MAY 21 2020

CITY OF PROVIDENCE ZONING BOARD OF REVIEW

APPLICATION FOR VARIANCE OR SPECIAL USE PERMIT

Check Each Type Zoning Reli	ief Sought:	Variance − Use * Variance − Dimensional* Special Use Permit **						
* Attach Appendix A to apply for a Use or Dimensional Variances **Attach Appendix B to apply for a Special Use Permit								
Applicant: J. P. Morgan Chas E-mail christopher.m.f Phone 312-355-3388 Home/Office		Address 10 S. Dearborn -15th Fl. Chicago, IL Zip Code 60603 Mobile (Cell)						
Owner: 280 Valley Street LLC E-mail kseacommercia Phone 401-434-2640 Home/Office	- Control	Address 58 Amaral Street, Riverside, RI Zip Code 02915 Mobile (Cell)						
E-mail Phone: Home/Office		Address Zip Code						
Does the proposal require review by any of the following (check each): Downtown Design Review Committee I-195 Redevelopment District Commission Capital Center Commission Historic District Commission								
1. Location of Property:	280-284 Valley Street Address C-2	Street						
2. Zoning District(s): Special purpose or overlay								
3a. Date owner purchased the	Property:	#280 - 12/3/2007, #284 - 2/28/2014						
3b. Month/year of lessee's occ	upancy:	12/2020						

3.	Di	mensions of eac							
Plat		Lot # 23		ft depth	87 ft. (avg.)	Total	area 10.875	sq. ft	
Plat	65	Lot # 24, 2寶	Frontage 65.34 f	t depth	90' ft. (avg.)	Total	area 5,881	sq. ft sq. ft	
		Lot #	Frontage			Total	area	sq. ft sq. ft	
4.	Siz	e of each struc	ture located on the					34. 10	
		Principal Stru		otal gross s	quare foota	IGE	3120 SF		
			rint 3120 SF	-	ht 12ft.鹛	ig.	Floors 1		
		_		ū					
		Accessory Str	ucture: Total gro	ss square fo	ootage				
		Footp	rint	Heig	ht		Floors		_
_	S:~	o of 1							_
Э,	Siz	e of proposed s	tructure(s): T	otal gross s	quare foota	ge:	3375 Sf		
		rootpi	int 3375 Sf	Heigl	ht <u>26.3</u>		Floors 1		
6a.	Exi	sting Lat cover	age: (include all bi	.:1.4:		10.0/			
		Edit Cover	age. (include aff of	uaings, aec	rks, etc.) <u>15.</u>	12 %			_
6b.	Pro	posed Lot cove	rage: (include new	constructio	n)16	5.5 %			
7a.	Pre Cor	sent Use of Promercial (Retail	perty (each lot/str	ucture):					
7b.	Leg Con	al Use of Propenmercial	erty (each lot/struc	ture) as rec		ept. of	Inspection &	Standar	rds:
8.	Pro	posed Use of Pa	roperty (each lot/s	ructure):			•		
	Cor	nmercial (Finan	cial Institution)	:		•			
				-					
9.	Nun	nber of Curren	t Parking Spaces:	20 (E	xisting Use)				
10.	Desc	cribe the propo	sed construction o	r alteration	s (each lot/e	chenoh	-ma).		
	ven	nolition of existin	10 COnvenience star	e to allow C	Onetruction	of a sa	ire). Sw.Chooo Bool	- - 1	er.
	with	associated part	king, utilities and re	note Drive-	Thru(s)	<u>yı a rie</u>	w Chase Bank	coranch	office
	•		• -		•				
4.4			\$ \$ \$ \$. 4	48,				
11.	Are	there outstand	ing violations conc	erning the	Property ur	ıder aı	ay of the follo	wing: N	- lone Known
	-		Orumance				-		
	-	RI State	Building Code						
	-	Provide	nce Housing Code						
12.]	List	all Sections of	the Zoning Ordin	ance from	which relie	ef is so	ught and des	crintion	nf each
-								•	oi each
		. 502(9	Front Setback 0 - 5	ft Relief re	equested to	allow 5	.56 ft. Front Si	etback	
		- 000 <u>03</u>	Dulio To Percentad	e 60 % - Re	lief requests	ad for 1	nn o/ to avoid	and alima	obst(
	OCC!	1202	Special Use Permit	- Stand-Alo	ne ATM (AT	M allo	ved in C-2 with	Approv	<u></u>

13. Explain the changes proposed for the Property.

Relief is required for the Front Setback and Build To Percentage to avoid an obstruction created by the Traffic Signal Controller that is situated on a concrete pad that partially obstructs the ability of the Applicant to meaningfully construct a building in compliance with the requirements. Clearance is needed to maintain operation of the traffic control device.

The Special Use Permit for remote ATM machine(s) is an integral part of the current operation. This feature is allowed in this district with special approval.

The undersigned acknowledge(s) and agree(s) that members of the Zoning Board of Review and its staff may enter upon the exterior of the Property in order to view the Property prior to any hearing on the application.

The undersigned further acknowledge(s) that the statements herein and in any attachments or appendices are true and accurate, and that providing a false statement in this application may be subject to criminal and/or civil penalties as provided by law, including prosecution under the State and Municipal False Claims Acts. Owner(s)/Applicant(s) are jointly responsible with their attorneys for any false statements.

Owner(s):	Applicant(s):
Konstantinos Dokos (280 Valley Street, LL&	Christopher Foit (JP Morgan Chase)
Type Name	Type Name
Signature	Signature
Type Name	Type Name
Signature	Signature

All requirements listed and described in the Instruction Sheet must be met or this application will not be considered complete.

APPENDIX A

APPLICATION FOR VARIANCE(S)

Rhode Island General Laws § 45-24-41(c) requires that the Applicant for a variance demonstrate:

- (1) That the hardship from which the applicant seeks relief is due to the unique characteristics of the subject land or structure and not to the general characteristics of the surrounding area; and is not due to a physical or economic disability of the applicant, excepting those physical disabilities addressed in § 45-24-30(16);
- (2) That the hardship is not the result of any prior action of the applicant and does not result primarily from the desire of the applicant to realize greater financial gain;
- (3) That the granting of the requested variance will not alter the general character of the surrounding area or impair the intent or purpose of the zoning ordinance or the comprehensive plan upon which the ordinance is based:
- (4) That the relief to be granted is the least relief necessary; and
- (5) (a) For a **use variance**: That the land or structure cannot yield any beneficial use if it is required to conform to the provisions of the zoning ordinance;
 - (b) For a dimensional variance, that the hardship suffered by the owner of the subject property if the dimensional variance is not granted amounts to more than a mere inconvenience.

Please provide the following information:

	What is the specific hardship from which the applicant Proximity to the existing irregularly-shaped Residential Zor Project Site; existing configuration of property lines; avoida	ne Boundary	on and adjacent to th	e oller. 🚹
2.	Specify any and all unique characteristics of the land or	structure 1	hat cause the hardsh	ip?
	Property is at an intersection with two front yards with more hardship for complete compliance with the "Build-To" provi	e than a 90- islon; avoida	degree angle presenting continues of existing traffic of	ng a device.
3.	(a) Is the hardship caused by an economic disability?	Yes	No_X	,
	(b) Is the hardship caused by a physical disability?			
	(c) If the response to subsection (b) is "yes," is the physwith Disabilities Act of 1990 (ADA), 42 U.S.C. § 121 Yes No	sical disabil		nericans
4	J 1			
4.	need for the variance requested? (Examples include, owner/applicant made to the structure(s), lot lines, or la Yes No _X			

Э.	primarily in order to obtain greater financial gain.
	Applicant wishes to develop the property consistent with the intent of the Setback requirement and
	promote pedestrian use by people in the neighborhood. Given the conditions of setbacks due to
	adjacent zoning district and lot configuration, and signal controller represents a hardship.
6.	State any and all facts that support your position that you are seeking the least relief necessary to lessen or eliminate the hardship (for example, why there are no viable alternatives to you
	proposed plan).
	The building is positioned with minimal clearance from the traffic signal equipment, and the zone district boundary on and adjacent to the site encumbers the building and parking area required for
	this reasonable, and benign use. Coupled with the street line configuration, these conditions create
	a hardship, and minimal relief is requested in order for the redevelopment to proceed.
	district.
8.	If you are seeking a DIMENSIONAL VARIANCE, set forth all facts that indicate that if the variance is not granted, the hardship the owner/applicant will suffer is more than a mer inconvenience.
	The intent of the regulation is satisfied, minimal relief is required to allow a meaningful
	redevelopment of the property. Relief would be required for virtually any reasonable future use.
	Compliance is provided on the Valley Street side, and positioning the building as proposed avoids
	existing traffic safety control device at the intersection of Valley Street and Atwells Avenue.

APPENDIX B

APPLICATION(S) FOR SPECIAL USE PERMIT

- Identify the section(s) of the Ordinance that provides for the special use permit.
 Section 1202(C) ATM. Proposed use is allowed within the C-2 District (with Special Approval), and the design meets the standards stated in that section (3 car stacking & ATM not in ROW).
- State all facts that demonstrate that the proposed special use will not substantially injure the use and enjoyment of neighboring property.
 ATMs are "remote" and dimly lit, and viewscreens are not directed towards on-coming traffic or towards adjacent residential properties. No voice commands or internal teller is required for operation. Substantial landscaping will serve as a screening device to surrounding properties.
- 3. State all facts that demonstrate that the proposed special use will not significantly devalue neighboring property.

The proposed redevelopment is proposed by a reputable financial institution and will be performed responsibly. The proposed use is benign and is not a nuisance use. The expectation is that redevelopment will increase the property values of the area.

4. State all facts that demonstrate that the proposed special use will not be detrimental or injurious to the health or welfare of the community.

The proposed Special Use is allowed within the underlying zoning district. The effective screening, green space and landscaping will minimize illumination levels, and benefit the neighborhood. The proposed Special Use meets the standards set forth in Section 1202 (C).

IF THE APPLICANT IS AN EDUCATIONAL OR HEALTH CARE INSTITUTION, COMPLETE PAGES 10 AND 11 BELOW

engineering architecture program management development services construction services



Zoning Relief Summary

Plat 65, Lot 991 (Formerly Lots 23, 24 & 26) 280-284 Valley Street Providence, RI

Special Use Permit
Per Sect. 1202 C – Stand-Alone ATM

The Special Use is allowed within the underlying Zoning C-2 District and meets the tests of the design standards (3 car stacking and not located within the right-ofway).

Additionally, the ATM screens are dimly lit and are not directed towards adjacent residential buildings or properties; or on-coming traffic or the driver's eye. Landscape buffers and screening also provide a visual barrier to prevent creating a distraction. Given the commercial characteristics of the area, with commercial signage and street lighting, the proposed relief is requested for this benign use.

Front Setback Variance (Atwells Avenue)

Per Sect. 502 A – Relief requested to allow front setback to vary between 5.56 feet and 8.56 feet along Atwells Avenue. Intent of compliance is satisfied by positioning the building adjacent to the right-of-way to promote pedestrian use. However, existing property boundary configuration, an obstruction at the intersection (traffic signal controller), and proximity of a Residential District restrict effective building placement and affect overall site design in complete compliance with this requirement. Compliance is substantially improved by granting this relief. Variance is for relief of 0.56-ft. to 3.56-ft.

Build to Percentage 60 % (Atwells Avenue)

Per Sect. 503 (A) 6 –The front setback "build to" percentage is achieved (65.7%) but is outside the front yard setback. For the reasons described above, namely; the existing non-rectangular lot line configuration, the obstruction at the intersection, and the close proximity of the Commercial – Residential Zoning district boundary, relief is requested if required.

Build to Percentage 40 % Corner Side (Valley Street)

Per Sect. 5 03 (A) 6 — Compliance with the corner side setback (0-5 ft.) is achieved, with the building face positioned off the line of Valley Street from 0 to 4.93-ft. from the street line. Given the existing unique site conditions at this property, relief is requested to allow a 28.1 % build-to percentage where 40 % is required. Compliance is drastically improved with approval of the proposed construction.



DESIGN AND DEVELOPMENT CONTACTS: APPLICANT 111 E. COURT STREET 2ND FLOOR FLINT, MI 48502 CONTACT: TOM MOFFATT KONSTANTINOS DOKOS CORE STATES GROUP 6060 NORTH CENTRAL EXPRESSWAY, SUITE 850 CIVIL ENGINEER CONTACT: THOMAS PICKERING, P.E. (RI) (214) 377-6420 ARCHITECT CORE STATES GROUP 201 S. MAPLE AVE, SUITE 300 AMBLER, PA 19002 CONTACT: KEN MACKENZIE, (RI) (267) 464-8048 SURVEYOR GALLAS SURVEYING GROUP 2865 US ROUTE 1 NORTH BRUNSWICK, NEW JERSEY 08902 CONTACT: GREGORY S. GALLAS (732) 422-6700 LANDSCAPE ARCHITECT EVERGREEN DESIGN GROUP **GOVERNING AGENCIES CONTACTS:** DEPARTMENT OF PLANNING AND DEVELOPMENT 444 WESTMINSTER STREET PROVIDENCE, RI 02903 CITY OF PROVIDENCE DEPARTMENT OF INSPECTION & STANDARDS 444 WESTMINSTER STREET BUILDING DEPARTMENT PROVIDENCE, RI 02903 (401) 680-5201 CITY OF PROVIDENCE FIRE PREVENTION FIRE PREVENTION BUREAU 325 WASHINGTON STREET PROVIDENCE, RI 02903 UTILITY: THE FOLLOWING COMPANIES WERE NOTIFIED BY THE RHODE ISLAND DIG SAFE SYSTEM AND REQUESTED TO MARK OUT UNDERGROUND FACILITIES AFFECTING AND SERVICING THIS SITE. THE LINDERGROUND UTILITY INFORMATION SHOWN HEREON IS BASED UPON THE UTILITY COMPANIES RESPONSE TO THIS REQUEST. REQUEST NUMBER(S): 20192018709 & 20192018724 AT&T TRANSMISSION ZAYO CENTURY LINK NATIONAL GRID ELECTRIC & GAS PROVIDENCE WATER SUPPLY BOARD VERIZON COX COMMUNICATIONS INC. APPLICANT AND OWNER SIGNATURES: APPLICANT DATE APPROVAL SIGNATURES: PLANNING BOARD CHAIRMAN DATE ALERT TO CONTRACTOR:

DATE

PLANNING BOARD SECRETARY

TOWNSHIP ENGINEER

THE SITE WORK FOR THE PROPOSED DEVELOPMENT SHALL

ALL NECESSARY INSPECTIONS AND/OR CERTIFICATIONS REQUIRED BY THE CITY OF PROVIDENCE CODES, CITY OF PROVIDENCE AND/OR UTILITY SERVICE COMPANIES SHALL BE

MEET OR EXCEED ALL CITY AND/OR COUNTY AND STATE

AND THE FINAL CONNECTION OF SERVICES

PRELIMINARY SITE PLAN APPROVAL

FOR



PROPOSED CHASE BANK

280 VALLEY STREET (PLAT 65 LOT 23)
284 VALLEY STREET (PLAT 65 LOT 24)
14 NEWARK STREET (PLAT 65 LOT 26)
PROVIDENCE, RI 02908
CITY OF PROVIDENCE
PROVIDENCE COUNTY, RHODE ISLAND

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CV-2	GENERAL NOTES	CORE STATES			П	\Box					
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C-3	GRADING PLAN	CORE STATES									
C-4	UTILITY PLAN	CORE STATES									
C-5	LIGHTING PLAN	CORE STATES				П					
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VICINITY MAP







1° = 500'



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Section 2012 April 1997 Apr

DOCUMENT SITE PLAN APPROVAL FOR CHASE BANK

SITE LOCATION 280 & 284 VALLEY STREET 14 NEWARK STREET PROVIDENCE, RI

ENGINEER SEAL

THOMAS PICKERNG
PROFESSIONAL BUSINEER
ORTHOMAS PICKERING, P.E.
RILICENSE #12554
SHEET TITLE
COVER
SHEET

DB #: JPM-2589
ATE: 06/10*1
CALE: AS SHOWN
RAWN BY: XXX
EECKED BY: XXX
SHEET NO.

CV-1

GENERAL SITE NOTES ALL CONSTRUCTION MATERIALS AND TECHNIQUES OF INSTALLATION SHALL MEET PERFORMANCE VALUES OF THE MATERIALS SPECIFIED AND COMPLY WITH ALL TOWNSHIP/COUNTY REGULATIONS AND CODES AND O.S.H.A. STANDARDS. THE GENERAL CONTRACTOR SHALL BE RESPONSIBLE FOR ENSURING THAT THIS PROJECT IS CONSTRUCTED IN ACCORDANCE WITH THESE DOCUMENTS AND IN COMPLIANCE WITH CODES INDICATED HEREIN. THE QUALITY OF WORKMAN AND INSTALLATION OF MATERIALS SPECIFIED BY THE ARCHITECT/ENGINEER ARE THE RESPONSIBILITY OF THE CONTRACTOR, THE ARCHITECT/ENGINEER WILL NOT BE HELD RESPONSIBLE FOR ANY SUBSTANDARD OR INSUFFICIENT KMANSHIP, MATERIALS, OR SERVICES PROVIDED IN THE EXECUTION OF ANY PHASE OF CONSTRUCTION OF THIS PROJECT. ALL MATERIALS ARE TO BE INSTALLED IN ACCORDANCE WITH MANUFACTURER'S REQUIREMENTS. THE GENERAL CONTRACTOR SHALL ENSURE THAT ALL MANUFACTURER'S WARRANTIES WILL BE HONORED. ALL CONDITIONS SHOWN TO BE "EXISTING" SHALL BE VERIFIED IN THE FIELD BY ALL CONDITIONS SHOWN TO BE EXISTING STRALE BY VERRIFIED IN THE FIELD BY THE GENERAL CONTRACTOR PRIOR TO START OF CONSTRUCTION. ANY DISCREPANCIES SHALL BE NOTED AND SUBMITTED TO THE OWNER AND THE ARCHITECTENGINEER FOR REVIEW. CHANGES TO THE ORIGINAL DESIGN OF THE PROJECT DUE TO EXISTING SITE CONDITIONS MUST BE APPROVED BY BOTH THE OWNER AND THE ARCHITECT/ENGINEER PRIOR TO MAKING ANY CHANGES. CONTRACTOR TO REVIEW AND FOLLOW CONSTRUCTION CONTRACTION TO REVIEW AND POLLOW CONSTRUCTION. TECHNIQUES/SPECIFICATIONS OUTLINED IN THE SITE GEOTECHNICAL REPORT. ANY CONFLICTS WHICH MAY ARISE SHALL BE NOTED AND SUBMITTED TO THE OWNER AND THE ARCHITECTENGINEER FOR REVIEW PRIOR TO COMMENCEMENT OF CONSTRUCTION ACTIVITIES. OF CONSTRUCTION ACTIVITIES. THE GENERAL CONTRACTOR SHALL BE RESPONSIBLE FOR HAVING A THOROUGH KNOWLEDGE OF EXISTING FIELD CONDITIONS AND OF ALL DRAWINGS AND KNOWLEDGE OF EXISTING FIELD CONDITIONS AND OF ALL DIKAYINGS AND SPECIFICATIONS RELATED TO THEIR FIELD. THE FAILURE TO ACQUANT HIMSELF WITH THIS PROJECT AND HIS FIELD OF SERVICE SHALL NOT RELIEVE HIM OF ANY RESPONSIBILITY FOR PERFORMING HIS WORK PROPERLY, NO ADDITIONAL COMPENSATION SHALL BE ALLOWED DUE TO THE GENERAL CONTRACTOR'S FAILURE TO CONVEY THE NECESSARY KNOWLEDGE TO FAMILIARIZE WORKERS AND SUBCONTRACTORS WITH THIS PROJECT. THE GENERAL CONTRACTOR SHALL BE RESPONSIBLE FOR ENSURING THE SAFETY THE GENERAL CONTRACTOR STALL BE RESPONSIBLE FOR ENSORING THE OF ALL PERSONS ON THE JOB SITE AT ALL TIMES INCLUDING (BUT NOT LIK TO) SUBCONTRACTORS, FACILITY EMPLOYEES, VENDORS, DESIGN STAFF PROFESSIONALS AND INSPECTION PERSONNEL. THE GENERAL CONTRACTOR SHALL PROVIDE DUMPSTERS, PORTABLE TOILETS AND TEMPORARY POWER FOR UNRESTRICTED PROJECT RELATED USE BY OTHERS FOR THE DURATION OF THE PROJECT. THE GENERAL CONTRACTOR SHALL COORDINATE PROJECT PHASING AND STORAGE OF MATERIALS WITH THE OWNER. THE GENERAL CONTRACTOR IS RESPONSIBLE FOR RECEIVING, UNLOADING STORING AND PROTECTING OF MATERIALS AND EQUIPMENT SUPPLIED BY THE OWNER UNTIL IT HAS BEEN INSTALLED AND ACCEPTED BY THE OWNER THE GENERAL CONTRACTOR SHALL BE RESPONSIBLE FOR KEEPING THE AREA CLEAN AND FREE OF DEBRIS AT ALL TIMES DURING CONSTRUCTION. THE GENERAL CONTRACTOR SHALL POWER WASH THE ENTIRE CONSTRUCTION AREA PRIOR TO TURNOVER TO THE OWNER. EXISTING PAVING THAT WILL REMAIN AFTER CONSTRUCTION SHALL BE PROTECTED FROM DAMAGE. AREAS OF EXISTING PAVING THAT ARE DAMAGED DURING CONSTRUCTION SHALL BE SAWCUT, THEN REMOVED AND REPLACED. THE GENERAL CONTRACTOR SHALL FIELD VERIFY THE EXACT LOCATION OF ALL PUBLIC AND PRIVATE UTILITIES, INCLUDING IRRIGATION, SPECIFIC TO THIS PROJECT PRIOR TO THE START OF ANY DEMOLITION OR CONSTRUCTION, SHOULD ANY UTILITY REQUIRE RELOCATION, CONTRACTOR SHALL COORDINATE WITH THE OWNER AND THE ARCHITECT/ENGINEER. SAWCUT AND REMOVE PORTIONS OF EXISTING PAVING ONLY AS REQUIRED TO INSTALL NEW UTILITIES OR TO CONSTRUCT PROPOSED FACILITIES PER THIS PLAN. REPLACE PORTIONS REMOVED TO MATCH EXISTING FLUSH AND SMOOTH. PROVIDE TEMPORARY CHAIN LINK FENCING, MINIMUM 6'-0' HIGH, AROUND ENTIRE PROVIDE TEMPORARY CHARLEMS PERCENCE, MINIMAN 40-11 INFO, ARCOLD ENTIRE AREA OF CONSTRUCTION. FIELD VERIFY EXACT LOCATION AND SPECIFICATIONS OF FENCE WITH THE OWNER PRIOR TO START OF CONSTRUCTION. REMOVE FENCING AT COMPLETION OF PROJECT AND PATCH PAVING AS REQUIRED AT FENCE POST HOLES. ALL DIMENSIONS AND RADII ARE TO FACE OF CURB UNLESS OTHERWISE NOTED. CONTRACTOR IS RESPONSIBLE FOR PROTECTION OF ALL PROPERTY CORNERS CONTRACTOR SHALL MATCH PROPOSED CURB AND GUTTER, CONCRETE, AND PAVEMENT TO EXISTING IN GRADE AND ALIGNMENT. CONSTRUCTION SHALL COMPLY WITH ALL GOVERNING CODES AND BE CONSTRUCTED TO SAME. CONTRACTOR IS RESPONSIBLE FOR REPAIRING THE DAMAGE DONE TO AN EXISTING ITEM TO REMAIN DURING CONSTRUCTION, SUCH AS, BUT NOT LIMITED TO DRAINAGE UTILITIES PAVEMENT STRIPING CURB ETC. REPAIRS SHALL BE FOLIAL TO OR BETTER THAN EXISTING CONDITIONS. CONTRACTOR IS BLE TO DOCUMENT ALL EXISTING DAMAGE AND NOTIFY OWNER PRIOR CONTRACTOR SHALL REFER TO THE ARCHITECTURAL PLANS FOR EXACT LOCATIONS AND DIMENSIONS OF BUILDING APPURTENANCES, STAIRS, RAMPS, SLOPE PAVING, SIDEWALKS, PRECISE BUILDING DIMENSIONS AND EXACT BUILDING UTILITY ENTRANCE LOCATIONS. ALL DISTURBED AREAS ARE TO RECEIVE FOUR INCHES OF TOPSOIL, SEED OR SOD, MULCH AND WATER UNTIL A HEALTHY STAND OF GRASS IS ESTABLISHED 23. EXISTING STRUCTURES WITHIN CONSTRUCTION LIMITS ARE TO BE ABANDONED. REMOVED OR RELOCATED AS NECESSARY, ALL COST SHALL BE INCLUDED IN CONTRACTOR SHALL BE RESPONSIBLE FOR ALL RELOCATIONS, (UNLESS OTHERWISE NOTED ON PLANS) INCLUDING BUT NOT LIMITED TO, ALL UTILITIES, STORM DRAINAGE, SIGNS, TRAFFIC SIGNALS & POLES, ETC. AS REQUIRED. ALL WORK SHALL BE IN ACCORDANCE WITH GOVERNING AUTHORITIES REQUIREMENTS AND PROJECT SITE WORK SPECIFICATIONS AND SHALL BE APPROVED BY SUCH, ALL COST SHALL BE INCLUDED IN BASE BID. THE SITE WORK FOR THIS PROJECT SHALL MEET OR EXCEED THE SPECIFICATIONS IN THE CONTRACT DOCUMENTS. ANY DISCREPANCIES ON THE DRAWINGS SHALL BE IMMEDIATELY BROUGHT TO THE ATTENTION OF THE OWNER AND ENGINEER OF RECORD BEFORE COMMENCING WORK. NO FIELD CHANGES OR DEVIATIONS FROM THE DESIGN ARE TO BE MADE WITHOUT PRIOR APPROVA IN THE EVENT THE CONSTRUCTION IS ABANDONED PRIOR TO THE COMPLETION OF THE PROJECT, ALL CONSTRUCTION AND STOCKPILED VEGETATIVE DEBRIS AND FILL WILL BE REMOVED FROM THE SITE AND THE SITE WILL BE STABILIZED PER RIDEM GENERIC PERMIT FOR STORM WATER DISCHARGE FROM LARGE AND SMALL CONSTRUCTION ACTIVITIES (NPDES). THESE PLANS ARE INTENDED TO AND SHALL COMPLY WITH AMERICANS WITH DISABILITIES ACT AND THE NEW JERSEY ACCESSIBILITY LAW. ALL VEGETATION FROM CLEARING AND GRUBBING WILL BE DISPOSED OF CONTRACTOR IS RESPONSIBLE FOR PERMITTING, INSTALLATION AND MAINTENANCE OF ALL MAINTENANCE OF TRAFFIC OPERATIONS DURING CONSTRUCTION. MAINTENANCE OF TRAFFIC SHALL CONFORM TO

RIDOT/GOVERNING AGENCY STANDARDS.

ALL DESIGN AND CONSTRUCTION MUST CONFORM TO THE MINIMUM STANDARDS

RELATED ORDINANCES, AND MINIMUM TESTING FREQUENCY REQUIREMENTS

IP/COUNTY DEVELOPMENT CODE ZONING AND/O

GENERAL UTILITY NOTES

THE DESIGNATED UTILITY COMPANIES.

CONTRACTOR SHALL COORDINATE ANY DISRUPTIONS TO EXISTING UTILITY

SERVICES WITH ADJACENT PROPERTY OWNERS ALL ELECTRIC, TELEPHONE AND GAS EXTENSIONS INCLUDING SERVICE LINES SHALL BE CONSTRUCTED TO THE APPROPRIATE UTILITY COMPANY SPECIFICATIONS. ALL UTILITY DISCONNECTIONS SHALL BE COORDINATED WITH

CONSTRUCTION SHALL NOT START ON ANY PUBLIC UTILITY SYSTEM UNTIL WRITTEN APPROVAL HAS BEEN RECEIVED BY THE ENGINEER FROM THE APPROPRIATE GOVERNING AUTHORITY AND CONTRACTOR HAS BEEN NOTIFIED SAID ENGINEER BY ENGINEER.

PRIOR TO THE CONSTRUCTION OF OR CONNECTION TO ANY STORM DRAIN. SANITARY SEWER, WATER MAIN OR ANY OF THE DRY UTILITIES, THE CONTRACTOR SANITANT SEVEN, WATEN MAIN ON ANY OF THE DRY UTILITIES, THE CONTRACTION AND ALL UTILITY CROSSINGS AND INFORM THE ENGINEER AND THE OWNERDEVELOPER OF ANY CONFLICT OR REQUIRED DEVIATIONS FROM THE PLAN. NOTIFICATION SHALL BE MADE A MINIMUM OF 48 HOURS PRIOR TO CONSTRUCTION. THE ENGINEER AND ITS CLIENTS SHALL BE HELD HARMLESS IN THE EVENT THAT THE CONTRACTOR FAILS TO MAKE SUCH NOTIFICATION.

PRIOR TO CONSTRUCTION THE GENERAL CONTRACTOR SHALL VERIEV THAT FRIOR TO CONSTRUCTION, THE GENERAL CONTRACTOR SHALL VERHYT HIS "STUB OUTS" FOR POWER, FLEEPHONE, FIBER OPTICS, WATER AND SEWER (IF APPLICABLE) HAVE BEEN PROVIDED BY OTHERS (IF APPLICABLE) AT THE AREA ADJACENT TO THE PROPOSED BUILDING. THE GENERAL CONTRACTOR SHALL BE RESPONSIBLE FOR FINAL CONNECTIONS AT THE BUILDING.

THE GENERAL CONTRACTOR SHALL BE RESPONSIBLE FOR COORDINATING THE SCHEDULE FOR INSTALLATION WITH THE UTILITY COMPANIES AND THE OWNER ALL EXISTING CONDITIONS THAT ARE REMOVED OR DISPURTED DURING THE ALL EXISTING CONDITIONS THAT ARE REMOVED OR DISROPTED DURING
PLACEMENT OF NEW UTILITIES SHALL BE REPLACED OR REPAIRED TO M.
ORIGINAL CONDITIONS. ANY EXISTING UTILITIES DISRUPTED DURING PL.
OF NEW UTILITIES SHALL BE REPAIRED AND OPERATING NORMALLY THE DAY OF DISRUPTION. ITEMS THAT MAY NEED TO BE REPLACED OR REPAIRED INCLUDE BUT ARE NOT LIMITED TO: EXISTING ASPHALT PAVING, EXISTING CONCRETE PAVING, WATER LINES, IRRIGATION LINES, GRASS AREAS. LANDSCAPING, AND SITE LIGHTING. THE GENERAL CONTRACTOR SHALL FIELD VERIFY THE EXACT LOCATION OF ALL EXISTING ITEMS THAT WILL BE DISRUPTED VERIFY THE EXACT LOCATION OF ALL EXISTING THEM STRAT VILL BE DISROPTED DURING THE PLACEMENT OF NEW UTILITIES AND PROVIDE THE OWNER A DETAILED PHASING SCHEDULE OUTLINING THE TIMELINE FOR INSTALLATION OF NEW UTILITIES INCLUDING THE PROPOSED TIMES THAT EXISTING TIEMS WILL BE DISRUPTED. THE NEW UTILITIES TRENCH WIDTH AND DEPTH SHALL MEET ALL LOCAL AND STATE REQUIREMENTS FOR THE DISPLACEMENT OF ALL UTILITIES. IF DIRECTIONAL BORING IS USED FOR INSTALLATION, THE ABOVE LISTED ITEMS ARE STILL REQUIRED TO BE SUBMITTED TO THE OWNER.

IF ANY EXISTING STRUCTURES TO REMAIN ARE DAMAGED DURING CONSTRUCTION, IT SHALL BE THE CONTRACTOR'S RESPONSIBILITY TO REPAIR ANDIOR REPLACE THE EXISTING STRUCTURE AS NECESSARY TO RETURN IT TO EXISTING CONDITIONS OR BETTER.

ALL SANITARY SEWER MANHOLES IN PAVED AREAS SHALL BE FLUSH WITH PAVEMENT, AND SHALL HAVE TRAFFIC BEARING RINGS & COVERS. SANITARY MANHOLES IN UNPAVED AREAS SHALL BE 2 * ABOVE FINISH GRADE WITH WATER

ALL FILL MATERIAL IS TO BE IN PLACE, AND COMPACTED BEFORE INSTALLATION OF PROPOSED UTILITIES.

CONTRACTOR SHALL NOTIFY THE UTILITY AUTHORITIES INSPECTORS 72 HOURS BEFORE CONNECTING TO ANY EXISTING LINE

UNDERGROUND UTILITY LINES SHALL BE INSTALLED, INSPECTED AND APPROVED BEFORE BACKFILLING.

REFER TO ARCHITECTURAL DRAWINGS FOR TIE-IN OF ALL LITHLITIES.

CONTRACTOR IS RESPONSIBLE FOR COMPLYING TO THE SPECIFICATIONS OF THE LOCAL AUTHORITIES WITH REGARDS TO MATERIALS AND INSTALLATION OF THE WATER AND SEWER LINES.

CONTRACTOR SHALL COORDINATE WITH ALL LITILITY COMPANIES FOR INSTALLATION REQUIREMENTS AND SPECIFICATION

DRAWINGS DO NOT PURPORT TO SHOW ALL EXISTING UTILITIES.

EXISTING UTILITIES SHALL BE VERIFIED IN FIELD PRIOR TO INSTALLATION OF ANY

THE CONTRACTOR SHALL CONSTRUCT GRAVITY SEWER LATERALS, MANHOLES, GRAVITY SEWER LINES AND DOMESTIC WATER AND FIRE PROTECTION SYSTEM AS SHOWN ON THESE PLANS. THE CONTRACTOR SHALL FURNISH ALL NECESSARY MATERIALS, EQUIPMENT, MACHINERY, TOOLS, MEANS OF TRANSPORTATION AND LABOR NECESSARY TO COMPLETE THE WORK IN FULL AND COMPLETE IN ACCORDANCE WITH THE SHOWN, DESCRIBED AND REASONABLY INTENDED REQUIREMENTS OF THE CONTRACT DOCUMENTS AND JURISDICTIONAL AGENCY REQUIREMENTS IN THE EVENT THAT THE CONTRACT DOCUMENTS AND JURISDICTIONAL AGENCY REQUIREMENTS ARE NOT IN AGREEMENT, THE MOST STRINGENT SHALL GOVERN.

THE CONTRACTOR SHALL RESTORE ALL DISTURBED VEGETATION IN KIND, UNLESS

DEFLECTION OF PIPE JOINTS AND CURVATURE OF PIPE SHALL NOT EXCEED THE DEFLECTION OF PIPE JOINTS AND CURVATURE OF PIPE SHALL NOT EXCEED THE MANUFACTURER'S SPECIFICATIONS. SECURELY CLOSE ALL OPEN ENDS OF PIPE AND FITTINGS WITH A WATERTIGHT PLUG WHEN WORK IS NOT IN PROGRESS. THE INTERIOR OF ALL PIPES SHALL BE CLEAN AND JOINT SURFACES WIPED CLEAN AND DRY AFTER THE PIPE HAS BEEN LOWERED INTO THE TRENCH. VALVES SHALL BE PLUMB AND LOCATED ACCORDING TO THE PLANS.

ALL LITH ITY AND STORM DRAIN TRENCHES LOCATED LINDER AREAS TO RECEIVE PAVING SHALL BE COMPLETELY BACKFILLED AND COMPACTED IN ACCOR WITH SPECIFICATIONS. IN THE EVENT THAT THE CONTRACT DOCUMENTS JURISDICTIONAL AGENCY REQUIREMENTS ARE NOT IN AGREEMENT, THE MOST STRINGENT SHALL GOVERN.

SHOP DRAWINGS FOR ALL MATERIALS AND APPLIETENANCE SHALL BE SUBMITTED TO AND APPROVED BY THE GOVERNING UTILITY DEPARTMENT. SOME REQUESTED AND APPROVED BY THE GOVERNING UTILITY DEPARTMENT. CONTRACTOR TO COPY THE ENGINEER OF RECORD WITH APPROVED DRAWINGS AS REQUIRED. NO WORK IS TO BEGIN UNTIL SHOP DRAWINGS HAVE BEEN REVIEWED. APPROVED AND RETURNED TO THE CONTRACTOR.

AT LEAST THREE WEEKS PRIOR TO CONSTRUCTION, THE CONTRACTOR SHALL NOTIFY THE TOWNSHIP/COUNTY AND THE UTILITY COMPANY AND SUPPLY THEM NOTIFY THE TOWNSHIP/COUNTY AND THE UTILITY COMPANY AND SUPPLY THEM WITH ALL REQUIRED SHOP DRAWINGS, THE CONTRACTOR'S NAME, STARTING DATE, PROJECTED SCHEDULE AND OTHER INFORMATION AS REQUIRED. THE TOWNSHIP/COUNTY ENGINEERING INSPECTION OFFICE SHOULD ALSO BE CONTACTED FUTE DAYS PRIOR TO CONSTRUCTION TO ENSURE AVAILABILITY OF INSPECTION PERSONAL. ANY WORK PREFORMED PRIOR TO NOTIFYING THE TOWNSHIP/COUNTY ENGINEERING. INSPECTION DEFECT ON DIFFERENCE TO INSTITUTE OF THE PROPERTY TOWNSHIP/COUNTY ENGINEERING INSPECTION OFFICE OR WITHOUT A DEPARTMENT INSPECTOR PRESENT MAY BE SUBJECT TO REMOVAL AND REPLACEMENT AT THE SOLE EXPENSE OF THE CONTRACTOR.

THE CONTRACTOR SHALL BE RESPONSIBLE FOR LOCATING EXISTING WATER INS, FORCE MAINS, SANITARY SEWER AND STORM MAINS AND MAINTAIN.
NIMUM CLEARANCE BETWEEN WATER MAINS AND OTHER UTILITIES AT ALI POINTS ALONG THEIR LENGTH AS REQUIRED IN THE PLANS, DETAILS, AND

SANITARY SEWER FORCE MAINS SEWER LATERALS AND STORM SEWERS SANTIANT SEVER, FORCE MANDS, SEVER LA LERGALS, AND STORM SEVERS SHOULD CROSS UNDER WATER MANDS AND/OR WATER SERVICES WHENEVER POSSIBLE. SANITARY SEWERS, FORCE MANS, SEWER LATERALS, AND STORM SEWERS CROSSING WATER MANDS SHALL BE LAID TO PROVIDE A MINIMUM DEPOTATION OF THE MODERN DEPOTATION OF THE /ERTICAL DISTANCE OF 18 INCHES BETWEEN THE BOTTOM OF THE UPPER PIPE AND THE TOP OF THE LOWER PIPE.

25. TREES SHALL BE PLACED SO AS TO AVOID BURIED UTILITIES.

ALL UTILITY MAIN LENGTHS SHOWN ARE APPROXIMATE. ALL MANHOLE TOP ELEVATIONS ARE APPROXIMATE. CONTRACTOR SHALL SET MANHOLE TOP LEVEL WITH FINISH PAVEMENT GRADES.

27. ALL FIRE HYDRANTS SHALL BE INSTALLED WITH HOSE CONNECTIONS FACING THE

PRESSURE PIPE TESTING SPECIFICATIONS SHALL REFERENCE THE TOWNSHIP/COUNTY AND/OR FIRE DEPARTMENT

29. CONTRACTOR IS RESPONSIBLE FOR ALL NECESSARY INSPECTIONS AND/OR CERTIFICATIONS REQUIRED BY CODES AND/OR LITILITY SERVICE COMPANIES. THIS AND THE FINAL CONNECTIONS OF THE SERVICE SHALL BE COMPLETED 30 DAYS PRIOR TO STORE POSSESSION

CONTRACTOR SHALL COORDINATE WITH ALL UTILITY COMPANIES FOR INSTALLATION REQUIREMENTS AND SPECIFICATIONS

CONNECTION INTO A EXISTING TOWNSHIP/COUNTY OWNED SYSTEM SHALL BE VIA CONNECTION INTO A EXISTING TOWNSHIP/OUNTY OWNED YSTEM SHALL A WET TAP, WET TAPS SHALL BE PREFORMED BY THE UTILITIES SERVICE COMPANY AT THE CONTRACTOR'S EXPENSE. EXCAVATION, BACKFILL, AND SURFACE RESTORATION SHALL BE THE CONTRACTOR'S RESPONSIBILITY.

32. THE UTILITIES SERVICE COMPANY SHALL NOT OWN OR MAINTAIN WATER AND SEWER LINES OR FACILITIES ONSITE.

DEMOLITION NOTES:

THE CONTRACTOR SHALL COMPLY WITH ALL FEDERAL, STATE AND LOCAL LAWS AND CODES AND OBTAIN ALL REQUIRED PERMITS FOR ANY CONSTRUCTION

ACTIVITY. THE CONTRACTOR SHALL CONTACT 811 DIG SAFELY BEFORE PERFORMING ANY

THE CONTRACTOR SHALL INSTALL ALL CONSTRUCTION FENCING AND EROSION AND SEDIMENT CONTROL DEVICES PRIOR TO THE START OF ANY DEMOLITION OR CONSTRUCTION ACTIVITY

ALL STRUCTURES, UTILITIES, SITE IMPROVEMENTS AND TREES DESIGNATED ON ALL STRUCTURES, OTHER IES, SITE IMPROVEMENTS AND TREES DESIGNATED OF THE DRAWINGS OR DIRECTED BY THE ENGINEER TO REMAIN SHALL BE PROTECTED FROM DAMAGE BY ALL CONSTRUCTION OPERATIONS. THIS SHALL BE ACCOMPLISHED BY ERECTING BARRIERS, GUARDS AND ENCLOSURES AS SHOWN ON THE DRAWINGS OR OTHER APPROVED MEANS. PROTECTION SHALL BE MAINTAINED UNTIL ALL WORK IN THE VICINITY OF THE WORK BEING ROTECTED HAS BEEN COMPLETED.

THE CONTRACTOR SHALL COMPLY WITH ALL DEMOLITION AND NEW CONSTRUCTION INSPECTIONS AS REQUIRED BY FEDERAL STATE AND AUTHORITY HAVING JURISDICTION LAWS, REGULATIONS AND BUILDING CODES

AUTHORITY HAVING JORGUSCHON LAWS, RESULATIONS AND BUILDING CODES THE CONTRACTOR IS RESPONSIBLE FOR THE DEMOLITION, REMOVAL, AND DISPOSAL (IN A LOCATION APPROVED BY ALL AUTHORITIES HAVING JURISDICTION) ALL STRUCTURES, PADS, WALLS, FLUMES, FOUNDATIONS, PARKING, DRIVES, DRAINAGE, STRUCTURES, UTILITIES, ETC., SUCH THAT THE MPROVEMENTS SHOWN ON THE REMAINING PLANS CAN BE CONSTRUCTED. UTILITIES ARE TO BE REMOVED TO THE RIGHT-OF-WAY, UNLESS OTHERWISE

7. ALL FACILITIES TO BE REMOVED SHALL BE UNDERCUT TO SUITABLE MATERIA AND BROUGHT TO GRADE WITH SUITABLE COMPACTED FILL MATERIAL PER THE CONTRACT DOCUMENTS.

CONTRACT DUCOMENTS.

CONTRACTOR IS TO REMOVE AND DISPOSE OF ALL DEBRIS, RUBBISH, VEGETATION FROM CLEARING AND GRUBBING, AND OTHER MATERIALS RESULTING FROM PREVIOUS AND CURRENT DEMOLITION OPERATIONS. DISPOSAL WILL BE IN ACCORDANCE WITH ALL LOCAL, STATE AND/OR FEDERAL REGULATIONS GOVERNING SUCH OPERATIONS. THE CONTRACTOR IS RESPONSIBLE FOR OBTAINING FOR ALL PERMITS REQUIRED FOR DEMOLITION AND DISPOSAL

9. THE CONTRACTOR IS RESPONSIBLE FOR REMOVING ALL DEBRIS FROM THE SITE AND DISPOSING THE DEBRIS IN A LAWFUL MANNER. THE CONTRACTOR IS RESPONSIBLE FOR OBTAINING ALL PERMITS REQUIRED FOR DEMOLITION AND

10. THE CONTRACTOR SHALL COORDINATE WITH RESPECTIVE UTILITY COMPANIES PRIOR TO THE REMOVAL AND/OR RELOCATION OF UTILITIES. THE CONTRACTOR SHALL COORDINATE WITH THE UTILITY COMPANY CONCERNING PORTIONS OF WORK WHICH MAY BE PERFORMED BY THE UTILITY COMPANY'S FORCES AND ANY FEES WHICH ARE TO BE PAID TO THE UTILITY COMPANY FOR THEIR SERVICES. THE CONTRACTOR IS RESPONSIBLE FOR PAYING ALL FEES AND

THE LOCATIONS OF ALL EXISTING UTILITIES SHOWN ON THIS PLAN HAVE BEEN THE LOCATIONS OF ALL EXISTING UTILITIES SHOWN ON THIS PLAN HAVE BEEN DETERMINED FROM THE BEST INFORMATION AVAILABLE AND ARE GIVEN FOR THE CONVENIENCE OF THE CONTRACTOR. THE ENGINEER ASSUMES NO RESPONSIBILITY FOR THEIR ACCURACY, PRIOR TO THE START OF ANY DEMOLITION ACTIVITY, THE CONTRACTOR SHALL NOTIFY THE UTILITY COMPANIES FOR ONSITE LOCATIONS OF EXISTING UTILITIES.

12. ALL EXISTING SEWERS, PIPING AND UTILITIES SHOWN ARE NOT TO BE INTERPRETED AS THE EXACT LOCATION, OR AS THE ONLY ORSTACLES THAT INTERPRETED AS THE EXACT LOCATION, OR AS THE ORLY OBSTACLES THAT MAY OCCUR ON THE SITE. VERIEY EXISTING CONDITIONS AND PROCEED WITH CAUTION AROUND ANY ANTICIPATED FEATURES. GIVE NOTICE TO ALL UTILITY COMPANIES REGARDING DESTRUCTION AND REMOVAL OF ALL SERVICE LINES AND CAP ALL LINES BEFORE PROCEEDING WITH THE WORK. UTILITIES DETERMINED TO BE ABANDONED AND LEFT IN PLACE SHALL BE GROUTED IF UNDER BUILDING.

13. ELECTRICAL, TELEPHONE, CABLE, WATER, FIBER OPTIC CABLE AND/OR GAS LINES NEEDING TO BE REMOVED OR RELOCATED SHALL BE COORDINATED WITH THE AFFECTED UTILITY COMPANY AND REMOVED TO THE PROPERTY LINE ADEQUATE TIME SHALL BE PROVIDED FOR RELOCATION AND CLOSE ADEQUATE TIME SHALL BE PROVIDED FOR RECOGNION AND CLOSE COORDINATION WITH THE UTILITY COMPANY IS NECESSARY TO PROVIDE A SMOOTH TRANSITION IN UTILITY SERVICE. CONTRACTOR SHALL PAY CLOSE ATTENTION TO EXISTING UTILITIES WITHIN ANY ROAD RIGHT OF WAY DURING CONTRACTOR.

CONSTRUCTION.
CONTRACTOR TO REPLACE ALL DEAD AND/OR DAMAGED SHRUBS IN KIND. ALL BELOW GRADE CONSTRUCTION INCLUDING BELOW- GRADE WALLS, SLABS AND TANKS ARE TO BE REMOVED.

16. PLAN DEPICTS ALL KNOWN STRUCTURES AND UTILITIES ABOVE AND/OR UNDERGROUND. ADDITIONAL UNDERGROUND UTILITIES AND/OR STRUCTURES
MAY EXIST. CONTRACTOR SHALL NOTIFY ENGINEER OF RECORD IF ADDITIONAL

GRADING NOTES:

1 ALL PAVING AND GRADING CONSTRUCTION MATERIALS AND METHODS SHALL

ALL PAVING AND GRADING CONSTRUCTIONS AND RECIDIOS SHAL MEET THE STANDARD SPECIFICATIONS AND REQUIREMENTS OF THE TOWNS
 CONTRACTOR IS RESPONSIBLE FOR DEMOLITION OF EXISTING STRUCTURES INCLUDING REMOVAL OF ANY EXISTING UTILITIES SERVING THE STRUCTURE UTILITIES ARE TO BE REMOVED TO THE RIGHT-OF-WAY.

3. THE CONTRACTOR IS SPECIFICALLY CAUTIONED THAT THE LOCATION AND/OR ELEVATION OF EXISTING UTILITIES AS SHOWN ON THESE PLANS IS BASED ON RECORDS OF THE VARIOUS UTILITY COMPANIES, AND WHERE POSSIBLE MEASUREMENTS TAKEN IN THE FIELD, THE INFORMATION IS NOT TO BE RELIED ON AS BEING EXACT OR COMPLETE. THE CONTRACTOR MUST CALL THE APPROPRIATE UTILITY COMPANIES AT LEAST 72 HOURS BEFORE ANY EXCAVATION TO REQUEST EXACT FIELD LOCATION OF UTILITIES. IT SHALL BE THE RESPONSIBILITY OF THE CONTRACTOR TO RELOCATE ALL EXISTING LITILITIES WHICH CONFLICT WITH THE PROPOSED IMPROVEMENTS SHOWN ON THE PLANS.

ALL CUT OR FILL SLOPES SHALL BE 4:1 OR FLATTER UNLESS OTHERWISE NOTED PRECAST STRUCTURES ARE REQUIRED.

STORM PIPES TO BE CLEANED OUT TO REMOVE ALL SILT AND DEBRIS. PRIOR TO FINAL INSPECTION.

EXISTING CONTOUR INTERVALS SHOWN AT 1.0 FOOT

PROPOSED CONTOUR INTERVALS SHOWN AT 1.0 FOOT.
 IF ANY EXISTING STRUCTURES TO REMAIN ARE DAMAGED DURING

CONSTRUCTION IT SHALL BE THE CONTRACTORS RESPONSIBILITY TO REPAIR AND/OR REPLACE THE EXISTING STRUCTURE AS NECESSARY TO RETURN IT TO EXISTING CONDITIONS OR BETTER.

10. ALL STORM PIPE ENTERING STRUCTURES SHALL BE GROUTED TO ASSURE CONNECTION AT STRUCTURE IS WATERTIGHT

1. ALL STORM SEWER MANHOLES IN PAVED AREAS SHALL BE FLUSH WITH PAVENERT, AND SHALL HAVE TRAFFIC BEARING RING & COVERS, MANHOLES I UNPAVED AREAS SHALL BE 2' ABOVE FINISH GRADE, LIDS SHALL BE LABELED 'STORM SEWER'.

12. THE CONTRACTOR SHALL ADHERE TO ALL TERMS & CONDITIONS AS OUTLINED IN THE NJDEP OR APPLICABLE STATE GENERAL PERMIT FOR STORMWATER DISCHARGE ASSOCIATED WITH CONSTRUCTION ACTIVITIES. 13. CONTRACTOR SHALL ADJUST AND/OR CUT EXISTING PAVEMENT AS NECESSARY

TO ASSURE A SMOOTH FIT AND CONTINUOUS GRADE. 14. CONTRACTOR SHALL ASSURE POSITIVE DRAINAGE AWAY FROM BUILDINGS FOR ALL NATURAL AND PAVED AREAS.

15. TOPOGRAPHIC INFORMATION IS TAKEN FROM A TOPOGRAPHIC SURVEY BY LAND SURVEYORS. IF THE CONTRACTOR DOES NOT ACCEPT EXISTING TOPOGRAPHY AS SHOWN ON THE PLANS, WITHOUT EXCEPTION, THEN THE CONTRACTOR SHALL SUPPLY, AT THEIR EXPENSE, A TOPOGRAPHIC SURVEY BY A REGISTERED LAND

SURVEYOR TO THE OWNER FOR REVIEW. 16. ALL UNSURFACED AREAS DISTURBED BY GRADING OPERATION SHALL RECEIVE 4 INCHES OF TOPSOIL. CONTRACTOR SHALL APPLY STABILIZATION FABRIC TO AL SLOPES 3H:1V OR STEEPER. CONTRACTOR SHALL STABILIZE DISTURBED AREAS IN ACCORDANCE WITH GOVERNING SPECIFICATIONS UNTIL A HEALTHY STAND OF VEGETATION IS OBTAINED

CONSTRUCTION SHALL COMPLY WITH ALL APPLICABLE GOVERNING CODES AND BE CONSTRUCTED TO SAME.
 ALL STORM STRUCTURES SHALL HAVE A SMOOTH UNIFORM POURED MORTAR

INVERT FROM INVERT IN TO INVERT OUT, UNLESS OTHERWISE NOTED. 19. CONTRACTOR TO MAINTAIN 1.5% MAXIMUM CROSS-SLOPE ON ALL SIDEWALKS

AND CROSSWALKS. CONTRACTOR TO MODIFY PAVEMENT GRADES AS NECESSARY TO MAINTAIN MAXIMUM CROSS-SLOPE IN CROSSWALKS

NECESSARY TO MAINTAIN MAMINUM CURSS-SLOPE IN CRUSSWALKS.

CONTRACTOR TO PROVIDE POSITIVE DRAINAGE AWAY FROM ALL STRUCTURES WITH 2% MINIMUM SLOPE IN PERVIOUS AREAS AND 1.5% MINIMUM SLOPE IN PAVED AREAS UNLESS OTHERWISE NOTED.

21. FOLLOWING DEMOLITION, CLEARING/GRUBBING OPERATIONS, DESIGN CUTS, AND ADDITIONAL CUTTING TO DELIVORE UNDUSTRIES CONSTITUTION.

ADDITIONAL CUTTING TO REMOVE UNSUITABLE CONDITIONS AND PRIOR TO FILL PLACEMENT AND NEW CONSTRUCTION, THE ENTIRE SITE SHOULD BE PROOF-COMPACTED WITH MULTIPLE PERPENDICULAR PASSES OF A LARGE (15-TONSTATIC WEIGHT) VIBRATORY ROLLER TO COMPACT LOOSE, NEAR SURFACE SOILS. HOWEVER, DEPENDING ON THE GROUNDWATER LEVEL AT THE TIME OF CONSTRUCTION, IT MAY BE NECESSARY TO OPERATE THE ROLLER IN STATIC MODE IN ORDER TO MINIMIZE DRAWING WATER UP THROUGH THESE TYPICALLY GRANULAR SOIL TYPES LOOSE, SOFT, WET OR UNSTABLE SOILS IDENTIFIED DURING THE PROOF-COMPACTION SHOULD BE EXCAVATED TO A ACCEPTABLE BEARING STRATUM AS DETERMINED BY A PSI REPRESENTATIVE. IF PRESENT, ABANDONED FOUNDATIONS, SLABS AND UTILITIES SHOULD BE REMOVED ENTIRELY BELOW THE PROPOSED BUILDING AND PAVEMENT AREAS. ANY REQUIRED BACKFILL OR NEW FILL SHOULD COMPLY WITH SECTION 3.3 STRUCTURAL FILL MATERIAL AND PLACEMENT, THE PLACEMENT OF A GEOTEXTILE AND/OR COARSE GRADED STONE MAY BE REQUIRED TO STABILIZE

22. CONTRACTOR TO ADD WATERPROOFING AT ALL LOCATIONS WHERE TH EXTERIOR GRADE IS PROPOSED ABOVE THE FINISHED FLOOR ELEVATION CONTRACTOR TO COORDINATE WITH ARCHITECTURAL DRAWINGS PRICE

STANDARD ABBREVIATIONS AC ACRES

AMERICANS WITH DISABILITY ACT

ADA

ADA	AMERICANS WITH DISABILITY ACT
RCH	ARCHITECTURAL
	100000 00 00 00 00 00 00 00 00 00 00 00
ВС	BOTTOM OF CURB
BF	BASEMENT FLOOR
BK	BLOCK
BL	BASELINE
BLD	BUILDING
BOL	BOLLARD
вм	BENCH MARK
BRL	BUILDING RESTRICTION LINE
CF	CUBIC FEET
CL	CENTERLINE
CMP	CORRUGATED METAL PIPE
NAO	CONNECTION
ONC	CONCRETE
CPP	CORRUGATED PLASTIC PIPE

CY	CUBIC YARDS
DEC	DECORATIVE
DEP	DEPRESSED
DIP	DUCTILE IRON PIPE
DOM	DOMESTIC
LEC	ELECTRIC
LEV	ELEVATION
EP	EDGE OF PAVEMENT
ES	EDGE OF SHOULDER
EW	
	END OF WALL
EX	EXISTING
FES	FLARED END SECTION
FF	FINISH FLOOR ELEVATION
FH	FIRE HYDRANT
FG	
01/00/2	FINISHED GRADE
G	GRADE
GF	GARAGE FLOOR
GH	GRADE HIGH SIDE OF WALL
GL	
	GRADE LOW SIDE OF WALL
GRT	GRATE
GV	GATE VALVE
IDPE	HIGH DENSITY POLYETHYLENE PIPE
HP	HIGH POINT
HOR	HORIZONTAL
HW	HEADWALL
INT	INTERSECTION
INV	INVERT
LF	LINEAR FOOT
LOC	
	LIMITS OF CLEARING
LOD	LIMITS OF DISTURBANCE
LOS	LINE OF SIGHT
LP	LOWPOINT
LS	LANDSCAPE
MAX	
	MAXIVUM
MIN	MNMUM
МН	MANHOLE
MJ	MECHANICAL JOINT
ос	ON CENTER
PC	POINT OF CURVATURE
_	
CCR	POINT OF COMPOUND CURVATURE, CURB RETURN
PI	
	POINT OF INTERSECTION
POG	POINT OF GRADE
POI	POINT OF INTEREST
ROP	PROPOSED
PT	POINT OF TANGENCY
TCR	
1000000	POINT OF TANGENCY, CURB RETURN
PVC	POLYVINYL CHLORIDE PIPE
PVI	POINT OF VERTICAL INTERSECTION
PVT	POINT OF VERTICAL TANGENCY
R	RADIUS
RCP	REINFORCED CONCRETE PIPE
RCPR	REINFORCED CONCRETE WITH RUBBER GASKET
T-WALL	RETAINING WALL
RW	RIGHT OF WAY
5555	
s	SLOPE
SAN	SANITARY SEWER
SF	SQUARE FEET
STA	STATION
STM	5-100 ACM 75
	STORM
TBR	TO BE REMOVED
	TO BE RELOCATED
TBRL.	
TC	TOP OF CURB
тс	
TC TEL	TELEPHONE
TC TEL TP	TELEPHONE TREE PROTECTION
TC TEL	TELEPHONE
TC TEL TP	TELEPHONE TREE PROTECTION
TC TEL TP TW	TELEPHONE TREE PROTECTION TOP OF WALL TYPICAL
TC TEL TP TW TYP UG	TELEPHONE TREE PROTECTION TOP OF WALL TYPICAL UNDERGROUND
TC TEL TP TW TYP UG UP	TELEPHONE TREE PROTECTION TOP OF WALL TYPICAL UNDERGROUND UTILITY POLE
TC TEL TP TW TYP UG UP W/L	TELEPHONE TREE PROTECTION TOP OF WALL TYPICAL UNDERGROUND
TC TEL TP TW TYP UG UP	TELEPHONE TREE PROTECTION TOP OF WALL TYPICAL UNDERGROUND UTILITY POLE
TC TEL TP TW TYP UG UP W/L	TELEPHONE TREE PROTECTION TOP OF WALL TYPICAL UNDERGROUND UTILITY POLE WATER LINE
TC TEL TP TW TYP UG UP W/L W/M	TELEPHONE TREE PROTECTION TOP OF WALL TYPICAL UNDERGROUND UTILITY POLE WATER LINE WATER METER PLUS OR MANUS
TC TEL TP TW TYP UG UP W/L W/M ±	TELEPHONE TREE PROTECTION TOP OF WALL TYPICAL UNDERGROUND UTILITY POLE WATER LINE WATER METER PLUS OR WAUS DEGREE
TC TEL TP TW TYP UG UP W/L W/M ±	TELEPHONE TREE PROTECTION TOP OF WALL TYPICAL UNDERGROUND UTILITY POLE WATER LINE WATER METER PLUS OR MANUS







v	DATE	COMMENT	BY
	03/04/20	ISSUE FOR BID	KGF
	03/13/20	PESOLUTION COMPLIANCE RESUBMISSION	нз

SITE PLAN APPROVAL FOR CHASE BANK


SITE LOCATION 280 & 284 **VALLEY STREET** 14 NEWARK STREET PROVIDENCE, RI

ENGINEER SEAL



SHEET TITLE GENERAL NOTES

RAWN BY: HECKED BY

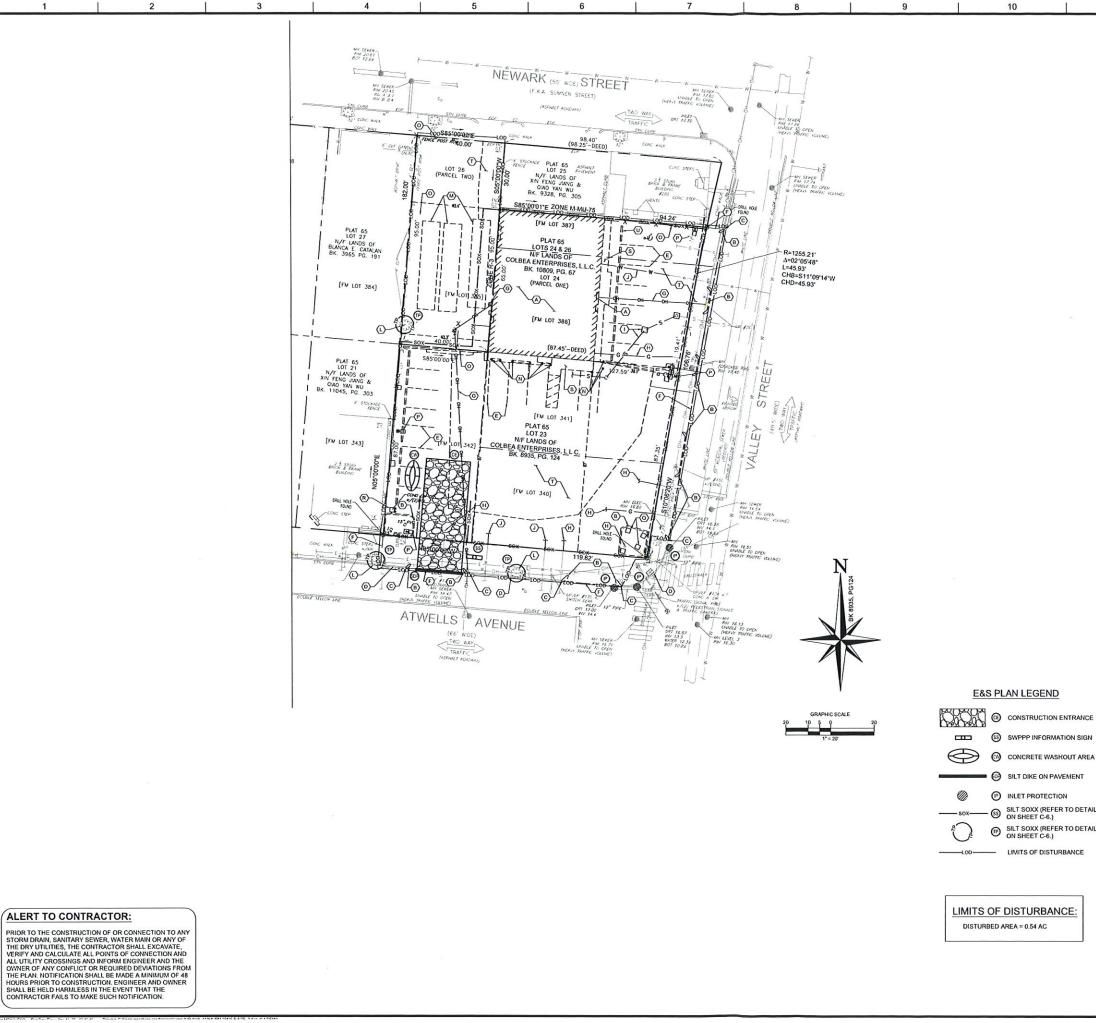

GENERAL NOTES:

1. THIS PROJECT REFERENCES A SURVEY PREPARED BY:
GALLAS SURVEYING GROUP
2865 US ROUTE 1
NORTH BRUNSVICK, NJ 08902
DATE: JUNE 07, 2019
BOUNDARY & TOPOGRAPHIC SURVEY
LOTS 23, 24 & 26, PLAT 65
280-286 VALLEY STREET
14 NEWARY STREET

14 NEWARY STREET CITY OF PROVIDENCE PROVIDENCE COUNTY STATE OF RHODE ISLAND

KEYED NOTES:

- A. EXISTING BUILDING AND CANOPIES TO BE REMOVED.
- EXISTING CURB TO REMOVED. LIMIT OF CURB REMOVAL. CONTRACTOR TO PROTECT IN

- C. LIMIT OF CURB REMOVAL. CONTRACTOR TO PROTECT IN PLACE EXISTING CURB AND REPAIR ANY DAMAGE DONE DURING CONSTRUCTION.

 D. EXISTING CURB TO REMAIN.

 E. EXISTING STRIPING TO BE REMOVED.

 F. PROPOSED SAWCUT LINE.

 G. EXISTING ELECTRICAL LINES AND METERS TO BE REMOVED. CONTRACTOR TO COORDINATE WITH UTILITY COMPANY PRIVED TO CONSTRUCTION. COMPANY PRIOR TO CONSTRUCTION.
- H. EXISTING GAS LINE AND METERS TO BE REMOVED.
- EXISTING GAS LINE AND METERS TO BE REMOVED. CONTRACTOR TO COORDINATE WITH UTILITY COMPANY PRIOR TO CONSTRUCTION.

 EXISTING SEWER LATERAL AND CLEANOUTS TO BE REMOVED AND CAPPED. CONTRACTOR TO COORDINATE SEWER DEMOLITION WITH UTILITY COMPANY. J. EXISTING WATER LINE TO BE REMOVED AND CAPPED.
- CONTRACTOR TO COORDINATE WATER LINE DEMOLITION CONTRACTOR TO COORDINATE WATER LINE DEMOLITION WITH UTILITY COMPANY.

 K. EXISTING UNKNOWN UTILITY LINES TO BE RELOCATED OR REMOVED. CONTRACTOR TO PERFORM TEST PITS TO DETERMINE SIZE, TYPE AND LOCATION OF UTILITY AND COORDINATE WITH APPROPRIATE UTILITY COMPANY TO BE RELOCATED OR REMOVED.

 L. EXISTING TREE TO REMAIN AND BE PROTECTED IN PLACE. REFER TO CONSTRUCTION DRAWINGS FOR TREE PROTECTION DETAIL
- PROTECTION DETAIL.
- M. EXISTING STORAGE TRAILERS TO BE REMOVED FROM

- M. EXISTING STORAGE TRAILERS TO BE REMOVED FROM SITE.

 N. EXISTING BOLLARDS TO BE REMOVED.

 O. EXISTING FENCING TO BE REMOVED.

 P. EXISTING LIGHT POLES AND ELECTRICAL LINES TO BE REMOVED. CONTRACTOR TO COORDINATE WITH UTILITY COMPANY PRIOR TO CONSTRUCTION.

 O. EXISTING SIGN TO BE REMOVED.

 EXISTING SIGN TO BE REMOVED.

 EXISTING SIGN TO BE REMOVED.
- EXISTING AIR COMPRESSOR AND ASSOCIATED UTILITIES
- TO BE REMOVED.
- CONCRETE WALK TO BE REMOVED.
 EXISTING PAVEMENT TO BE REMOVED.
 EXISTING WHEEL STOP TO BE REMOVED.

EXISTING LEGEND

PROPERTY BOUNDARY LINE
CENTER LINE OF EXISTING ROAD!
ADJOINING PROPERTY LINE
EXISTING CURB
EXISTING EDGE OF PAVEMENT
EXISTING FENCE
EXISTING BLOCK NUMBER
EXISTING LOT NUMBER
EXISTING 5' INTERVAL CONTOUR I
EXISTING 1' INTERVAL CONTOUR I
EXISTING TREE
EXISTING GAS MAIN
EXISTING UTILITY POLE
EXISTING STORM STRUCTURES
EXISTING SANITARY STRUCTURES
EXISTING WATER MAIN
EXISTING FIRE HYDRANT
EXISTING WATER VALVE
EXISTING UNDERGROUND ELECTI
EXISTING TELEPHONE

LIMITS OF DISTURBANCE: DISTURBED AREA = 0.54 AC

S SWPPP INFORMATION SIGN

SILT DIKE ON PAVEMENT

(P) INLET PROTECTION SILT SOXX (REFER TO DETAIL ON SHEET C-6.) SILT SOXX (REFER TO DETAIL ON SHEET C-6.) LIMITS OF DISTURBANCE

— — — — — DEMO GRAVEL ROAD
— — — — — DEMO ASPHALT

DEMO TREE - PROPOSED SAWCUT LINE LIMITS OF DISTURBANCE

EXISTING STORM

======= DEMO CURB

COR





SITE PLAN

CHASE BANK 280 & 284 VALLEY STREET

14 NEWARK STREET


APPROVAL FOR

PROVIDENCE, RI ENGINEER SEAL



SHEET TITLE **DEMOLITION PLAN** AND EROSION **CONTROL PLAN**

SCALE: AS NOTE AWN BY HECKED BY:

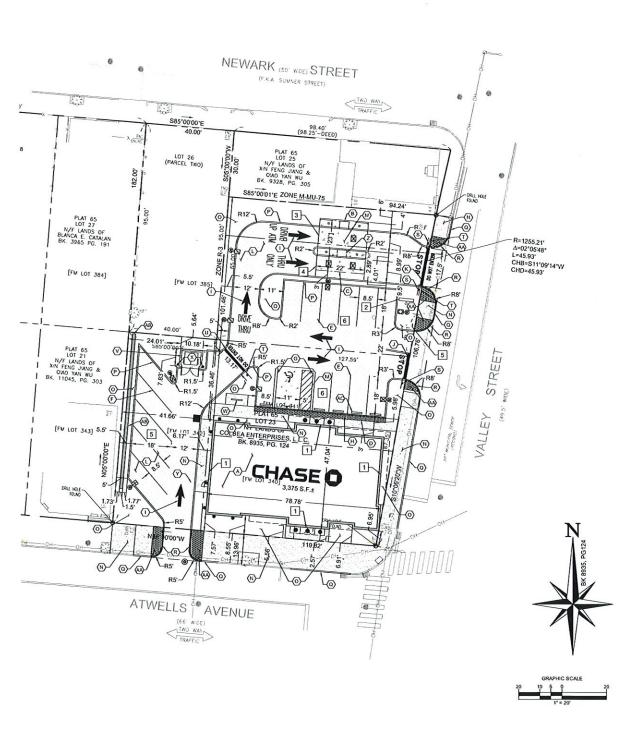

ITEM	REQUIRED	EXISTING	PROPOSED	COMMENT
MIN. LOT AREA	OFEET	20,459 SF	20,459 SF	COMPLIANT*
MIN. LOT FRONTAGE	N/A	N/A	272.51 FT	COMPLIANT
MIN. BUILDING FRONT SETBACK	0-5 FEET	N/A	2.57 FT	COMPLIANT
MIN. INTERIOR SIDE SETBACK	0 FEET (10 FEET ABUTTING RESIDENTAL DISTRICT)	N/A	41.66 FT	COMPLIANT
MIN. CORNER SIDE SETBACK	0-5 FEET	N/A	0.0 FT	NONCOMPLIANT
MIN BUILDING REAR SETBACK	20 FEET	N/A	36.45 FT / 101.46 FT	COMPLIANT
MAX. BUILDING HEIGHT	50 FEET	N/A	26.33 FT	COMPLIANT
MAX. BUILDING LOT COVERAGE	N/A	15.12%	16.5%	COMPLIANT
MAXIMUM LOT COVERAGE	70%	94.16%	61.9%	COMPLIANT

LOT AREA IS CALCULATED BY THE COMBINATION OF LOTS 23, 24 & 26

ITEM

SIGNAGE TABLE

FREESTANDING SIGNS

PERMITTED PROPOSED COMMENT

MAXIMUM SIGN HEIGHT	15 FEET	4.21 FEET	COMPLIANT
MAXIMUM ALLOWED PER FRONTAGE	1 SIGN PER STREET LOT LINE	1 SIGN	COMPLIANT
MAXIMUM AREA ALLOWED	20SF	12 SF	COMPLIANT
	WALL SIGN	s	
,		ALLEY STREET = 1 SIGN	COMPLIANT
MAXIMUM ALLOWED PER	1 SIGN PER BUILDING	NORTH BUILDING SIDE NO STREET = 1 SIGN	COMPLIANT
FRONTAGE	WALL	WEST BUILDING SIDE NO STREET = 1 SIGN	COMPLIANT
		ATWELLS AVE = 1 SIGN	COMPLIANT
MAXIMUM AREA ALLOWED		VALLEY STREET 42.72 FT X 2 SF/FT= 85.44 SF (36.9 SF)	COMPLIANT
	2 SF PER LINER FOOT	NORTH BUILDING SIDE 77.65 SF X 2 SF/FT = 155.3 SF (36.9 SF)	COMPLIANT
	OF BUILDING	WEST BUILDING SIDE 43 FT X 2 SF/FT = 86 SF (36.9 SF)	COMPLIANT
		ATWELLS AVE = 78.78 FT X 2 SF/FT = 157.56 SF (36.9 SF)	COMPLIANT
	DIRECTIONAL S	IGNS	
	4 SF PER SIGN	DRIVE UP LANE DESIGNATOR = 3.1 SF	COMPLIANT
MAXIMUM AREA ALLOWED	4 SF PER SIGN	CLEARANCE SIGN = 2.1 SF	COMPLIANT
	4 SF PER SIGN	DIRECTIONAL SIGN = 2.3 SF	COMPLIANT
	4 FT	DRIVE UP LANE DESIGNATOR = 1.21 FT	COMPLIANT
MAXIMUM HEIGHT ALLOWED	4 FT	CLEARANCE SIGN = 0.83 FT	COMPLIANT
	4 FT	DIRECTIONAL SIGN = 3 FT	COMPLIANT

PARKING CALCULATIONS:

EXISTING:

PLAT 65, LOT 23 = 13 SPACES PLAT 65, LOTS 24 & 26 = 7 SPACES

PROPOSED:

PLAT 65, LOTS 23, 24 & 26 = 17 SPACES

REQUIRED:

MINIMUM ALLOWED: FOR BANK USE = 1 SPACE FOR 500 GFA + 3 STACKING SPACES FOR DRIVE-THRU

3,500 SF / 500 SF + 3 STACKING = 10 SPACES

TOTAL MINIMUM = 10 SPACES MINIMUM

SIGNAGE KEY NOTES: 1

- 1. PROPOSED WHITE W/ BLUE OCTAGON ILLUM CHANNEL
- FOROSED CHASE LOGO SIGN. (3.9. SF)
 PROPOSED DOUBLE-FACED ILLUMINATED MONUMENT SIGN. (12 SF)
 PROPOSED ILLUM DRIVE UP LANE DESIGNATOR "ATM" SIGN.
- (3.1 SF)
 4. PROPOSED NON-ILLUMINATED CLEARANCE SIGN. (2.1 SF)
 5. PROPOSED DOUBLE FACED NON-ILLUMINATED DIRECTIONAL

KEYED NOTES: (A)

- A. PROPOSED CHASE BANK

- PROPOSED CHASE BANK
 PROPOSED DRIVE-UP ATM.
 PROPOSED 22' x 23' CANOPY
 PROPOSED AD COMPLIANT PARALLEL CURB RAMP.
 PROPOSED 8.5' X 16' PARKING SPACE.
 PROPOSED 45 DEGREE ANGLED PARKING SPACE.
 (STALL
- DIMENSION = 8.5'W x 18'L)

 G. PROPOSED 8' X 18' ACCESSIBLE PARKING SPACE AND AISLE.
- PROPOSED ACCESSIBLE PARKING SIGNAGE.
- PROPOSED REFLECTIVE DIRECTIONAL STRIPING. I. PROPOSEO REFLECTIVE DIRECTIONAL STRII
 J. PROPOSED STOP BAR.
 K. PROPOSED STOP AND DO NOT ENTER BAR.
 PROPOSED STOP AND DO NOT ENTER BAR.
 M. PROPOSED CONCRETE PAD.
 N. PROPOSED CONCRETE SIDEWALK
 D. PROPOSED CONCRETE SIDEWALK
 D. PROPOSED CONCRETE CUIDE
 DEDODOSED CONCRETE CUIDE
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- PROPOSED CONCRETE CURB. PROPOSED GRANITE CURB.
- PROPOSED DEPRESSED CURB
- R. PROPOSED DEPRESSED CURB.

 PROPOSED 'STOP SIGN.

 T. PROPOSED 'STOP SIGN.

 U. PROPOSED 'DO NOT ENTER' SIGN.

 U. PROPOSED 'DO NOT ENTER' SIAR.

 V. PROPOSED TRASH ENCLOSURE.

 W. PROPOSED BICYCLE RACK.

 X. PROPOSED BOLLARD. REFER TO CONSTRUCTION DETAIL SHEFET.

- Y. PROPOSED INLET. REFER TO RIDOT CONSTRUCTION DETAIL
- 2. PROPOSED FUTURE ATM. CONTRACTOR TO INSTALL ISLAND AND SEE ELECTRICAL DRAWINGS FOR FUTURE STUB UP LOCATIONS. AA PROPOSED ADA CURB RAMP.
 AB. PROPOSED RETAINING WALL. REFER TO CONSTRUCTION
- DETAILS.
 AC. PROPOSED WHEEL STOP.

SITE LEGEND

EXISTING PROPERTY BOUNDARY LINE — — EXISTING ADJOINING PROPERTY LINE — — — EXISTING UTILITY EASEMENT EXISTING CURB AND GUTTER EXISTING EDGE OF PAVEMENT — PROPOSED CURB PROPOSED DEPRESSED CURB PROPOSED BUILDING PROPOSED SIDEWALK . PROPOSED CONCRETE PROPOSED RIPRAP

PROPOSED ASPHALT ♠ ITI № Θ PROPOSED WATER STRUCTURES

> O 🖺 🖫 📵 PROPOSED STORM STRUCTURES O PROPOSED SANITARY STRUCTURES



☐ EXISTING ELECTRIC STRUCTURE PROPOSED PARKING COUNT

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	CH	IASE BANK	

SITE LOCATION 280 & 284 **VALLEY STREET** 14 NEWARK STREET PROVIDENCE, RI


ENGINEER SEAL HEMAST PICKERIN No 12554 REGISTERED PROFESSIONAL ENGINEER CIVIL HOMAS PICKERING, P.I SHEET TITLE

PLAN 06/10/


SITE

ALERT TO CONTRACTOR:

PRIOR TO THE CONSTRUCTION OF OR CONNECTION TO ANY STORM DRAIN, SANITARY SEWER, WATER MAIN OR ANY OF THE DRY UTILITIES, THE CONTRACTOR SHALL EXCAVATE, VERIFY AND CALCULATE ALL POINTS OF CONNECTION AND ALL UTILITY CROSSINGS AND INFORM ENGINEER AND THE OWNER OF ANY CONFLICT OR REQUIRED DEVATIONS FROM THE PLAN. NOTIFICATION SHALL BE IMADE A MINIMUM OF 48 HOURS PRIOR TO CONSTRUCTION. ENGINEER AND OWNER SHALL BE HELD HARMLESS IN THE EVENT THAT THE CONTRACTOR BAIL STO MAKE SIJCH NOTIFICATION. CONTRACTOR FAILS TO MAKE SUCH NOTIFICATION.

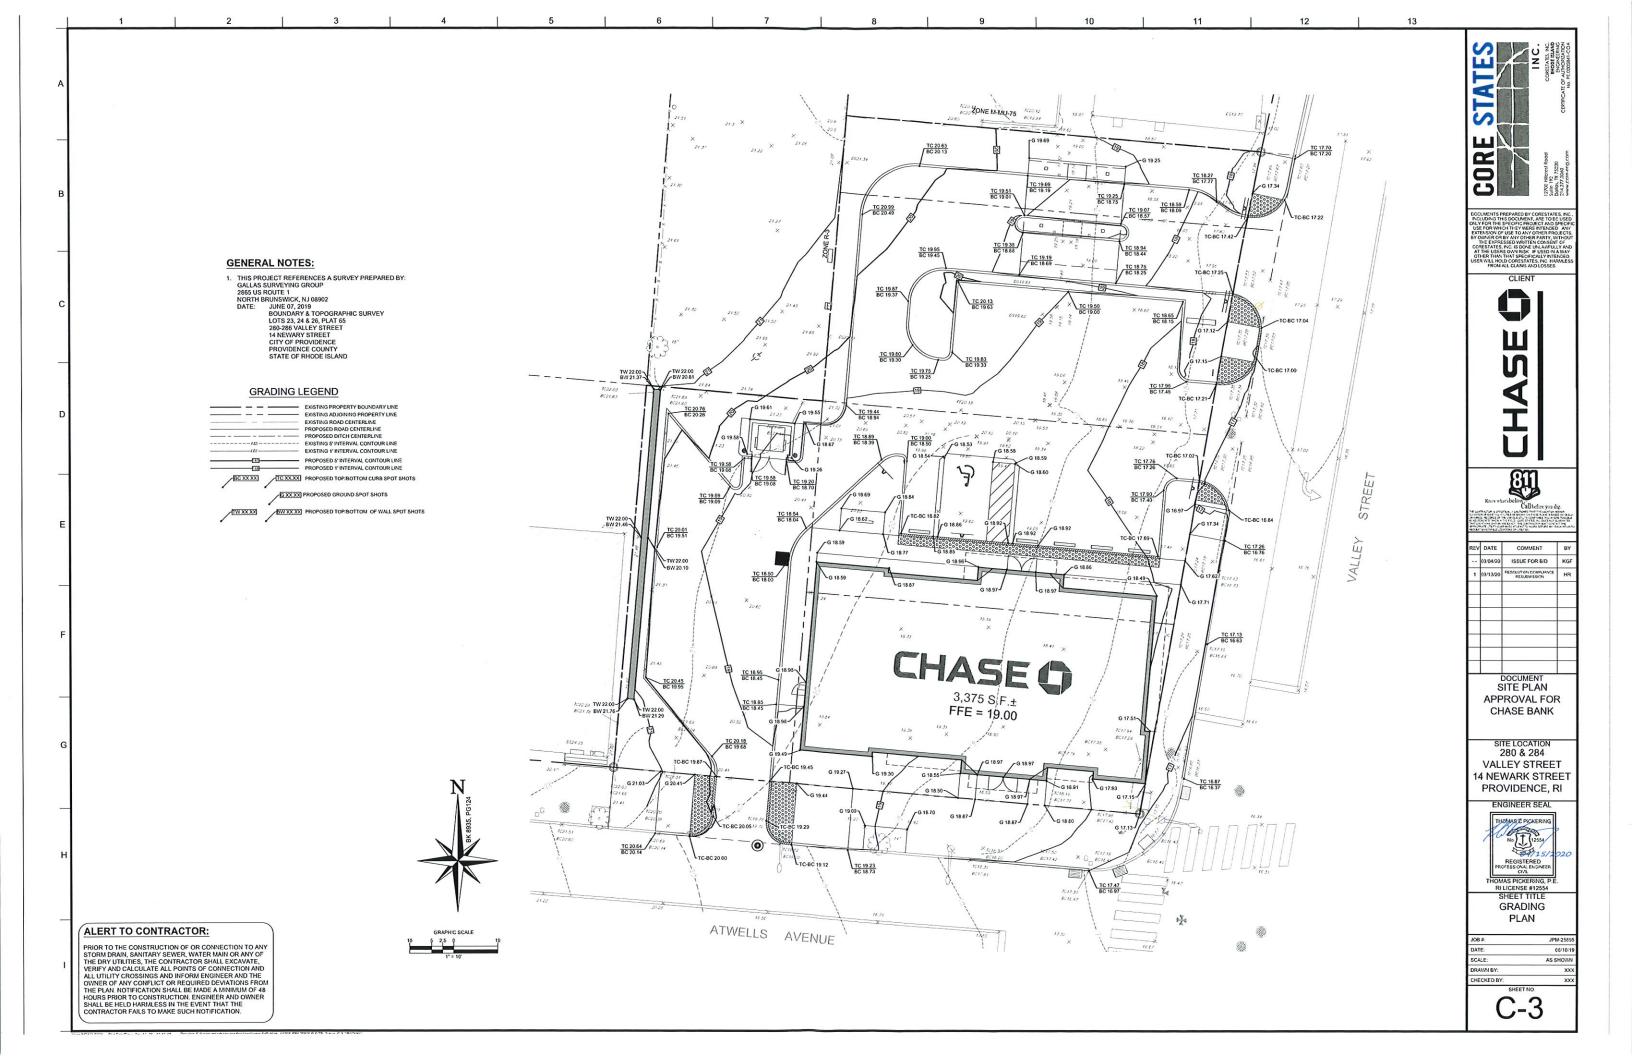

NEWARK STREET

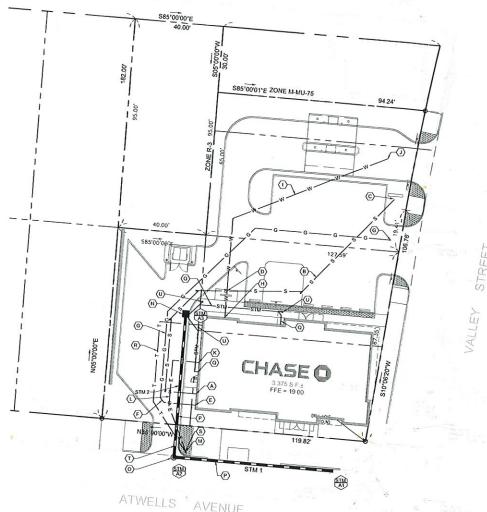



KEYED NOTES: ⊗

A. PROPOSED SANITARY LATERAL BUILDING CONNECTION INVERT

17:00.

B. PROPOSED 4* SDR 26 PVC SANITARY SEWER LATERAL AT A MINIMUM 10% SLOPE.

C. PROPOSED NEW SANITARY SEWER LATERAL TIE-IN CONNECTION

TO EXISTING SEWER MANHOLE, MINIMUM TIE-IN INVERT 14.45. COORDINATION WITH TOWN WATER & SEWER DEPARTMENT IS

COORDINATION WITH TOWN WATER & SEWER DEPARTMENT IS REQUIRED TO VERIFY INVERT OF EXISTING SANITARY SEWER MAIN. CONTRACTOR TO COORDINATE WITH ENGINEER OF RECORD PRIOR TO BEGINNING OF CONSTRUCTION. D. PROPOSED SEWER LINE AND WATER LINE CROSSING. SEWER LINE TO BE ENCASED IN CONCRETE FOR 20'. REFER TO CONSTRUCTION DETAIL SHEET.

 PROPOSED GAS METER.
 PROPOSED GAS SERVICE LINE. CONTRACTOR TO COORDINATE WITH UTILITY COMPANY PRIOR TO CONSTRUCTION.
G. PROPOSED GAS POINT OF CONNECTION AT EXISTING MAIN.

TO CONSTRUCTION.

H. PROPOSED 1-1/2* WATER SERVICE LINE CONNECTION TO BUILDING.

J. PROPOSED 1-1/2* WATER SERVICE LINE.

OF RECORD PRIOR TO INSTALLATION

CONTRACTOR TO COORDINATE WITH UTILITY COMPANY PRIOR

PROPOSED NEW 1-1/2' WATER TAP ON EXISTING ON-SITE WATER LINE. CONTRACTOR TO VERIFY LOCATION OF EXISTING WATER

LINE AND COORDINATE WITH UTILITY COMPANY AND ENGINEER

OF RECORD PRIOR TO INSTALLATION.

R. PROPOSED ELECTRICAL METER AND AUTOMATIC TRANSFER SWITCH. REFER TO ELECTRICAL DRAWINGS FOR SPECIFICATION.

PROPOSED UNDERGROUND 4" ELECTRICAL CONDUIT. REFER TO ELECTRICAL DRAWINGS FOR SPECIFICATIONS.

M. PROPOSED ELECTRICAL POINT OF CONNECTION AT UTILITY POLE. CONTRACTOR TO COORDINATE WITH UTILITY COMPANY CONDUIT.

PRIOR TO INSTALLATION.

N. PROPOSED STORM WATER RIDOT TYPE "F" INLET GRATE. REFER

OF PROPOSED 12* ADS STORM DRAIN LINE. REFER TO STORM STRUCTURE TABLE.

PROPOSED 6* PVC ROOF DRAIN PIPE. CONTRACTOR TO HOLD A

OF PROPOSED 6* PVC ROOF DRAIN PIPE. CONTRACTOR TO HOLD A

MINIMUM 1.0% SLOPE.

R. PROPOSED 2" TELEPHONE LINE, CONTRACTOR TO COORDINATE

HOPOSED 2" TELEPHONE LINE. CONTINATION TO COORDINATE WITH UTILITY COMPANY PRIOR TO CONSTRUCTION.

 PROPOSED TELEPHONE POINT OF CONNECTION AT UTILITY POLE. CONTRACTOR TO COORDINATE WITH UTILITY COMPANY PRIOR TO INSTALLATION.

 PROPOSED ELECTRICAL LINE AND PROPOSED STORM PIPE CROSSING. CONTRACTOR TO PERFORM SOFT DIG TO LOCATE INVERT OF ELECTRICAL LINE AND VERIETY WITH EOR BEFORE PROCESUME WITH INSTALLATION OF STORM DID.

PROCEEDING WITH INSTALLATION OF STORM PIPE

U. PROPOSED ROOF DRAIN CLEAN OUT

V. PROPOSED SANITARY LATERAL CLEAN OUT

TO CONSTRUCTION DETAIL SHEET.
O. PROPOSED DRAINAGE MANHOLE. REFER TO CONSTRUCTION



STORM STRUCTURE TABLE								
STRUCTURE NAME	STRUCTURE TYPE	RIV	INVIN	INO OUT	PIPE NAME	PIPE LENGTH	PIPE SIZE AND TYPE	PIPE SLOPE
A1	EXISTING RIO WI CATCHEASIN	12,054	14.40					
A2	43" DIA CONCRETE MANHOLE	19.65+/-	14.76	14.76	STM I	72 37	12" ADS PVPE	0.50%
£A.	PROPOSED NEW CATCH BASIN	18 04		15.42	STM 2	6533	12" ADS PIPE	1.00%

GENERAL NOTES:

THIS PROJECT REFERENCES A SURVEY PREPARED BY:
GALLAS SURVEYING GROUP
2865 US ROUTE 1

NORTH BRUNSWICK, NJ 08902 JUNE 07, 2019 BOUNDARY & TOPOGRAPHIC SURVEY LOTS 23, 24 & 26, PLAT 65 280-286 VALLEY STREET 14 NEWARY STREET CITY OF PROVIDENCE PROVIDENCE COUNTY STATE OF RHODE ISLAND

UTILITY NOTES:

- 1. THE CONTRACTOR IS SPECIFICALLY CAUTIONED THAT THE THE CONTRACTOR IS SPECIFICALLY CAUTIONED THAT THE LOCATION AND /OR ELEVATION OF EXISTING UTILITIES AS SHOWN ON THESE PLANS IS BASED ON RECORDS OF THE VARIOUS UTILITY COMPANIES, AND WHERE POSSIBLE, WEASUREMENTS TAKEN IN THE FIELD. THE INFORMATION IS NOT TO BE RELIED UPON AS BEING COMPLETE OR EXACT. THE CONTRACTOR MUST CALL THE APPROPRIATE UTILITY.

 COMPANIES AT LEAST 72 HOURS BEFORE ANY EXCAVATION TO PROPURE YEACH THE CONTRACTOR WIST CALL OF CONTRACTOR WIST CALL THE APPROPRIATE UTILITY. REQUEST EXACT FIELD LOCATION OF UTILITIES. IT SHALL BE THE CONTRACTORS RESPONSIBILITY TO RELOCATE ALL EXISTING UTILITIES WHICH CONFLICT WITH THE PROPOSED IMPROVEMENTS SHOWN ON THE PLANS.
- 2. REFER TO ARCHITECTURAL PLANS FOR SITE ELECTRICAL
- 3. MINIMUM HORIZONTAL SEPARATION OF 10 FEET REQUIRED BETWEEN SANITARY SEWER AND WATER LINES.
- 4. MINIMUM VERTICAL SEPARATION OF 2 FEET REQUIRED BETWEEN SANITARY SEWER AND WATER LINES
- 5. CONTRACTOR TO EVALUATE THE CONDITION OF THE EXISTING WATER CONNECTION FOR REUSE PRIOR TO CONSTRUCTION.
- CONTRACTOR TO DETERMINE CONDITION OF THE EXISTING SANITARY LATERAL CONNECTION POINT BEFORE CONSTRUCTION WITH TVI INSPECTION.
- CONTRACTOR TO PROVIDE POWER CONNECTIONS TO SITE LIGHTING AND BUILDING SIGNS AS REQUIRED.
- 8. CONTRACTOR TO MAINTAIN A MINIMUM OF 3 FEET OF COVER FOR ALL PROPOSED SEWER LATERALS AND A MINIMUM OF 4 FEET OF COVER OVER PROPOSED WATER LINES.
- 9. PROPOSED SANITARY SEWER LATERAL IS TO BE PRIVATELY OWNED AND MAINTAINED
- 10. THE TOWNSHIP ENGINEER OR REPRESENTATIVE SHALL
 OBSERVE ALL TESTING OF THE BUILDING SEWER LATERAL. ALL
 EQUIPMENT AND MATERIALS REQUIRED FOR TESTING SHALL BE
 FURNISHED BY THE OWNER OF THE IMPROVED PROPERTY TO
 BE CONNECTED TO A SEWER. THE COST OF INSPECTION SHALL
 DEPONDED TO THE OWNER. BE BORNE BY THE OWNER.
- 11. NO BUILDING SEWER SHALL BE COVERED UNTIL IT HAS BEEN NO BUILDING SEVER STALL BE COVERED WHILL IT HAS BEEN INSPECTED, TESTED AND APPROVED. IF ANY PART OF A BUILDING SEWER IS COVERED PRIOR TO INSPECTION, TESTING AND APPROVAL, IT SHALL BE UNCOVERED FOR INSPECTION AND TESTED AT THE EXPENSE OF THE GENERAL CONTRACTOR.
- 12. SEPARATE UTILITY PERMIT APPLICATIONS WILL BE REQUIRED FOR ANY PROPOSED UTILITY WORK (GAS, ELECTRIC, WATER, ETC.) IN RIDOT ROW. APPLICANT HAS TO BE THE RESPECTIVE UTILITY COMPANY.
- 13. CONTRACTOR TO VERIFY SIZE AND INVERT OF EXISTING CONTROCTOR TO VERIET SIZE AND INVERT OF EXISTING SANITARY TIE-IN PRIOR TO BEGINNING OF CONSTRUCTION TO SEE IF EXISTING LATERAL IS ADEQUATE FOR PROPOSED SANITARY SEWER LATERAL.

UTILITY	LEGEND:
=======	EXISTING PROPERTY BOUNDARY LEXISTING ADJOINING PROPERTY LI
	EXISTING ROAD CENTERLINE PROPOSED ROAD CENTERLINE PROPOSED DITCH CENTERLINE PROPOSED LIMITS OF BMP / DETER
	EXISTING CURB PROPOSED CURB
	PROPOSED MOUNTABLE PROPOSED BUILDING
	PROPOSED RIP RAP PROPOSED CONCRETE
. • • -	PROPOSED WATER STRUCTURES
- B B □ A O	PROPOSED STORM STRUCTURES
□ ○ ⑩	PROPOSED SANITARY STRUCTURE
	EXISTING SANITARY STRUCTURES

EXISTING SANITARY

PROPOSED STORM PIPE - W----- PROPOSED WATER s — s — PROPOSED SANITARY

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SITE LOCATION 280 & 284 VALLEY STREET 14 NEWARK STREET PROVIDENCE, RI

CHASE BANK

ENGINEER SEAL




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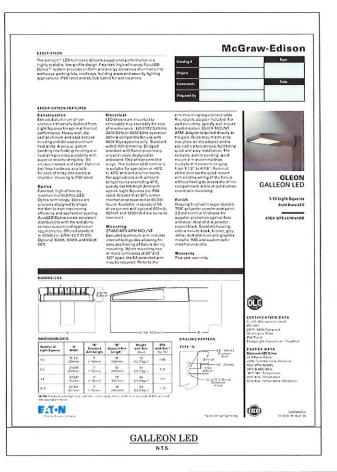
EXISTING WATER STRUCTURES EXISTING GAS MAIN EXISTING WATER MAIN EXISTING UNDERGROUND ELECTRIC EXISTING TELEPHONE


ALERT TO CONTRACTOR: PRIOR TO THE CONSTRUCTION OF OR CONNECTION TO ANY STORM DRAIN, SANITARY SEWER, WATER MAIN OR ANY OF


THE DRY UTILITIES, THE CONTRACTOR SHALL EXCAVATE, VERIFY AND CALCULATE ALL POINTS OF CONNECTION AND ALL UTILITY CROSSINGS AND INFORM ENGINEER AND THE OWNER OF ANY CONFLICT OR REQUIRED DEVIATIONS FROM THE PLAN, NOTIFICATION SHALL BE MADE A MINIMUM OF 48 HOURS PRIOR TO CONSTRUCTION, ENGINEER AND OWNER SHALL BE HELD HARMLESS IN THE EVENT THAT THE CONTRACTOR FAILS TO MAKE SUCH NOTIFICATION

ATWELLS 'AVENUE



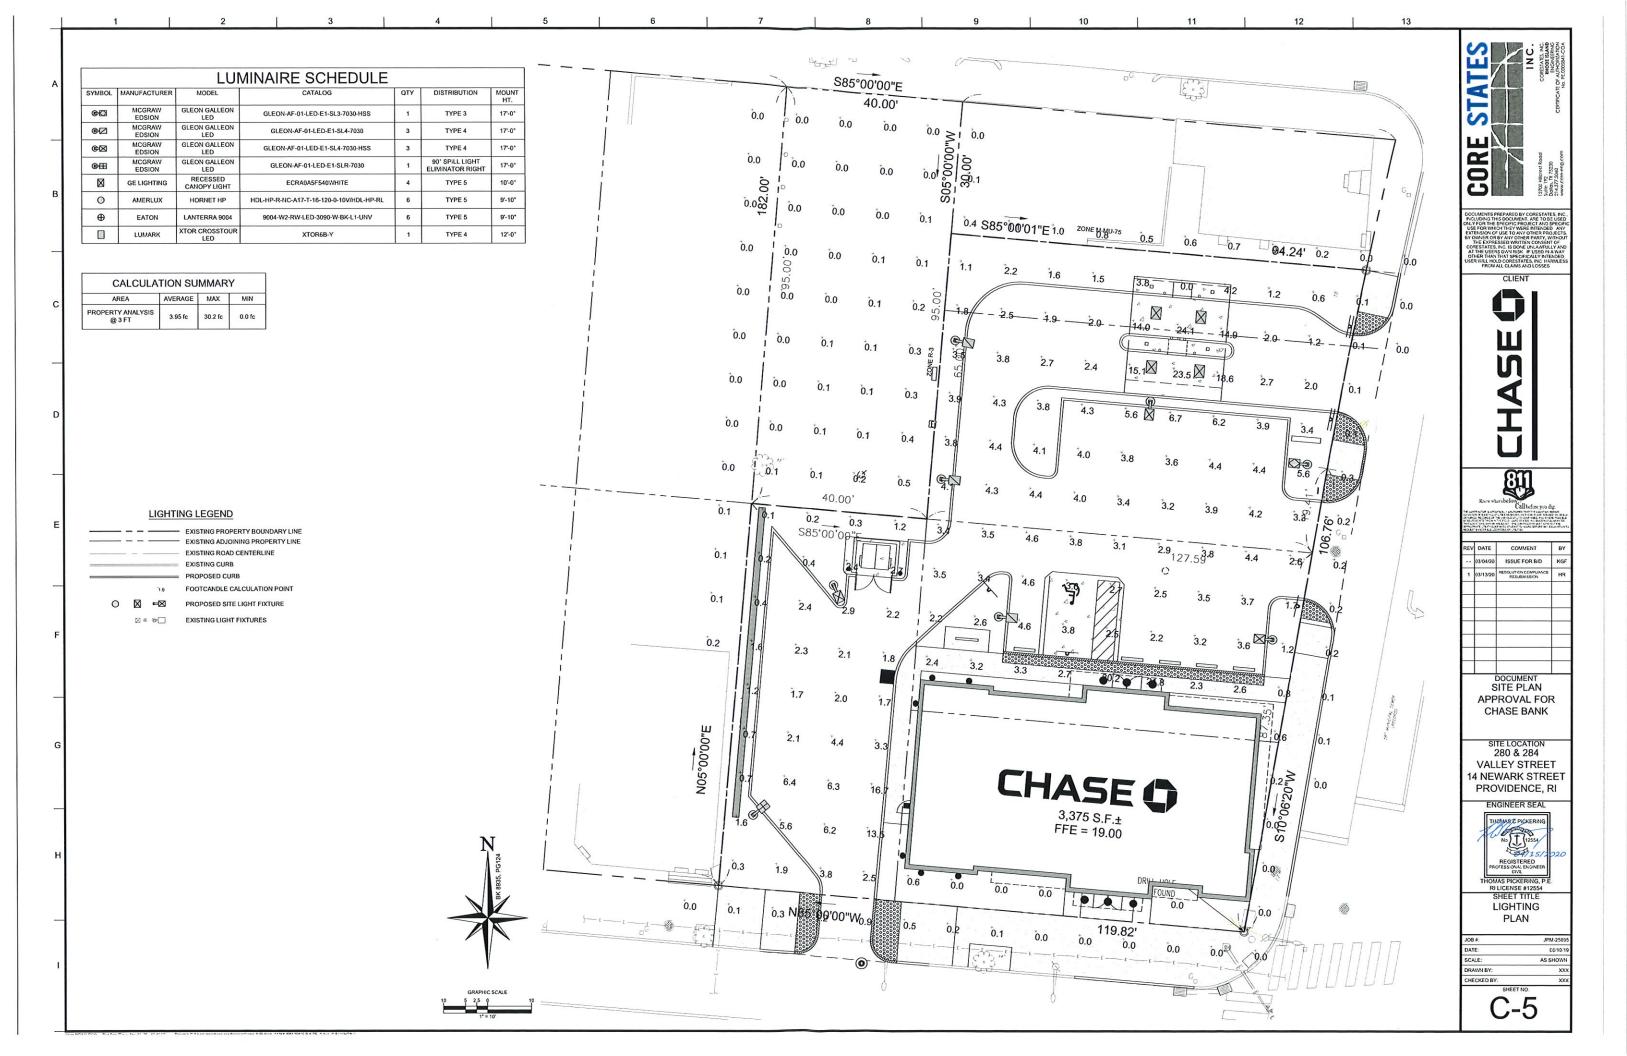


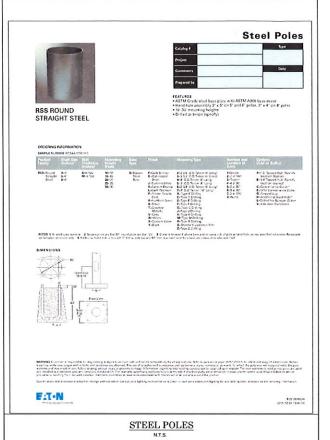


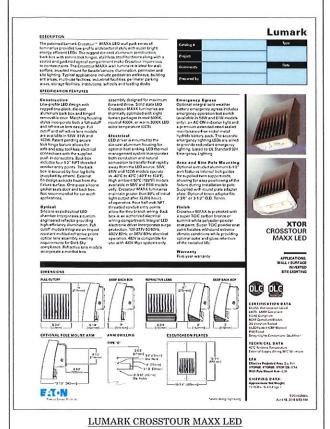




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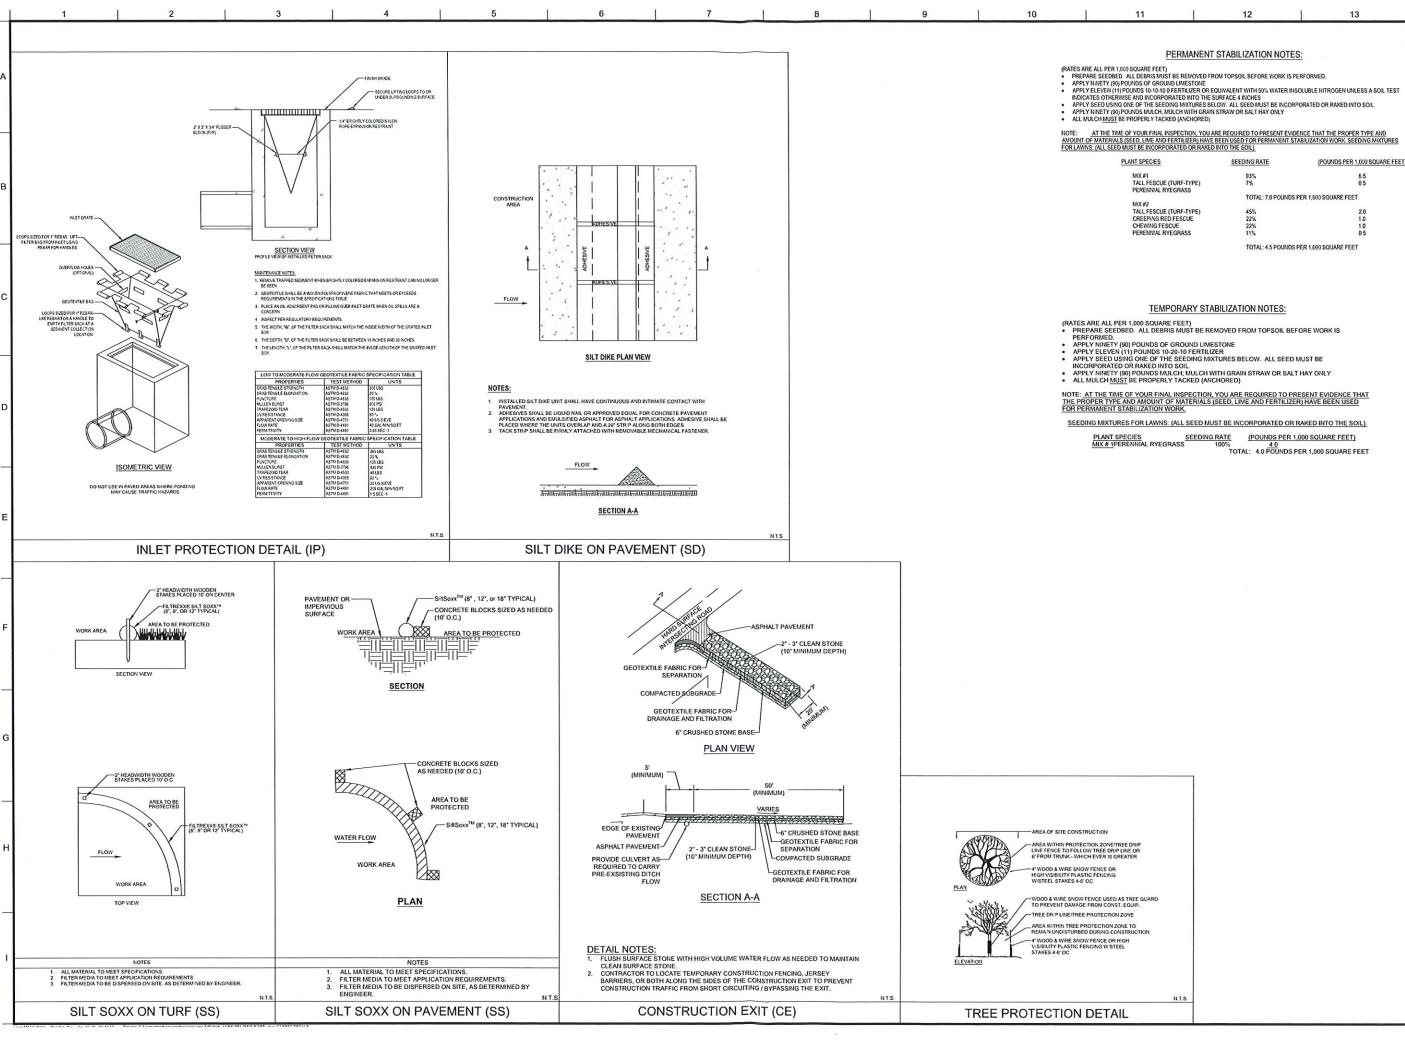


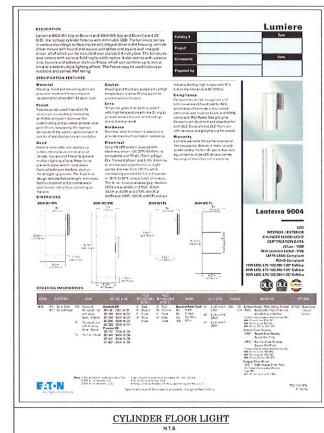

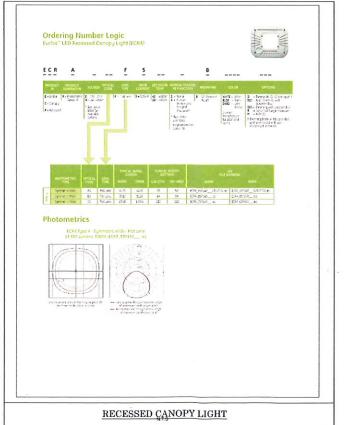

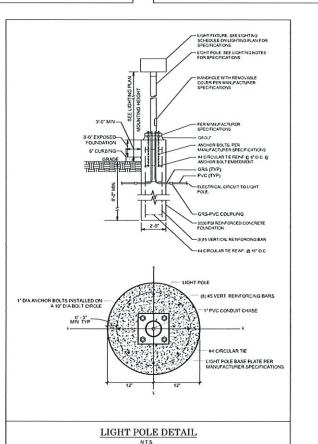

C-6



PLANT SPECIES	SEEDING RATE	(POUNDS PER 1,000 SQUARE FEE
MIX #1	93%	6.5
TALL FESCUE (TURF-TYPE) PERENNIAL RYEGRASS	7%	0.5
	TOTAL: 7.0 POUND:	S PER 1,000 SQUARE FEET
MiX #2		
TALL FESCUE (TURF-TYPE)	45%	2.0
CREEPING RED FESCUE	22%	1.0
CHEWING FESCUE	22%	1.0
PERENNAL RYEGRASS	11%	0.5

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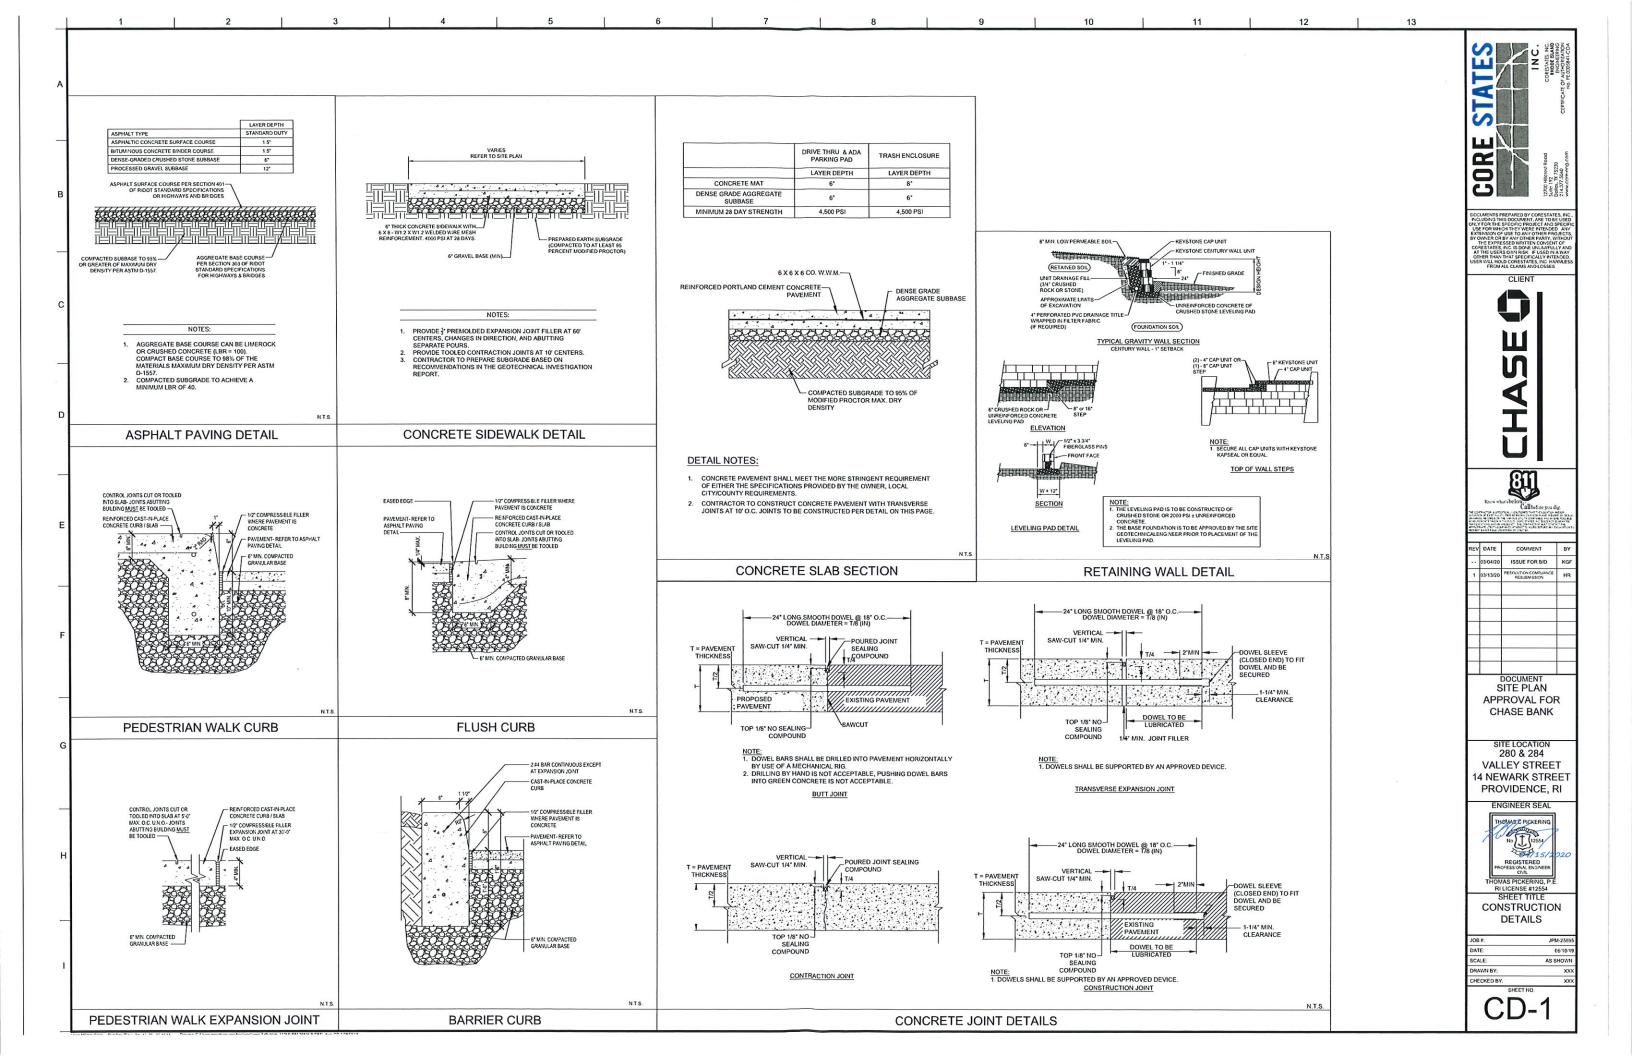
SITE LOCATION 280 & 284 **VALLEY STREET** 14 NEWARK STREET PROVIDENCE, RI


CHASE BANK


ENGINEER SEAL MASE PICKERIN No. 1255 REGISTERED OFESSIONAL ENGINEE THOMAS PICKERING, P.I

SOIL EROSION & SEDIMENTATION CONTROL PLAN

AS SHOW HECKED BY



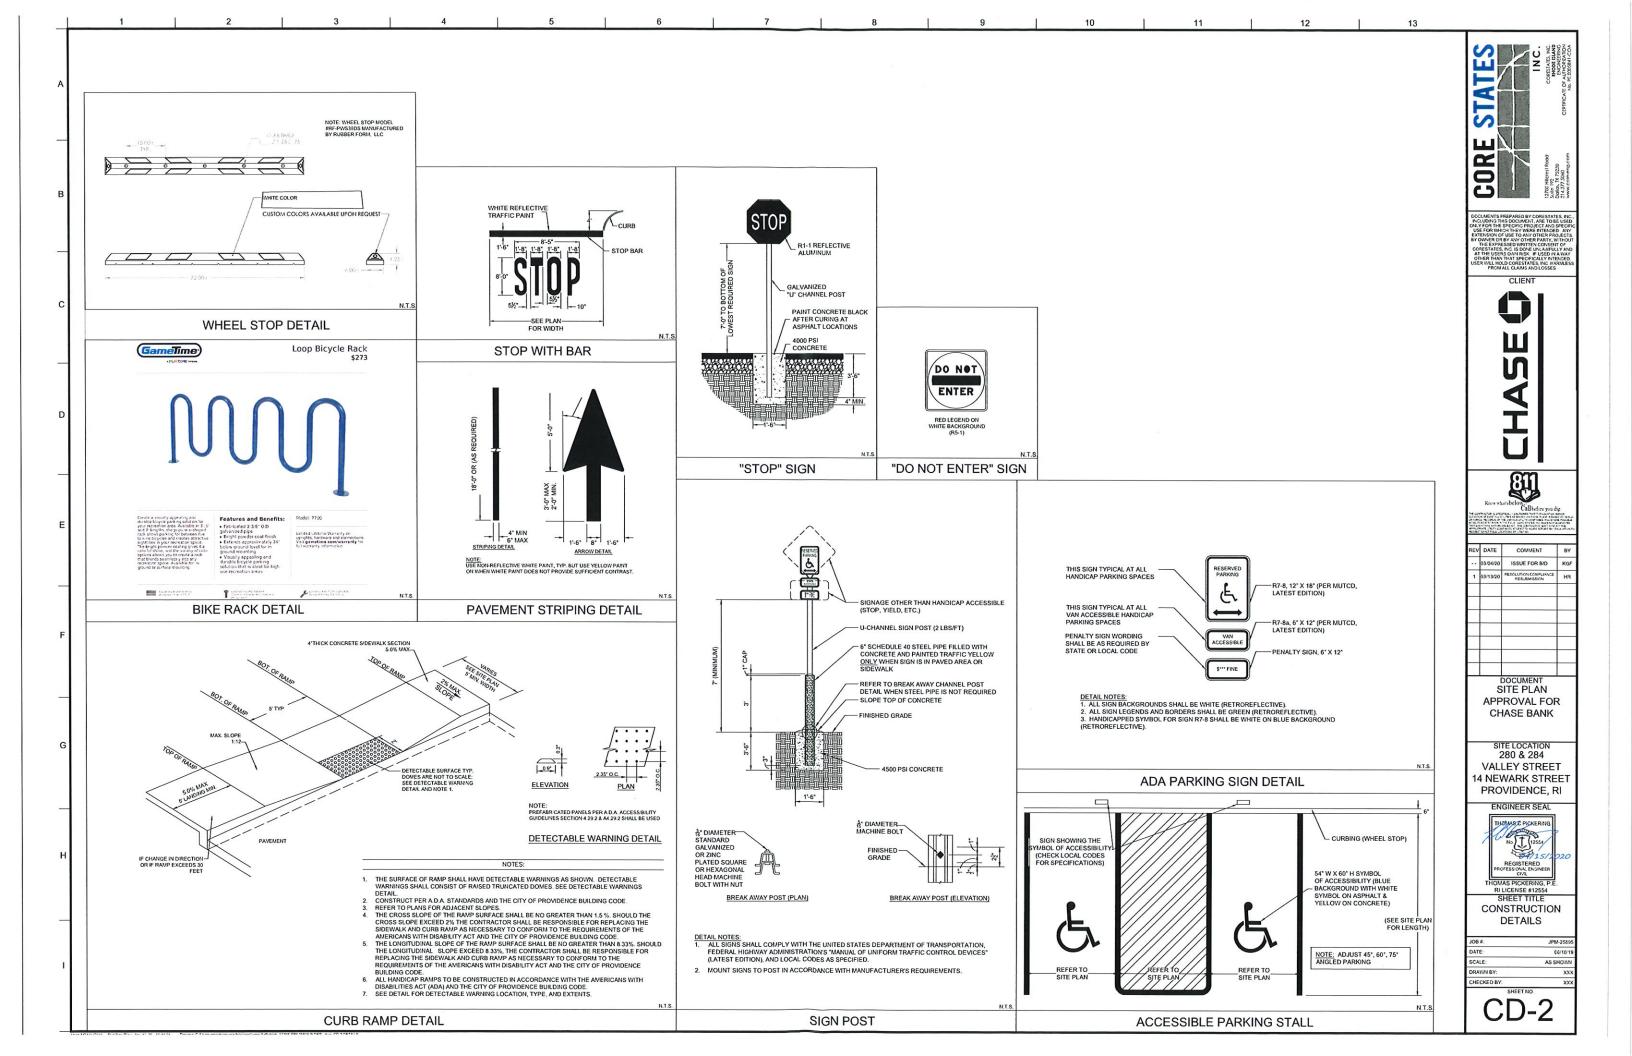

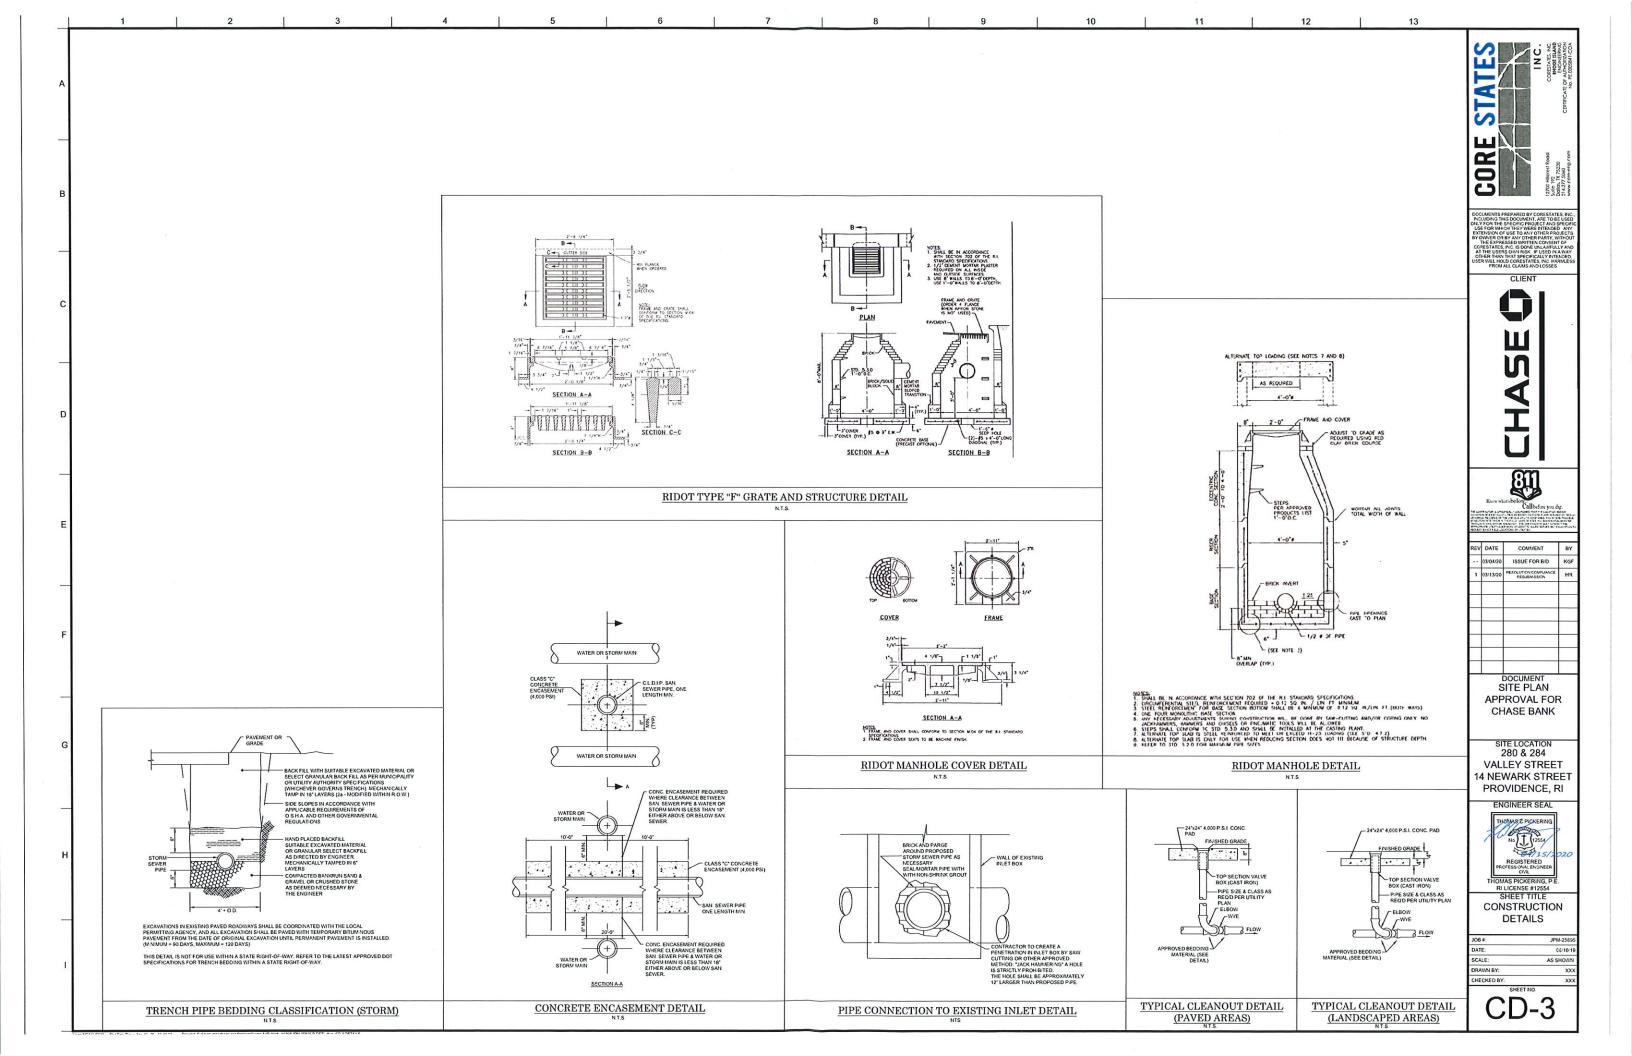

1	- 1		2	1	3		4	1	5
PLANT SCH	EDUL	E							
TREES	CODE	QTY	BOTANICAL / COMMON N	IAME		CALIPER	CONTAINER	SIZE	
	AR	4	Acer rubrum / Red Maple 1,000 S.F. TREE CANOPY	EACH		CONTAINER OR B&B	2*Cal	8'-10' HT.	
D	PY	2	Prunus x yedoensis / Yoshino Cherry 300 S.F. TREE CANOPY EACH			CONTAINER OR B&B	2*Cal	8'-10' HT.	
Θ	QS	4	Ouercus shumardi / Shumard Oak 1,000 S.F. TREE CANOPY EACH			CONTAINER OR B&B	2*Cal	8'-10' HT.	
()	TE	4	Thuja occidentalis 'Erneral	d' / Ernerald Arborvita	e	15 gal		6' HT.	
8	TG	7	Thuja standishii x plicata `C	Green Giant' / Green	Giant Arborvitae	CONTAINER OR B&B		10'-12' HT.	
SHRUBS	CODE	<u>QTY</u>	BOTANICAL / COMMON N	<u>KAME</u>		CONT. SIZE	PLANT SIZE		SPACING
0	AI	32	Azalea Encore 'Autumn Iv	ory' TM / Encore Aza	'ea	3 gal	15"HT. x 15"W.		30° o.c.
*	CF	27	Cyrtomium falcatum / Holly	Fern		3 gal	FULL POT		24° o.c.
₩.	HL	2	Hosta x 'Twist of Lime' / P OR OTHER WHITE-GREE VARIETY	iantain Lily N VARIEGATED AV	AILABLE	3 gal	FULL POT		36° o.c.
(<u>)</u>	JA	45	Juniperus horizontalis "Andorra" / Andorra Juniper			3 gal	FULL POT	FULL POT	
\odot	LJ	23	Ligustrum japonicum / Japanese Privet			15 gal	4° HT.		48° o.c.
淼	MS	21	Miscanthus sinensis 'Adag	joʻ / Dwarf Maiden G	rass	3 gal	18" HT. x 18" W.		30° o.c.
器	MG	20	Miscanthus sinensis 'Grac	illimus` / Maiden Gras	ss	7 gal	4° HT.		48° o.c.
\odot	RX	68	Rosa x 'Apriot Drift' / Aprio	ot Drift Rose		3 gal	FULL POT		24° o.c.
\bigcirc	R3	14	Rosa x 'Radtko' / Double	Knock Out Red Rose		3 gal	18" HT. x 18" W.		36° o.c.
GROUND COVERS	CODE	QTY	BOTANICAL / COMMON I	NAME		SIZE	CONTAINER		SPACING
	ES	92	Eragrostis spectabilis / Pu	ple Love Grass		1 gal	FULL POT		15" o.c.
	ZJ	5,245 sf	Zoysia japonica / Zoysia G	irass		fat			
ROOT BARRIERS THE CONTRACTOR SHALL INSTALL ROOT BARRIERS NEAR ALL NEWLY-PLANTED TREES THAT ARE LOCATED WITHIN FIVE (5) FEET OF PANING OR CURBS. ROOT BARRIERS SHALL BE "CENTURY" OR "DEEP-ROOT" 24" DEEP PANELS (OR EQUIAL). BARRIERS SHALL BE LOCATED IMMEDIATELY ADJACENT TO HARDSCAPE. INSTALL PANELS PER MANUFACTURER'S RECOMMENDATIONS. UNDER NO CIRCUMSTANCES SHALL THE CONTRACTOR USE ROOT BARRIERS OF A TYPE THAT COMPLETELY ENCIRCLE THE ROOTBALL. MULCHES							R		
AFTER ALL PLANTING IS COMPLETE, CONTRACTOR SHALL INSTALL 3" THICK LAYER OF 1-1/2" SHREDDED WOOD MULCH IN ALL PLANTING AREAS									

AF 1EM ALL PLANTING IS COMPLETE, CONTRACTOR SHALL INSTALL 3' THICK LAYER OF 1-1/2' SHREDDED WOOD MULCH IN ALL PLANTING AREAS (EXCEPT FOR TURE AREAS). CONTRACTOR SHALL SUBWIT SAMPLES OF ALL MULCHES TO LANDSCAPE ARCHITECT AND OWNER FOR APPROVAL PRIOR TO CONSTRUCTION. ABSOLUTELY NO EXPOSED GROUND SHALL BE LEFT SHOWING ANYWHERE ON THE PROJECT AFTER MULCH HAS BEEN INSTALLED.

PLANTING AND IRRIGATION GUARANTEE

THE LANDSCAPE CONTRACTOR SHALL GUARANTEE THAT ALL NEWLY INSTALLED AND EXISTING PLANTS SHALL SURVIVE FOR ONE YEAR AFTER FINAL OWNER ACCEPTANCE OF THE INSTALLATION WORK. THE CONTRACTOR SHALL ALSO BE RESPONSIBLE FOR APPROPRIATE WATERING OF THE LANDSCAPE THROUGH INSTALLATION OF A PROPERLY DESIGNED IRRIGATION. SYSTEM. THE OWNER SHALL APPROVE THE SYSTEM DESIGN BEFORE INSTALLATION OF PLANTS OR IRRIGATION.

GENERAL PLANTING NOTES

- THE GENERAL CONTRACTOR IS RESPONSBLE FOR REMOVING ALL EXISTING VEGETATION (EXCEPT WHERE NOTED TO REMAIN). BEFORE STARTING WORK, THE LANDSCAPE CONTRACTOR SHALL VERIFY THAT THE GRADE OF ALL LANDSCAPE AREAS ARE WITHIN 14-0.1 OF FINISH GRADE. THE LANDSCAPE CONTRACTOR SHALL NOTIFY THE OWNER MUMEDIAELY SHOULD ANY DISCREPANCIES EXIST. SEE SPECIFICATIONS FOR MORE DEFAULE IN INTRUCTION ON TURE AREA AND PLANTING BED PREPARATION.

 CONSTRUCT AND MAINTAIN FINISH GRADES IN LANDSCAPE AREAS AS SHOWN ON GRADING PLAIS, AND CONSTRUCT AND MAINTAIN SLOPES AS RECOMMENDED BY THE GOTECHNICAL REPORT, LANDSCAPE AREAS SHALL HAVE POSITIVE DRANAGE AWAY FROM STRUCTURES AT THE MINIMUM SLOPE SPECIFIED IN THE REPORT, AND AREAS OF POTENTIAL PONDING SHALL BE REGRADED TO BLEND IN WITH THE SURROUNDING GRADES AND ELIMINATE PONDING POTENTIAL. PONDING SHALL BE REGRADED TO BLEND IN WITH THE SURROUNDING GRADES AND ELIMINATE PONDING POTENTIAL. SHOULD HAVE CONTROLLED, THE CONTROLLED ON THE CONTR

- INSTALL MULCH TOPDRESSING, TYPE AND DEPTH PER MULCH NOTE, IN ALL PLANTING BEDS AND TREE RINGS. DO NOT

- INSTALL MUICH TOPORESSING, TYPE AND DEPTH PER NUICH NOTE, IN ALL PLAYTING BEDS AND TREE RINGS. DO NOT
 INSTALL MUICH WITHIN 6" OF TREE ROOT FLARE.
 INSTALL 14G, GREEN STEEL EDGING BETWEEN ALL PLAYTING BEDS AND TURF AREAS, AND BETWEEN GROUNDCOVERS
 AND OTHER FAUNTS (WHERE INDICATED ON THE PLAY).
 HYDROMULCH ALL DISTURBED AREAS OUTSIDE OF PROPERTY LIMITS (WILESS SHOWN AS SOD).
 ALP AUT LOCATIONS ARE DIAGRAMMATIC. ACTUAL LOCATIONS SHALL BE VERIFIED WITH THE LADSCAPE AREA
 ALP AUT LOCATIONS ARE DIAGRAMMATIC. ACTUAL LOCATIONS SHALL BE VERIFIED WITH THE LADSCAPET ARE
 PERMITTING AUTHORITY ARE MET (I.E., MANIMUM PLAYT QUANTITIES, PLAYTING METHODS, TREE PROTECTION METHODS,
 PERMITTING AUTHORITY ARE MET (I.E., MANIMUM PLAYT QUANTITIES, PLAYTING METHODS, TREE PROTECTION METHODS,
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- ETC.). THE LANDSCAPE CONTRACTOR IS RESPONSIBLE FOR DETERMINING PLANT QUANTITIES; PLANT QUANTITIES SHOWN ON
- THE LANDSCAPE CONTRACTOR IS RESPONSIBLE FOR DETERMINING PLANT LOWNTHINES, PLANT DUANTITIES SHOWN ON LEGENDS AND CALLOUTS ARE FOR GENERAL INFORMATION ONLY. IN THE EVENT OF A DISCREPANCY BELIEVE THE PLAN AND THE PLANT LEGEND, THE PLANT DUANTITY AS SHOWN ON THE PLAN (FOR INDIVIDUAL SYMBOLS) OR CALLOUT (FOR GROUNDCOVER PATTERNS) SHALL TAKE PRECEDENCE.

 NO SUBSTITUTIONS OF PLANT MATERIALS SHALL BE ALLOWED WITHOUT THE WRITTEN PERMISSION OF THE LANDSCAPE ARCHITECT, IF SOME OF THE PLANTS ARE NOT AVAILABLE, THE LANDSCAPE CONTRACTOR SHALL NOTIFY THE LANDSCAPE ARCHITECT IN WRITING (VIA PROPER CHANNELS).

 PLANTS MAY BE INSPECTED AND APPROVED OR REJECTED ON THE JOBSITE BY THE OWNER OR OWNERS REPRESENTATIVE.
- THE LANDSCAPE CONTRACTOR SHALL BE RESPONSIBLE FOR THE MAINTENANCE OF ALL WORK SHOWN ON THESE PLANS THE LANDSCAPE CONTRACTOR SHALL BE RESPONSIBLE FOR THE MAINTENANCE OF ALL WORK SHOWN ON THESE PLANS FOR 90 DAYS BEYOND FINLA ACCEPTANCE OF ALL LANDSCAPE WORK BY THE OWNER. LANDSCAPE MERINGE SHALL INCLUDE WEEKLY SITE VISITS FOR THE FOLLOWING ACTIONS (AS APPROPRIATE) PROPER PRUNING, RESTAKING OF TREES, RESENTING OF PLANTS THAT HAVE SETTLED. MOWING AND AERTION OF LANNS, WEEDING, RESCHOK AREAS WHICH HAVE NOT GERMINATED WELL, TREATING FOR INSECTS AND DISEASES REPLACEMENT OF MUICH, REMOVAL OF LITTER, REPARS TO THE IRRIGATION SYSTEM DUE TO FAULTY PARTS AND/OR WORKING MAINSHIP, AND THE PROPORTIATE WATERING OF ALL PLANTINGS. THE LANDSCAPE CONTRACTOR SHALL MERICATION SYSTEM IN PROPER WORKING ORDER, WITH SCHEDULING ADJUSTMENTS BY SEASON TO MANAZIZE WATER CONSERVATION. SHOULD SEEDED AND/OR SOODED AREAS NOT BE COVERED BY AN AUTOMATIC IRRIGATION SYSTEM, THE LANDSCAPE CONTRACTOR SHALL BE RESPONSIBLE FOR WATERING THESE AREAS AND OBTAINING A FULL STAND OF GRASS AT NO ADDITIONAL COST TO THE OWNER.
- TO ACHIEVE FINAL ACCEPTANCE AT THE END OF THE MAINTENANCE PERIOD, ALL OF THE FOLLOWING CONDITIONS MUST

- ICUR:

 THE LANDSCAPE SHALL SHOW ACTIVE, HEALTHY GROWTH (WITH EXCEPTIONS MADE FOR SEASONAL DORMANCY), ALL PLANTS NOT MEETING THIS CONDITION SHALL BE REJECTED AND REPLACED BY HEALTHY PLANT MATERIAL PRIOR TO FINAL ACCEPTANCE.

 ALL HARDSCAPE SHALL BE CLEANED PRIOR TO FINAL ACCEPTANCE.

 SODDED AREAS MUST BE ACTIVELY GROWING AND MUST REACH A MINIMUM HEIGHT OF 1 1/2 INCHES BEFORE FIRST MOWING. HYDROMULCHED AREAS SHALL SHOW ACTIVE, HEALTHY GROWTH. BARE AREAS LARGER THAN TWELVE SQUARE INCHES MUST BE RESODDED OR RESEEDED (AS APPROPRIATE) PRIOR TO FINAL ACCEPTANCE. ALL SODDED THIS FINAL BE NEATLY MOWED.
- 15. SEE SPECIFICATIONS AND DETAILS FOR FURTHER REQUIREMENTS.

PROVIDENCE, RI PERMIT LANDSCAPE PLA	N REQUIREMENTS		0	
REQUIRED TREE CANOPY	TOTAL PARCEL (SF)	REQUIREMENT (%)	REQUIRED CANOPY (SF)	PROVIDED CANOPY (SF)
15% of Lot Devoted to Landscape	20,500	0.15	3,075	8,900
PERIMETER PARKING LOT LANDSCAPE	LOT LENGTH ALONG R/W (FT.)	REQUIREMENT	REQUIRED LANDSCAPE	PROVIDED LANDSCAPE
5' Wide + 6" Curb Offset Adjacent to ROW	76	1 Shade Tree / 25 L.F. 60% Length w/ 3' Shrubs OR Wall @ 3'-4' Ht	3 Shade Trees Approx. 30 Shrubs in Double- Row Configuration @ 3' o.c.	3 Shade Trees 79 Shrubs
INTERIOR PARKING LOT LANDSCAPE	PARKING LOT AREA (SF)	REQUIREMENT	REQUIRED LANDSCAPE	PROVIDED LANDSCAPE
Interior Landscape Area Shall be Minimum of 10% of Total Parking Area Excluding Penmeter Landscape Areas, 1 Island / 10 Pking, Spaces	8,520	1 Shade Tree / Each Car-Length Island with Living Groundcover	7 Shade Trees with 852 s.f., Minimum of Living Groundcover	7 Shade Trees with 115 Plants (852 s.f. Minimum)
PERIMETER PKNG LOT LS ABUTTING RESIDENTIA	LOT LENGTH ALONG RES. (FT.	REQUIREMENT	REQUIRED LANDSCAPE	PROVIDED LANDSCAPE
	87	4' Ht. Wall, Fence or Hedge	(22) 4' Ht. Min. Shrubs @ 4' o.c.	4 Shrubs (Wall Provided)







M



REV	DATE	COMMENT	BY
001	4.15.20	Revised CAD Base	GP
_			
_			_

SITE PLAN APPROVAL FOR CHASE BANK

SITE LOCATION 280 & 284 VALLEY STREET 14 NEWARK STREE PROVIDENCE, RI

ENGINEER SEAL PANST PICKER No 112554 REGISTERED OFESSIONAL ENGINE CIVIL

> RI LICENSE #12554 SHEET TITLE LANDSCAPE

PLANTING GP/RA

LP-1

NORTH

SCALE: 1" = 20"

ATM DRIVE THRU & OVERHEAD Secretary Secret PROPERTY LINE, TYPICAL STREET PROPERTY LINE, TYPICAL RETAINING WALL THIS SIDE BY É HESE PLANTING BEDS TO RECEIVE METAL EDGING BETWEEN BED & SOD PER THE & SOD PER THE DETAIL ON SHEET LP-2

10

NEWARK (50' WOE) STREET (F.K.A. SUNNER STREET)

SEE EARTH SPADE BED EDGE DETAIL SHEET LP-2 FOR PERIMETER HEDGE BEDLINE

THE CONTRACTOR IS SECRICALLY CAUTONED THAT THE LOCATION AND/OR ELEVATION OF DISTING ULTIMES AS BROWN OF THESE BLANS IS BASED ON DESCRIP DRAWINGS RECORDS OF THE SECONER DOES NOT COMMANDE THAT HE PROPERTY OF THE PROPERTY O

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CUMENTS PREPARED BY CORESTATES, INC CLUDING THIS DOCUMENT, ARE TO BE USED Y FOR THE SPECIFIC PROJECT AND SPECIF YOMER ON BIT A WATER CONSENT OF EXPRESSED WRITTEN CONSENT OF CORESTATES, NO. IS DONE UNLAWFULLY AN AT THE USERS OWN RISK. IF USED IN A WATER OTHER THAN THAT SPECIFICALLY MITEMORE THAN THAT SPECIFICALLY MITEMORE OF THE PROPERTY OF THE PROP ER THAN THAT SPECIFICALLY I WILL HOLD CORESTATES, INC. FROW ALL CLAIMS AND LOSS

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SITE PLAN APPROVAL FOR CHASE BANK

SITE LOCATION 280 & 284 **VALLEY STREET** 14 NEWARK STREET PROVIDENCE, RI

ENGINEER SEAL


HOMASIE PICKERIN No. 12554/ HOMAS PICKERING, P.E RI LICENSE #12554


SHEET TITLE **PLANTING**

DETAILS & SPECS

04/15/202 HECKED BY: GP/RM

LP-2

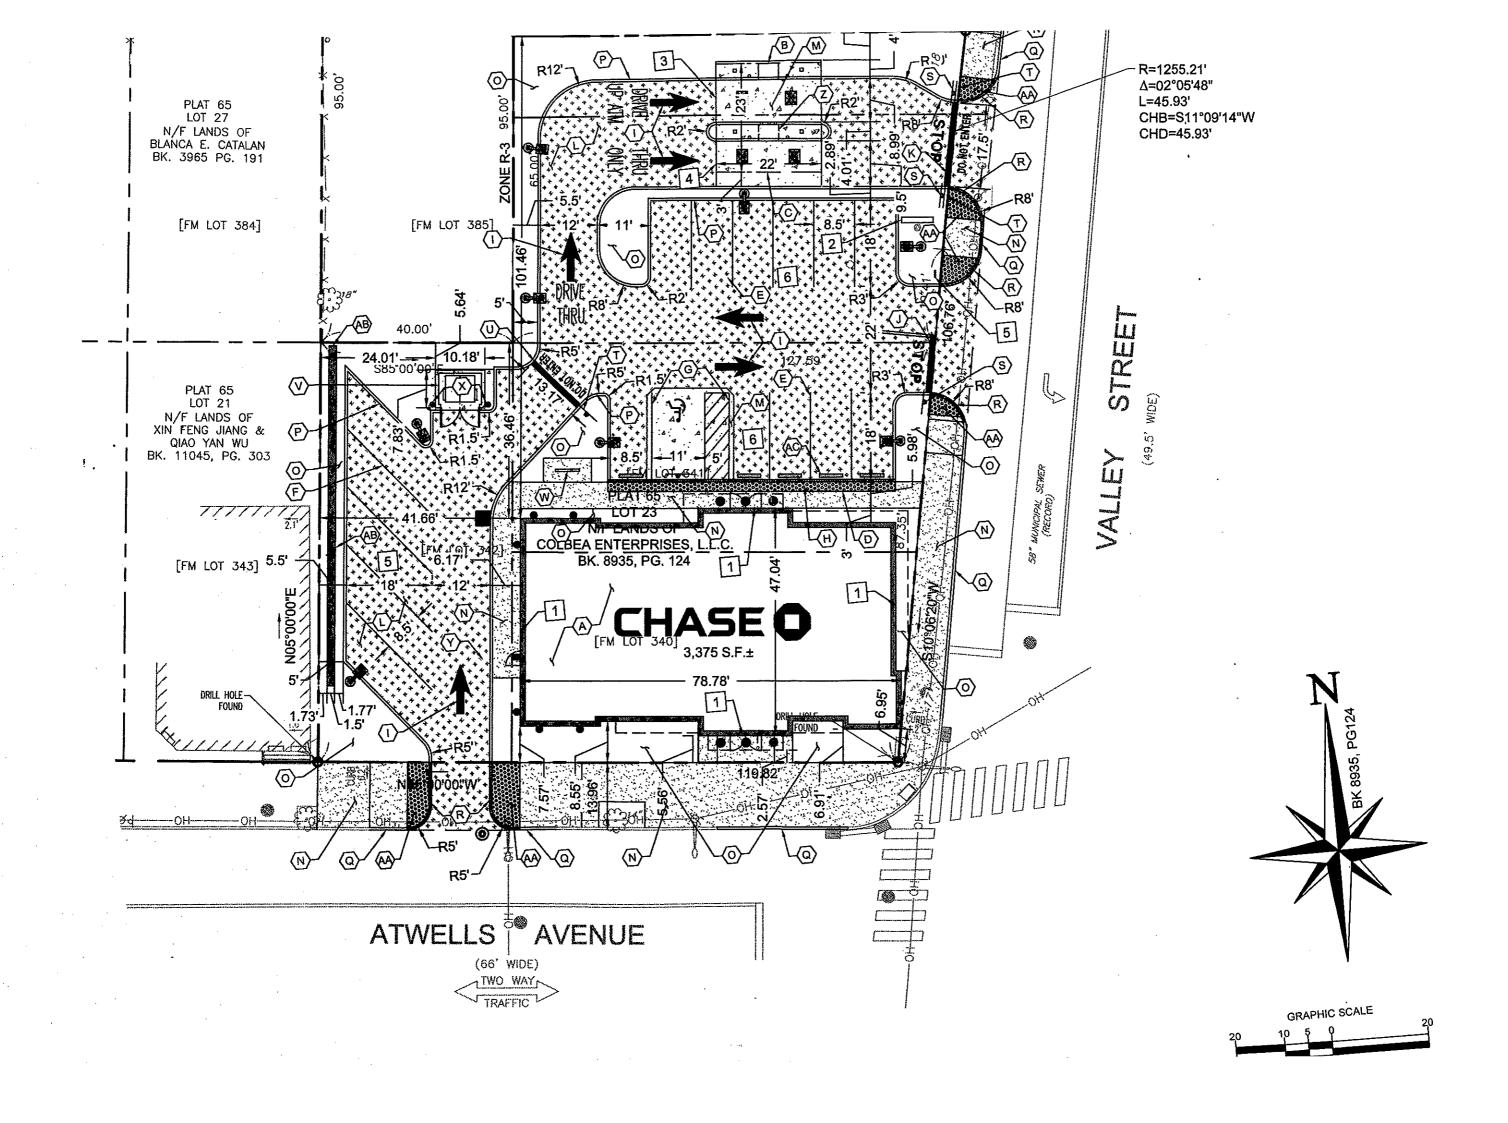

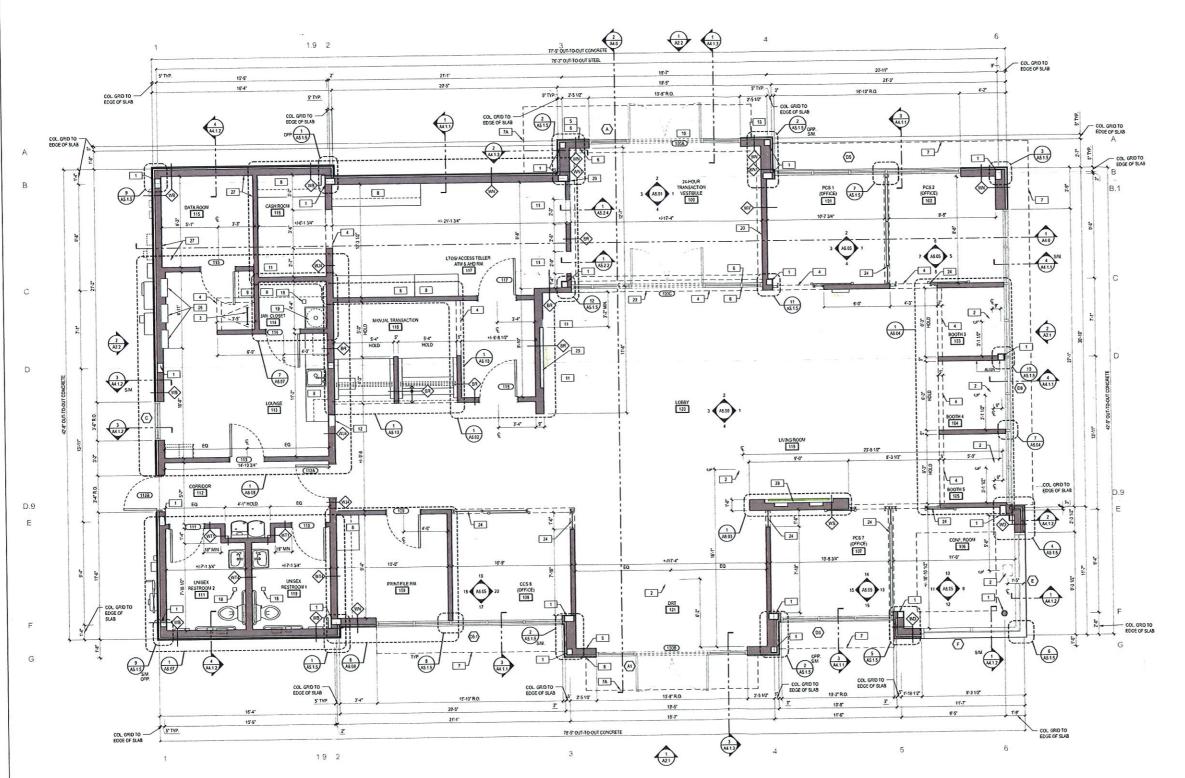



GENERAL FLOOR PLAN NOTES

Α.	A	ALL INTERIOR WALL PARTITIONS TO BE WJ U.N.O. (SE SHEET A3.1.0 FOR ADDITIONAL INFORMATION).		
	В	ALL DOOR FRAMES TO HAVE 5' RETURN ON HINGE SE U.N.O.		
	С	NOT ALL KEYNOTES MAY BE USED. REFER TO DRAW!		

F	LOOR PLAN KEYNOTES
1	STRUCTURAL COLUMN: COORDINATE WITH STRUCTURAL ENGINEERING DRAWINGS
2	POWER DATA FLOOR BOX: REFER TO ELECTRICAL DRAWINGS FOR ADDITIONAL INFORMATION, COORDINATE LOCATIONS WITH STRUCTURAL DRAWINGS.
3	ROOF ACCESS LADDER & SCUTTLE: REFER TO ROOF PLAN AND DETAIL AS NOTED
4	SOFFIT / BULGHEAD ABOVE: REFER TO REFLECTED CELLING PLANS, SECTIONS, DETALS AND INTERIOR ELEVATIONS, PROVIDE DEFLECTION TRACK AT UNDERSIDE OF ROOF / FLOOR STRUCTURE ABOVE TO ALLOW BULGHEAD TO REST ON DEMONITABLE PARTITION SYSTEM BELOW.
5	CARD READER: REFER TO EXTERIOR ELEVATIONS AND ELECTRICAL DRAWINGS FOR ADDITIONAL INFORMATION.
6	AUTOMATIC DOOR OPERATOR SYSTEM: REFER TO ELEVATIONS AND DOOR SCHEDULE.
7	SUNSHADE SYSTEM: KAWNEER SUNSHADE
7A	CANOPY SYSTEM: MAPES SUPER LUMIDECK CANOPY SYSTEM.
8	CUSTOW SHOP-FABRICATED BUILT-IN MILLWORK: REFER TO INTERIOR ELEVATIONS- SUBMIT SHOP DRAWMOS AND FINISH SAMPLES TO ARCHITECT FOR APPROVAL
9	ADJUSTABLE SHELVES: REFER TO INTERIOR ELEVATIONS-PROVIDE BLOCKING IN WALL AS REQUIRED
10	SUPPORTED CONCRETE STOOP: ACCESSIBILITY-COMPLIANT CONTINUOUS PAVING TO PUBLIC R.O.W. REQD. FROM ALL EXITS
11	EQUIPMENT APPLIANCE: REFER TO EQUIPMENT INSTALLATION MANUAL - COCRODATE WITH EQUIPMENT INSTALLER - PROVIDE ELECTRICAL, DATA, AND SECURITY PACIFIES REQUIPMENT - PRAME WALL OPENING AND PREPARE FLOOI SUBSTRATE AS REQUIRED. PROVIDE BLOCKING IN WALL AS REQUIRED.
12	FIRE EXTINGUISHER AND CABINET: PROVIDE THE MINIMUM NUMBER AS REQUIRED AND COORDINATE LOCATIONS WITH CODE REQUIREMENTS AND ADJACENT ACCESSIBILITY CLEARANCES
13	KNOX BOX: MOUNTED FLUSH WITH SURROUNDING WALL SURFACE. VERIFY LOCATION WITH LOCAL MUNICIPALITY TO ENSURE COMPLIANCE. PAINT TO BLEND WITH SURROUNDING WALL FINISH.
14	CEIUNG LIGHT FIXTURE COVE- REFER TO REFLECTED CEIUNG PLAN
15	NOT USED
16	STOREFRONT GLAZING SYSTEM INTERIOR PARTITION - REFER TO INTERIOR ELEVATIONS
17	DEMOUNTABLE PARTITION SYSTEM WITH INTEGRAL DOORS AND POWER, DATA AND SECURITY CONDUIT SYSTEMS, ANCHORED TO BUILDING WALLS. SUBFLOOR, AND BUILDHEADS
18	FLOOR DRAIN: REFER TO PLUMBING DRAWINGS FOR ADDITIONAL INFORMATION.
19	MOP SINK: REFER TO PLUMBING DRAWINGS FOR ADDITIONAL INFORMATION.
20	EXTEND 24-HOUR VESTIBULE PARTITION AND BULKHEAD FRAME AND FINISH TO UNDERSIDE OF ROOF DECK
21	SPANDREL GLASS: OPACI-COAT #3-0770 WARN GREY (FOR USE WITH PPG). SEE SPECIFICATIONS.
22	THROUGH WALL ROOF DRAIN
23	NOT USED FULL-HEIGHT GLASS PARTITION TO CEILING ABOVE -
25	REFER TO INTERIOR ELEVATIONS PARTIAL-HEIGHT GYP BD PARTITON W PARTIAL-HEIGHT
	GLASS ABOVE - REFER TO INTERIOR ELEVATIONS
26	ELECTRICAL PANELS: LOCKING ENCLOSURES FOR ELECTRICAL MAIN SERVICE AND DISTRIBUTION
27	PROVIDE PAINTED F.T. PLYWOOD OVER GWB AT DATA ROOM.
1 22	LUCTURED

WALL LEGEND

ECESS FOR DIGITAL DISPLA

28 NOT USED.

NEW WALL CONSTRUCTION

S E CORE STATES
GROUP COR CERT. AX011726 ARCHITECT OF RECORD

DESCRIPTION 03.03.2020 BID SET 1 04.03.2020 BID ADDENDUM #1

2 04.08.2020 PERM/T SET

PROJECT INFORMATION

PROJECT NO: DATE: PROTOTYPE: DRAWN BY: CHECKED BY: VERSION: 03/03/20 15 T. NUN V. ALVAR SHEET TITLE

> CONSTRUCTION FLOOR PLAN

SHEET NUMBER

A1.1.1

EAST ELEVATION (VALLEY STREET) A2.1 1/4" = 1'-0"

SOUTH ELEVATION (ATWELLS AVENUE) A2.1 1/4" = 1'-0"

GENERAL EXTERIOR NOTES

G.C. TO VERIFY EXTERIOR COLOR & MATERIAL LOCATIONS AS SHOWN ON ELEVATION DRAWNOS WITH CHASE DESIGNER & APPROVED BRANDING PACKAGE PRIOR TO PURCHASE & INSTALLATION

B NOT ALL KEYNOTES MAY BE USED. REFER TO DRAWINGS

EL	.EV	ATIO	N NC	TES	
		NGS / FOL		WS:	

CONCRETE CURB AND ISLANDS: REFER TO ARCHITECTURAL SITE PLAN AND DRIVE-UP CANOPY PLAN

CANOFYPLAN

EMERGENCY ACCESS KEY BOX

WHERE REQUIRED BY LOCAL CODE ONLY.

RECESS-BOUNT IN WALL CONSTRUCTION AS REDO TO

SET FACE FLUSH WITH ADJACENT WALL FRISH- VERIFY

FLUAL LOCATION WITH AUTHORITIES HAVING

JURISDICTION

4 IRRIGATION SYSTEM SENSOR 5 LIGHTING TIMER SYSTEM PHOTO SENSOR REFER TO ELECTRICAL DRAWINGS

6 IRRIGATION SYSTEM CONTROL BOX. 7 SUNSHADE SYSTEM. KAWNEER SUNSHADE. SEE SPECS ON SHEET A5.1.3.

CANOPY SYSTEM.
MAPES SUPER LUMBECK CANOPY SYSTEM. REFER TO
DETAILS ON SHEET A5.1.3.

SECURITY CAMERA: REFER TO ELECTRICAL SHEETS FOR WORE INFORMATION COPING: REFER TO ROOF PLAN-FINISH TO MATCH EPT-1

GUTTERS & DOWNSPOUTS: REFER TO ROOF PLAN-FINISH TO MATCH EPT-1

SCUPPER: REFER TO ROOF PLAN

13 DOWNSPOUT NOZZLE: REFER TO PLUMBING DRAWINGS AND PLUMBING FIXTURE SCHEDULE ROOF VENT: REFER TO ROOF PLAN.

15 AUTOMATIC DOOR OPERATOR BUTTON AND KEYCARD READER RECESSED FLUSH WITH WALL SURFACE- DO NOT SURFACE-MOUNT. 16 AUTOMATIC DOOR OPERATOR BUTTON RECESSED FLUS WITH WALL SURFACE- DO NOT SURFACE-MOUNT.

17 AWNING:
OPTIONAL DESIGN ELEMENT - VERIFY WITH OWNER - BY
SIGNAGE VENDOR NOT IN CONTRACT, COORD
STRUCTURAL SUPPORT/BLOCKING IN WALL AS REQD.

18 SPANDREL GLASS.

19 BOULARD.
CONCRETE-FILLED STEEL PIPE EMBEDDED IN CONCRETE
CURB. WITH PLASTIC COVER. REFER TO SITE PLAN,
DRIVE-LIP CANOPY PLAN AND DETAILS - OMIT AT
POSITIONS NOT ADJACENT TO VEHICULAR LANE
(LIMDSCAPE, WALK ETC.)

20 BANK EQUIPMENT: BANK EQUIPMENT: FURNISHED AND INSTALLED BY BANK EQUIPMENT VENDOR-COORD, WALL OPENINGS AND ELECTRICAL/ DATA REQUIREMENTS WITH OWNER-FURNISHED EQUIPMENT SHOP DRAWINGS AND PRODUCT DATA

SIGNAGE: BY OWNER'S SIGN VENDOR- N.I.C.- PROVIDE ROUGH ELEC. WORK AND BLOCKING IN WALL AS REQD. FOR VENDOR INSTALLATION

22 BULDING ADDRESS NUMBER: WHITE VAYA, NUMBERS WITH 12" WIDE STROKE APPUED TO INTERIOR FACE OF GLASS TRANSOM- MIN. 6" HEIGHT OR AS REDD. BY LOCAL CODE

23 LIGHT FIXTURE: REFER TO LIGHT FIXTURE SCHEDULE

24 HOSE B.B HOSE BIB SET FLUSH WITH FACE OF MASONRY VENEER-REFER TO PLUMBING FIXTURE SCHEDULE

25 ELECTRICAL OUTLET: SET FLUSH WITH FACE OF MASONRY VENEER- PROVIDE METAL COVER COMPLIANT WITH N.E.C.

26 UTLITY COMPLEXITY WITH THE C.

20 UTLITY COMPLEXITY
AND METERS AS REQUIRED - COORD. WITH OWNER'S
SECURITY AND THE EDATA SERVICES - COORD. CABINET
AND METER LOCATIONS WITH LOCAL JURISDICTIONREFER TO SITE PLAN

REFER TO SITE FLAVOR

FRE-FINSHED ALMANUM FLASHING TO SPAN GAP
BETWEEN PREFAS CANOPY. AND BUILDING REFER TO
WALL SECTIONS AND DETALS-COLOR TO MATCH EPTVEREY FRAIL FLASHING LENGTH AND CONFIGURATION
WITH APPROVED CANOPY SHOP DWGS

28 NOT USED.

29 FIRE ALARM SYSTEM BELL AND STROBE: WHERE REQUIRED BY LOCAL CODE ONLY- VERIFY FINAL LOCATION WITH LOCAL AUTHORITIES HAVING JURISDICTION

30 SIAMESE CONNECTION
FIRE SUPPRESSION SYSTEM EXTERIOR CONNECTION
WHERE REDO BY LOCAL CODE ONLY - VERBY FRIMAL
LOCATION WITH LOCAL AUTHORITIES HAVING
JURISDICTION

THE PROPERTY OF THE PROPERTY OF THE PROPERTY OF THE PROP

31 TELE / DATA / UTILITY CONNECTIONS: COORDINATE FINAL LOCATION WITH CIVIL ENGINEER

COR CERT. AX011726 ARCHITECT OF RECORD THESE DRAWINGS ARE NOT COMPLETE WITHO SEPARATE TIPE WRITTEN SPECIFICATIONS MA WHICH ARE PART OF THE CONTRACT DOCUM ISSUE DATE DESCRIPTION

03.03.2020 BID SET 1 04.03.2020 BID ADDENDUM #1 2 04.08.2020 PERMIT SET

AN CHASE,

RG,

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CORE STATES

OLNEYVILLE
280-284 VALLEY ST
PROVIDENCE, RI 02598
CHAKE CVP# 33100P31779,

PROJECT INFORMATION

PROTOTYPE: I. NU V. ALV DRAWN BY:


CHECKED BY: VERSION: SHEET TITLE

> **EXTERIOR ELEVATIONS**


SHEET NUMBER

A2.1.0

10 1.0 PARAPET _ ___ RC-2 1.0 PARAPET ---FC-2 10 PAPAPET _____ (FC-2)-10 RC-1 FC-1 8 TO STOREFRONT 7 25 10 SLAB - -

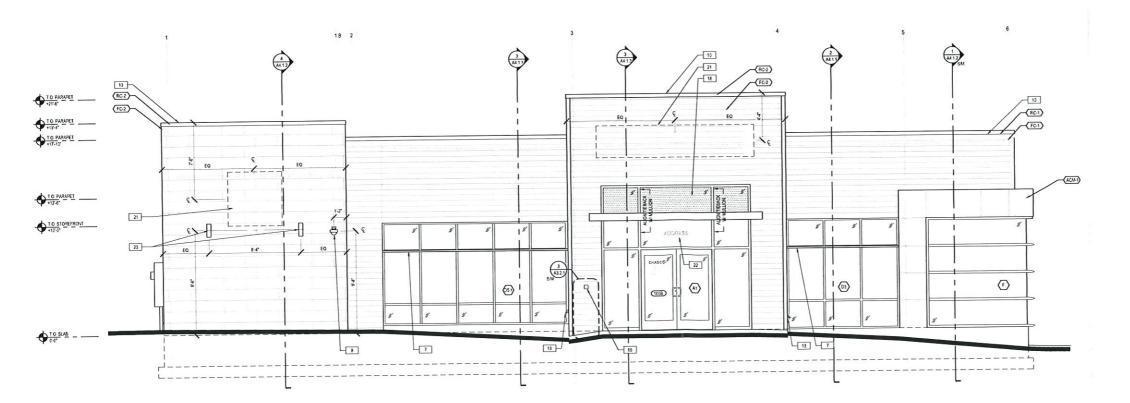

WEST ELEVATION (PARKING ACCESS) A2.2

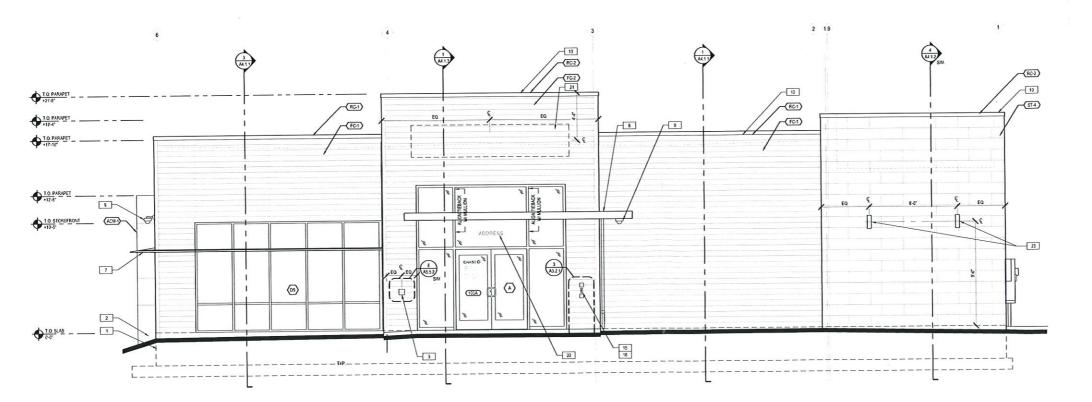

NORTH ELEVATION (PARKING ACCESS) A2.2 1/4" = 1'-0"

GENERAL EXTERIOR NOTES

- A GC. TO VERFY EXTERIOR COLOR & MATERIAL LOCATION AS SHOWN ON ELEVATION DRAWINGS WITH CHASE DESIGNER & APPROVED BRANDING PACKAGE PRIOR TO PURCHASE & INSTALLATION
- B NOT ALL KEYNOTES MAY BE USED. REFER TO DRAWING

Εl	.E\	/A	TI	10	1	0	T	E	

- CONCRETE FOOTINGS / FOUNDATIONS: REFER TO STRUCTURAL DWGS.
- CONCRETE CURB AND ISLANDS: REFER TO ARCHITECTURAL SITE PLAN AND DRIVE-UP CANOPY PLAN

- EMERGENCY ACCESS KEY BOX
 WHERE REQUIRED BY LOCAL CODE ONLY.
 RECESS-MOUNT IN WALL CONSTRUCTION AS REQD. TO
 SET FACE FLUSH WITH ADJACENT WALL FINISH-VERFY
 FINAL LOCATION WITH AUTHORITIES HAVING
 JURISDICTION
- 4 IRRIGATION SYSTEM SENSOR
- 5 LIGHTING TIMER SYSTEM PHOTO SENSOR REFER TO ELECTRICAL DRAWINGS

6 IRRIGATION SYSTEM CONTROL BOX

- SUNSHADE SYSTEM.
 KAWNEER SUNSHADE. SEE SPECS ON SHEET A5.1.3.
- CANOPY SYSTEM:
 MAPES SUPER LUMIDECK CANOPY SYSTEM. REFER TO
 DETAILS ON SHEET AS 1.3.
- SECURITY CAMERA: REFER TO ELECTRICAL SHEETS FOR MORE INFORMATION
- COPING: REFER TO ROOF PLAN-FINISH TO WATCH EPT-1
- GUTTERS & DOWNSPOUTS: REFER TO ROOF PLAN-FINISH TO MATCH EPT-1
- 12 SCUPPER: REFER TO ROOF PLAN
- 13 DOWNSPOUT NOZZLE: REFER TO PLUMBING DRAWINGS AND PLUMBING FOXTURE SCHEDULE
- 14 ROOF VENT: REFER TO ROOF PLAN.
- 15 AUTOMATIC DOOR OPERATOR BUTTON AND KEYCARD READER RECESSED FLUSH WITH WALL SURFACE- DO NO
- SURFACE-MOUNT
- 16 AUTOMATIC DOOR OPERATOR BUTTON RECESSED FLUS. WITH WALL SURFACE- DO NOT SURFACE-MOUNT.
- 17 AWNING:
 OPTIONAL DESIGN ELEMENT VERIFY WITH OWNER BY
 SIGNAGE VENDOR NOT IN CONTRACT. COORD
 STRUCTURAL SUPPORTIBLOCKING IN WALL AS REQD.
- 18 SPANDREL GLASS.
- 19 BOLLARD.
 CONCRETE-FILLED STEEL PIPE EMBEDDED IN CONCRETE
 CURB- WITH PLASTIC COVER- REFER TO SITE PLAN,
 DRYK-LIP CANCRY PLAN AND DETAILS OMIT AT
 POSITION'S NOT ADJACENT TO VEHICULAR LANE
- (LANDSCAPE, WALK, ETC.) 20 BANK EOUPMENT:
 FURNISHED AND INSTALLED BY BANK EQUIPMENT
 VENDOR-COORD. WALL OPENINGS AND ELECTRICAL/
 DATA REQUIREMENTS WITH OWNER-FURNISHED
 EQUIPMENT SHOP DRAWINGS AND PRODUCT DATA
- SIGNAGE: BY OWNERS SIGN VENDOR- N.L.C. PROVIDE ROUGH ELEC. WORK AND BLOCKING IN WALL AS REQD. FOR VENDOR INSTALLATION
- 28 BULDING ADDRESS NUVBER
 WHITE VAYN, NUVBERS WITH 12" WIDE STROKE APPUED
 TO INTERIOR FACE OF GLASS TRANSOM- MIN. 6" HEIGHT
 OR AS REOD. BY LOCAL CODE
- 23 LIGHT FIXTURE: REFER TO LIGHT FIXTURE SCHEDULE
- 24 HOSE BB SET FLUSH WITH FACE OF MASONRY VENEER- REFER TO PLUMBING FATURE SCHEDULE
- 25 ELECTRICAL OUTLET: SET FLUSH WITH FACE OF MASONRY VEI METAL COVER COMPLIANT WITH N.E.C. WITH FACE OF MASONRY VENEER- PROVIDE

- 26 UTLITY COMPANY THIN E.C.
 26 UTLITY COMPANY THIN E.C.
 27 PROVIDE AND INSTALL UTLITY TERMINATION CABINETS
 AND METERS AS REQUIRED COORD. WITH OWNERS
 SECURITY AND TELE DATA SERVICES COORD. CABINET
 AND METER LOCATIONS WITH LOCAL JURISDICTIONREFER TO SITE PLAN

- REPER TO SHEPLAN

 FLASHING AT PREFAB CANOPY.

 PRE-FINSHED ALUMINIM FLASHING TO SPAH GAP

 RETWEEN PEFAB CANOPY, AND BULDING-REFER TO

 WALL SECTIONS AND DETAILS-COLOR TO MATCH EPT
 VERIFY FRAIL FLASHING LENGTH AND CONFIGURATION

 WITH APPROVED CANOPY SHOP DWGS

- 28 NOT USED. 29 FIRE ALARM SYSTEM BELL AND STROBE: WHERE REQUIRED BY LOCAL CODE ONLY-VERIFY FINAL LOCATION WITH LOCAL AUTHORITIES HAVINS JURISDICTION

- 3 SAMESE CONNECTION
 PRE SUPPRESSION SYSTEM EXTERIOR CONNECTION
 WHERE RECO. BY LOCAL CODE ONLY VERIFY FINAL
 LOCATION WITH LOCAL AUTHORITIES HAVING
 JUNSDICTION
 THE STATE OF T
- 31 TELE / DATA / UTILITY CONNECTIONS: COORDINATE FINAL LOCATION WITH CIVIL ENGINEER

PROTOTYPE DRAWN BY

A2.2.0

CHASE, OLNEYVILLE
280-284 VALLEY ST
PROVIDENCE, RI 02908
CHARE CYDE#331009317394 RG, OW W J

ARCHITECT OF RECORD

CORE STATES

2015 Atopie Avenue 5.04: 330 Ambler, PA 19:02 215:509:2125 aven Corestales Com

COR CERT. AX011726

THESE DRAWINGS ARE NOT COMPLETE WITHOUT SEPARATE TYPE WRITTEN SPECIFICATIONS MANU WHICH ARE PART OF THE CONTRACT DOCUMEN

03.03.2020 BID SET 1 04.03.2020 BID ADDENDUM #1

2 04.08.2020 PERMIT SET


PROJECT INFORMATION

F,MO CHECKED BY

VERSION: HEET TITLE

> **EXTERIOR ELEVATIONS**

SHEET NUMBER

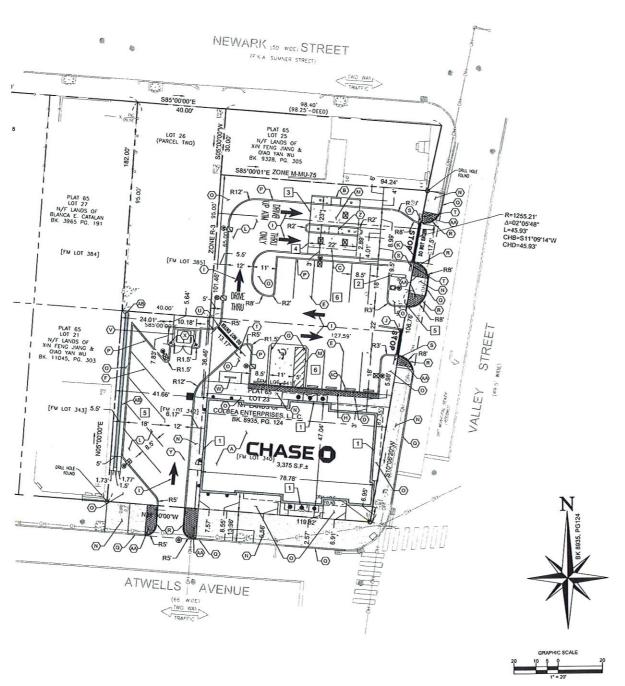

ITEM	REQUIRED	EXISTING	PROPOSED	COMMENT	
MIN LOT AREA	OFEET	20,459 SF	20,459 SF	COMPLIANT*	
MIN. LOT FRONTAGE	N/A	N/A	272.51 FT	COMPLIANT	
MIN. BUILDING FRONT SETBACK	0-5 FEET	N/A	2.57 FT	COMPLIANT	
MIN. INTERIOR SIDE SETBACK	0 FEET (10 FEET ABUTTING RESIDENTAL DISTRICT)	N/A	41.66 FT	COMPLIANT	
MIN. CORNER SIDE SETBACK	0-5 FEET	N/A	0.0 FT	NONCOMPLIANT	
MINL BUILDING REAR SETBACK	20 FEET	N/A	36.45 FT / 101.45 FT	COMPLIANT	
MAX. BUILDING HEIGHT	50 FEET	N/A	26.33 FT	COMPLIANT	
MAX. BUILDING LOT COVERAGE	N/A	15.12%	16.5%	COMPLIANT	
MAXIMUM LOT COVERAGE	70%	94.16%	61.9%	COMPLIANT	

LOT AREA IS CALCULATED BY THE COMBINATION OF LOTS 23, 24 & 26

10

	SIGNAGE TA	ABLE	
ITEM	PERMITTED	PROPOSED	COMMENT
	FREESTANDING S	SIGNS	
MAXIMUM SIGN HEIGHT	15 FEET	4.21 FEET	COMPLIANT
MAXIMUM ALLOWED PER FRONTAGE	1 SIGN PER STREET LOT LINE	1 SIGN	COMPLIANT
MAXIMUM AREA ALLOWED	20SF	12 SF	COMPLIANT
	WALL SIGN	S	
		ALLEY STREET =	COMPLIANT
MAXIMUM ALLOWED PER FRONTAGE	1 SIGN PER BUILDING	NORTH BUILDING SIDE NO STREET = 1 SIGN	COMPLIANT
	WALL	WEST BUILDING SIDE NO STREET = 1 SIGN	COMPLIANT
		ATWELLS AVE = 1 SIGN	COMPLIANT
		VALLEY STREET 42.72 FT X 2 SF/FT= 85.44 SF (36.9 SF)	COMPLIANT
MAXIMUM AREA ALLOWED	2 SF PER LINER FOOT	NORTH BUILDING SIDE 77.65 SF X 2 SF/FT = 155.3 SF (36.9 SF)	COMPLIANT
	OF BUILDING	WEST BUILDING SIDE 43 FT X 2 SF/FT = 86 SF (36.9 SF)	COMPLIANT
		ATWELLS AVE = 78.78 FT X 2 SF/FT = 157.56 SF (36.9 SF)	COMPLIANT
	DIRECTIONAL	SIGNS	
	4 SF PER SIGN	DRIVE UP LANE DESIGNATOR = 3.1 SF	COMPLIANT
MAXIMUM AREA ALLOWED	4 SF PER SIGN	CLEARANCE SIGN = 2.1 SF	COMPLIANT
	4 SF PER SIGN	DIRECTIONAL SIGN = 2.3 SF	COMPLIANT
	4FT	DRIVE UP LANE DESIGNATOR = 1.21 FT	COMPLIANT
MAXIMUM HEIGHT ALLOWED	4FT	CLEARANCE SIGN = 0.83 FT	COMPLIANT
	4FT	DIRECTIONAL SIGN	COMPLIANT

PARKING CALCULATIONS:

EXISTING:

PLAT 65, LOT 23 = 13 SPACES PLAT 65, LOTS 24 & 26 = 7 SPACES

PROPOSED:

PLAT 65, LOTS 23, 24 & 26 = 17 SPACES

MINIMUM ALLOWED: FOR BANK USE = 1 SPACE FOR 500 GFA + 3 STACKING SPACES FOR DRIVE-THRU

13

COR

CLIENT

COMMENT ISSUE FOR BID

SITE PLAN APPROVAL FOR

> SITE LOCATION 280 & 284

> > MASE PICKERI

No 112554

REGISTERED FESSIONAL ENGIN

3 500 SF / 500 SF + 3 STACKING = 10 SPACES TOTAL MINIMUM = 10 SPACES MINIMUM

SIGNAGE KEY NOTES: 1

- PROPOSED WHITE W/ BLUE OCTAGON ILLUM CHANNEL LETTERS CHASE LOGO SIGN. (36.9 SF)
 PROPOSED DOUBLE-FACED ILLUMINATED MONUMENT SIGN.
- (12 SF)
 3. PROPOSED ILLUM DRIVE UP LANE DESIGNATOR "ATM" SIGN.
- PROPOSED ILLUMINATED CLEARANCE SIGN. (2.1 SF)
 PROPOSED NON-ILLUMINATED CLEARANCE SIGN. (2.1 SF)
 PROPOSED DOUBLE FACED NON-ILLUMINATED DIRECTIONAL
- SIGN. (2.3 SF)

KEYED NOTES: (A)

- A PROPOSED CHASE BANK
 B. PROPOSED DRIVE-UP ATM.
 C. PROPOSED DRIVE-UP ATM.
 C. PROPOSED DRIVE-UP ATM.
 C. PROPOSED DRIVE-UP ATM.
 C. PROPOSED 22" x 23" CANIOPY
 D. PROPOSED 8.5" X 18" PARKING SPACE.
 F. PROPOSED 8.5" X 18" PARKING SPACE.
 F. PROPOSED 8.5" X 18" ACCESSIBLE PARKING SPACE. (STALL DIMENSION = 8.5" x 18")
 G. PROPOSED 8" X 18" ACCESSIBLE PARKING SPACE AND AISLE.
 H. PROPOSED ACCESSIBLE PARKING SIGNAGE.
 J. PROPOSED STOP BAR.
 K. PROPOSED STOP BAR.
 L. PROPOSED CONCRETE PAD.
 N. PROPOSED CONCRETE PAD.
 N. PROPOSED CONCRETE PAD.
 N. PROPOSED CONCRETE PAD.
 PROPOSED CONCRETE SIDEWALK.
 O. PROPOSED GRANITE CURB.
 PROPOSED GRANITE CURB.
 PROPOSED GRANITE CURB.
 PROPOSED DENTERSED CURB.
 PROPOSED DENTERSED CURB.
 PROPOSED DENTERSED CURB.
 PROPOSED DO NOT ENTER' SIGN.
 U. PROPOSED DO NOT ENTER' BAR.
 V. PROPOSED BICYCLE RACK.
 X. PROPOSED BICYCLE RACK.
 X. PROPOSED BICYCLE RACK.
 X. PROPOSED BILCYCLE RACK.
 X. PROPOSED BILLET. REFER TO CONSTRUCTION DETAIL SHEETS.
 Y. PROPOSED BULLET. REFER TO RIDOT CONSTRUCTION DETAIL SHEETS.
 Y. PROPOSED BULLET. REFER TO RIDOT CONSTRUCTION DETAIL SHEETS.

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PROPOSED SITE LIGHTING FIXTURES

S EXISTING SANITARY STRUCTURES EXISTING WATER STRUCTURE

☐ EXISTING ELECTRIC STRUCTURE PROPOSED PARKING COUNT

SHEET.

2. PROPOSED FUTURE ATM. CONTRACTOR TO INSTALL ISLAND AND SEE ELECTRICAL DRAWINGS FOR FUTURE STUB UP LOCATIONS.

AA. PROPOSED ADA CURB RAMP.

AB. PROPOSED RETAINING WALL. REFER TO CONSTRUCTION DETAILS.

AC. PROPOSED WHEEL STOP. CHASE BANK LEGEND EXISTING PROPERTY BOUNDARY LINE
 EXISTING ADJOINING PROPERTY LINE
 EXISTING UTILITY EASEMENT VALLEY STREET 14 NEWARK STREET EXISTING CURB AND GUTTER PROVIDENCE, RI EXISTING EDGE OF PAVEMENT = PROPOSED CURB ENGINEER SEAL PROPOSED DEPRESSED CURB PROPOSED BUILDING PROPOSED SIDEWALK PROPOSED CONCRETE PROPOSED RIPRAP PROPOSED ASPHALT PROPOSED WATER STRUCTURES PROPOSED STORM STRUCTURES PROPOSED SANITARY STRUCTURES

RI LICENSE #12554 SHEET TITLE SITE PLAN

AS SHOW!

ALERT TO CONTRACTOR:

PRIOR TO THE CONSTRUCTION OF OR CONNECTION TO ANY STORM DRAIN, SANITARY SEWER, WATER MAIN OR ANY OF THE DRY UTILITIES, THE CONTRACTOR SHALL EXCAVATE, VERIFY AND CALCULATE ALL POINTS OF CONNECTION AND ALL UTILITY CROSSINGS AND INFORM ENGINEER AND THE OWNER OF ANY CONFLICT OR REQUIRED DEVALTIONS FROM THE PLAN, NOTIFICATION SHALL BE MADE A MINIMUM OF 48 HOURS PRIOR TO CONSTRUCTION. ENGINEER AND OWNER SHALL BE HELD HARMLESS IN THE EVENT THAT THE CONTRACTOR FAILS TO MAKE SUCH NOTIFICATION.

1	- 1		2	3		4		5
PLANT SCHEDULE								
TREES	CODE	QTY	BOTANICAL / COMMON NA	AME	CALIPER	CONTAINER	SIZE	
	AR	4	Acer rubrum / Red Maple 1,000 S.F. TREE CANOPY	EACH	CONTAINER OR E	3&B 2*Cal	8'-10' HT.	
3	PY	2	Prunus x yedoensis / Yoshir 300 S.F. TREE CANOPY E.	no Cherry ACH	CONTAINER OR E	B&B 2°Cal	8'-10' HT.	
Θ	os	4	Querous shumardii / Shuma 1,000 S.F. TREE CANOPY		CONTAINER OR E	B&B 2°Cal	8°-10° HT.	
	TE	4	Thuja occidentalis 'Ernerald	' / Emerald Arborvitae	15 gal		6" HT.	
8	TG	7	Thuja standishii x plicata 'G	ireen Giant' / Green Giant Arborvitae	CONTAINER OR E	B&B	10'-12' HT.	
SHRUBS	CODE	QTY	BOTANICAL / COMMON N	AME	CONT. SIZE	PLANT SIZE		SPACING
0	AI	32	Azalea Encore 'Autumn Ivo	ry' TM / Encore Azalea	3 gal	15"HT. x 15"W.		30° o.c.
*	CF	27	Cyrtomium falcatum / Holly	Fem	3 gal	FULL POT		24° o.c.
£ ;	HL	2	Hosta x 'Twist of Lime' / Pk OR OTHER WHITE-GREEN VARIETY	antain Lily N VARIEGATED AVA/LABLE	3 gal	FULL POT		36° o.c.
5	JA	45	Juniperus horizontalis 'And	lorra` / Andorra Juniper	3 gal	FULL POT		30° o.c
\odot	u	23	Ligustrum japonicum / Japa	anese Privet	15 gal	4° HT.		48° a.c.
泰	MS	21	Miscanthus sinensis 'Adagi	io' / Dwarf Maiden Grass	3 gal	18" HT. x 18" W.		30° o.c.
袋	MG	20	Miscanthus sinensis 'Gradi	Mimus' / Maiden Grass	7 gal	4° HT.		48° a.c.
\odot	RX	68	Rosa x 'Apriot Drift' / Aprio	ot Drift Rose	3 gal	FULL POT		24° o.c.
\odot	R3	14	Rosa x 'Radtko' / Double k	Knock Out Red Rose	3 gal	18" HT. x 18" W.		36° a.c.
GROUND COVERS	CODE	QTY	BOTANICAL / COMMON N	IAME.	SIZE	CONTAINER		SPACING
	ES	92	Eragrostis spectabilis / Pur	ple Love Grass	1 gal	FULL POT		15° o.c.
	ZJ	5,245 sf	Zoysia japonica / Zoysia G	rass	flat			

ROOT BARRIERS

THE CONTRACTOR SHALL INSTALL ROOT BARRIERS NEAR ALL NEWLY-PLANTED TREES THAT ARE LOCATED WITHIN FIVE (5) FEET OF PAVING OR CURBS. ROOT BARRIERS SHALL BE "CENTURY" OR "DEEP-ROOT" 21" DEEP PANELS (OR EQUAL). BARRIERS SHALL BE LOCATED IMMEDIATELY ADJACENT TO HARDSCAPE. INSTALL PANELS PER MANIFACTURER'S RECOMMENDATIONS. UNDER NO CIRCUMSTANCES SHALL THE CONTRACTOR USE ROOT BARRIERS OF A TYPE THAT COMPLETELY ENCIRCLE THE ROOTBALL.

MULCHES

AFTER ALL PLANTING IS COMPLETE, CONTRACTOR SHALL INSTALL 3' THICK LAYER OF 1-1/2' SHREDDED WOOD MULCH IN ALL PLANTING AREAS (EXCEPT FOR TURE AREAS). CONTRACTOR SHALL SUBMIT SAMPLES OF ALL MULCHES TO LANDSCAPE ARCHITECT AND OWNER FOR APPROVAL PRIOR TO CONSTRUCTION. ABSOLUTELY NO EXPOSED GROUND SHALL BE LEFT SHOWING ANYWHERE ON THE PROJECT AFTER MULCH HAS BEEN

PLANTING AND IRRIGATION GUARANTEE

THE LANDSCAPE CONTRACTOR SHALL GUARANTEE THAT ALL NEWLY INSTALLED AND EXISTING PLANTS SHALL SURVIVE FOR ONE YEAR AFTER FINAL OWNER ACCEPTANCE OF THE BISTALLATION WORK. THE CONTRACTOR SHALL ALSO BE RESPONSIBLE FOR APPROPRIATE WATERING OF THE LANDSCAPE THROUGH INSTALLATION OF A PROPERLY DESIGNED IRRIGATION SYSTEM. THE OWNER SHALL APPROVE THE SYSTEM DESIGN BEFORE INSTALLATION OF PLANTS OR IRRIGATION.

GENERAL PLANTING NOTES

- THE GENERAL CONTRACTOR IS RESPONSIBLE FOR REMOVING ALL EXISTING VEGETATION (EXCEPT WHERE NOTED TO REMAIN). BEFORE STARTING WORK, THE LANDSCAPE CONTRACTOR SHALL VERBY THAT THE GRADE OF ALL LANDSCAPE AREAS ARE WITHIN 14-0.
- AREAS ARE WITHIN 1-6.1' OF FINISH GRADE. THE LANDSCAPE CONTRACTOR SHALL NOTIFY THE OWNER NUMEDIATELY SHOULD ANY DISCREPANCIES EXIST. SEE SPECIFICATIONS FOR MORE DETAILED INSTRUCTION ON TURF AREA AND PLANTING BED PREPARATION.

 CONSTRUCT AND MANTAN PRINSH GRADES IN LANDSCAPE AREAS AS SHOWN ON GRADING PLANS, AND CONSTRUCT AND MAINTANN SLOPES AS RECOMMENDED BY THE GEOTECHNICAL REPORT. ALL LANDSCAPE AREAS SHALL HAVE POSITIVE DRAINAGE AWAY FROM STRUCTURES AT THE MINIMUM SLOPE SPECIFIED IN THE REPORT, AND AREAS OF POTENTIAL PONDING SHALL BE REGRADED TO BLEND IN WITH THE SURROUNDING GRADES AND ELIMINATE PONDING POTENTIAL PONDING SHALL BE REGRADED TO BLEND IN WITH THE SURROUNDING GRADES AND ELIMINATE PONDING POTENTIAL. PONDING SHALL BE REGRADED TO BLEND IN WITH THE SURROUNDING GRADES AND ELIMINATE PONDING POTENTIAL. PONDING SHALL BE REGRADED AND SHALL BE THE ARBITICAL SHALL BE THE ARBITICAL SHALL BE TO THE ATTENTION OF THE LANDSCAPE ARCHITECT, GENERAL CONTRACTOR SHALL INMEDIATELY BRING SUCH TIEMS TO THE ATTENTION OF THE LANDSCAPE ARCHITECT, GENERAL CONTRACTOR SHALL BE Z'BELOW FINISH GRADE AFTER INSTALLING SOIL AMENDMENTS, AND 1'BELOW FINISH GRADE IN SURROUR SHALL BE Z'BELOW FINISH GRADE AFTER INSTALLING SOIL AMENDMENTS, AND 1'BELOW FINISH GRADE IN SURROUR SHALL BE Z'BELOW FINISH GRADE AFTER INSTALLING SOIL AMENDMENTS, AND 1'BELOW FINISH GRADE IN SON REAS AFTER INSTALLING SOIL AMENDMENTS, MULCH COVER WITHIN 12'O' FULLUS SHALL BE AT LEAST'S 'LOWER THAN THE TOP OF WALL.

 INSTALL MULCH COUNCE, WOVEN, NEEDLE-PUNCHED POLYPROPYLENE FABRIC (DOWNTT 'PRO-5' OR EQUAL/UNDER ALL MULCHED AREAS AND INDIVIDUAL THERE RINGS.

 INSTALL MULCH TOPORESSING, TYPE AND DEPTH PER MULCH NOTE, IN ALL PLANTING BEDS AND TREE RINGS. DO NOT INSTALL MULCH WITHIN 6' O' F TREE ROOT FLARE.

 INSTALL MULCH WITHING AND BE AREAS OUTSIDE OF PROPERTY LIMITS (UNLESS SHOWN AS SOO).

 ALL PLANT LOCATIONS ARE DIAGRAMMATIC. ACTUAL LOCATIONS SHALL BE VERTIFED WITH THE LANDSCAPE ARCHITECT OR DESIGNER PRIOR TO PLANTING. THE LANDSCAPE CONTRACTOR SHALL BENGE THAT ALL REQUI

- ETC.).
 THE LANDSCAPE CONTRACTOR IS RESPONSIBLE FOR DETERMINING PLANT QUANTITIES, PLANT QUANTITIES SHOWN ON LEGENDS AND CALLOUTS ARE FOR GENERAL INFORMATION ONLY. IN THE EVENT OF A DISCREPANCY BETWEEN THE PLAN AND THE PLANT LEGEND, THE PLANT QUANTITY AS SHOWN ON THE PLAN (FOR INDIVIDUAL SYMBOLS) OR CALLOUT (FOR GROUNDCOVER PATTERNS; SHALL TAKE PRECEDENCE.


 NO SUBSTITUTIONS OF PLANT ATERIALS SHALL BE ALLOWED WITHOUT THE WRITTEN PERMISSION OF THE LANDSCAPE ARCHITECT. IF SOME OF THE PLANT SHE NOT AVAILABLE, THE LANDSCAPE CONTRACTOR SHALL NOTIFY THE LANDSCAPE ARCHITECT IN WRITING (VIA PROPER CHANNELS).


 PLANTS MAY BE INSPECTED AND APPROVED OR REJECTED ON THE JOBSITE BY THE OWNER OR OWNERS REPRESENTATIVE.

- PLANTS IMM BE INSPECTED AND APPROVED OR RESPECTED ON THE MAINTENANCE OF ALL WORK SHOWN ON THESE PLANS
 FOR 90 DAYS BEYOND FINAL ACCEPTANCE OF ALL LANDSCAPE WORK BY THE OWNER. LANDSCAPE MAINTENANCE SHALL
 NICLUDE WEEKLY SIG PLANTS THAT CHE FOLD WING A CONTROL OF ALL LANDSCAPE MAINTENANCE SHALL
 NICLUDE WEEKLY SIG PLANTS THAT SHALL SETTLED. MOWING AND AERATION OF LAWNS, WEEDING, RESEEDING AREAS
 WHICH HAVE NIC BETTING OF PLANTS THAT MAVE SETTLED. MOWING AND AERATION OF LAWNS, WEEDING, RESEEDING AREAS
 WHICH HAVE NIC BETTING THE WILL THE PLANTS FOR INSECTS AND DISEASES REPLACEMENT OF MULCH, REMOVAL OF
 WITCHING AND THE INFICATION SYSTEM DUE TO FAULTY PARTS ANXION WORKJUANSHIP, AND THE APPROPRIATE
 WITCHING ALL PLANTINGS. THE LANDSCAPE CONTRACTOR SHALL MAINTAIN THE IRRIGATION SYSTEM IN PROPER
 WITCHING DEDER, WITH SCHEDULING ADJUSTMENTS BY SEASON TO MAXINGE WATER CONSERVATION.
 SHOULD SEEDED AMOOR SOODED AREAS NOT BE COVERED BY AN AUTOMATIC RISINGATION SYSTEM. THE LANDSCAPE
 CONTRACTOR SHALL BE RESPONSIBLE FOR WATERING THESE AREAS AND OBTANING A FULL STAND OF GRASS AT NO
 ADDITIONAL COST TO THE OWNER.
- ADDITIONAL COST TO THE OWNER. TO ACHIEVE FINAL ACCEPTANCE AT THE END OF THE MAINTENANCE PERIOD, ALL OF THE FOLLOWING CONDITIONS MUST
- OCCUR.

 A. THE LANDSCAPE SHALL SHOW ACTIVE, HEALTHY GROWTH (WITH EXCEPTIONS MADE FOR SEASONAL DORMANCY). ALL PLANTS NOT MEETING THIS CONDITION SHALL BE REJECTED AND REPLACED BY HEALTHY PLANT MATERIAL PRIOR TO
- FINAL ACCEPTANCE
 ALL HARDSCAPE SHALL BE CLEANED PRIOR TO FINAL ACCEPTANCE.
 ALL HARDSCAPE SHALL BE CLEANED PRIOR TO FINAL ACCEPTANCE.
 SODED AREAS MUST BE ACTIVELY GROWING AND MUST REACH A MINIMUM HEIGHT OF 1 1/2 INCHES BEFORE FIRST
 MOWING. HYDROMULCHED AREAS SHALL SHOW ACTIVE, HEALTHY GROWTH. BARE AREAS LARGER THAN TIVELYE
 SQUARE INCHES MUST BE RESOURCE OR RESERVED (AS A PPROPRIATE) PRIOR TO FINAL ACCEPTANCE. ALL SODDED
- TURF SHALL BE NEATLY MOWED.

 15. SEE SPECIFICATIONS AND DETAILS FOR FURTHER REQUIREMENTS.

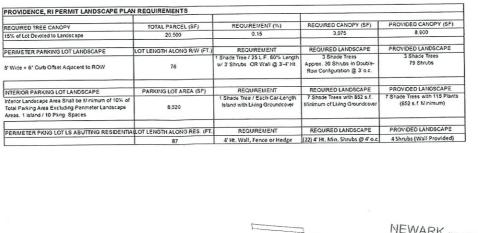

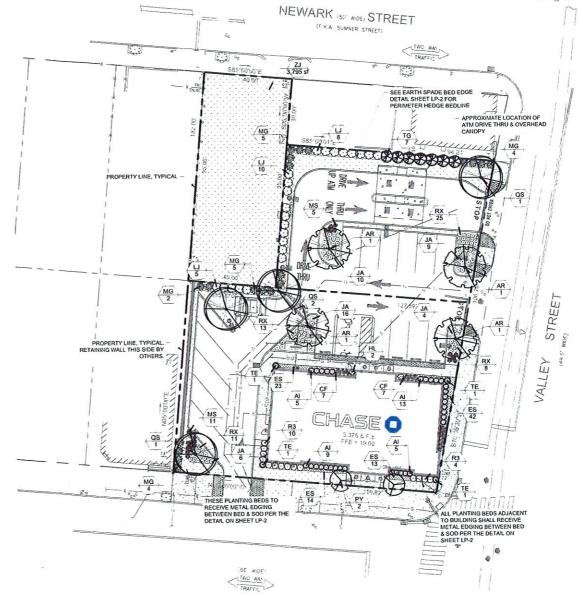

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EV	DATE	COMMENT	BY			
201	4.15.20	Revised CAD Base	GP			
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DOCUMENT SITE PLAN APPROVAL FOR CHASE BANK

SITE LOCATION 280 & 284 VALLEY STREET 14 NEWARK STREET PROVIDENCE, RI


ENGINEER SEAL



RI LICENSE #12554 LANDSCAPE PI ANTING

JPM-25	
04/15/2	
G.P./F	

SCALE: 1" = 20"

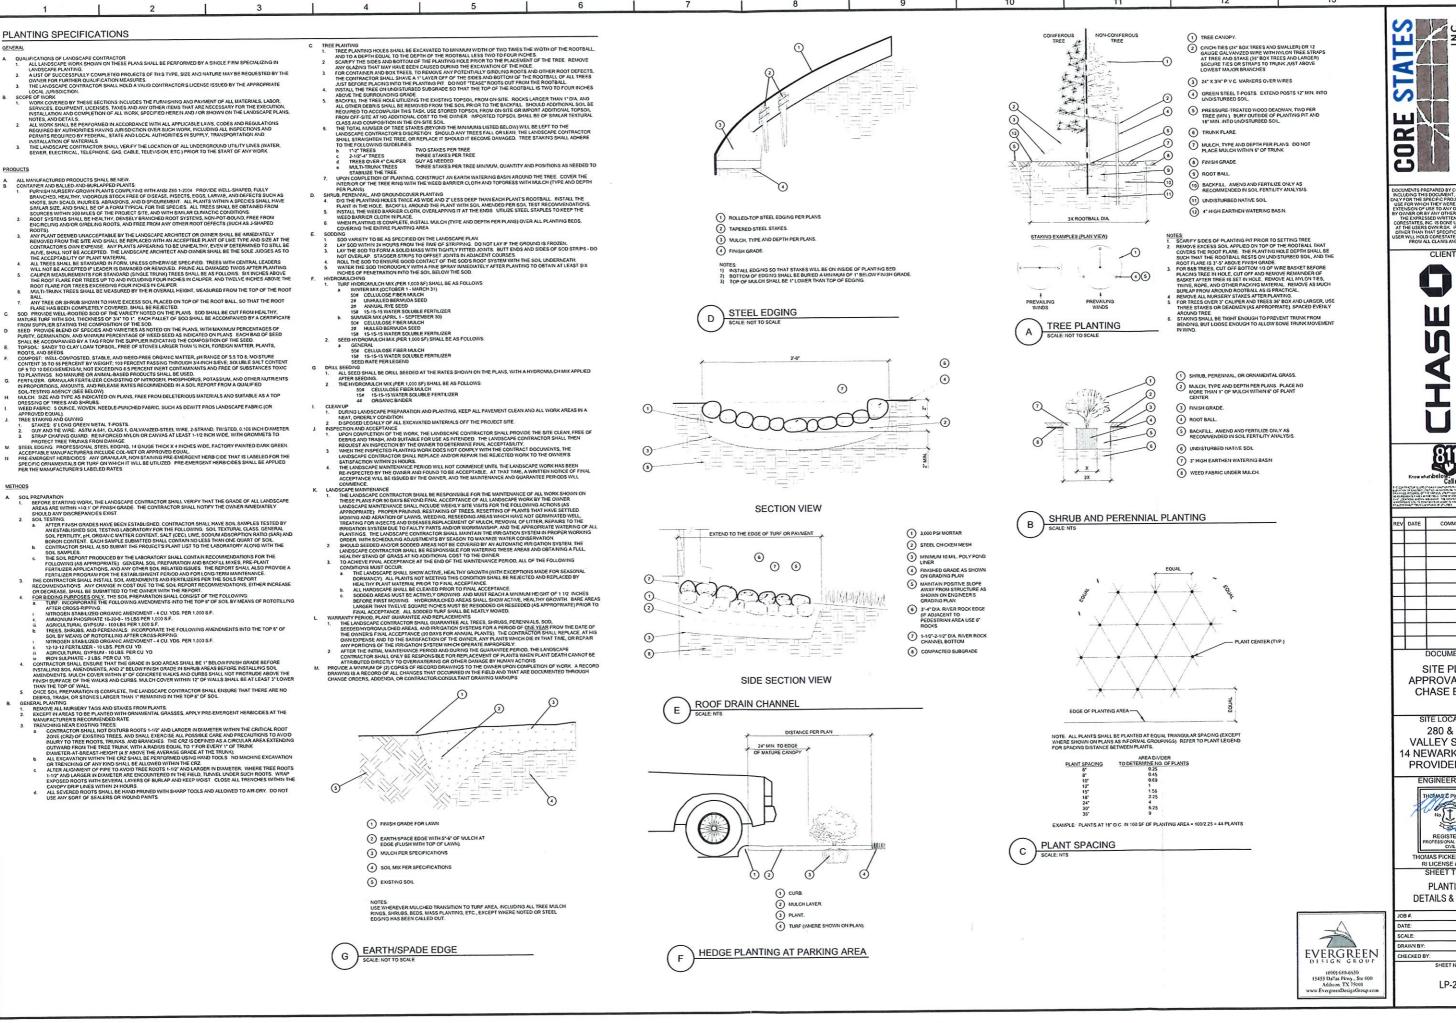

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COMMENT

SITE PLAN APPROVAL FOR CHASE BANK

SITE LOCATION 280 & 284 VALLEY STREET 14 NEWARK STREET PROVIDENCE, RI

ENGINEER SEAL

THOMASE PICKERIN No 12554/ THOMAS PICKERING, P.E.

SHEET TITLE **PLANTING DETAILS & SPECS**

G.P./R.N

LP-2