Providence City Plan Commission



June 25, 2020

AGENDA ITEM 5 - 1292 WESTMINSTER STREET



A view of the building from Westminster Street



View of the lot at 334 Carpenter Street

Site Plan

OVERVIEW

OWNER/APPLICANT: 1290 Westminster LLC, Owner

Michael Lemoi and 1290 Westminster Street LLC,

Applicant

CASE NO./

17-034 MA

PROJECT TYPE:

Preliminary Plan

PROJECT DESCRIPTION:

The applicant is seeking approval for a five story building with 7,200 SF of commercial space on the first floor and a total of 35 dwelling units on floors 2-5. The item is being reconsidered by the CPC after an appeal was granted by the superior court.

PROJECT LOCATION: 1292 Westminster Street

RECOMMENDATION:

Approval of the Preliminary Plan subject to

the findings and conditions noted below.

AP 32 Lots 233


C-2 under HD Overlay

NEIGHBORHOOD:

West End

PROJECT PLANNER:

Choyon Manjrekar

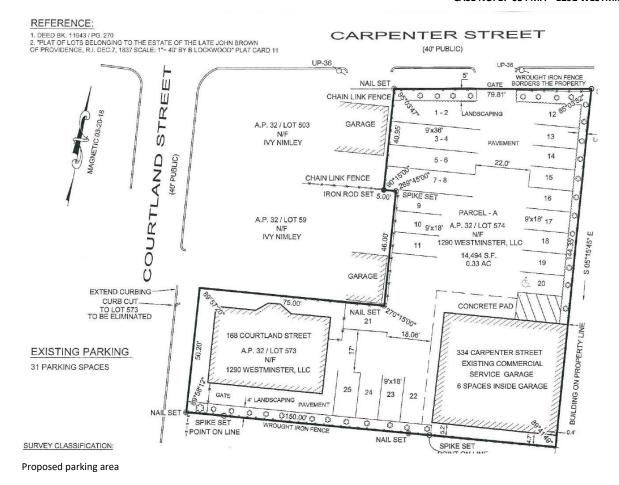

PROJECT OVERVIEW

The subject lot measures approximately 16,825 SF and is zoned C-2 under the Historic District overlay. The project consists of a 58 foot tall, five story mixed use building with 7,200 SF of commercial space on the ground floor and 35 units on floors 2-5. The CPC granted an eight foot, one story dimensional adjustment from the height restriction at the master plan stage. Forty three parking spaces are required but 22 onsite vehicular spaces and 18 bike spaces will be provided. Twenty one additional dedicated spaces will be provided within an accessory parking lot also owned by the applicant, which would fulfill the parking requirement.

ANALYSIS AND IDENTIFICATION OF POTENTIAL ISSUES

Use

The subject property is zoned C-2 which permits mixed use development by right.

Dimensions

A building which was deemed noncontributing by the Historic District Commission (HDC) was demolished prior to construction of the structure. The building is set to the lot

lines at Westminster and Harrison Streets with parking at the rear. A height of five stories and 58 feet will be maintained through a height adjustment granted by the CPC at the master plan stage.

The foundation slightly encroaches onto the public right of way on Westminster Street. Articulations on the building's façade include a canopy that projects three feet and windows that project two feet over the right of way. The applicant has received encroachment permits for these projections.

Building and Site Design

The building's design follows suggestions by the CPC to introduce more fenestration on the western façade and to pull back the upper stories back to accommodate the increased transparency. The HDC and CPC have approved the final design.

The main entrance for commercial and residential uses is located on Westminster Street. Stair access is provided from Harrison Street. The commercial space on the ground floor conforms to the C-2 design regulations by providing a largely transparent façade composed of brick, glass and other materials encouraged in the zone. The upper stories are

composed of brick veneer, glazing and fiber cement panels with transparency that exceeds the 10 percent required for upper stories.

Parking

A total of 43 parking spaces are required for the development. Thirty five parking spaces are required for the residential use, with a requirement of one per dwelling unit. Eight spaces are required for the commercial use after accounting for parking exemptions and reductions as follows:

The commercial area requires one space per 500 SF of development. Fourteen spaces are required for 7,200 SF, but the requirement is reduced by five due to the first 2,500 SF of commercial development being exempt from parking in the C-2 zone. Seven bicycle spaces, calculated as one per five dwelling units are required, but 18 permanent indoor bike spaces are proposed. As the total exceeds 120% of required bicycle spaces, the amount of required parking is further reduced by one space for a total of 43 required spaces.

Twenty two vehicle spaces are provided in a parking area at the rear of the building. The applicant is proposing to provide 21 additional parking spaces dedicated to the development in a lot at 170 Courtland/334 Carpenter Street, about 0.1 miles away or an approximately 2 minute walk from the development. The site is currently used as an auto repair business. The applicant has proposed to abandon the auto body repair use, merge the 334 Carpenter Street property with an adjacent lot the applicant owns at 170 Courtland Street, which includes a 3-family dwelling, and to convert the auto body repair building to an accessory garage. The parking on the lot will now be accessory to a permitted use, and the surplus parking will be used for the subject development. In connection with this application, the applicant has obtained a letter from Joseph Atchue, Director of Inspection and Standards. Section 1404.A.1.a of the Ordinance authorizes the Director to grant approval for off-site parking on a separate lot from a development. In a letter issued by Director Atchue, he makes findings that are consistent with the requirements of Section 1404.A.1.a. It finds the following:

- That the parking spaces are within a reasonable distance from the subject development.
- The three family dwelling is a legally permitted used of the property so, therefore, the offsite parking conforms to the zoning ordinance.
- A total of 31 spaces are located on the site and three are required for the dwelling, resulting in a surplus of 28 spaces. The excess parking spaces on the property are not required for the three-family use or any other use.

The letter finds that the offsite parking spaces "may be used as part of the required parking count for 1292 Westminster Street," in conformance with Sect. 1404.A.1.a of the Zoning Ordinance. Therefore, the applicant meets the parking requirements of the subject application.

Landscaping—1292 Westminster

The development employs a mix of four large and five small trees and maintain a planting strip around the perimeter of the parking lot. Approximately 2,500 SF of canopy coverage is required. Per the plan, the applicant meets the canopy coverage requirement, providing a total of 5,500 SF of coverage in addition to shrubs and groundcover. The western portion of the parking area which abuts a residential lot is screened using a stockade fence as required for parking areas that abut residential zones.

Lighting

The applicant has submitted a lighting plan which employs freestanding LED area lighting with downward facing fixtures around the parking lot. Per the photometric plan, there will be no light spillover off the site, onto neighboring property or on rights of way.

<u>Drainage, Stormwater and Site Management</u>

Drainage and stormwater management: The applicant has submitted a detailed stormwater management plan which employs measures like a stormtech infiltration system that uses crushed stone and a filter fabric. The plan includes a maintenance schedule for the stormwater system as well as site management activities for trash and snow removal and landscape maintenance.

The plans have been approved by the City Engineer.

The applicant has received stormwater connection and sewer connection permits from the Narragansett Bay Commission (NBC) as well as a stormwater construction permit from the Department of Environmental Management (DEM).

CITY PLAN COMMISSION June 25, 2020 PAGE 3

FINDINGS

Section 806 of the Commission's *Development Review Regulations* requires that the City Plan Commission make the following findings as part of their approval of all land development project applications. Based on the analysis contained herein and subject to the conditions contained in this report, staff has prepared the following findings regarding the request for approval of the Preliminary Plan stage:

1. Consistency—The proposed development is consistent with the Comprehensive Plan and/or has satisfactorily addressed the issues where there may be inconsistencies.

The subject property is located in an area that the future land use map of *Providence Tommorow: The Comprehensive Plan* intends for Neighborhood Commercial/Mixed Use. The plan describes these areas as ones intended to foster the expansion of traditional, transit and pedestrian oriented commercial uses that serve neighborhood needs. The development is in conformance with this designation.

Provision of housing conforms to objectives H-1 and H-2 of the comprehensive plan which seek to create new housing opportunities and improve existing housing. According to Map 11.1 of the Comprehensive plan, Westminster Street is designated a growth corridor which is suited to accommodate high density mixed use development to accommodate an improved transit system. The development is in conformance with objective LU-2 which encourages growth within corridors best suited to provide access to jobs and transit.

Compliance with Zoning Ordinance—The proposed development is in compliance with the standards and provisions of the Zoning Ordinance.

Use: Mixed use development is permitted by right in the C-2 zone.

Dimension: The development conforms to the dimensional requirements of the C-2 zone. The applicant received an adjustment from the height limit of the C-2 zone at the master plan stage.

Landscaping: The applicant meets the landscaping requirements for the development. The plans have been approved by the City Forester.

Parking: The applicant meets the parking requirement, providing 43 spaces. Twenty two spaces will be provided at 1292 Westminster Street and 21 will be provided in the lot at 170 Courtland/334 Carpenter Street.

Lighting: The lighting plan meets the requirements of the zoning ordinance.

3. Environmental Impact—There will be no significant environmental impacts from the proposed development as shown on the final plan, with all required conditions for approval.

Stormwater, site management and erosion control plans have been submitted and approved by the City Engineer. All state approvals have been granted.

No negative environmental impacts are expected as the applicant is in conformance with applicable environmental regulations.

4. Buildable Lot—The subdivision or development project, as proposed, will not result in the creation of individual lots with such physical constraints to development that building on those lots according to pertinent regulations and building standards would be impracticable.

There are no physical constraints that impact development of this property as the applicant meets the dimensional requirements for this zone.

Street Access—All proposed development projects and all subdivision lots shall have adequate and permanent physical access
to a public street. Lot frontage on a public street without physical access shall not be considered compliance with this
requirement.

Adequate vehicular and pedestrian access is provided from Westminster and Harrison Streets.

RECOMMENDATION

Preliminary Plan Approval

The CPC should vote to approve the preliminary plan, finding it to be in conformance with the zoning ordinance and comprehensive plan, subject to the following condition:

Final plan approval should be delegated to DPD staff.



LOCUS MAP

- 1. DEED BOOK 3788, PAGE 88
- 2. LOTS 15, 14 AND PORTION OF 13 ON THAT PLAN ENTITLED "PLOT OF LOTS OF LAND BELONGING TO THE DEXTER DONATION SURVEYED AND PLATTED NOV. 1843 BY ATWATER & SCHUBARTH", PLAT CARD 52
- 3. STREETLINE PLAN HARRISON STREET, CITY ENGINEER'S OFFICE.
- MAP OF MILLER STREET (POWHATAN STREET) FROM DEXTER STREET TO DIVISION STREET. PROVIDENCE, R.I. CITY ENGINEER'S OFFICE, DEC. 22, 1883


ZONING DISTRICT: C-2

MINIMUM SETBACKS:

THIS SURVEY HAS BEEN CONDUCTED AND THE PLAN HAS BEEN PREPARED PURSUANT TO SECTION 9 OF THE RULES AND REGULATIONS ADOPTED BY THE RHODE ISLAND STATE BOARD OF REGISTRATION FOR PROFESSIONAL LAND SURVEYORS ON NOVEMBER 25, 2015, AS FOLLOWS:

TYPE OF BOUNDARY SURVEY: MEASUREMENT SPECIFICATION:

BY: RICHARD T. BZDYRA, PES; LICENSE #1786; COA # LS-A60

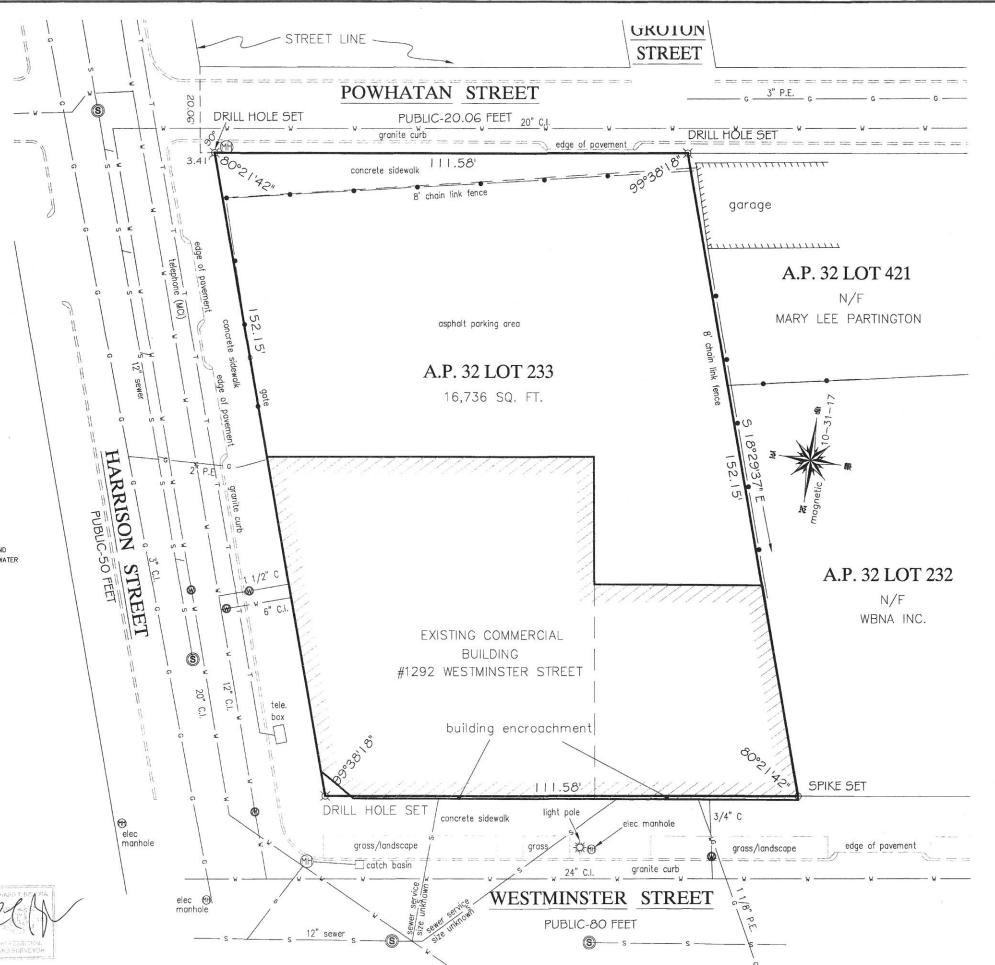


Planners,

OAKLAWN AVENUE CRANSTON, RHODE ISLAND E (401) 463-9696 FAX (401) 463-9039

REVISION: DATE: NOVEMBER 3, 2017 DRAWN BY: DCD SCALE:

OF 1 SHEETS JOB NO. 9106 DWG. NO. 9106-LCBS

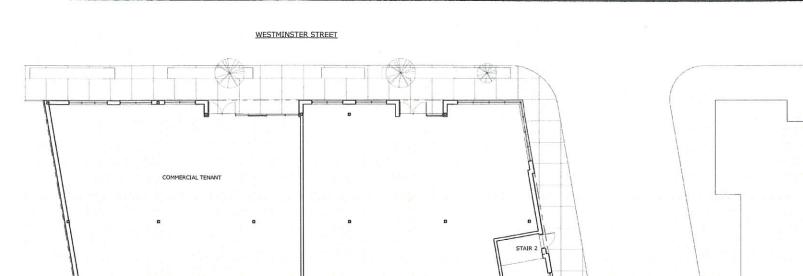

PLAT 32 LOT 233

20 STANDARD PARKING SPACES 1 COMPACT SPACE 1 ACCESSIBLE PARKING SPACE 22 TOTAL PARKING SPACES

POWHATAN STREET

STAIR 1

- 48" SCREEING FENCE

1 SITE PLAN 1" = 10'-0"

1292 WESTMINSTER ST

JANUARY 2018

SITE PLAN

UNIT MATRIX:

	TYPE	AREA	FLOOR 2	FLOOR 3	FLOOR 4	FLOOR 5	TOTAL	%
ONE BED UNIT			8	8	9	7	32	91.4%
	A1	810 SF	1	1	-	-	2	5.7%
	A2	816 SF	5	5		-	10	28.5%
	А3	790 SF	1	1	2	2	2	5.7%
	A4	902 SF	1	1	1.		2	5.7%
	A5	785 SF		191	1		1	2.9%
	A6	791 SF	- 1	-	5		5	14.3%
	A7	716 SF		(40)	1	-	1	2.9%
	A8	826 SF		-	1	-	1	2.9%
	А9	830 SF	-	- 121	. 1	9	1	2.9%
	A10	480 SF				1	1	2.9%
	A11	605 SF	-		-	4	4	11.4%
	A12	665 SF	:			1	1	2.9%
	A13	580 SF		-	-	1	1	2.9%
TWO BED UNIT			1	1	0	1	3	8.6%
	В1	1,047 SF	1	1	-		2	5.7%
	B2	1,076 SF	-	-	-	1	1	2.9%
1 1	-					- 1		- 12

BUILDING SUMMARY:

PARCEL AREA - 16,824 SF FLOOR AREA

FLOOR AREA
BASEMENT 5,209 SF
FIRST FLOOR 8,708 SF
SECOND FLOOR 8,856 SF
THIRD FLOOR 8,856 SF
FOURTH FLOOR 8,250 SF
FIFTH FLOOR 6,365 SF
TOTAL BUILDING SQUARE FOOTAGE - 46,244 SF

7,049 SF TOTAL COMMERCIAL SPACE AT GROUND FLOOR

9 UNITS PER FLOOR @ FLOORS 2-4 8 UNITS @ FLOOR 5 4 RESIDENTIAL FLOORS TOTAL 35 UNITS TOTAL UNITS RANGE FROM 480 SF - 1,072 SF

PARKING SUMMARY:

ON SITE 20 STANDARD PARKING SPACES 1 COMPACT PARKING SPACE 1 ACCESSIBLE PARKING SPACE 22 TOTAL PARKING SPACES

ON ALTERNATE SITE 16 STANDARD PARKING SPACES FOR 1292 WESTMINSTER

20 INDOOR BIKE STORAGE SPACES

C-2 ZONE
HISTORIC OVERLAY DISTRICT (ARMORY)
MIN. LOT AREA: NONE
MIN. BUILDING HEIGHT: 16'
MIN. FIRST STORY HEIGHT: 11'
MAX. BUILDING HEIGHT: 30', NOT TO EXCEED 4 STORIES
MAX. BUILDING HEIGHT: 30', NOT TO EXCEED 4 STORIES
MAX. BUILDING COVERAGE: NONE

FRONT SETBACK: BUILD TO ZONE OF 0'-5'
INTERIOR SIDE SETBACK: NONE, 10' WHEN ABUTTING A RESIDENTIAL DISTRICT
CORNER SIDE SETBACK: BUILD TO ZONE 0'-5'
REAR SETBACK: NONE, 20' WHEN ABUTTING A RESIDENTIAL DISTRICT

PARKING CALCULATIONS:

DWELLING - MULTI-FAMILY:


1 PARKING SPACE PER DWELLING UNIT =
1 BICYCLE SPACE PER 5 DWELLING UNITS =
7 BICYCLE SPACES

7,049 SF - 2,500 SF (PER 1410.85) = 4,549 SF / 500 SF = 9.10 \sim 9 CAR SPACES 4,549 SF / 5,000 SF = .91 \sim 1 BICYCLE SPACE

PER 1402.C3; WHERE A NON-RESIDENTIAL USE PROVIDES ADDITIONAL BICYCLE PARKING ES OF 120% OR MORE OF THAT REQUIRED, THE NON-RESIDENTIAL USE IS PERMITTED A VEHICLE PARKING SPACE REDUCTION OF UP TO

TOTAL:
CAR SPACES:
35 + 8 = 43 SPACES
BICYCLES SPACES
7 + 3 = 10 SPACES




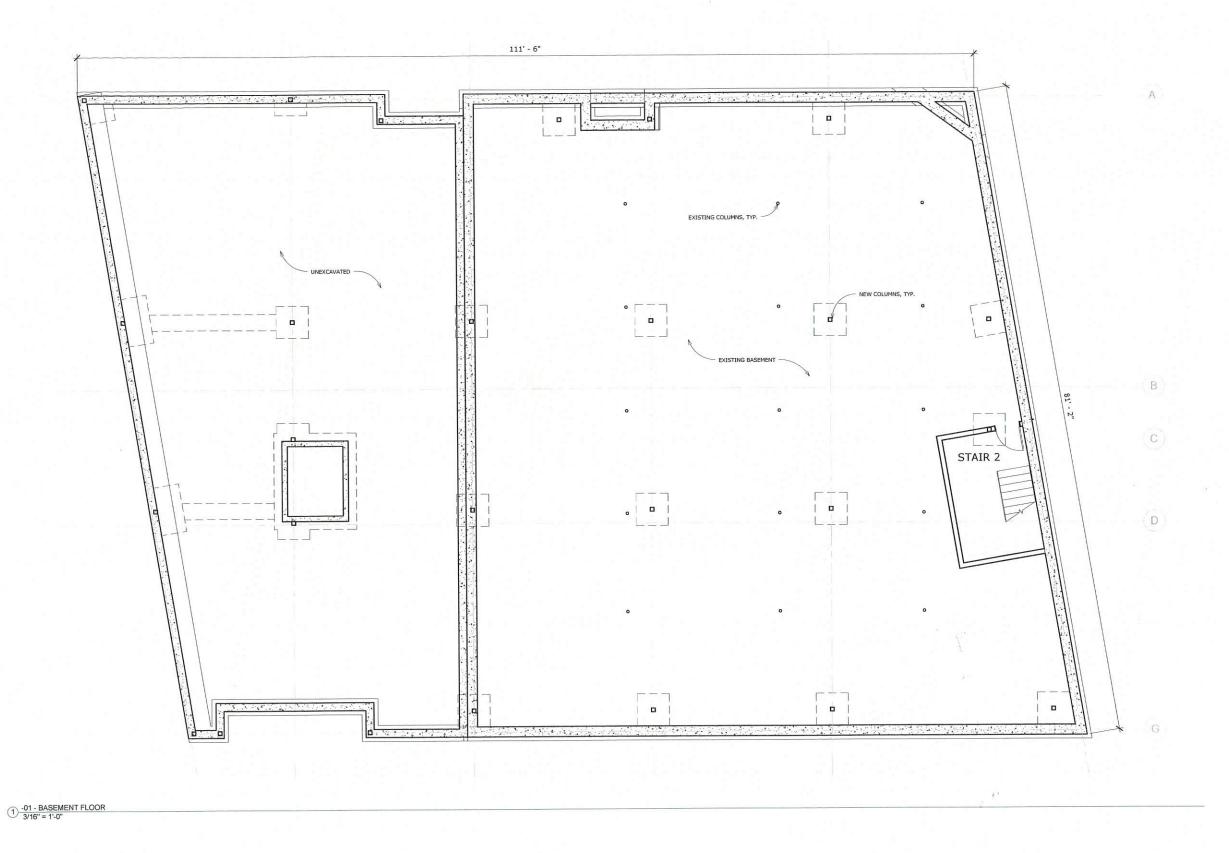

BASEMENT/FOUNDATION PLAN

1292 WESTMINSTER ST




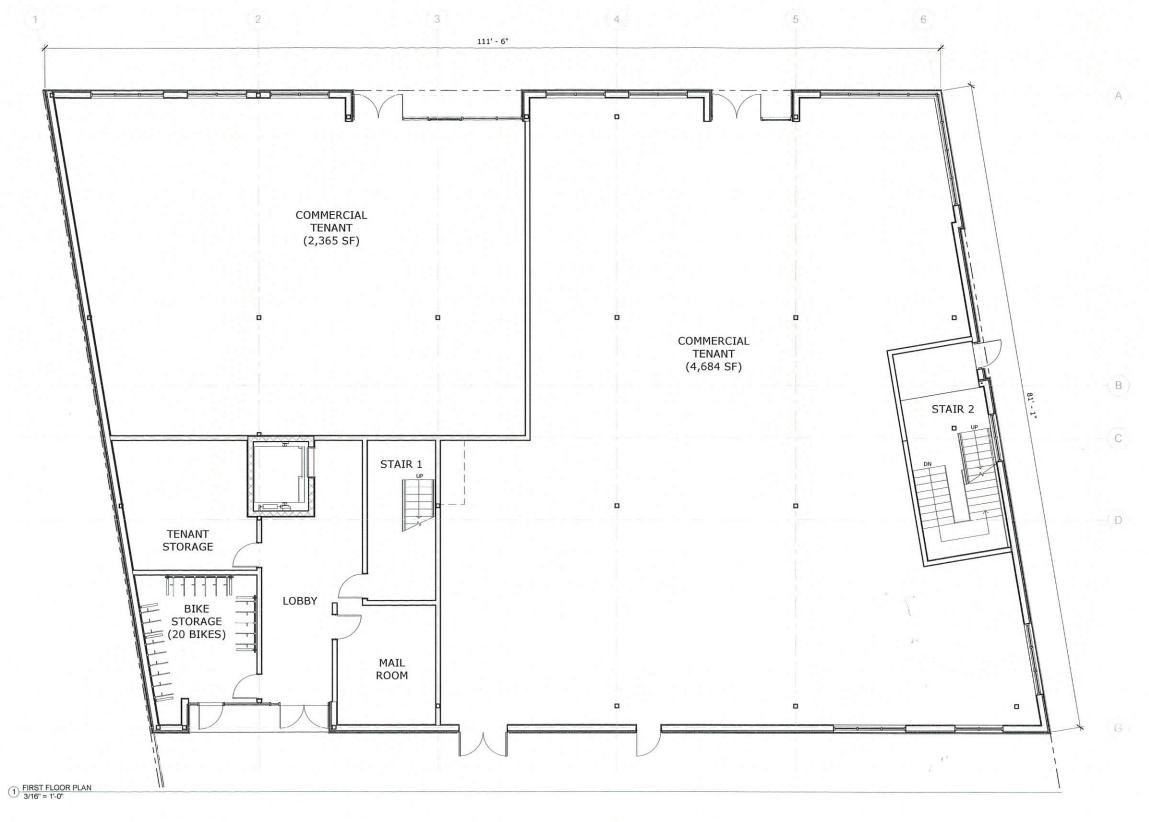

FIRST FLOOR PLAN

1292 WESTMINSTER ST




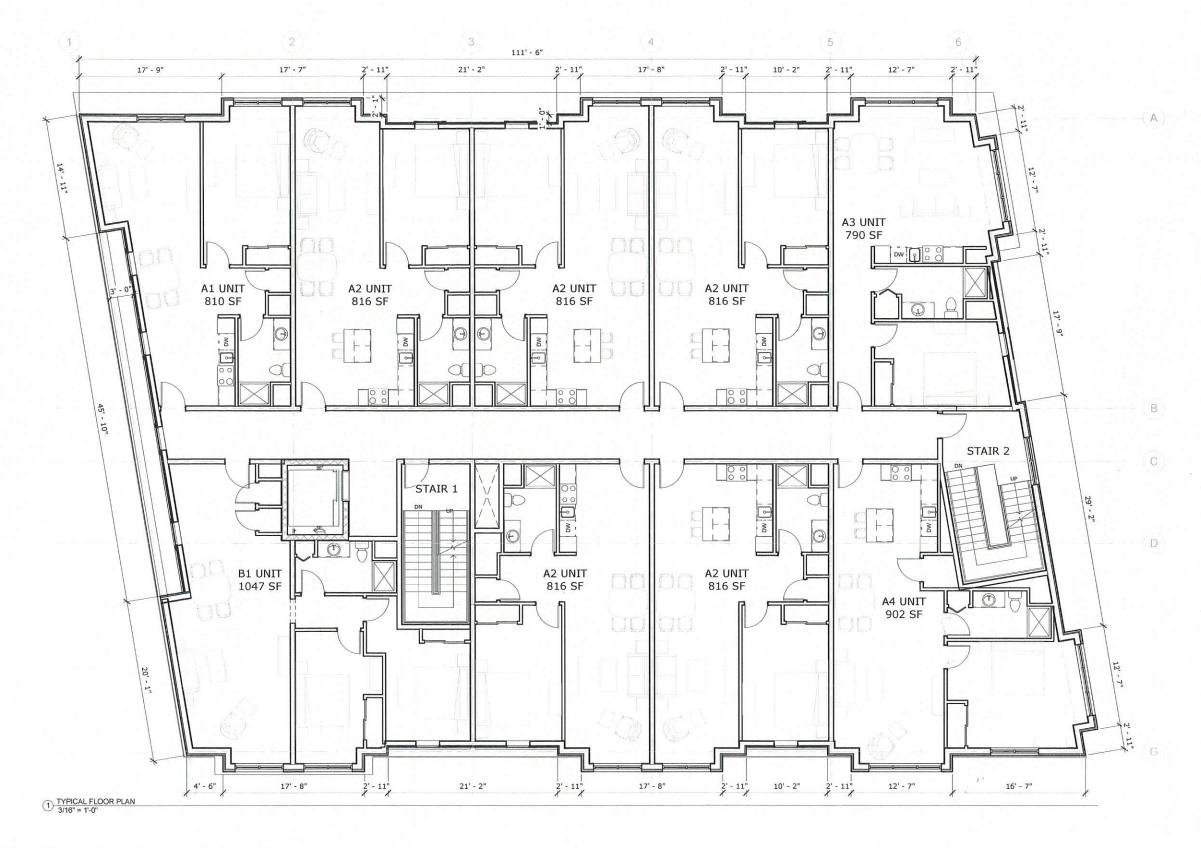

TYPICAL FLOOR PLAN (2-3)

1292 WESTMINSTER ST




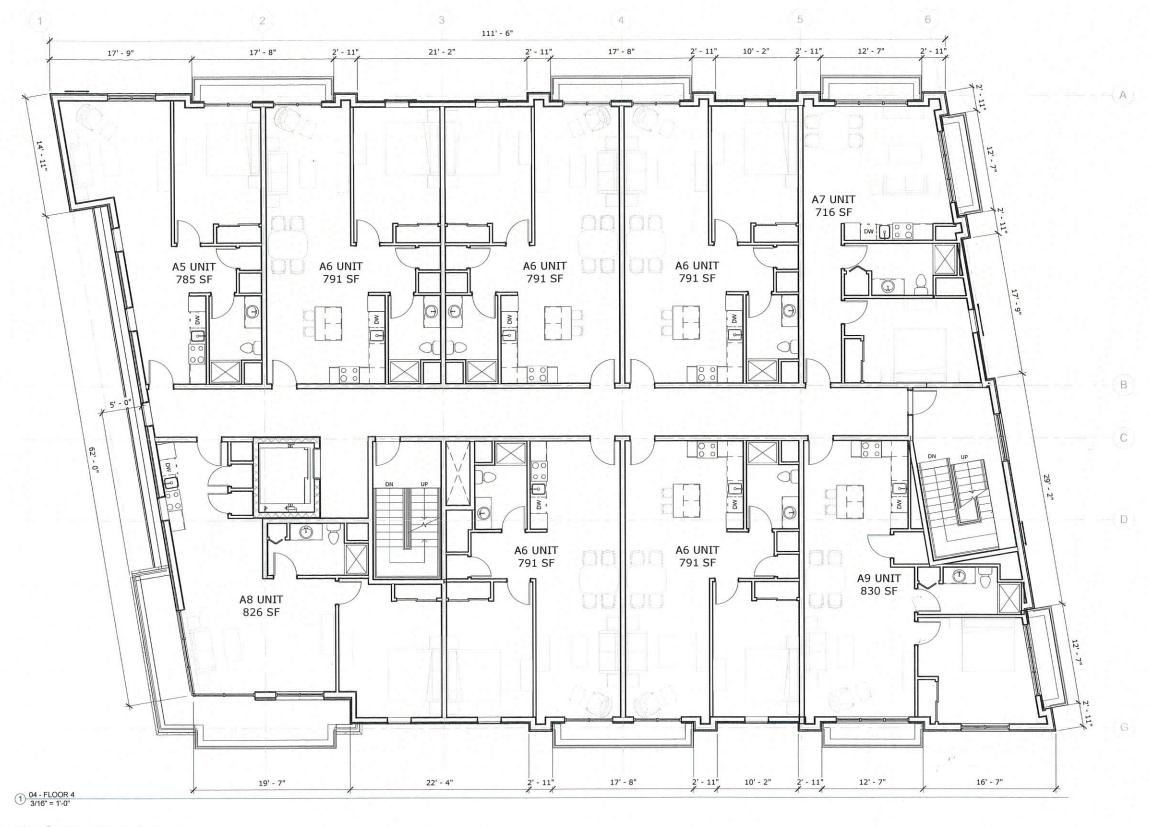

FOUTH FLOOR PLAN

1292 WESTMINSTER ST




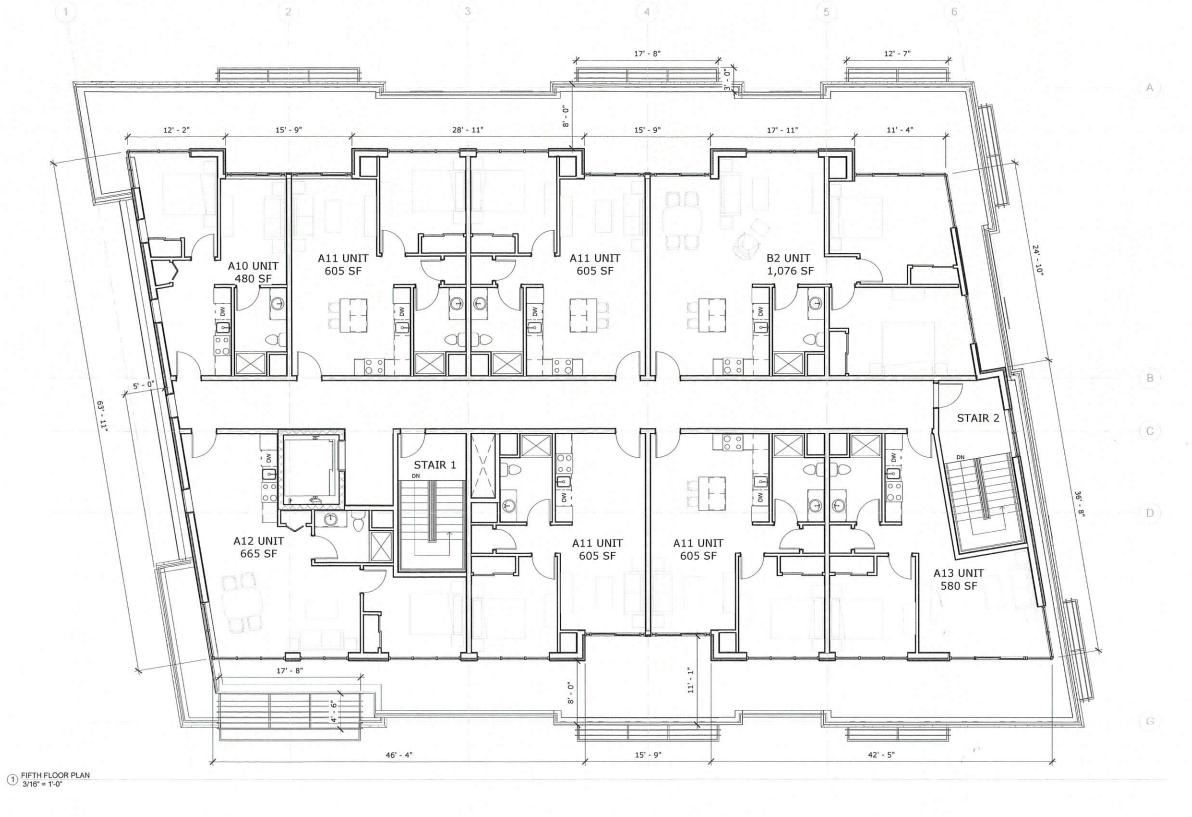

FIFTH FLOOR PLAN

1292 WESTMINSTER ST




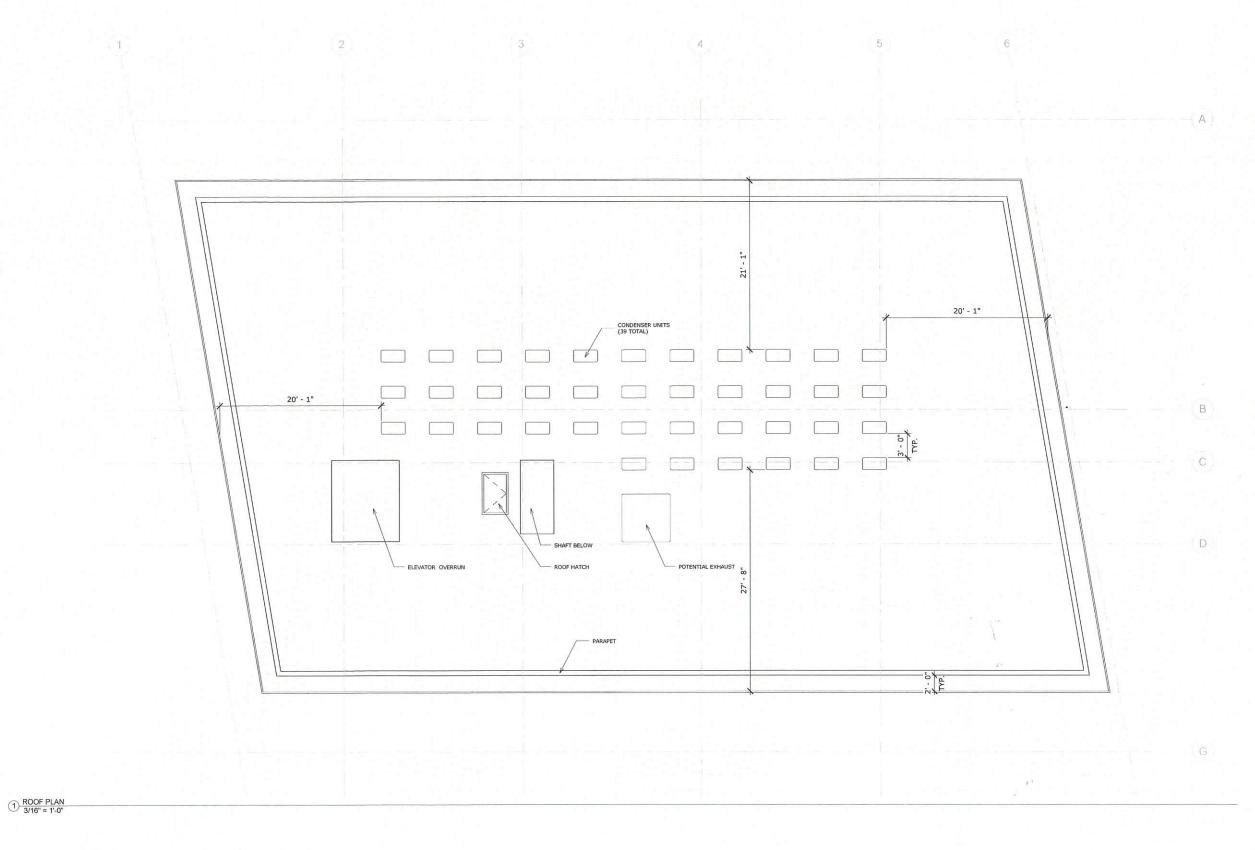

ROOF PLAN

1292 WESTMINSTER ST



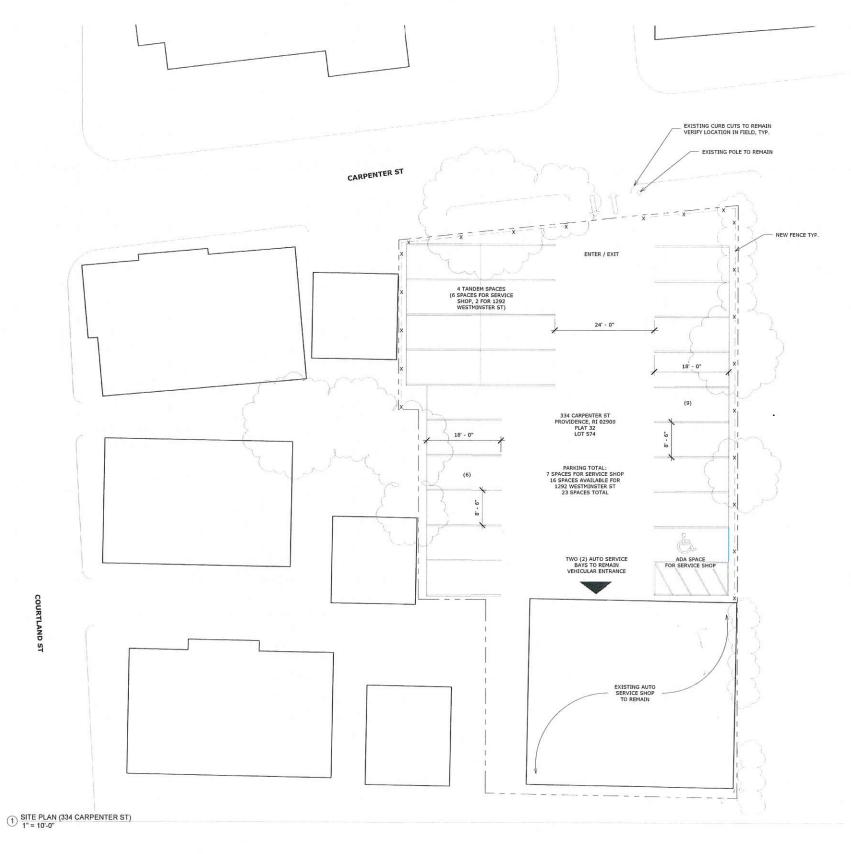

334 CARPENTER STREET PARKING LAYOUT

1292 WESTMINSTER ST





1292 WESTMINSTER ST PROVIDENCE CITY PLANNING COMMISSION

JANUARY 23, 2018





IBC 2012 TABLE 705.8

3' - 5' FROM PROPERTY LINE, SPRINKLERED - 15% ALLOWABLE WALL OPENING AREA (14.7% @ 2ND & 3RD FLOORS)

5' - 10' FROM PROPERTY LINE, SPRINKLERED - 25% ALLOWABLE WALL OPENING AREA (25% @ 4TH FLOOR, 23.4% @ 5TH FLOOR)

PROPOSED SOUTH WEST 3D VIEW

1292 WESTMINSTER ST





PROPOSED SOUTH EAST 3D VIEW

1292 WESTMINSTER ST






PROPOSED NORTH WEST 3D VIEW

1292 WESTMINSTER ST



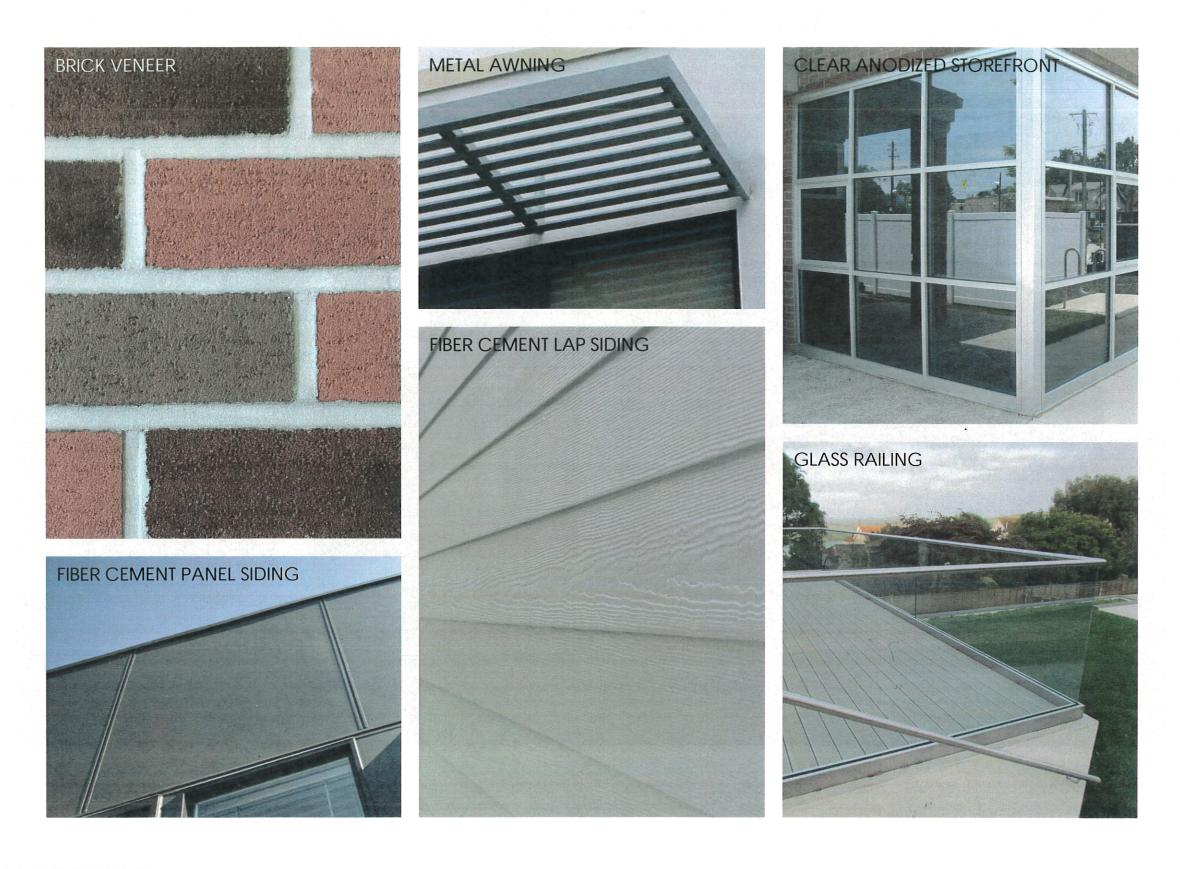

BUILDING MATERIALS


1292 WESTMINSTER ST

OCTOBER 2017







NORTH ELEVATION - WESTMINSTER ST

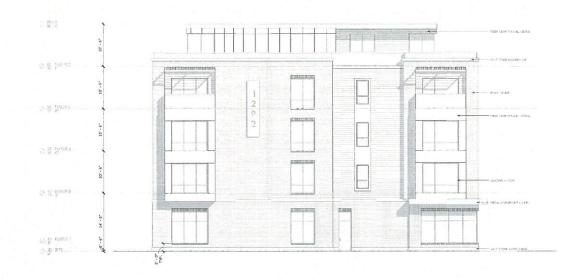

EAST ELEVATION - HARRISON ST

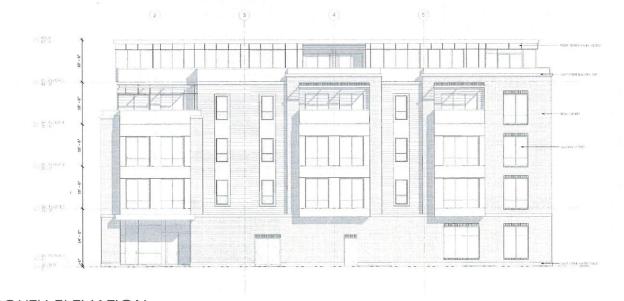

SOUTH ELEVATION

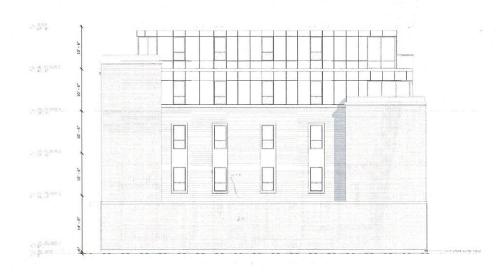

WEST ELEVATION

BUILDING ELEVATIONS

1292 WESTMINSTER ST
JANUARY 2018



SITE PLAN SET FOR

1292 WESTMINSTER STREET IMPROVEMENTS

PLAT 32, LOT 233

ZONING DISTRICT: C-2
GENERAL COMMERCIAL DISTRICT
HISTORIC OVERLAY DISTRICT
1292 WESTMINSTER STREET
PROVIDENCE, RHODE ISLAND

OWNER

1292 WESTMINSTER LLC 311 BROADWAY PROVIDENCE, RHODE ISLAND 02903

APPLICANT

MICHAEL LEMOI 311 BROADWAY PROVIDENCE, RHODE ISLAND 02903

ENGINEERS and LAND SURVEYORS



- Transportation
- Environmental
- Surveying
 Permitting
- Landscape Architecture

CROSSMAN ENGINEERING

Rhode Island 151 Centerville Road Warwick, RI 02886 Phone: (401) 738-5660

103 Commonwealth Avenue North Attleboro, MA 02763 Phone: (508) 695-1700

Email: cel@crossmaneng.com

JANUARY 2018 SHEET 1 of 15

ARCHITECT







LOCATION MAP

NOT TO SCALE

INDEX OF DRAWINGS

DRAWING No.	PLAN
C1	GENERAL NOTES and LEGEND
C2	EXISTING AERIAL MAP
C3	PROPOSED AERIAL MAP
C4	EXISTING CONDITIONS PLAN
. C5	SITE LAYOUT PLAN
C6	PRELIMINARY GRADING and DRAINAGE PLAN
C7	SOIL EROSION and SEDIMENT CONTROL PLAN
C8	MISCELLANEOUS DETAIL PLAN No. 1
C9	MISCELLANEOUS DETAIL PLAN No. 2
C10	MISCELLANEOUS DETAIL PLAN No. 3
E1	SITE LIGHTING PLAN
L1	LANDSCAPE PLAN
L2	LANDSCAPE DETAIL PLAN
	LIMITED CONTENT BOUNDARY SURVEY

REVISIONS:					
No.: DATE:		DESCRIPTION:			
100					

GENERAL NOTES

- THE EXISTING CONDITIONS AND UTILITY INFORMATION REFERENCED IN THIS PLAN SET IS BASED UPON A SURVEY PLAN PREPARED BY OTHERS (SEE MAP REFERENCE). THE PLANS DO NOT DEPICT ALL UNDERGROUND UTILITY SYSTEMS. THE CONTRACTOR SHALL VERIFY THE LOCATIONS OF ALL EXISTING DRAINAGE AND UTILITIES, BOTH UNDERGROUND AND OVERHEAD, BEFORE EXCAVATION BEGINS IN ACCORDANCE WITH "DIG SAFE PROGRAM LAW" ENACTED BY THE R.I. LEGISLATURE AND BY CONTACTING THE INDIVIDUAL UTILITY COMPANIES. EXCAVATION SHALL BE IN ACCORDANCE WITH ALL STATUTES, ORDINANCES, RULES AND REGULATIONS OF ANY CITY, STATE OR FEDERAL AGENCY THAT MAY APPLY. ANY DAMAGE TO EXISTING UTILITIES SHALL BE THE CONTRACTOR'S RESPONSIBILITY.
- 2. SPECIFICATIONS TO GOVERN THIS PROJECT ARE IDENTIFIED WITHIN THE PROJECT MANUAL FOR ALL EXCAVATION, PLACEMENT OF FILL, PIPE INSTALLATION, BITUMINOUS PAVEMENT, CUTTING INTO CATCHBASIN/MANHOLES, CONCRETE AND SAWCUTTING, THE CONTRACTOR SHALL PERFORM THE WORK IN FULL COMPLIANCE WITH THE RHODE ISLAND DEPARTMENT OF TRANSPORTATION STANDARD SPECIFICATIONS FOR ROAD AND BRIDGE CONSTRUCTION, AMENDED AUGUST 2013, WITH LATEST REVISIONS UNLESS OTHERWISE SHOWN ON PLANS. THE "METHOD OF MEASUREMENT" AND "BASIS OF PAYMENT" WITHIN THE R.I.D.O.T. SPECIFICATIONS ARE NOT APPLICABLE. THESE SPECIFICATIONS CAN BE OBTAINED ON—LINE AT:

HTTP://WWW.DOT.STATE.RI.US/ENGINEERING/STANDARDS/INDEX.ASP

- FOR ALL EXCAVATION AND PLACEMENT OF FILL, THE CONTRACTOR SHALL PERFORM THE WORK IN FULL COMPLIANCE WITH THE R.I. STANDARD SPECIFICATION SECTION 202.
- 4. RHODE ISLAND STANDARDS REFERENCED ARE ACCORDING TO THE STATE OF RHODE ISLAND AND PROVIDENCE PLANTATIONS "RHODE ISLAND STANDARD DETAILS" DATED MAY 20, 2015, WITH ALL REVISIONS AS PREPARED BY THE DEPARTMENT OF TRANSPORTATION.
- 5. THE CONTRACTOR MUST VERIFY PRIOR TO CONSTRUCTION THAT ALL REQUIRED AUTHORIZATION TO PERFORM WORK HAS BEEN OBTAINED. THE CONTRACTOR SHALL BE SOLELY RESPONSIBLE FOR CONSTRUCTION OPERATIONS INCLUDING ALL ACTIONS OR OMISSIONS OF ANY SUBCONTRACTORS, AGENTS OR EMPLOYEES. THE CONTRACTOR MUST ENSURE THAT THE CONDITIONS OF ALL PERMITS, SPECIFICATIONS AND FEDERAL, STATE AND LOCAL REGULATIONS ARE STRICTLY EMPORCED. THE CONTRACTOR IS ALSO RESPONSIBLE FOR ASPECTS OF ON-SITE SAFETY INCLUDING ANY DAMAGE TO EXISTING STRUCTURES.
- 6. WORK SHOWN ON THE PLANS FOR WHICH THERE ARE NO PARTICULAR DETAILS OR SPECIFICATIONS DOES NOT RELIEVE THE CONTRACTOR FROM FURNISHING AND INSTALLING THE WORK. THE CONTRACTOR SHALL THOROUGHLY EXAMINE THE CONTRACT DOCUMENTS AND PLANS AND INSPECT THE SITE. THE BID PRICE SHALL INCLUDE ALL LABOR, INCIDENTALS, TOOLS EQUIPMENT, TESTING, SERVICES AND MATERIALS NECESSARY TO COMPLETE THE PROJECT ANY CHANGES TO THE PROJECT OR THE INSTALLATION OF AN ITEM FOR WHICH NO PARTICULAR DETAIL OR SPECIFICATION WAS PROVIDED MUST BE REVIEWED BY AND MUST BE ACCEPTABLE TO THE FIGURISHER AND OWNER.
- CONTRACTOR IS RESPONSIBLE TO VERIFY ALL EXISTING CONDITIONS AND DIMENSIONS PRIOR TO CONSTRUCTION. THE CONTRACTOR SHALL NOTIFY THE ENGINEER OF ANY DISCREPANCIES PRIOR TO ANY WORK.
- 8. IT IS THE RESPONSIBILITY OF THE CONTRACTOR TO REVIEW ALL DRAWINGS AND SPECIFICATIONS ASSOCIATED WITH THIS PROJECT PRIOR TO THE INITIATION OF WORK. SHOULD THE CONTRACTOR FIND A CONFLICT WITH THE DOCUMENTS, RELATIVE TO THE SPECIFICATIONS OR APPLICABLE. CODES, IT IS THE CONTRACTOR'S RESPONSIBILITY TO NOTIFY THE PROJECT ENGINEER OF RECORD IN WRITING PRIOR TO THE START OF CONSTRUCTION, FALLER BY THE CONTRACTOR TO NOTIFY THE PROJECT ENGINEER SHALL CONSTITUTE ACCEPTANCE OF FULL RESPONSIBILITY BY THE CONTRACTOR TO COMPLETE THE SCOPE OF WORK AS DEFINED BY THE DRAWINGS AND IN FULL CONFORMANCE WITH LOCAL REGULATIONS AND CODES.
- 9. ALL DISTURBED AREAS SHALL BE REPLACED IN KIND UNLESS OTHERWISE SHOWN.
- THROUGHOUT THE SITE URBAN FILL AND/OR DEBRIS MAY BE ENCOUNTERED DURING EXCAVATION.
 THE CONTRACTOR SHALL INCLUDE REMOVAL AND DISPOSAL OF THIS MATERIAL WITHIN THE REQUIRED
 EXCAVATION AREA, IN THE BID PRICE.
- 11. ALL PROPOSED SIDEWALK RAMPS SHALL HAVE A DETECTABLE WARNING DEVICE (RI STD 48.1.0).
- 12. THE SITE IS NOT WITHIN 200' OF ANY WETLAND AREAS, WATER COURSES OR COASTAL FEATURES.
- 13. THE EXISTING WATER, SEWER AND GAS UTILITIES TO THIS SITE WILL BE RE-USED FOR THE PROPOSED BUILDING IMPROVEMENTS, REFER TO ARCHITECTUAL PLANS FOR THE INTERIOR MODIFICATIONS INCLUDING THE WATER METER AND BACKELOW PREVENTER.
- 14. REFER TO ARCHITECTUAL PLANS FOR THE ELECTRIC, TELEPHONE AND CABLE SERVICE LOCATIONS. THE CONTRACTOR SHALL COORDINATE WITH EACH UTILITY COMPANY FOR SERVICE INSTALLATION.

LAYOUT NOTE

THE LAYOUT SHOWN REPRESENTS A GRAPHICAL DESIGN, AND PRIOR TO CONSTRUCTION, THE THE DATOUT SHOWN REPRESENTS A GRAPHICAL DESIGN, AND PHONE TO CONSTRUCTION, THE
CONTRACTOR SHALL ENGAGE A PROFESSIONAL LAND SURVEYOR (PLS) REGISTERED IN THE STATE TO
SET AND VERIEY ALL LINES AND GRADES AND PROVIDE A BENCH MARK FOR CONSTRUCTION, ALL
EXISTING UTILITY LOCATIONS AND ELEVATIONS ARE TO BE CONFIRMED BY THE CONTRACTOR PRIOR
TO CONSTRUCTION. ANY ITEM FOUND WHICH DOES NOT MATCH THE PLANS MUST BE BROUGHT TO THE ENGINEER'S ATTENTION PRIOR TO CONSTRUCTION FOR REVIEW. NO WORK SHALL PROCEED

EXISTING UTILITY NOTES

- THE CONTRACTOR SHALL NOTIFY THE PROPER UTILITY COMPANIES AND OWNER TO OBTAIN THE LOCATION OF ALL UTILITIES PRIOR TO BEGINNING WORK. THE MARKED LOCATIONS SHALL BE PRESERVED BY THE CONTRACTOR DURING THE COURSE OF THE WORK, UNTIL SUCH TIME AS
- ALL UTILITIES INTERFERED WITH OR DAMAGED BY THE CONTRACTOR SHALL BE IMMEDIATELY AND PROPERLY RESTORED BY THE CONTRACTOR AT NO ADDITIONAL COST TO THE OWNER. THE CONTRACTOR SHALL FULLY COMPACT ALL BACKFILL MATERIAL AROUND AND UNDER ALL EXISTING UTILITIES ENCOUNTERED OR CROSSED.
- UNDERGROUND UTILITIES REFERENCED ON THESE PLANS HAVE BEEN PROVIDED BY OTHERS, REFER TO MAP REFERENCE.
- CROSSMAN ENGINEERING HAS LOCATED THE SITE TOPOGRAPHY IN JANUARY 2018. THE BENCH MARK USES AN ASSUMED DATUM.

MAP REFERENCES

LIMITED CONTENT BOUNDARY SURVEY, A.P. 32 LOT 233, 1292 WESTMINSTER STREET, PROVIDENCE, RHODE ISLAND, PREPARED FOR MICHAEL LEMOI C/O ZDS, INC., PREPARED BY; OCEAN STATE PLANNERS, INC., 1255 OAKLAWN AVENUE, CRANSTON, RHODE ISLAND, (401) 463-9696, DATE; NOVEMBER 3, 2017, SCALE 1°=10°.

THE SITE IS LOCATED IN ZONE X. AREAS DETERMINED TO BE OUTSIDE THE 0.2% CHANCE FLOOD. AS NOTED ON THE FLOOD INSURANCE RATE MAP, PROVIDENCE COUNTY, RHODE ISLAND (ALL JURISDICTIONS), PANEL 308 OF 451, MAP NUMBER 44007C0308J, MAP REVISED OCTOBER 2, 2015

PROPOSED PAVEMENT STRUCTURE

- 1 1/2" BITUMINOUS CONCRETE COURSE 2 1/2" BITUMINOUS CONCRETE BASE COURSE

MAINTENANCE AND PROTECTION OF TRAFFIC NOTES

- 1. THE CONTRACTOR SHALL BE RESPONSIBLE FOR ALL MAINTENANCE AND PROTECTION OF PEDESTRIAN AND VEHICULAR TRAFFIC INCLUDING POLICE PROTECTION. ALL TEMPORARY CONSTRUCTION SIGNS, BARRICADES AND LANE CLOSURES SHALL BE IN CONFORMANCE WITH THE LATEST REVISIONS OF MANUAL OF UNIFORM TRAFFIC CONTROL DEVICES (M.U.T.C.D.)
- 2. TEMPORARY CONSTRUCTION SIGNS AND ALL APPLICABLE TRAFFIC CONTROL DEVICES SHALL BE IN PLACE PRIOR TO THE START OF WORK IN ANY AREA OPEN TO TRAFFIC.
- 3. THE PRIVATE VEHICLES OF CONSTRUCTION WORKERS WILL NOT BE PARKED IN ANY ROADWAY
- 4. ALL MAINTENANCE AND PROTECTION OF TRAFFIC CONTROL SETUPS, SIGNS, CHANNELING DEVICES, ETC., SHALL BE IN ACCORDANCE WITH THE MANUAL ON UNIFORM TRAFFIC CONTROL DEVICES, 2009 EDITION, INCLUDING REVISION 2, MAY 2012, AND SUBSEQUENT ADDENDA.
- SIGN MOUNTINGS SHALL BE IN ACCORDANCE WITH THE STATE D.O.T. SPECIFICATIONS FOR TEMPORARY CONSTRUCTION SIGNS.
- THE CONTRACTOR SHALL INCLUDE POLICE DETAILS REQUIRED FOR WORK WITHIN THE CITY RIGHT-OF-WAY, WITHIN THE CONTRACT FRICE.
- 7. ROAD OPENING PERMITS SHALL BE OBTAINED BY THE CONTRACTOR.
- 8. COORDINATION WITH THE PROVIDENCE DEPARTMENT OF PUBLIC WORKS IS REQUIRED TO REVIEW ALL WORK IMPACTING SIDEWALKS AND/OR PEDESTRIAN TRAFFIC WITHIN THE CITY R.O.W. THE CONTRACTOR IS RESPONSIBLE FOR ALL SIGNAGE, DETOURS AND TEMPORARY FENCING AROUND SITE REQUIRED DURING CONSTRUCTION. DPW APPROVALS WILL BE REQUIRED FOR

UTILITY NOTES

- THE CONTRACTOR SHALL REVIEW ALL PLANS PREPARED BY THE ARCHITECT, MECHANICAL ELECTRIC AND PLUMBING ENGINEER TO CONPIRM IF ALL EXISTING UTILITY SERVICES TO THE BUILDING ARE TO REMAIN. EXISTING SERVICE UTILITIES NO LONGER REQUIRED SHALL BE CUT AND CAPPED AT THE PROPERTY LINE. COORDINATION WITH THE UTILITY COMPANIES WILL BE
- PRIOR TO CONSTRUCTION AND AS REQUIRED FOR NEW SERVICES, THE CONTRACTOR MUST PERFORM ADDITIONAL TESTS TO:
 - A. CONFIRM THE EXISTING DEPTHS OF UTILITIES AT ALL PROPOSED CONNECTION POINTS AND POTENTIAL CROSSOVER (CONFLICT) POINTS.
 - B. CONFIRM THE EXTENT OF LEDGE WHICH MAY EXIST IN ALL ANTICIPATED UTILITY TRENCH AREAS. PRIOR TO CONSTRUCTION, THE FINDINGS ARE TO BE REVIEWED BY THE OWNER AND THE ENGINEER. IF NECESSARY, ALTERNATIVES TO MINIMIZE LEDGE REMOVAL AND UTILITY CONFLICTS WILL BE DEVELOPED. NO CONSTRUCTION WILL BE ALLOWED WITHOUT
 - C. THE CONTRACTOR SHALL DIG TEST HOLES TO VERIFY THE ELEVATIONS AND PIPE MATERIAL OF THE EXISTING WATER, GAS AND SANITARY SERVICES AT THE PROPOSED TIE—IN LOCATION.
- 2. ANY MODIFICATIONS TO THE PROPOSED UTILITIES TO AVOID CONFLICTS MUST BE APPROVED BY THE ENGINEER PRIOR TO CONSTRUCTION. NO EXTRA PAYMENT TO THE CONTRACTOR DUE TO RELOCATIONS WILL BE AUTHORIZED.
- 3. CONTRACTOR SHALL NOTIFY ALL UTILITY COMPANIES PRIOR TO TIE-IN OR SERVICE REMOVAL.
- 4. THIS UTILITY PLAN DOES NOT REPRESENT THE SITE ELECTRICAL/TELEPHONE/COMMUNICATION SYSTEM DESIGNS AND DOES NOT REPRESENT IRRIGATION PIPING. CONTRACTOR SHALL COORDINATE WITH ARCHITECT TO VERIFY IRRIGATION PIPING REQUIREMENTS.
- 5. AS APPLICABLE FOR NEW SERVICE; THE CONTRACTOR MUST LOCATE THE EXISTING WATER MAIN TO OBTAIN THE PROPER OUTSIDE DIAMETER TO SIZE THE SLEEVE.
- 6. AS APPLICABLE FOR NEW SERVICE; THE CONTRACTOR IS RESPONSIBLE TO ENSURE THAT ALL NEW UTILITY PIPE SIZES INCLUDING WAITER, SEWER AND GAS ARE VERIFIED BY THE ARCHITECT PRIOR TO ORDERING PIPE OR RELATED MATERIAL.
- 7. ALL PROPOSED PIPES AND CONDUITS SHALL BE INSTALLED TO MEET H-20 LOADING CAPACITY. ALL MATERIAL AND TRENCHING METHODS SHALL CONFORM TO H-20 LOADING CAPACITIES, AS RECOMMENDED BY THE MANUFACTURER. CONTRACTOR SHALL SUBMIT SHOP DRAWINGS/CATALOG CUTS FOR PROPOSED PIPE AND CONDUIT TO ENGINEER FOR APPROVAL.

- 1. AS APPLICABLE FOR TERMINATING EXISTING SERVICES; THE CONTRACTOR SHALL LOCATE ALL EXISTING UTILITY STUBS TO THIS SITE AND PROPERLY PLUG AND CAP STUBS AT THE PROPERTY LINE OR CURB LINE.
- 2. PRIOR TO REMOVAL OF OVERHEAD POLES AND WIRES THE CONTRACTOR SHALL CONTACT THE ELECTRIC, TELEPHONE, CABLE AND FIRE ALARM COMPANIES.
- THE CONTRACTOR IS RESPONSIBE TO REMOVE AND DISPOSE ALL ITEMS OUTSIDE THE BUILDING FOOTPRINT, INCLUDING BUT NOT LIMITED TO EXISTING PAVEMENT, SIDEWALKS, LIGHT POLES, DEBRIS, BOLLARDS, TREES, UNDERGROUND PIPES AND FENCING ON SITE.
- 4. BUILDING DEMOLITION IS NOT INCLUDED OR REFERENCED IN THIS PLAN SET. REFER TO ARCHITECTUAL PLANS FOR REQUIRED PERMITS, TESTING, REMOVAL AND DISPOSAL REQUIREMENTS FOR THE BUILDING DEMOLITION.

TEST PIT - DEMOLITION NOTES

THE SOIL EVALUATIONS CONDUCTED FOR THIS SITE NOTED REMAINS OF AN OLD STONE FOUNDATION. THIS STONE FOUNDATION WOULD BE CONSIDERED AN UNSTABLE CONDITION FOR THE NEW PARKING LOT. THEREFORE PRIOR TO CONSTRUCTION, THE CONTRACTOR SHALL DIG TEST HOLES TO VERIFY IF OTHER STONE FOUNDATIONS OR UNSTABLE CONDITIONS SIXEST, ONCE LOCATIONS ARE ESTABLISHED, THE CONTRACTOR SHALL REMOVE AND DISPOSE THE STONES, OR DEBRIS AND/OR SOIL. WITHIN THE BID PRICHING, THE CONTRACTOR SHALL PROVIDE A UNIT COST FOR REMOVAL AND DISPOSAL OF STONES OR DEBRIS AND/OR SOIL. PRICHING SHALL INCLUDE REPLACING THE VOID AREAS WITH GRAVEL BORROW, COMPACTED TO 95% DRY DENSITY, MODIFIED PROCTOR METHOD. ALL COST FOR MATERIAL TRUCKING, AND LABOR SHALL BE PROVIDED BY THE CONTRACTOR. COORDINATE DETAILS WITH OWNER.

	LEGEND	
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	LIGHT POLE	
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TEST PIT DATA

TEST F ENGINEERING

	TEST HOLE 1		-	0"-	TEST HOLE 2	
10	Bituminous Pavement	нтм-ви.	1	30	Bituminous Pavement	нтм-віт.
_	Light Olive Brown Sandy Loam/Loamy Sand	HTM (Frozen)		2*-	Light Olive Brown Sandy Loam/Loamy Sand	HTM (Frozen)
	Bituminous Pavement	HТМ-Віт.	*		Bituminous Pavement	HTM-Bit.
_	Mix of Sandy Loam with Grovel, Bricks, Dry Stone Foundation & Trace of Ash-Mix	Urban FilV HTM-Mix (Frigble)		10"-	Mix of Sendy Learn with Gravel, Bricks, Metal Pipe, Dry Stone Foundation & Broken Porcelain	Urban Fill/ HTM-Mix (Frigble)
	Dark Yellowish Brown Sandy Loam	Ab (Friable)			Light Olive Brown Gravelly Course Sand	C1 (Loose)
	Dark Yellowish Brown Sandy Loam	Bw1 (Friable)		88*	Light Olive Brown Course Sand	C2 (Loose)
_	Light Olive Brown Gravelly Loamy Sand	C1 (Loose)	L)	120-	No Limiting Layer No Water Seepag No Redox Feature	e
	Light Olive Brown Sand	C2 (Loose)			ESHWT >120" Design Infiltration	
-	Light Olive Brown Course Sand	C3 (Loose)			* NOTE	

No Limiting Layer No Water Seepage No Redox Features ESHWT >120"

* NOTE:

SOIL/FILL TO BE REMOVED UNDER INFILTRATION SYSTEM.



Key Plan

1292 WESTMINSTER STREET

PLAT MAP 32, LOT 233 ZONING DISTRICT C2 GENERAL COMMERCIAL DISTRICT and HISTORIC OVERLAY DISTRICT 1292 WESTMINSTER STREET PROVIDENCE, RHODE ISLAND

PREPARED FOR:




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GENERAL NOTES and LEGEND

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CROSSMAN ENGINEERING

North Attleboro, MA 0276 Phone: (508) 695-1700

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KEY PLAN

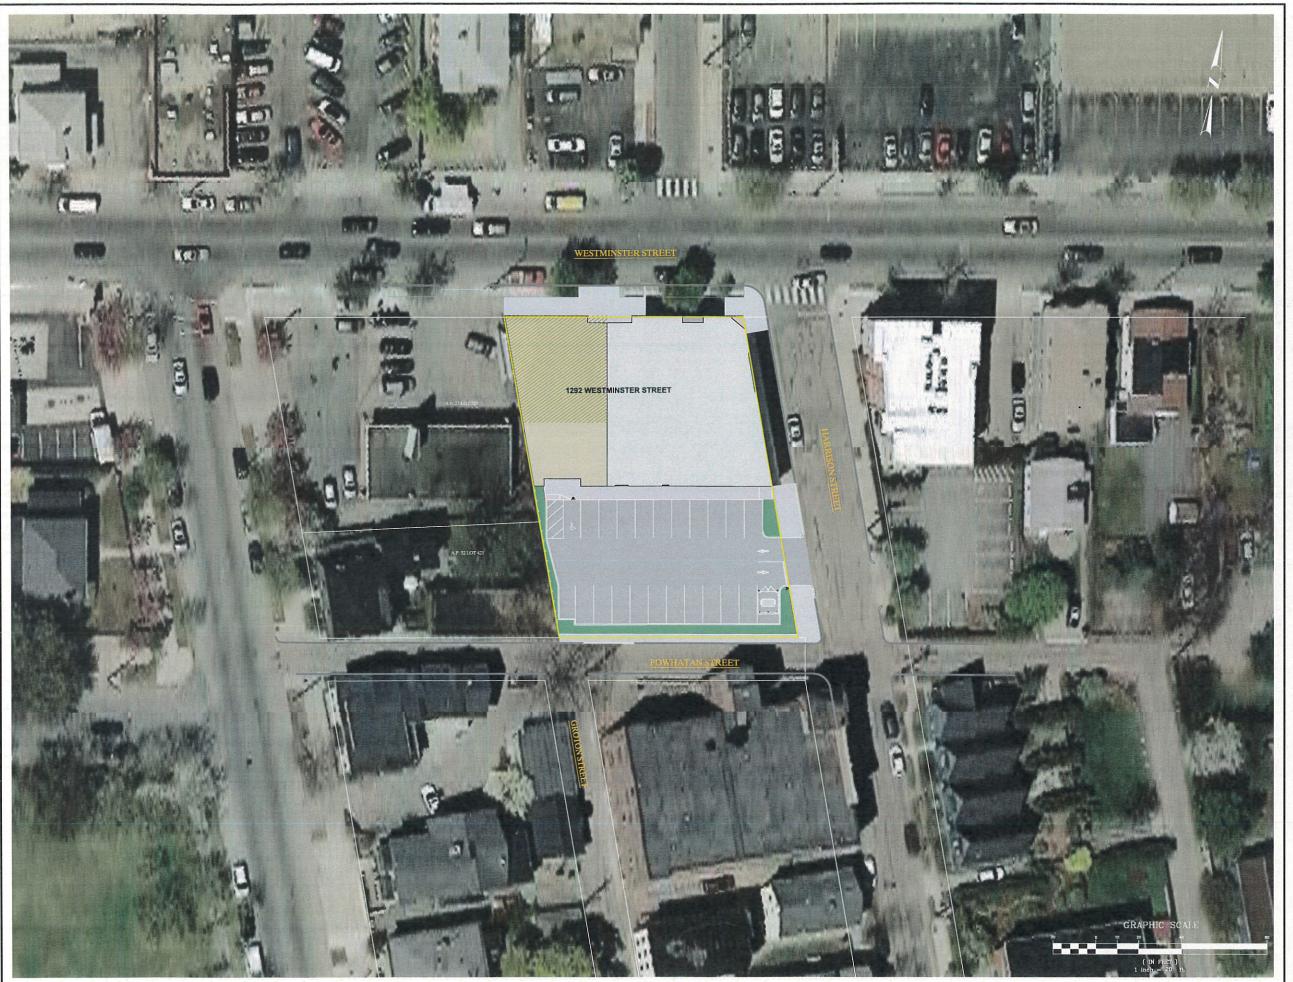PROJECT TITLE:

1292 WESTMINSTER STREET

PLAT MAP 32, LOT 233
ZONING DISTRICT C2
GENERAL COMMERCIAL
DISTRICT and HISTORIC
OVERLAY DISTRICT
1292 WESTMINSTER STREET
PROVIDENCE, RHODE ISLAND

PREPARED FOR:



ZDS inc.
WEYBOSSET ST, SUITE 302
PROVIDENCE, RI 02903
+1.401.680.6504

DRAWING TITLE:


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- Civil
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- Site Planning
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CROSSMAN ENGINEERING

Rhode Island 151 Centerville F Warwick, RI 02 Phone: (401) 738

Massachusetts
103 Commonwealth Avenu
North Attleboro, MA 02763
Phone: (508) 695-1700

Email: cei@crossmaneng.com

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PROVIDENCE, RHODE ISLAND

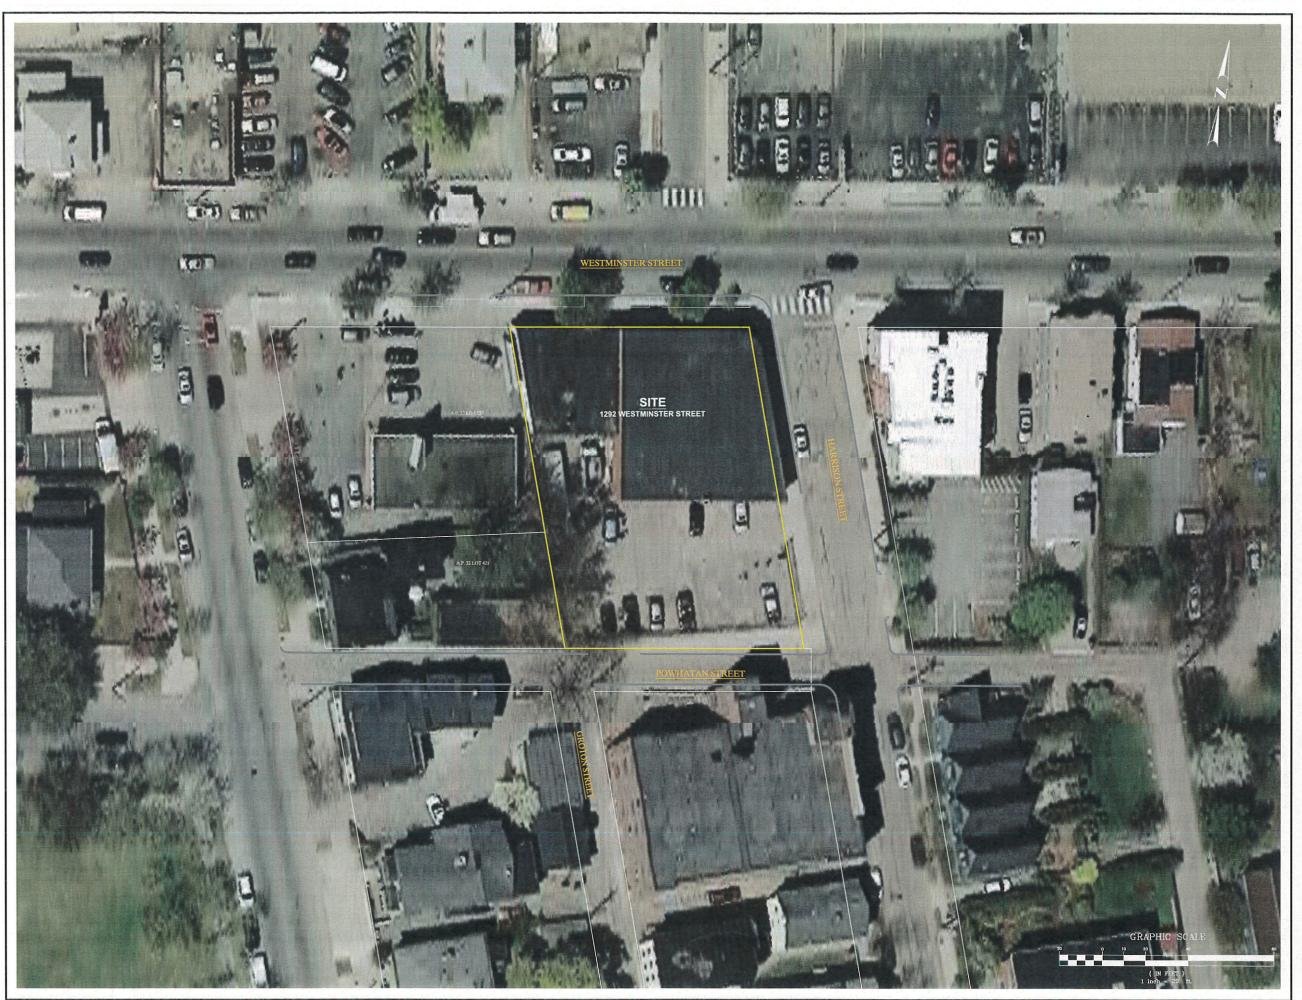PREPARED FOR:



ZDS inc.
WEYBOSSET ST, SUITE 302
PROVIDENCE, RI 02903
+1.401.680.6599
www.r-ds.com

DRAWING TITLE:

EXISTING AERIAL MAP


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Rhode Island 151 Centerville Re Warwick, RI 028 Phone: (401) 738-5 Massachusetts
dd 103 Commonwealth Av
5 North Attleboro, MA 0
60 Phone: (508) 695-17

Email: cel@crossmaneng.com

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PROVIDENCE, RHODE ISLAND

PREPARED FO

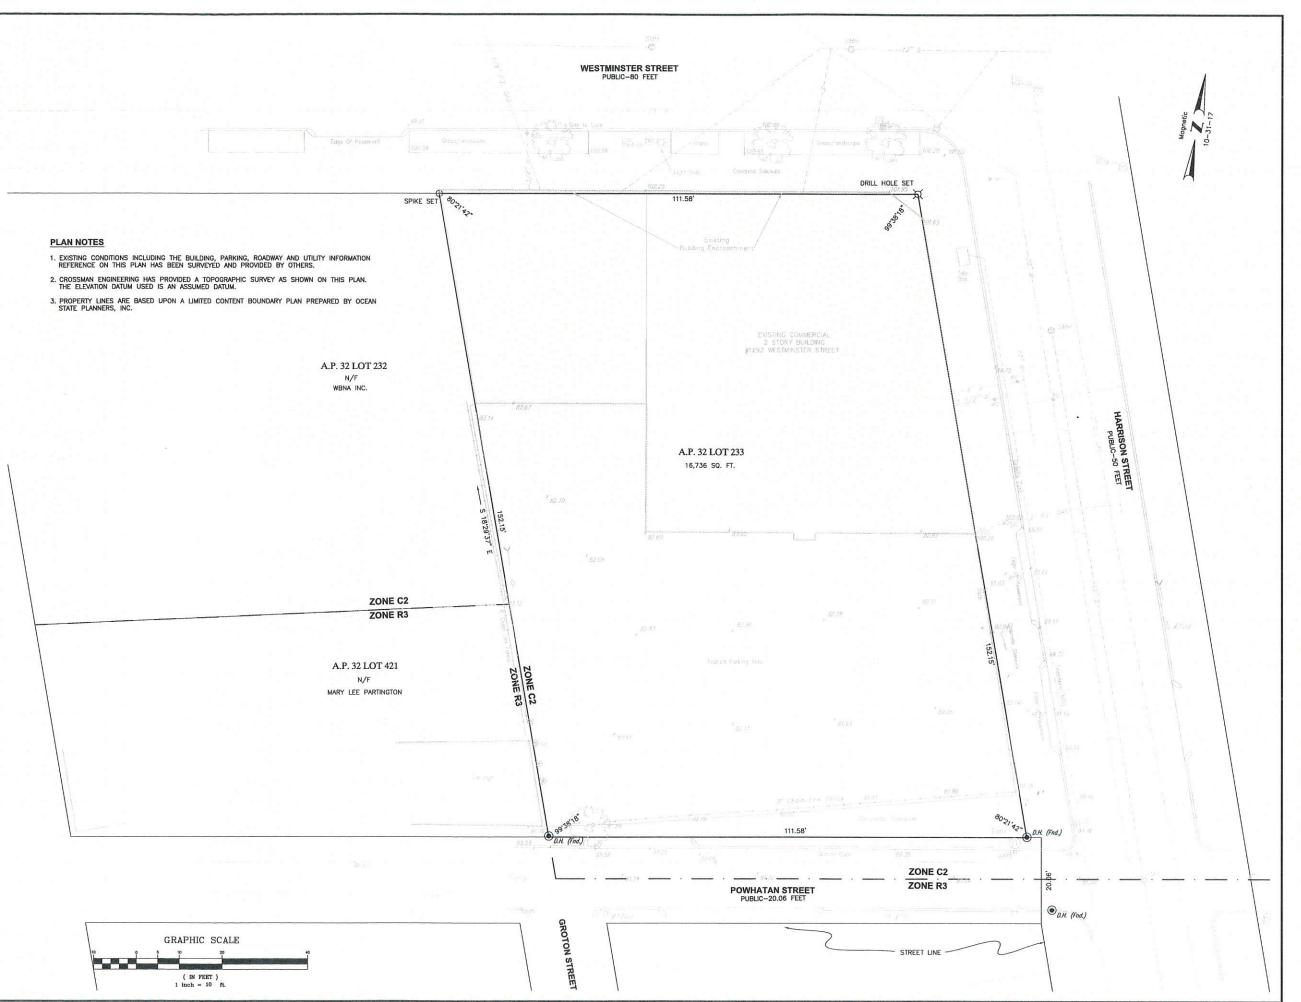

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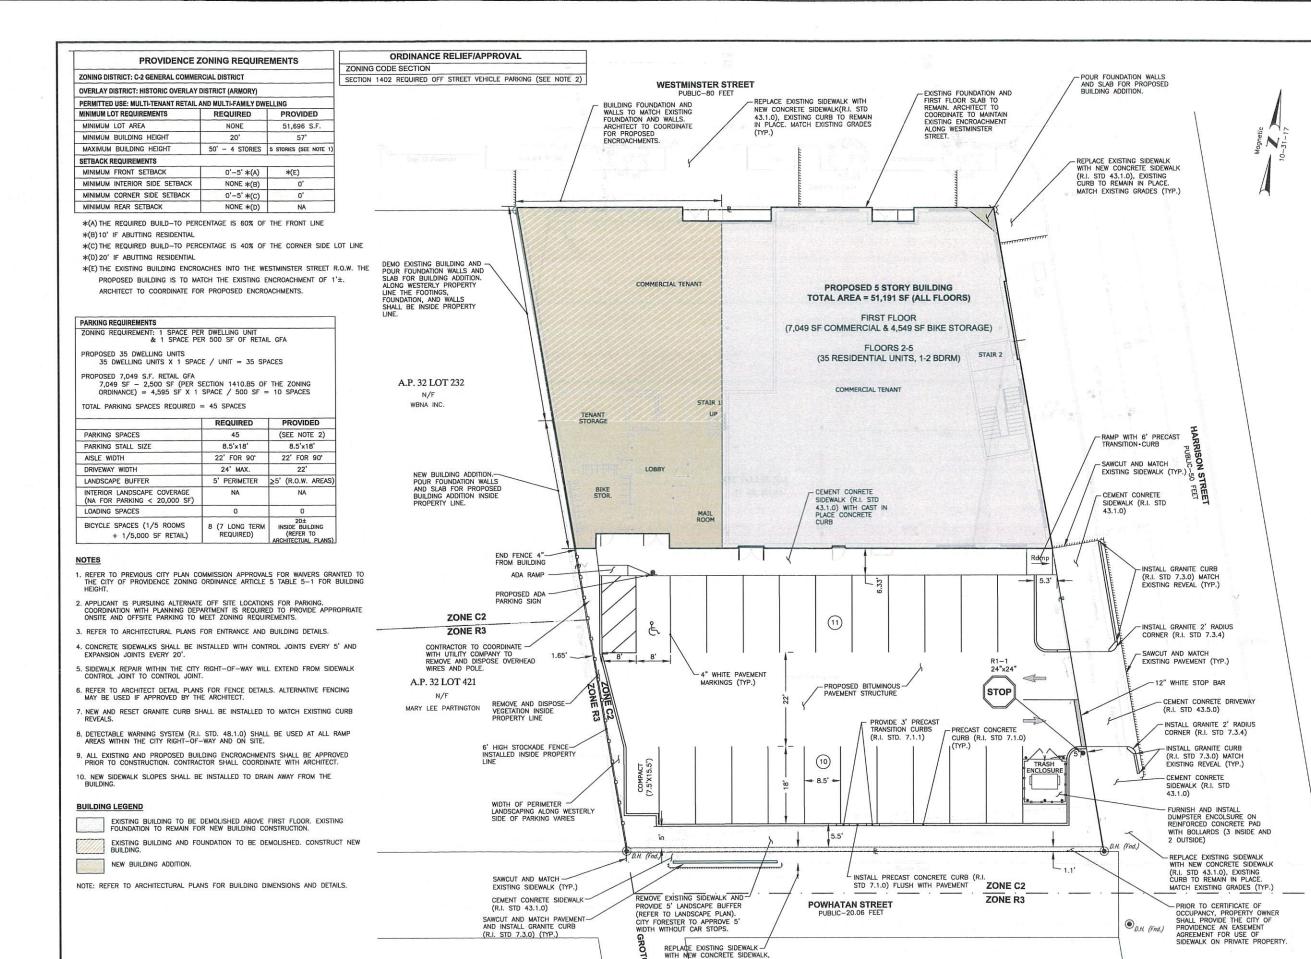
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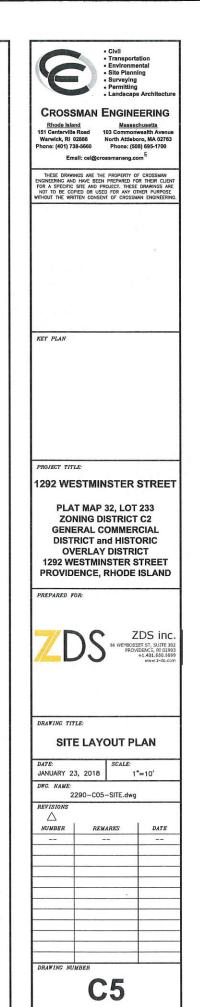
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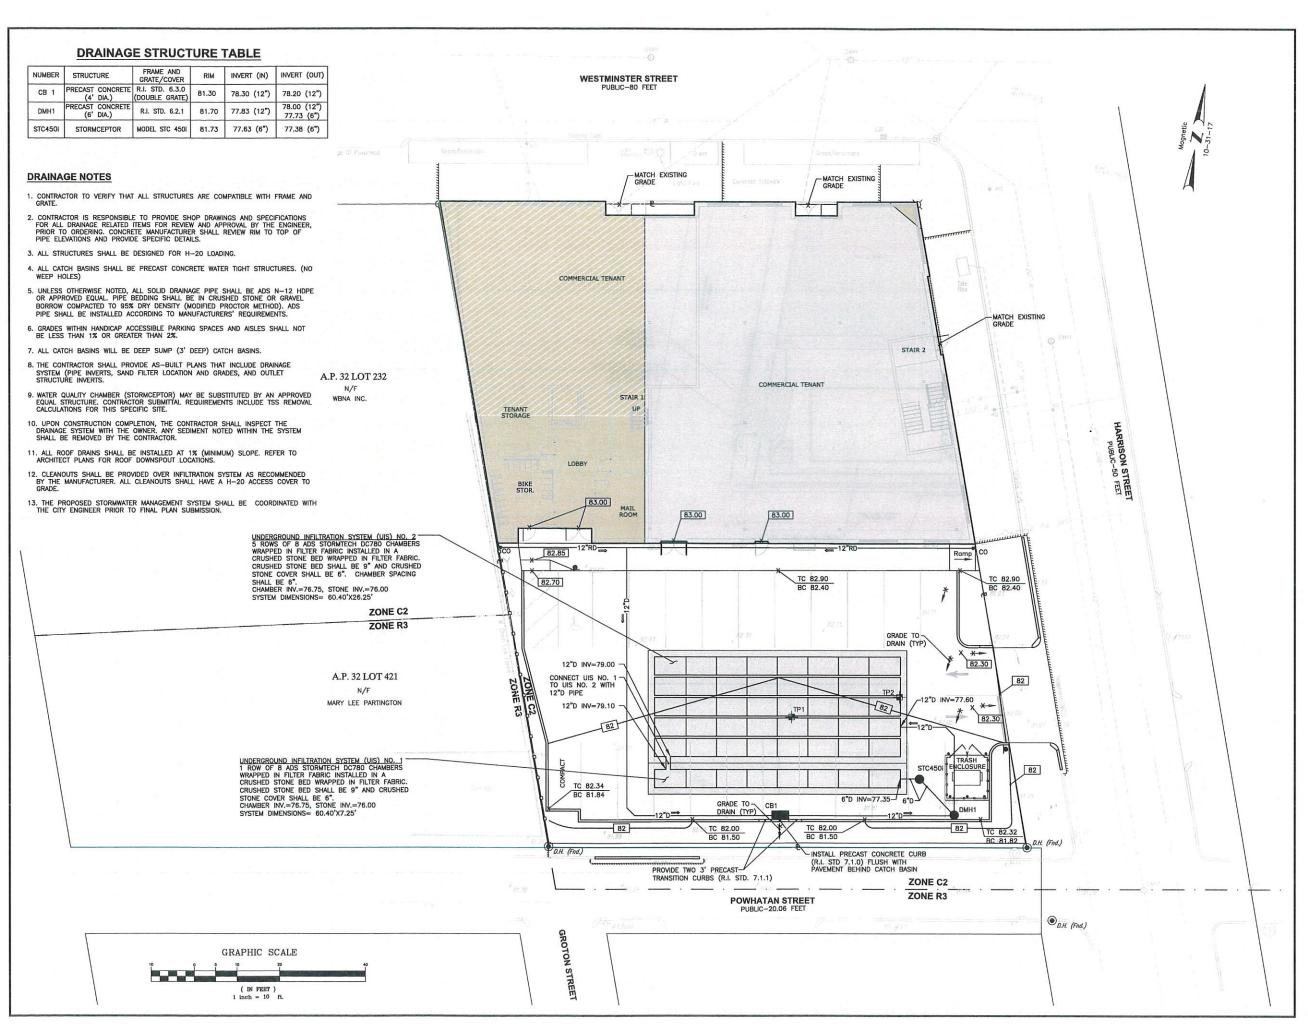


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GRAPHIC SCALE

1 inch = 10 f







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CROSSMAN ENGINEERING

Rhode Island 151 Centerville R Warwick, RI 028 Phone: (401) 738-

| Iland | Massachusetts | 103 Commonwealth Avenue | 102886 | North Attleboro, MA 02763 | 738-5660 | Phone: (508) 695-1700 |

mail: cei@crossmaneng.com

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1292 WESTMINSTER STREET
PROVIDENCE, RHODE ISLAND

PREPARED FO



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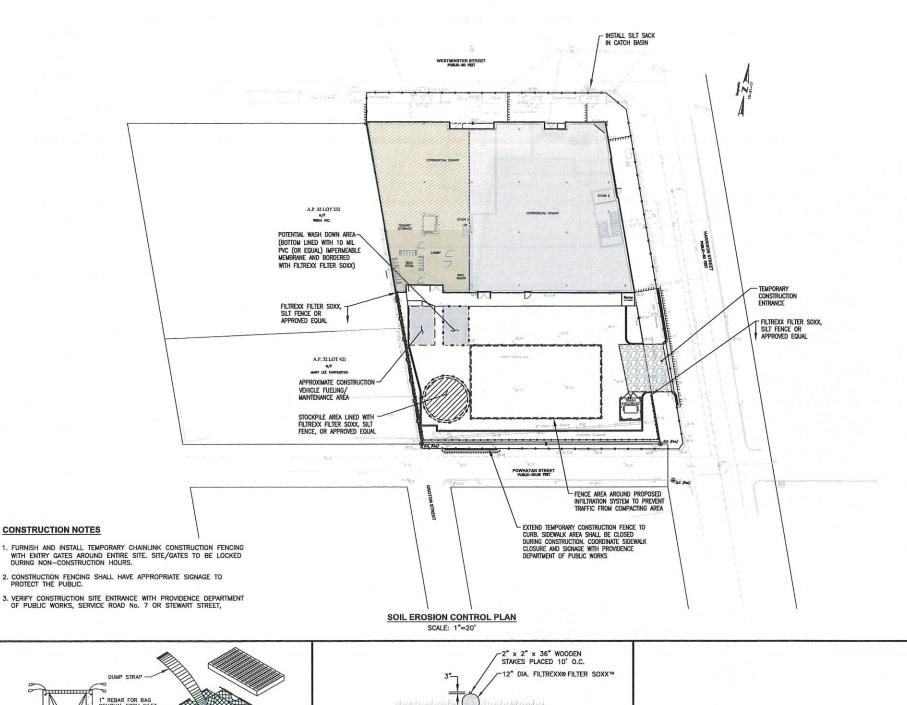
PRELIMINARY GRADING AND DRAINAGE PLAN


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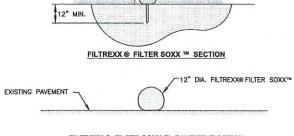




2. CONTRACTOR SHALL SUBMIT SILT SACK PRODUCT TO ENGINEER FOR APPROVAL

TYPICAL SILT SACK DETAIL

NOT TO SCALE

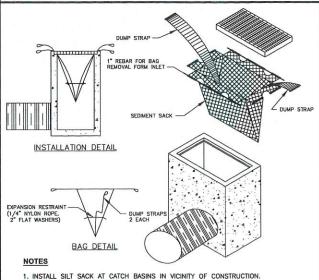

FILTREXX ® FILTER SOXX ™ PAVEMENT OPTION

1. FILTREXX FILTER SOXX MAY BE USED IN LIEU OF SILT FENCE.


- CONTRACTOR IS RESPONSIBLE TO BECOME FAMILIAR WITH THE FILTREXX PRODUCTS AND COORDINATE INSTALLATION SCHEDULES AND METHODS WITH THE ENGINEER PRIOR TO PLACEMENT.
- 3. ALL MATERIAL SHALL MEET FILTREXX SPECIFICATIONS.

NOTES

4. COMPOST MATERIAL SHALL NOT BE DISPERSED ON SITE AFTER CONSTRUCTION.

FILTREXX ® FILTER SOXX ™ DETAIL

NOT TO SCALE

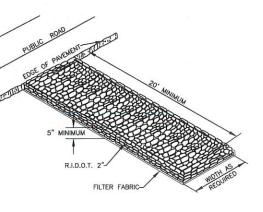

CONSTRUCTION ENTRANCE DETAIL

NOT TO SCALE

DUST CONTROL NOTES

ON AN AS-NEEDED BASIS OR AS DIRECTED BY THE CITY, RIDEM OR OWNER, THE CONTRACTOR SHALL UTILIZE ONE OF THE FOLLOWING METHODS TO CONTROL DUST:

A. THE EXPOSED SOIL SURFACE SHOULD BE MOISTENED PERIODICALLY WITH ADEQUATE WATER TO CONTROL DUST.

B. CALCIUM CHLORIDE SHOULD BE EITHER LOOSE DRY GRANULES OR FLAKES FINE ENOUGH TO FEED THROUGH A SPREADER AT A RATE THAT WILL KEEP SURFACE MOIST BUT NOT CAUSE POLLUTION OR PLANT DAMAGE.

THE METHODS SHOULD BE REPEATED AS NEEDED, AND SPECIAL ATTENTION MUST BE GIVEN TO THE ACCESS DRIVES.

INSPECTION/MAINTENANCE NOTES

- PRIOR TO COMMENCING PAVEMENT REMOVAL AND/OR EXCAVATION OPERATIONS AND EARTHWORK, EROSION CONTROLS SHALL BE PLACED INSIDE SAWCUT EDGE TO PREVENT SEDIMENT FROM ENTERING EXISTING ROADWAY DRAINAGE SYSTEM AND ABUTTING PROPERTIES.
- 2. EXTREME CARE SHALL BE EXERCISED SO AS TO PREVENT ANY UNSUITABLE MATERIAL FROM ENTERING THE DRAINAGE SYSTEM.
- 3. ALL DISTURBED AREAS WHICH BECOME SUBJECT TO EROSIVE TENDENCIES WHETHER THEY BE NEWLY FILLED OR EXCAVATED SHALL RECEIVE SLOPE PROTECTION SUCH AS RIP—RAP.
- DURING CONSTRUCTION, THE CONTRACTOR SHALL BE RESPONSIBLE FOR MAINTAINING DRAINAGE AND RUNOFF FLOW DURING PERIODS OF RAINFALL.
- 5. DURING CONSTRUCTION, THE CONTRACTOR SHALL BE RESPONSIBLE FOR ALL EROSION CONTROL MANITENANCE AND SHALL INSPECT / REPLACE DAILY DURING CONSTRUCTION, FOLLOWING RAINFALL AND WEEKLY DURING NON CONSTRUCTION PERIODS.
- ADDITIONAL FILTERSOXX OR SANDBAGS SHALL BE LOCATED AS CONDITIONS WARRANT OR AS DIRECTED BY THE ENGINEER.
- THE LATEST VERSION OF THE "RHODE ISLAND SOIL EROSION AND SEDIMENT CONTROL HANDBOOK" PREPARED BY THE R.I. STATE CONSERVATION COMMITTEE, MUST BE UTILIZED BY THE CONTRACTOR AS A GUIDE.
- B. THE CONTRACTOR IS RESPONSIBLE FOR ALL DUST CONTROL AND FOR THE ENTIRE PROJECT DURATION, INCLUDING TEMPORARY SHUT—DOWN PERIODS, MUST MONITOR AND REPAIR, AS NEEDED, ALL SLOPES TO ENSURE A STABLE PRODUCT.

GENERAL PROJECT WIDE NOTES

- CONTRACTOR SHALL INSTALL TEMPORARY MEASURES SUCH AS; FIBER MATTING, CRUSHED STONE, HAY OR STRAW IN AREAS WHERE SLOPES OR STABILIZATION HAS FAILED.
- IF SEDIMENT IS TRACKED OR ERODED INTO THE ROADWAY, THE CONTRACTOR WILL BE REQUIRED TO INSTALL SILT SACK OR APPROVED EQUAL UNDER THE EXISTING CATCH BASIN GRATES. REMOVE AFTER CONSTRUCTION.
- 3. FILTER SOXX (OR SILT FENCE) SHALL BE INSTALLED AROUND THE PERIMETER OF THE AREA TO BE DISTURBED BY CONSTRUCTION. ADDITIONAL APPLICATIONS OF THESE CONTROLS MEASURES MAY BE REQUIRED DURING THE CONSTRUCTION PROCESS. THE CONTRACTOR SHALL INSPECT THE SITE AT A MINIMUM OF ONCE PER WEEK OR WITHIN 24 HOURS AFTER A STORM EVENT.
- 4. IF EROSION OR EROSIVE TENDENCIES ARE APPARENT ON THE SITE, THE CONTRACTOR IS RESPONSIBLE TO INSTALL ADDITIONAL EROSION CONTROLS.
- 5. IF SEDIMENT OR DEBRIS IS TRACKED ONTO EXISTING PAVED AREAS ADJACENT TO THE CONSTRUCTION AREA, THE CONTRACTOR IS REQUIRED TO SWEEP THE PAVEMENT ON A DAILY BASIS. THE AREA SHALL BE INSPECTED DAILY.
- 6. THE CONTRACTOR IS RESPONSIBLE TO KEEP THE SITE CLEAN OF TRASH. RECOMMENDED DAILY PATROL OF THE CONSTRUCTION SHOULD BE CONDUCTED TO PICK-UP TRASH. THE OPERATOR SHALL REQUIRE THE CONTRACTOR TO HAVE PORTABLE SANITARY FACILITIES ON SITE. ROUTINE CLEANING AND WASTE DISPOSAL OF THESE PORTABLE SANITARY FACILITIES IS REQUIRED.

FILTREXX SOXX NOTE

CONTRACTOR IS RESPONSIBLE TO BECOME FAMILIAR WITH THE FILTREXX PRODUCTS AND COORDINATE INSTALLATION SCHEDULES AND METHODS WITH THE ENGINEER PRIOR TO PLACEMENT.

EROSION CONTROL AND SOIL STABILIZATION PROGRAM

- 1. EXTREME CARE SHALL BE EXERCISED SO AS TO PREVENT ANY UNSUITABLE MATERIAL FROM ENTERING THE DRAINAGE SYSTEM, ADJACENT PROPERTY AND ROADWAYS.
- TEMPORARY TREATMENTS SHALL CONSIST OF A HAY, STRAW, OR FIBER MULCH PROTECTIVE COVERS, SUCH AS A MAT OR FIBER LINING (BURLAP, JUTE, FIBERGIASS NETTING, EXCELSIOR BLANKETS). THEY SHALL BE INCORPORATED INTO THE WORK AS WARRANTED OR AS ORDERED BY THE OWNER.
- 3. HAY OR STRAW APPLICATIONS SHALL BE IN THE AMOUNT OF 3,000-4,000 LBS/ACRE
- 4. STOCKPILES SHALL HAVE NO SLOPE STEEPER THAN 2:1 AND SHALL BE SURROUNDED BY STAKED HAY BALES OR SILT FENCING.
- STOCKPILES EXPOSED FOR EXCESSIVE PERIODS SHALL RECEIVE TEMPORARY TREATMENT CONSISTING OF HAY, STRAW OR FIBER MATTING.
- DURING CONSTRUCTION, THE CONTRACTOR SHALL BE RESPONSIBLE FOR ALL EROSION CONTROL MAINTENANCE AND SHALL INSPECT/REPLACE AS NEEDED.
- 7. ADDITIONAL HAY BALES OR SANDBAGS SHALL BE LOCATED AS CONDITIONS WARRANT OR AS DIRECTED BY THE ENGINEER, OWNER, MUNICIPAL REPRESENTATIVES OR LOCAL D.O.T.
- 8. THE CONTRACTOR SHALL BE RESPONSIBLE FOR PROVIDING DUST CONTROL AT NO ADDITIONAL COST TO THE OWNER.
- 9. ALL CATCH BASINS ADJACENT TO THE CONSTRUCTION AREA SHALL BE PROTECTED BY SILT SACKS. ROUTINE CLEANING OF SEDIMENT WILL BE REQUIRED.
- ALL PROPOSED CATCH BASINS SHALL BE PROTECTED BY STAKED HAY BALES, SILT FENCING OR SILT SACKS.
- 11. THE FILTREXX FILTER SOXX MAY BE INSTALLED ON THE EXISTING PAVEMENT /IMPERVIOUS AREAS WITH OUT STAKES. CONTRACTOR SHALL INSPECT DAILY, IF SOIL EROSION OR SEDIMENT IS OBSERVED IN THESE AREAS, THE CONTRACTOR SHALL RELOCATE OR INSTALL ADDITIONAL FILTREXX FILTER SOXX IN LOCATIONS THAT CAN BE STAKED. THIS WORK IS INCLUDED IN THE PROJECT SCOPE.
- 12. SILT FENCE OR STAKED HAYBALES MAY BE USED IN LIEU OF FILTREXX FILTER SOXX. ENGINEER APPROVAL IS REQUIRED.
- 13. AN ALTERNATE COMPOST SOCK OR STRAW WATTLE PRODUCT MAY BE USED IN LIEU OF FILTREXX FILTER SOCK UPON APPROVAL OF THE ENGINEER.



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Centerville Road 103 Commonwest ick, RI 02886 North Attleboro, North Attl

mail: cei@crossmaneng.com

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KEY PLAN

PROJECT TITLE:

1292 WESTMINSTER STREET

PLAT MAP 32, LOT 233
ZONING DISTRICT C2
GENERAL COMMERCIAL
DISTRICT and HISTORIC
OVERLAY DISTRICT
1292 WESTMINSTER STREET
PROVIDENCE, RHODE ISLAND

PREPARED FOR



DRAWING TITLE:


SOIL EROSION and SEDIMENT CONTROL PLAN


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NUMBER REMARKS DATE

DRAWING NUMBER





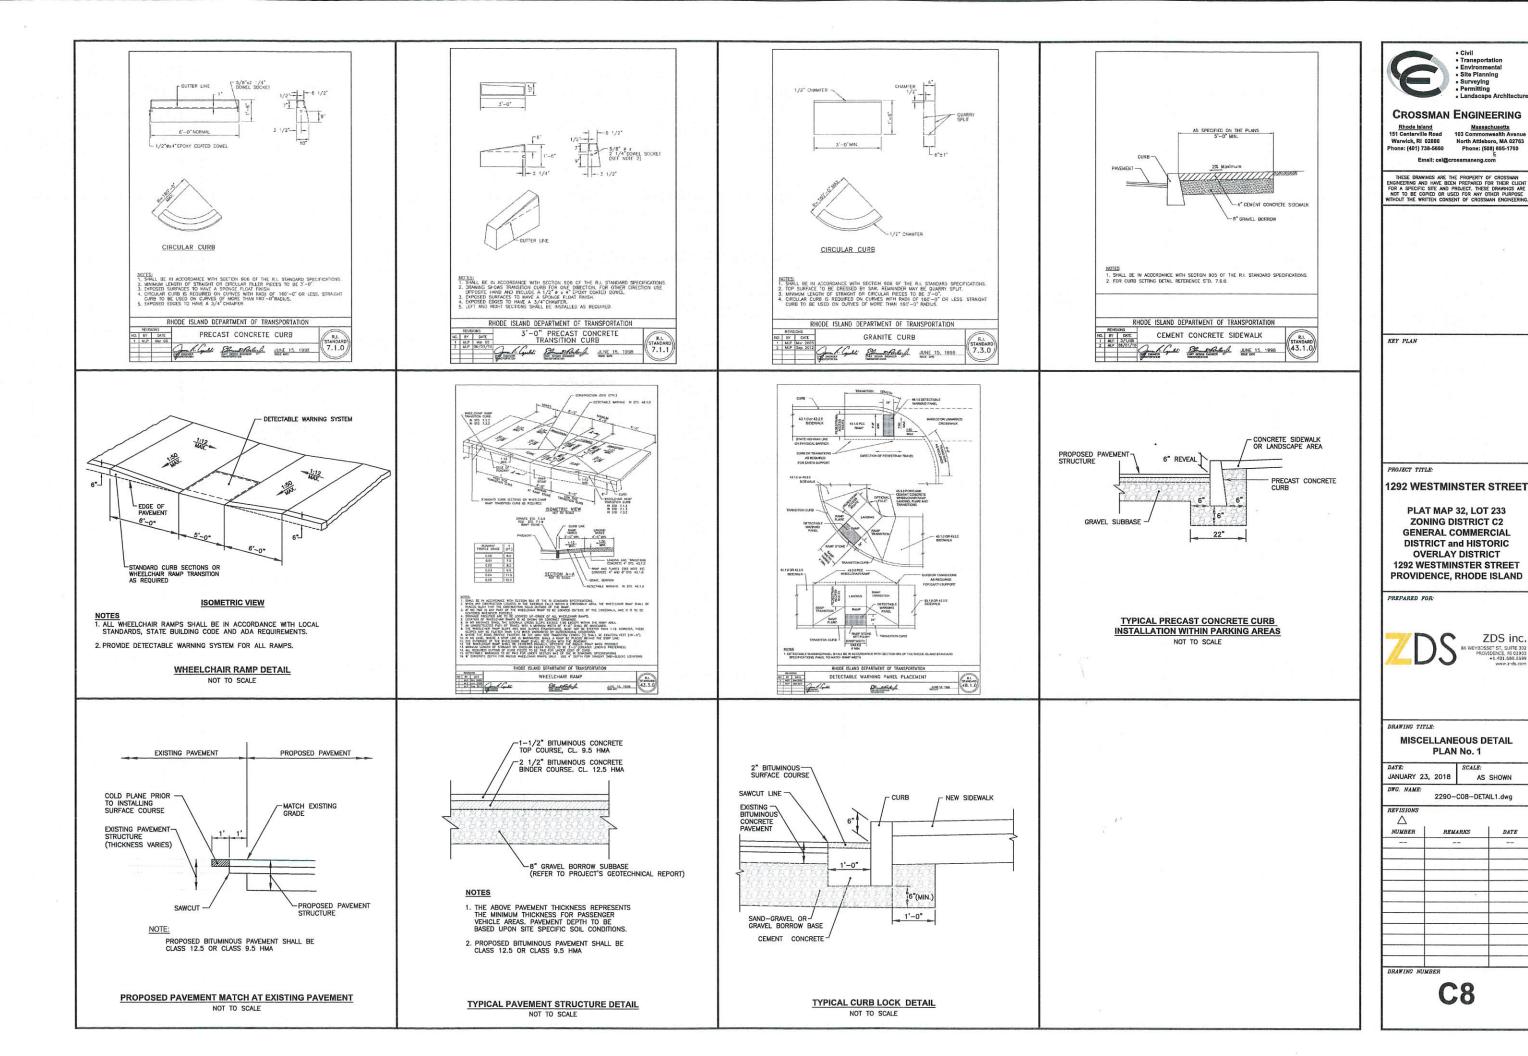

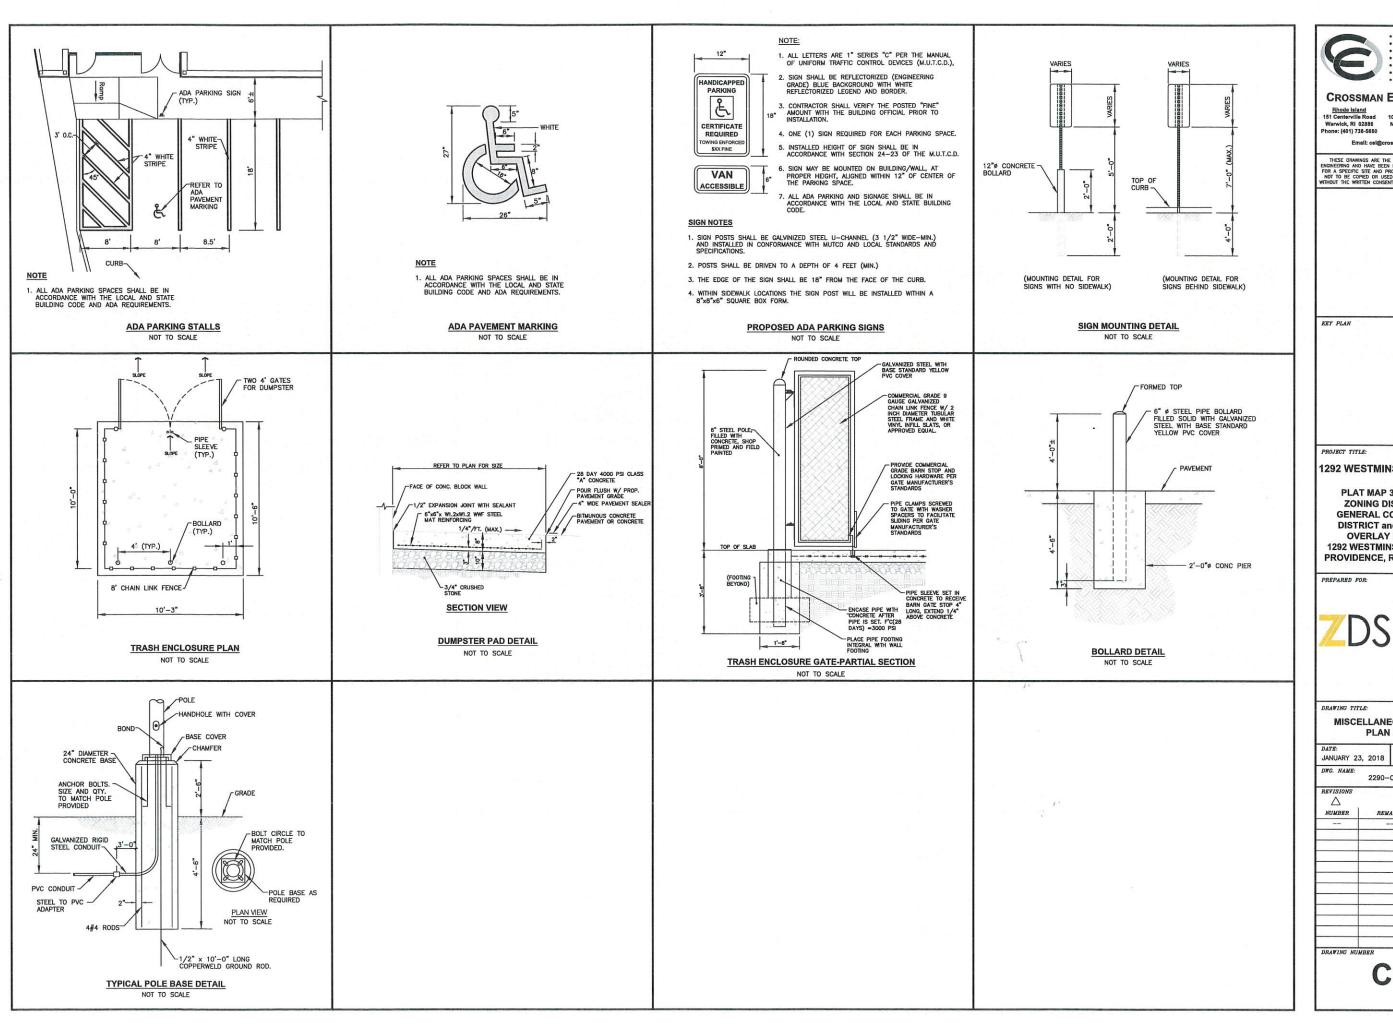CROSSMAN ENGINEERING

North Attleboro, MA 02763 Phone: (508) 695-1700

1292 WESTMINSTER STREET

PLAT MAP 32, LOT 233 ZONING DISTRICT C2 GENERAL COMMERCIAL DISTRICT and HISTORIC **OVERLAY DISTRICT** 1292 WESTMINSTER STREET PROVIDENCE, RHODE ISLAND




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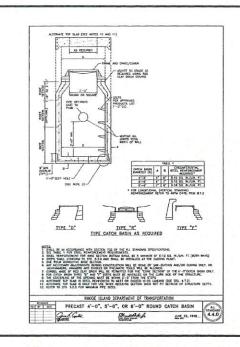
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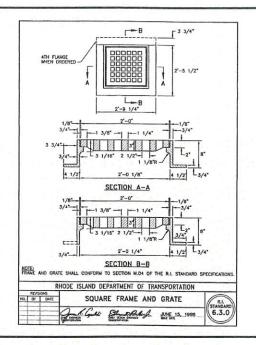
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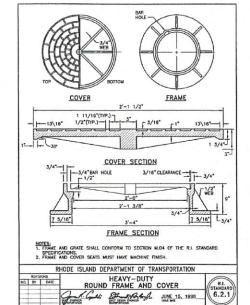
MISCELLANEOUS DETAIL PLAN No. 2


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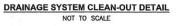










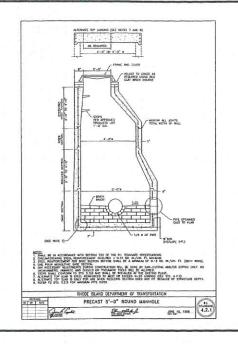

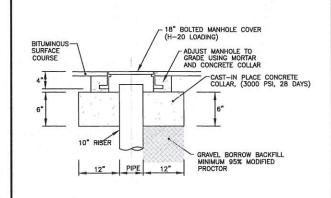

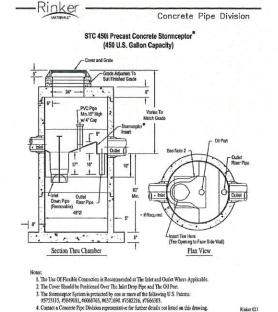

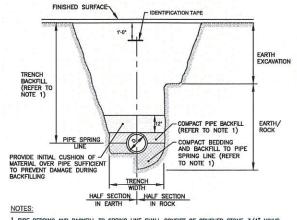

- PIPE BEDDING AND BACKFILL TO SPRING LINE SHALL CONSIST OF CRUSHED STONE—3/4* MINUS. PIPE BACKFILL SHALL CONSIST OF CRUSHED STONE (WRAPPED IN FILTER FABRIC) OR GRAVEL (3* MINUS, WITH SIEVE AMALYSIS APPROVED BY PENGINEER), OR OTHER APPROVED MATERIAL IEENCH BACKFILL SHALL CONSIST OF SUITABLE EXCAVATED MATERIAL OR OTHER APPROVED MATERIAL ALL BEDDING/BACKFILL TO BE COMPACTED TO 95% DRY DESSTY, MODIFIED PROCFOR METCHAL ALL BEDDING/BACKFILL TO BE COMPACTED TO 95% DRY DESSTY, MODIFIED PROCFOR METCHAL G/BACKFILL TO BE COMPACTED TO 95% DRY DENSITY, MODIFIED PROCTOR METHOD
- 2. ALL TRENCH EXCAVATION AND ANY SHEETING AND SHORING SHALL BE DONE IN ACCORDANCE WITH ALL STATE AND LOCAL CODES AND OSHA REGULATIONS.
- 3. MINIMUM TRENCH WIDTH SHALL BE OUTSIDE DIAMETER OF PIPE AT BELL PLUS 12".


 MAXIMUM TRENCH WIDTH SHALL BE OUTSIDE DIAMETER OF PIPE AT BELL PLUS 24"

DRAINAGE TRENCH DETAIL

6. THE CONTRACTOR MUST SUBMIT SHOP DRAWINGS FOR THE PIPES TO BE USED IN THE UNDERGROUND INFILTRATION SYSTEMS TO THE ENGINEER PRIOR TO CONSTRUCTION, THE SHOP DRAWINGS MUST VERIFY THAT THE PIPES CAN SUPPORT H-20 LOADING WITH THE SYSTEM SPECIFIC COVER.


INFILTRATION SYSTEM CONSTRUCTION NOTE

- . WITHIN THE INFILTRATION SYSTEMS, THE CONTRACTOR SHALL REMOVE ALL TOPSOIL AND SUBSOIL AREAS (A AND B HORIZONS) AND ANY FILL AREAS (HTM). CONTRACTOR SHALL COORDINATE A BOTTOM BED INSPECTION WITH OWNER AND ENGINEER. IF NECESSARY THE AREA SHALL BE PREPARED WITH SAND FILL SOIL MEETING THE MEDIA REQUIREMENTS OF SAND FILTERS, AS DESCRIBED IN THE RHODE ISLAND STORMWATER DESIGN AND INSTALLATION STANDARDS MANUAL MARCH 2015, SECTION 5.5 (ASTM C-33 SAND). THE DEPTH OF EXISTING SOIL REMOVAL SHALL BE VERIFIED BY THE ENGINEER. PLACEMENT OF THE SAND FILL (ASTM C-33 SAND), SHALL BE USED TO BRING THE BOTTOM OF SYSTEM TO THE DESIGN ELEVATIONS.
- 2. INFILTRATION SYSTEM CONSTRUCTION AND MATERIALS SHALL CONFORM TO RHODE ISLAND STORMWATER DESIGN AND INSTALLATION STANDARDS MANUAL, MARCH 2015, APPENDIX F.3 CONSTRUCTION STANDARDS/SPECIFICATIONS FOR INFILITRATION BMP'S. AFTER CONSTRUCTION, THE CONTRACTOR SHALL COORDINATE FINAL INSPECTIONS WITH THE OWNER IN ACCORDANCE WITH TABLE F-5 IN APPENDIX F.3.
- 3. THE CONTRACTOR IS REQUIRED TO SUBMIT A LIST OF MATERIALS, GRADATIONS AND THE NAME AND ADDRESS OF THE SUPPLIERS TO THE ENGINEER FOR APPROVAL PRIOR TO BRINGING MATERIAL ON SITE. MATERIAL CERTIFICATIONS SHALL ALSO BE REQUIRED FOR REVIEW AND APPROVAL.
- 4. THE CONTRACTOR IS RESPONSIBLE TO BECOME FAMILIAR WITH THE ABOVE REFERENCED MANUAL. THE MANUAL CAN BE FOUND AT: http://www.dem.ri.gov/pubs/regs/regs/water/swmanual.pdf
- 5. GREAT CARE MUST BE TAKEN TO PREVENT THE INFILTRATION AREA FROM COMPACTION; BY MARKING OFF THE INFILTRATION UNDERGROUND SYSTEM LOCATION BEFORE THE START OF CONSTRUCTION, AND BY CONNECTING UPSTREAM DRAINAGE AREAS ONLY AFTER CONSTRUCTION IS COMPLETE AND THE CONTRIBUTING AREA IS STABILIZED.
- 3. IF LARGE ROCKS OR BOULDERS ARE FOUND WITHIN 36" BELOW THE INFILTRATION SYSTEMS, OR WITHIN A 10' PERIMETER AROUND SYSTEM, THE CONTRACTOR SHALL REMOVE THE ROCKS/BOULDERS AND REPLACE WILL GRAVEL BORROW. CONTRACTOR SHALL COORDINATE WITH ENGINEER.

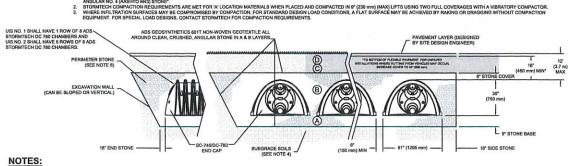

TONS ARE FOR GRADATIONS ONLY. THE STONE MUST ALSO BE CLEAN, CRUSHED, ANGULAR. FOR EXAMPLE, A SPECIFICATION FOR #4 STONE WOULD STATE: "CLEAN, CRUSHED,

- BERS SHALL CONFORM TO THE REQUIREMENTS OF ASTM F2418 "STANDARD SPECIFICATION FOR POLYPROPYLENE (PP) CORRUGATED WALL STOR
- 2. DC-760 CHAMBERS SHALL BE DESIGNED IN ACCORDANCE WITH ASTM F2767 "STANDARD PRACTICE FOR STRUCTURAL DESIGN OF THERMOPLASTIC CORRUGATED WALL STORMWATER COLLECTION CHAMBERS SHALL BE DESIGNED IN ACCORDANCE WITH ASTM F2767 "STANDARD PRACTICE FOR STRUCTURAL DESIGN OF THERMOPLASTIC CORRUGATED WALL STORMWATER COLLECTION CHAMBERS SHALL BE DESIGNED IN ACCORDANCE WITH ASTM F2767 "STANDARD PRACTICE FOR STRUCTURAL DESIGN OF THERMOPLASTIC CORRUGATED WALL STORMWATER COLLECTION CHAMBERS SHALL BE DESIGNED IN ACCORDANCE WITH ASTM F2767 "STANDARD PRACTICE FOR STRUCTURAL DESIGN OF THERMOPLASTIC CORRUGATED WALL STORMWATER COLLECTION CHAMBERS SHALL STORMWATER COLLECTION CHAMBERS SHALL BE DESIGNED IN ACCORDANCE WITH ASTM F2767 "STANDARD PRACTICE FOR STRUCTURAL DESIGN OF THERMOPLASTIC CORRUGATED WALL STORMWATER COLLECTION CHAMBERS SHALL BE DESIGNED FOR CHAMBERS SHALL BE DESIGNE
- 3. "ACCEPTABLE FILL MATERIALS" TABLE ABOVE PROVIDES MATERIAL LOCATIONS, DESCRIPTIONS, GRADATIONS, AND COMPACTION REQUIREMENTS FOR FOUNDATION, EMBEDMENT, AND FILL MATERIALS. 4. THE SITE DESIGN ENGINEER IS RESPONSIBLE FOR ASSESSING THE BEARING RESISTANCE (ALLOWABLE BEARING CAPACITY) OF THE SUBGRADE SOILS AND THE DEPTH OF FOUNDATION STONE WITH CONSIDERATION FOR THE RANGE OF EXPECTED SOIL MOISTURE CONDITIONS.
- 5. PERIMETER STONE MUST BE EXTENDED HORIZONTALLY TO THE EXCAVATION WALL FOR BOTH VERTICAL AND SLOPED EXCAVATION WALLS.
- 6. ONCE LAYER C' IS PLACED, ANY SOILMATERIAL CAN BE PLACED IN LAYER O' UP TO THE FINISHED GRADE. MOST PAVEMENT SUBBASE SOILS CAN BE USED TO REPLACE THE MATERIAL REQUIREMENTS OF LAYER C' OR D' AT THE SITE DESIGN ENGINEERS DISCRETION

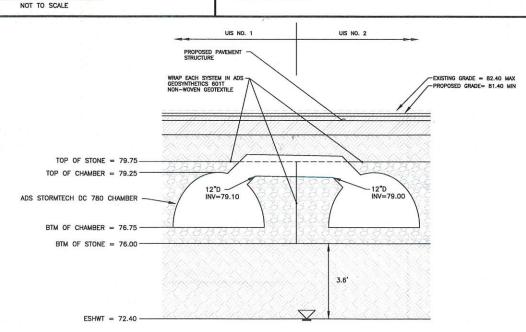

DRAWING TITLE:

MISCELLANEOUS DETAIL PLAN No. 3

CROSSMAN ENGINEERING

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KEY PLAN

PROJECT TITLE:

PREPARED FOR

1292 WESTMINSTER STREET

PLAT MAP 32, LOT 233

ZONING DISTRICT C2 GENERAL COMMERCIAL DISTRICT and HISTORIC OVERLAY DISTRICT

1292 WESTMINSTER STREET

PROVIDENCE, RHODE ISLAND

ZDS inc

North Attleboro, MA 0276: Phone: (508) 695-1700

JANUARY 23, 2018 AS SHOWN


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C10

UNDERGROUND INFILTRATION SYSTEM DETAILS

NOT TO SCALE



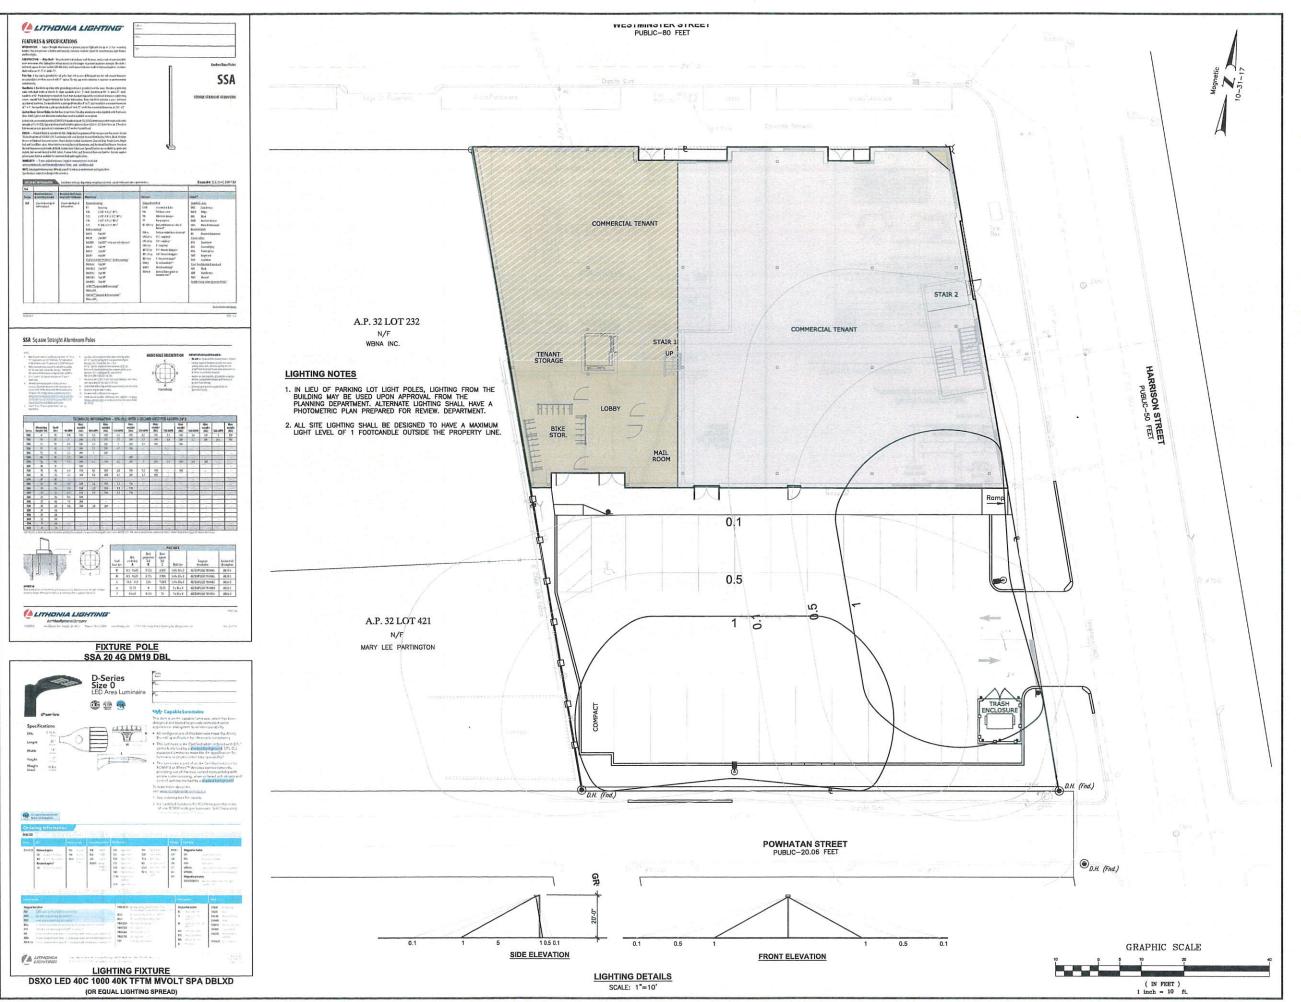

Transportation
Environmental
Site Planning
Surveying
Permitting

CROSSMAN ENGINEERING

Rhode Island Massach
151 Centerville Road 103 Commonw
Warwick, RI 02886 North Attlebore
Phone: (401) 738-5660 Phone: (508)

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KEY PLAN

PROJECT TITLE

1292 WESTMINSTER STREET

PLAT MAP 32, LOT 233
ZONING DISTRICT C2
GENERAL COMMERCIAL
DISTRICT and HISTORIC
OVERLAY DISTRICT
1292 WESTMINSTER STREET
PROVIDENCE, RHODE ISLAND

PREPARED FOR



ZDS inc

DRAWING TITLE:

SITE LIGHTING PLAN

JANUARY 23, 2018 1"=10'


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2290-E01-LIGHT.dwg

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NUMBER REMARKS DATE

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Civil
 Transportation
 Environmental

Surveying
 Permitting
 Landscape Architects

CROSSMAN ENGINEERING

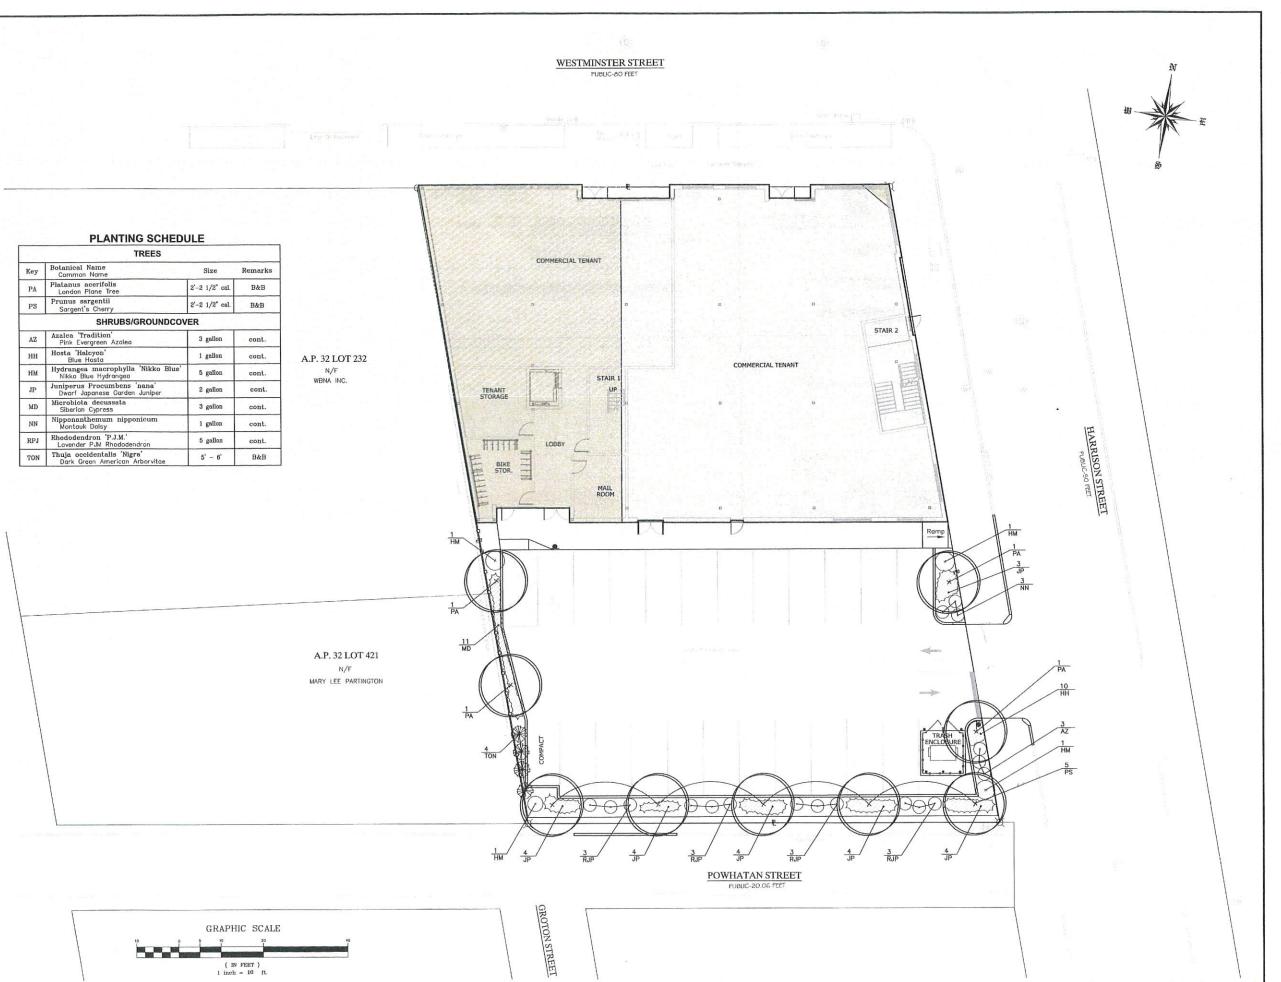Rhode Island 151 Centerville R Warwick, RI 02 Phone: (401) 738-

lle Road 103 C 1 02886 North 738-5660 Ph

mall: cel@crossmaneng.com

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KEY PLAN

PROJECT TITLE:

1292 WESTMINSTER STREET

PLAT MAP 32, LOT 233
ZONING DISTRICT C2
GENERAL COMMERCIAL
DISTRICT and HISTORIC
OVERLAY DISTRICT
1292 WESTMINSTER STREET
PROVIDENCE, RHODE ISLAND

PREPARED FOR:



VEYBOSSET ST, SUITE 30 PROVIDENCE, RI 0290 +1 401 690 669

DRAWING TITLE:

LANDSCAPE PLAN

DATE: SCALE:

JANUARY 2018 1"=10'

DWG. NAME:

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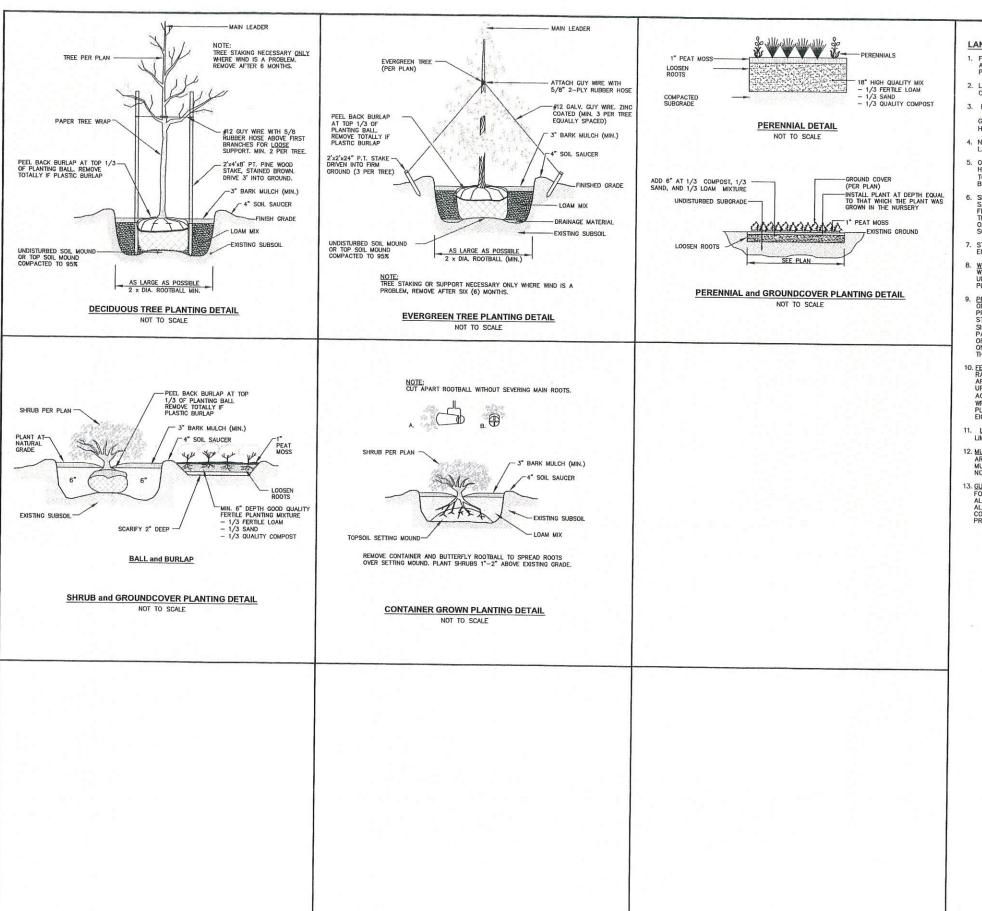
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LANDSCAPE CONSTRUCTION NOTES

- FURNISH AND INSTALL ALL PLANTS SHOWN ON THE DRAWINGS SPECIFIED HEREIN, AND IN THE QUANTITIES LISTED ON THE PLANT LIST. NO SUBSTITUTIONS WILL BE PERMITTED, UNLESS APPROVED BY THE LANDSCAPE ARCHITECT.
- LOAM TO BE SCREENED, GOOD QUALITY, FERTILE, FREE OF WEEDS, STICKS, STONES OVER 3/4", AND ROOTS. SPREAD TO A MINIMUM OF 6" OVER ALL PLANTED AREAS.
- 3. BIO-DETENTION AREAS-PLANTING SOIL AND MULCH:
 LOAMY SAND TO A SANDY LOAM-BO% SAND <20% SILT, <2% CLAY. WELL AGED
 GRADED COMPOST (25% OF SOIL MIX). WELL AGED, AERATED DARK BROWN
 HARD-WOOD MULCH (AGED 6 MONTHS).
- NURSERY STOCK SHALL MEET THE STANDARDS OF THE AMERICAN NURSERY AND LANDSCAPE ASSOCIATION AS TO GRADING AND QUALITY.
- 5. ONLY NURSERY-GROWN PLANTS, GROWN IN ACCORDANCE WITH ACCEPTED HORTICULTURAL PRACTICES, AND GROWN UNDER CLIMATIC CONDITIONS SIMILAR TO TO THOSE IN THE LOCALITY OF THE PROJECT FOR AT LEAST TWO (2) YEARS, WILL BE ACCEPTED.
- 6. SET PLANTS PLUMB AND AT A LEVEL THAT AFTER SETTLEMENT THEY BEAR THE SAME RELATION TO THE SURROUNDING GROUND AS THEY BORE TO THE GROUND FROM WHICH THEY WERE DUG. SETTLE BACKFILL MATERIAL FOR PLANTS, THOROUGHLY AND PROPERLY BY FIRMING OR TAMPING. FORM SAUCERS, CAPABLE OF HOLDING WATER ABOUT INDIVIDUAL PLANTS, BY PLACING RIDGES OF PLANTING SOIL AROUND EACH.
- STAKE ALL TREES OVER 5 FEET AS SHOWN ON PLANS. REMOVE STAKES AT THE END OF THE GUARANTEE PERIOD.
- 8. <u>WAITERING</u>; WATER ALL PLANTS WITHIN 48 HOURS AFTER PLANTING, IF CONDITIONS WARRANT, AND AS MANY TIMES THEREAFTER TO SUSTAIN HEALTHY CONDITIONS UNTIL LANDSCAPE INSTALLATION IS COMPLETED. SATURATE THE SOIL AROUND EACH PLANT THOROUGHLY AT EACH WATERING.
- 9. PRUNING: PRUNE PLANTS, AS DIRECTED BY OWNER, AT THE PROJECT SITE BEFORE OR IMMEDIATELY AFTER PLANTING IN ACCORDANCE WITH THE BEST HORTICULTURAL PRACTICE. CUT BROKEN, DEAD OR INJURED BRANCHES IMMEDIATELY ABOVE THE STEM COLLAR ON THE TRUNK OR LIMB. PRUNE ALL BROKEN ROOTS ON THE PLANT SIDE OF THE BREAK. PAINT CUTS OVER 3/4" IN DIAMETER WITH TREE WOUND PAINT. PRUNING SHALL NOT DEFORM OR OTHERWISE DESTROY THE TYPICAL SHAPE OR SYMMETRY OF THE PLANT, AND SHALL NOT REDUCE THE HEIGHT BY MORE THAN ONE—THIRD. DO NOT CUT BACK THE LEADER OF THE PLANT UNLESS DIRECTED BY THE LANDSCAPE ARCHITECT.
- 10. EERTILIZING: FERTILIZE SHRUB BEDS WITH 10-6-4 FERTILIZER BROADCAST AT A RATE OF THREE POUNDS PER 100 SQUARE FEET OF SURFACE AREA BROADCAST. APPLY THE FERTILIZER UNIFORMENT TO THE SURFACE BEDS AND WORK INTO THE UPPER TWO INCHES OF SOIL. FERTILIZE INDIMIDUAL TREES AT A FEET OF ONE AGRIFORM PELLET PER INCH OF TRUNK DIAMETER (FOLLOW MANUFACTURER'S WRITTEN INSTRUCTIONS). APPLY A SECOND APPLICATION OF FERTILIZER TO ALL PLANT ITEMS AT THE SAME SPECIFIED RATES OVER THE MULCH AT THE END OF AN EIGHT WEEK PERIOD.
- LIMING: ADD POWDERED LIME EVERY SIX MONTHS OR SLOW RELEASE GRANULAR LIME—AS PER MANUFACTURER'S INSTRUCTION.
- 12. MULCHING: WITHIN A 72 HOUR PERIOD AFTER PLANTING, COVER ALL PLANTED AREAS WITH 3" DARK HEMLOCK MULCH. NO RED OR DYED MULCH IS TO BE USED. MULCH SHOULD BE PULLED ONE INCH AWAY FROM PLANT TRUNK OR STEM, AND NOT ALLOWED TO REST DIRECTLY AGAINST THE TRUNK OR STEM.
- 13. GUARANTEE: ALL PLANTS FURNISHED BY THE CONTRACTOR SHALL BE GUARANTEED FOR A PERIOD OF ONE (1) YEAR AFTER PRELIMINARY INSPECTION AND SHALL BE ALIVE AND IN SATISFACTORY GROWTH AT THE END OF THE GUARANTEE PERIOD. ALL DEAD OR DYING PLANT MATERIAL SHALL BE REPLACED AT ONCE BY THE CONTRACTOR, FREE OF CHARGE. CONTRACTOR SHALL PROVIDE WRITTEN GUARANTEE PRIOR TO CONSTRUCTION COMPETETION.



Transportation
Environmental
Site Planning
Surveying
Permitting

CROSSMAN ENGINEERING

Rhode Island 151 Centerville Road Warwick, RJ 02886 Phone: (401) 738-5660

nterville Road 103 Commonwealth Avenulick, RI 02886 North Attleboro AA 02763 (401) 738-5660 Phone: (508) 695-1700 Emall: cei@crossmaneng.com

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KEY PLAN

PROJECT TITLE

1292 WESTMINSTER STREET

PLAT MAP 32, LOT 233
ZONING DISTRICT C2
GENERAL COMMERCIAL
DISTRICT and HISTORIC
OVERLAY DISTRICT
1292 WESTMINSTER STREET
PROVIDENCE, RHODE ISLAND

PREPARED FOR:



ZDS inc. BOSSET 51, SUITE 302 PROVIDENCE, RI 02903 +1.401.580.6699


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LANDSCAPE DETAIL PLAN

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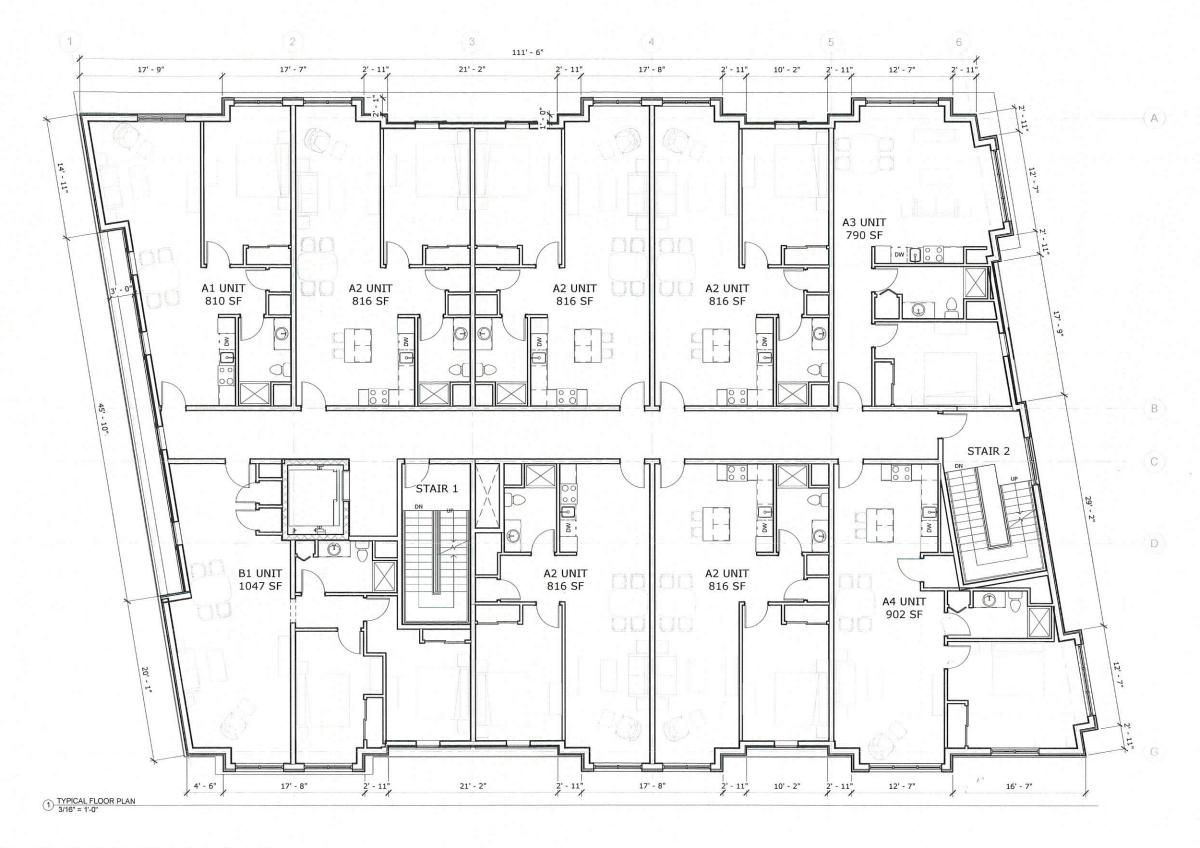
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FOUTH FLOOR PLAN

1292 WESTMINSTER ST



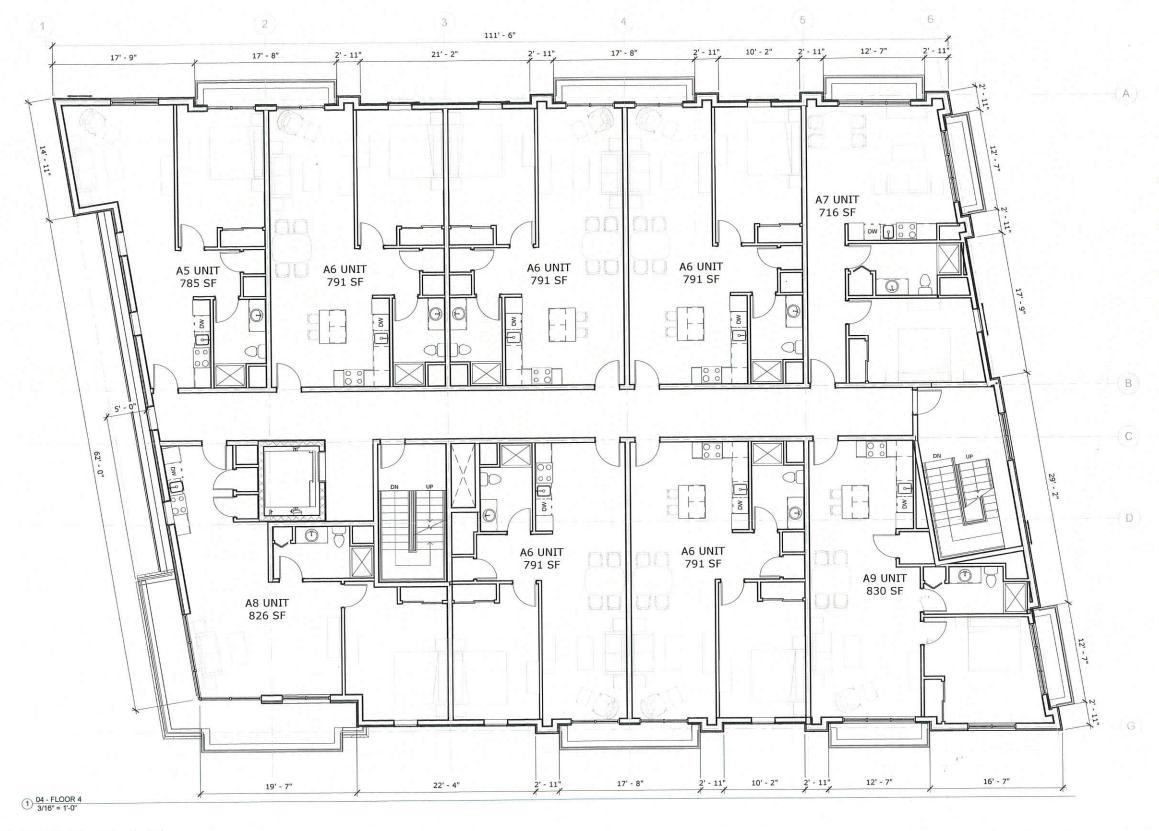


TYPICAL FLOOR PLAN (2-3)

1292 WESTMINSTER ST






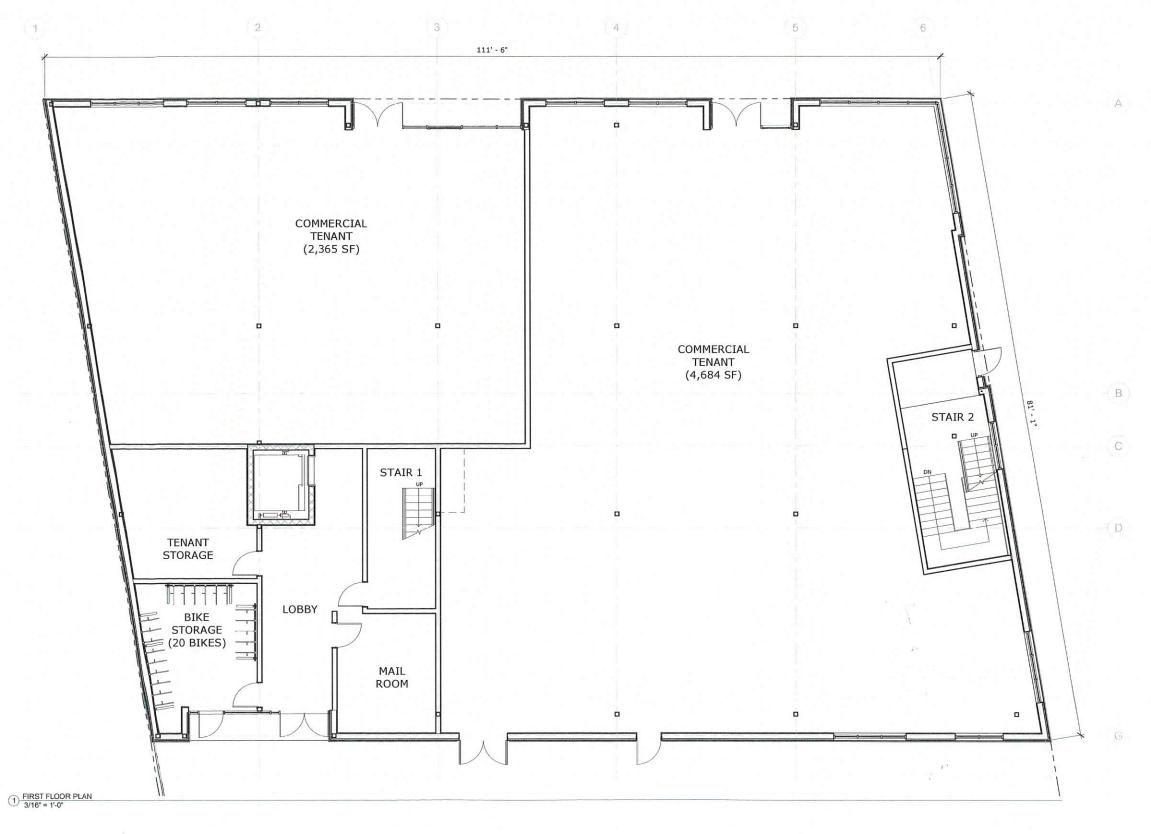

FIRST FLOOR PLAN

1292 WESTMINSTER ST



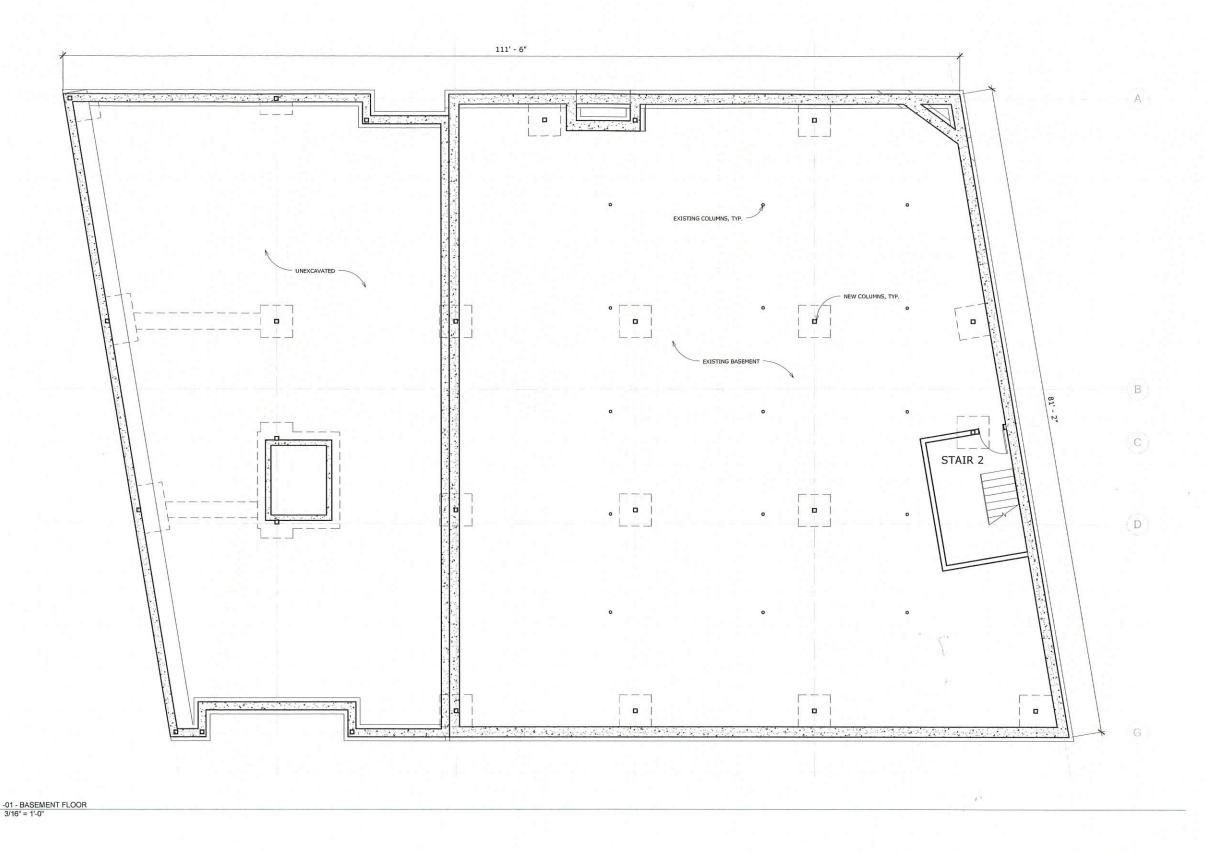

BASEMENT/FOUNDATION PLAN

1292 WESTMINSTER ST

