



3. CASE 21.123, 65 HALSEY STREET, House, post 1957 (COLLEGE HILL)

Contemporary; 1; flat; vertical sheathing; L plan with garage under; bands of windows; entrance in arms of L under cantilevered overhang.

NON-CONTRIBUTING to College Hill National Historic Landmarks District

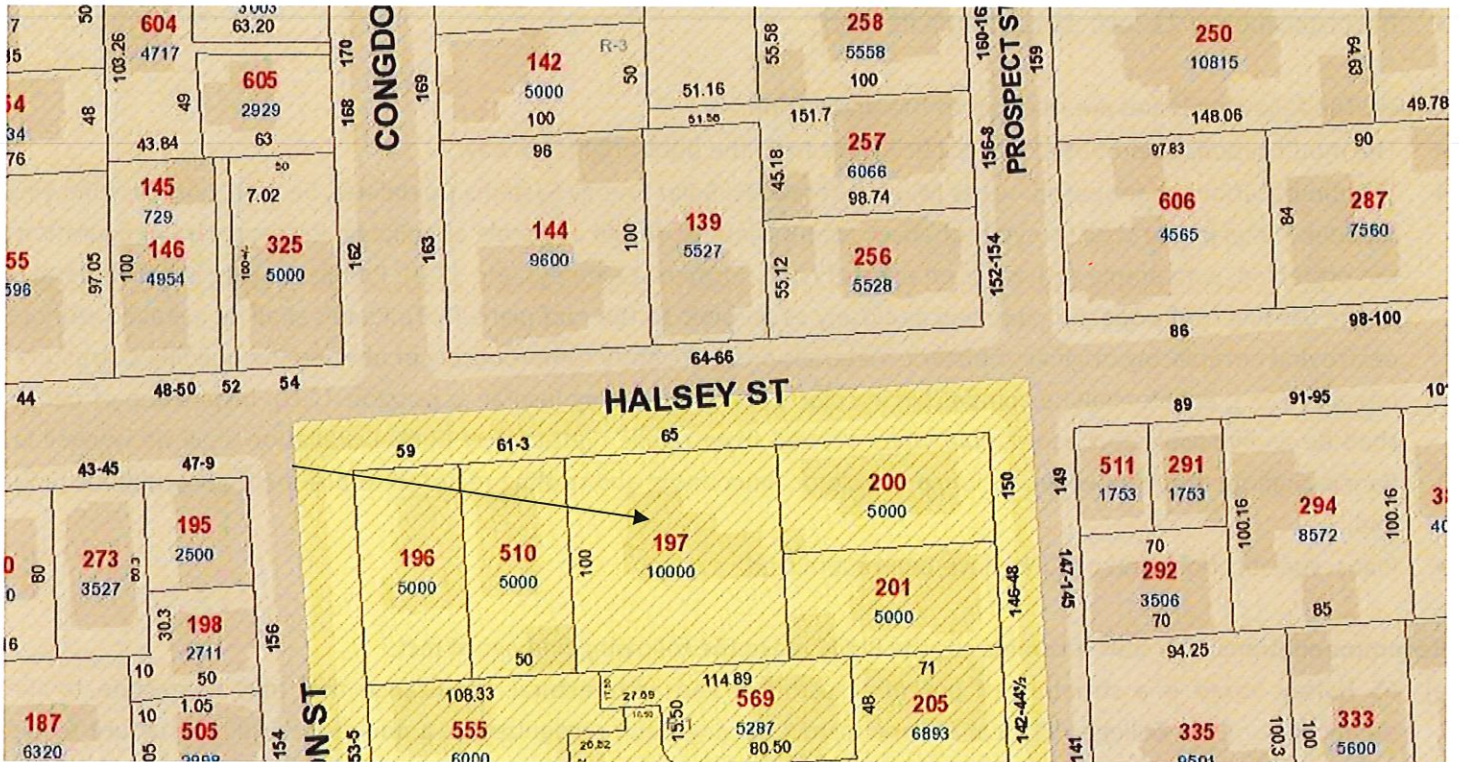

Arrow indicates 65 Halsey Street

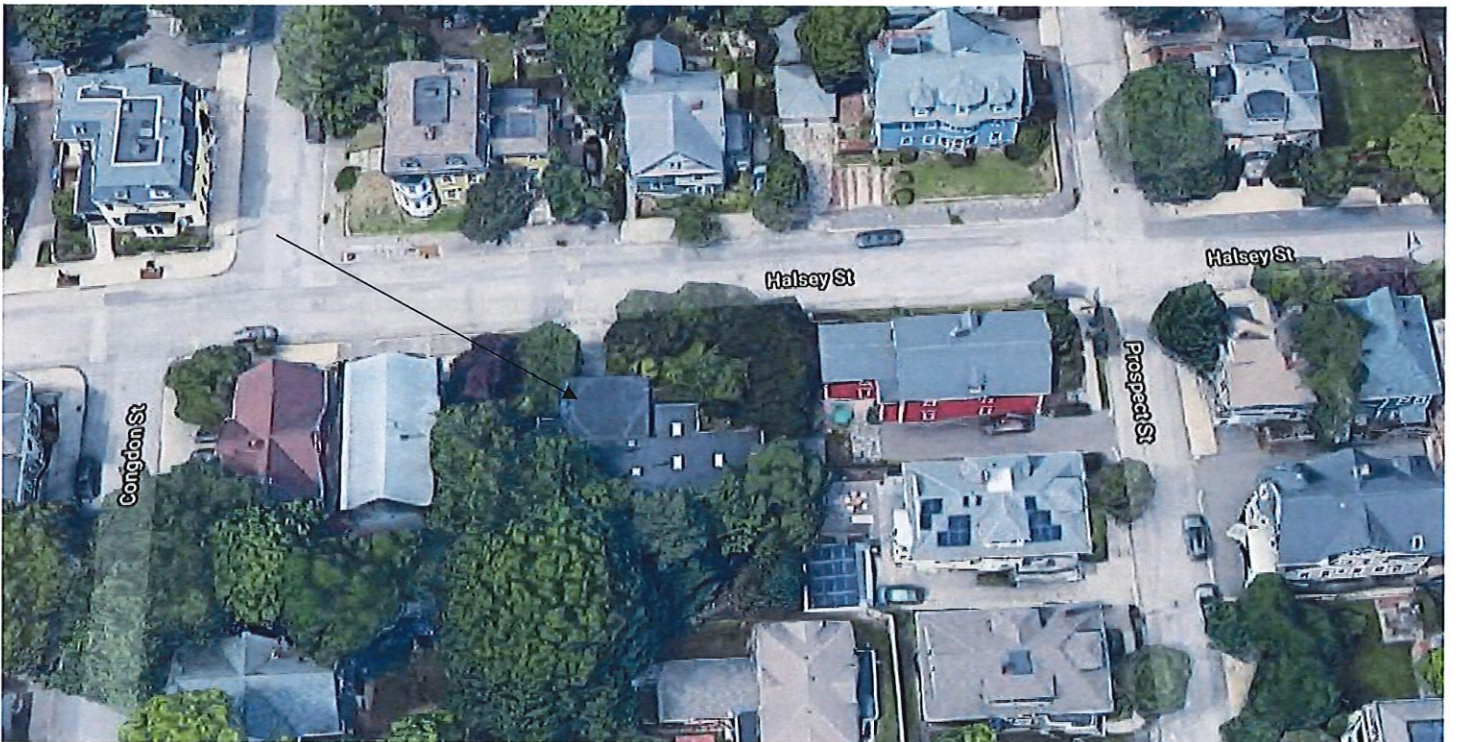

Arrow indicates project location, looking north.

OWNER DETAIL

NAME : **PAULA MARTIESIAN**
 MUNICIPALITY : PROVIDENCE, RI

CONTRACTOR DETAILS

NAME : **GOTSUN GOSOLAR**
 PHONE : 774-229-2986

DESIGN SPECIFICATIONS

OCCUPANCY : II
 CONSTRUCTION : SINGLE FAMILY DWELLING
 ZONING : RESIDENTIAL

APPLICABLE CODES & STANDARDS

BUILDING : IBC 2015
 ELECTRICAL : NEC 2020

ROOF MOUNT PV SYSTEM
9.085 KW DC / 6.67 KW AC
PAULA MARTIESIAN
65 HALSEY ST
PROVIDENCE, RI 02906

SHEET LIST TABLE

SHEET NUMBER	SHEET TITLE
G-1	COVER PAGE
G-2	NOTES
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A-2	PROJECT PLAN
E-1	COMPONENTS INFORMATION
E-2	THREE LINE DIAGRAM
S-1	RACKING
S-2	LABELLING
D-1	MODULE DATASHEET
D-2	INVERTER DATASHEET
D-3	RACKING DATASHEET
D-4	RACKING MOUNT DATASHEET



GOTSUN GOSOLAR

1547 FALL RIVER AVE

SUITE #1

SEEKONK, MA 02771

PHONE: 774-229-2986

MA REG# CS-091168


MA HIC# 180717

RI REG# 3973


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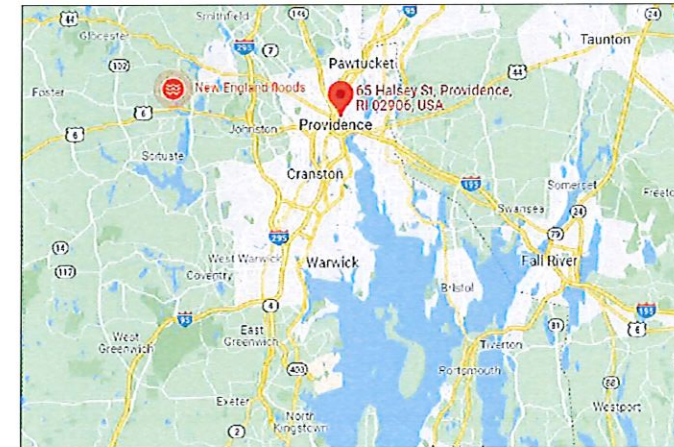
G1 3D MODEL
 01 NTS




G1 IRRADIANCE MAP
 02 NTS

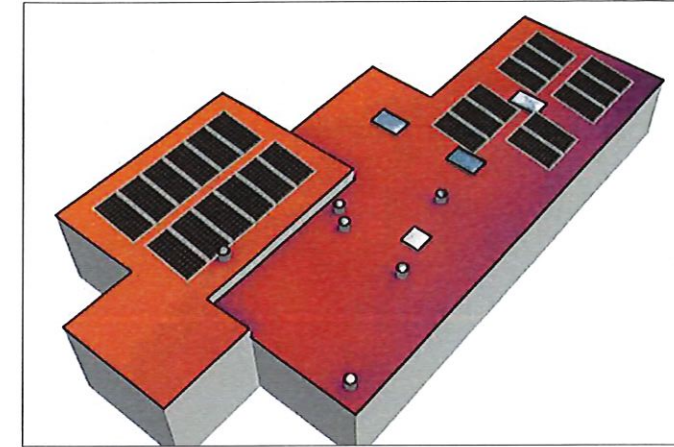

G1 LOCAL MAP
 03 NTS

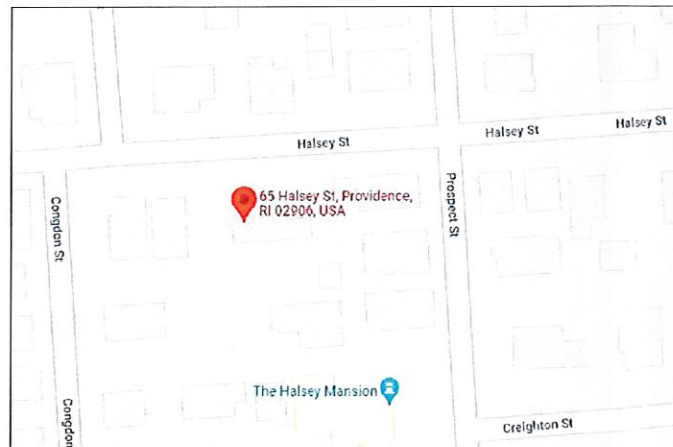

G1 REGIONAL MAP
 04 NTS

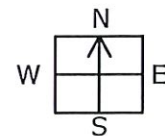

PROJECT NOTES

1.1.2 THIS PHOTOVOLTAIC (PV) SYSTEM SHALL COMPLY WITH THE NATIONAL ELECTRIC CODE (NEC) ARTICLE, ALL MANUFACTURER'S LISTING AND INSTALLATION INSTRUCTIONS, AND THE RELEVANT CODES AS SPECIFIED BY THE AUTHORITY HAVING JURISDICTION'S (AHJ) APPLICABLE CODES.

1.1.3 THE UTILITY INTERCONNECTION APPLICATION MUST BE APPROVED AND PV SYSTEM INSPECTED PRIOR TO PARALLEL OPERATION

1.1.4 GROUND FAULT DETECTION AND INTERRUPTION (GFDI) DEVICE IS INTEGRATED WITH THE MICROINVERTER IN ACCORDANCE WITH NEC 690.5(A)

1.1.5 ALL PV SYSTEM COMPONENTS; MODULES, UTILITY-INTERACTIVE INVERTERS, AND SOURCE CIRCUIT COMBINER BOXES ARE IDENTIFIED AND LISTED FOR USE IN PHOTOVOLTAIC SYSTEMS AS REQUIRED BY NEC 690.4 & NEC 690.60:

PV MODULES: UL1703, IEC61730, AND IEC61215, AND NFPA 70 CLASS C FIRE INVERTERS: UL 1741 CERTIFIED, IEEE 1547, 929, 519

COMBINER BOXES: UL 1703 OR UL 1741 ACCESSORY

1.1.6 MAX DC VOLTAGE CALCULATED USING MANUFACTURER PROVIDED TEMP COEFFICIENT FOR VOC. IF UNAVAILABLE, MAX DC VOLTAGE CALCULATED ACCORDING TO NEC 690.7.

1.1.7 ALL INVERTERS, PHOTOVOLTAIC MODULES, PHOTOVOLTAIC PANELS, AND SOURCE CIRCUIT COMBINERS INTENDED FOR USE IN A PHOTOVOLTAIC POWER SYSTEM WILL BE IDENTIFIED AND

LISTED FOR THE APPLICATION PER 690.4 (D). SHALL BE INSTALLED ACCORDING TO ANY INSTRUCTIONS FROM LISTING OR LABELING [NEC 110.3].

1.1.8 ALL SIGNAGE TO BE PLACED IN ACCORDANCE WITH LOCAL BUILDING CODE. IF EXPOSED TO SUNLIGHT, IT SHALL BE UV RESISTANT. ALL PLAQUES AND SIGNAGE WILL BE INSTALLED AS REQUIRED BY THE NEC AND AHJ.

1.2.1 SCOPE OF WORK

PRIME CONTRACTOR IS RESPONSIBLE FOR THE DESIGN AND SPECIFICATIONS OF THE GRID-TIED PHOTOVOLTAIC SYSTEM RETROFIT. PRIME CONTRACTOR WILL BE RESPONSIBLE FOR COLLECTING EXISTING ON-SITE REQUIREMENTS TO DESIGN, SPECIFY, AND INSTALL THE EXTERIOR ROOF-MOUNTED PORTION OF THE PHOTOVOLTAIC SYSTEMS DETAILED IN THIS DOCUMENT.

1.2.2 WORK INCLUDES:

1.2.3 PV ROOF ATTACHMENTS

1.2.4 PV RACKING SYSTEM INSTALLATION

1.2.5 PV MODULE AND INVERTER INSTALLATION

1.2.6 PV EQUIPMENT GROUNDING

1.2.7 PV SYSTEM WIRING TO A ROOF-MOUNTED JUNCTION BOX

1.2.8 PV LOAD CENTERS (IF INCLUDED)

1.2.9 PV METERING/MONITORING (IF INCLUDED)

1.2.10 PV DISCONNECTS

1.2.11 PV GROUNDING ELECTRODE & BONDING TO (E) GEC

1.2.12 PV FINAL COMMISSIONING

1.2.13 (E) ELECTRICAL EQUIPMENT RETROFIT FOR PV

1.2.14 SIGNAGE PLACED IN ACCORDANCE WITH LOCAL BUILDING CODE

COVER PAGE

DATE: 09.05.2021

DESIGNED BY: YO

CHECKED BY: RB

REVISIONS

REV1

G-1

GOTSUN GOSOLAR

1547 FALL RIVER AVE

SUITE #1

SEEKONK, MA 02771


PHONE: 774-229-2986

MA REG# CS-091168

MA HIC# 180717

RI REG# 3973

ROOF MOUNT PV SYSTEM
9.085 KW DC / 6.67 KW AC
PAULA MARTIESIAN
65 HALSEY ST
PROVIDENCE, RI 02906

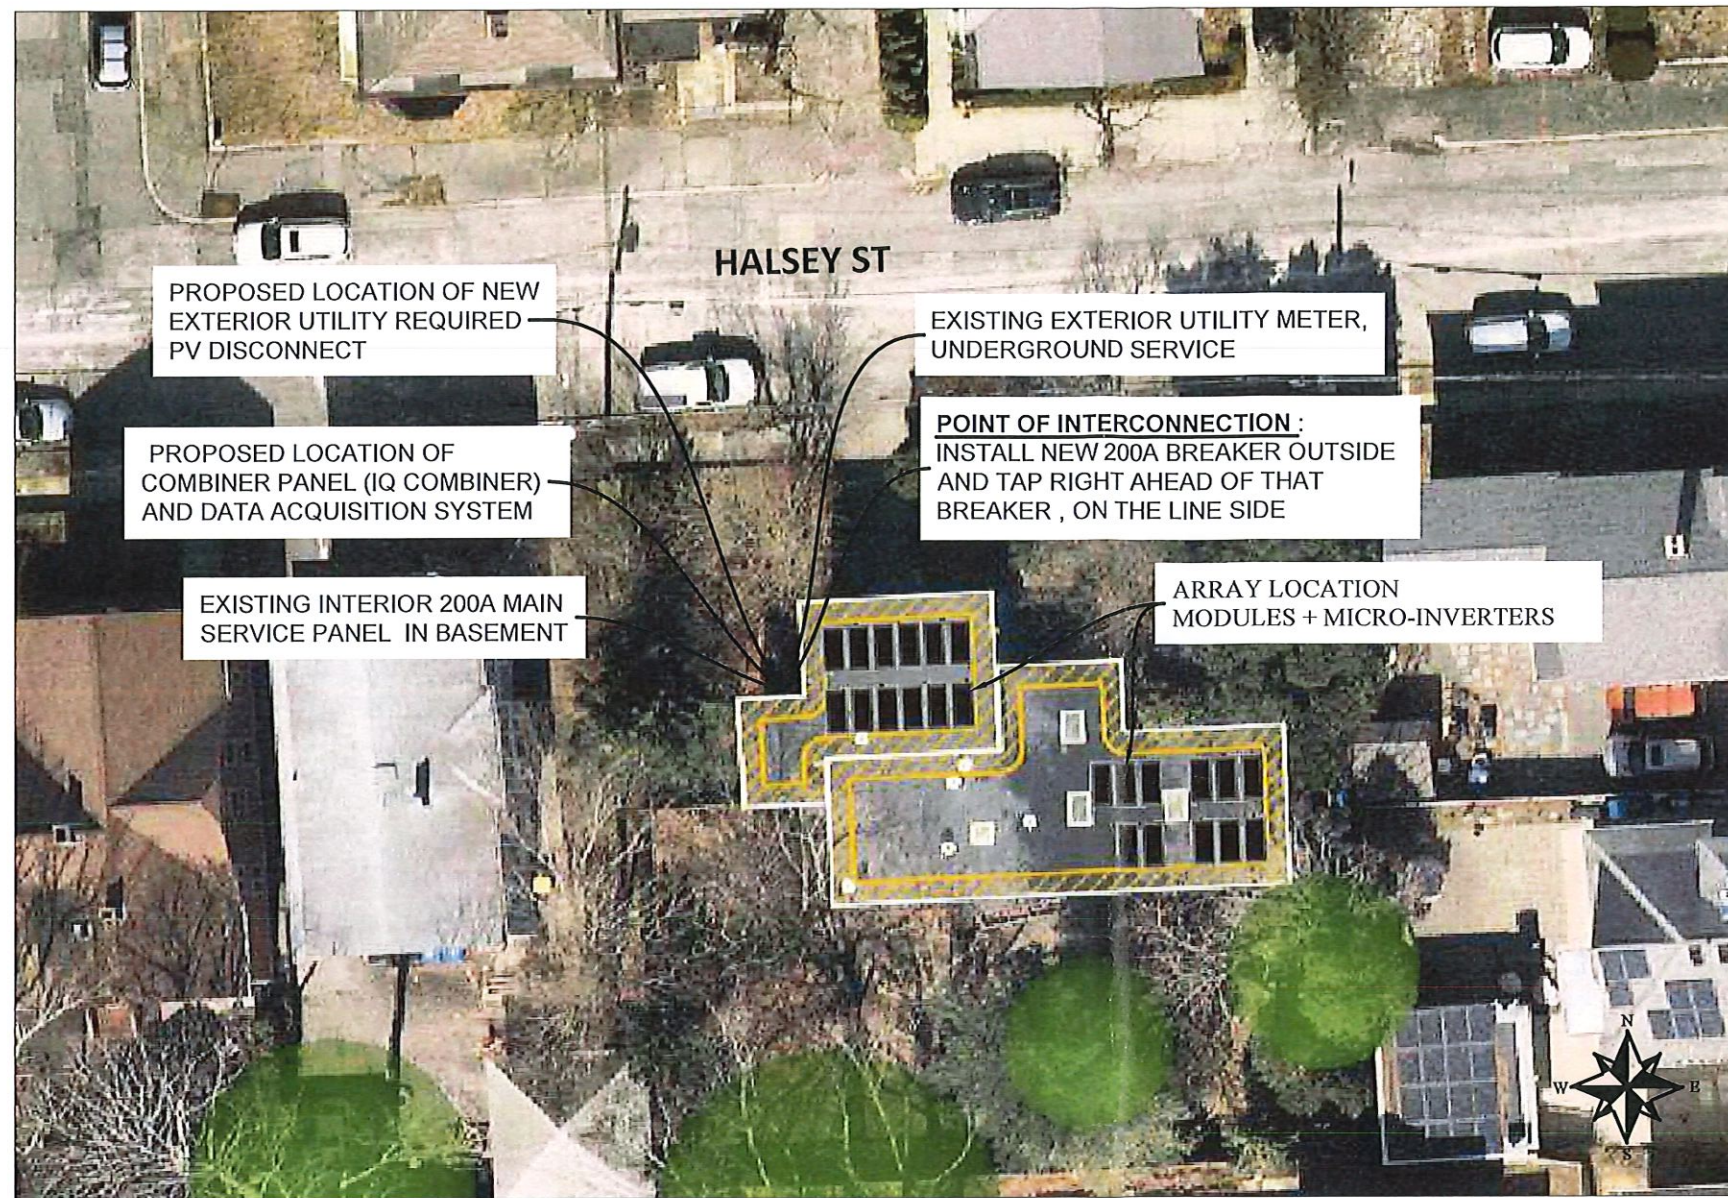

LOCATION INFO	
LOCATION	PROVIDENCE, RI 02906 USA
LATITUDE	41.834038° N
LONGITUDE	-71.407175° W
ELEVATION	247 m
DESIGN LOW TEMP	-4° F (-20° C)
DESIGN HIGH TEMP	89.6° F (32° C)

ELECTRICAL CHARACTERISTICS	
MICRO-INVERTERS	(23) ENPHASE IQ 7+
MODULES	(23) LG395N2K-A5 395W
NUMBER OF MODULES	(14)
ARRAY CIRCUITS	2 BRANCHES : 11/12
STC POWER OF ARRAY	9.085 KW
MAX AC OUTPUT CURRENT	27.83 A

SITE PLAN

DATE: 09.05.2021


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A-1



ARRAY :
 23 x 395W MODULES
 ROOF TILT : 0°
 RACKING TILT : 8°
 AZIMUTH : 177°
 RACKING INTER-ROW SPACING : 33"/34"



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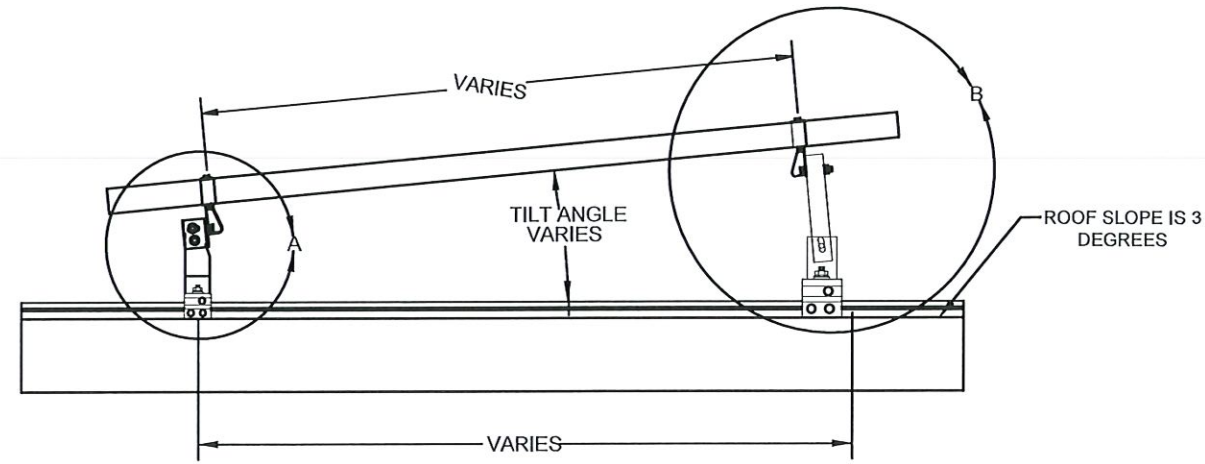
ROOF MOUNT PV SYSTEM
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 65 HALSEY ST
 PROVIDENCE, RI 02906

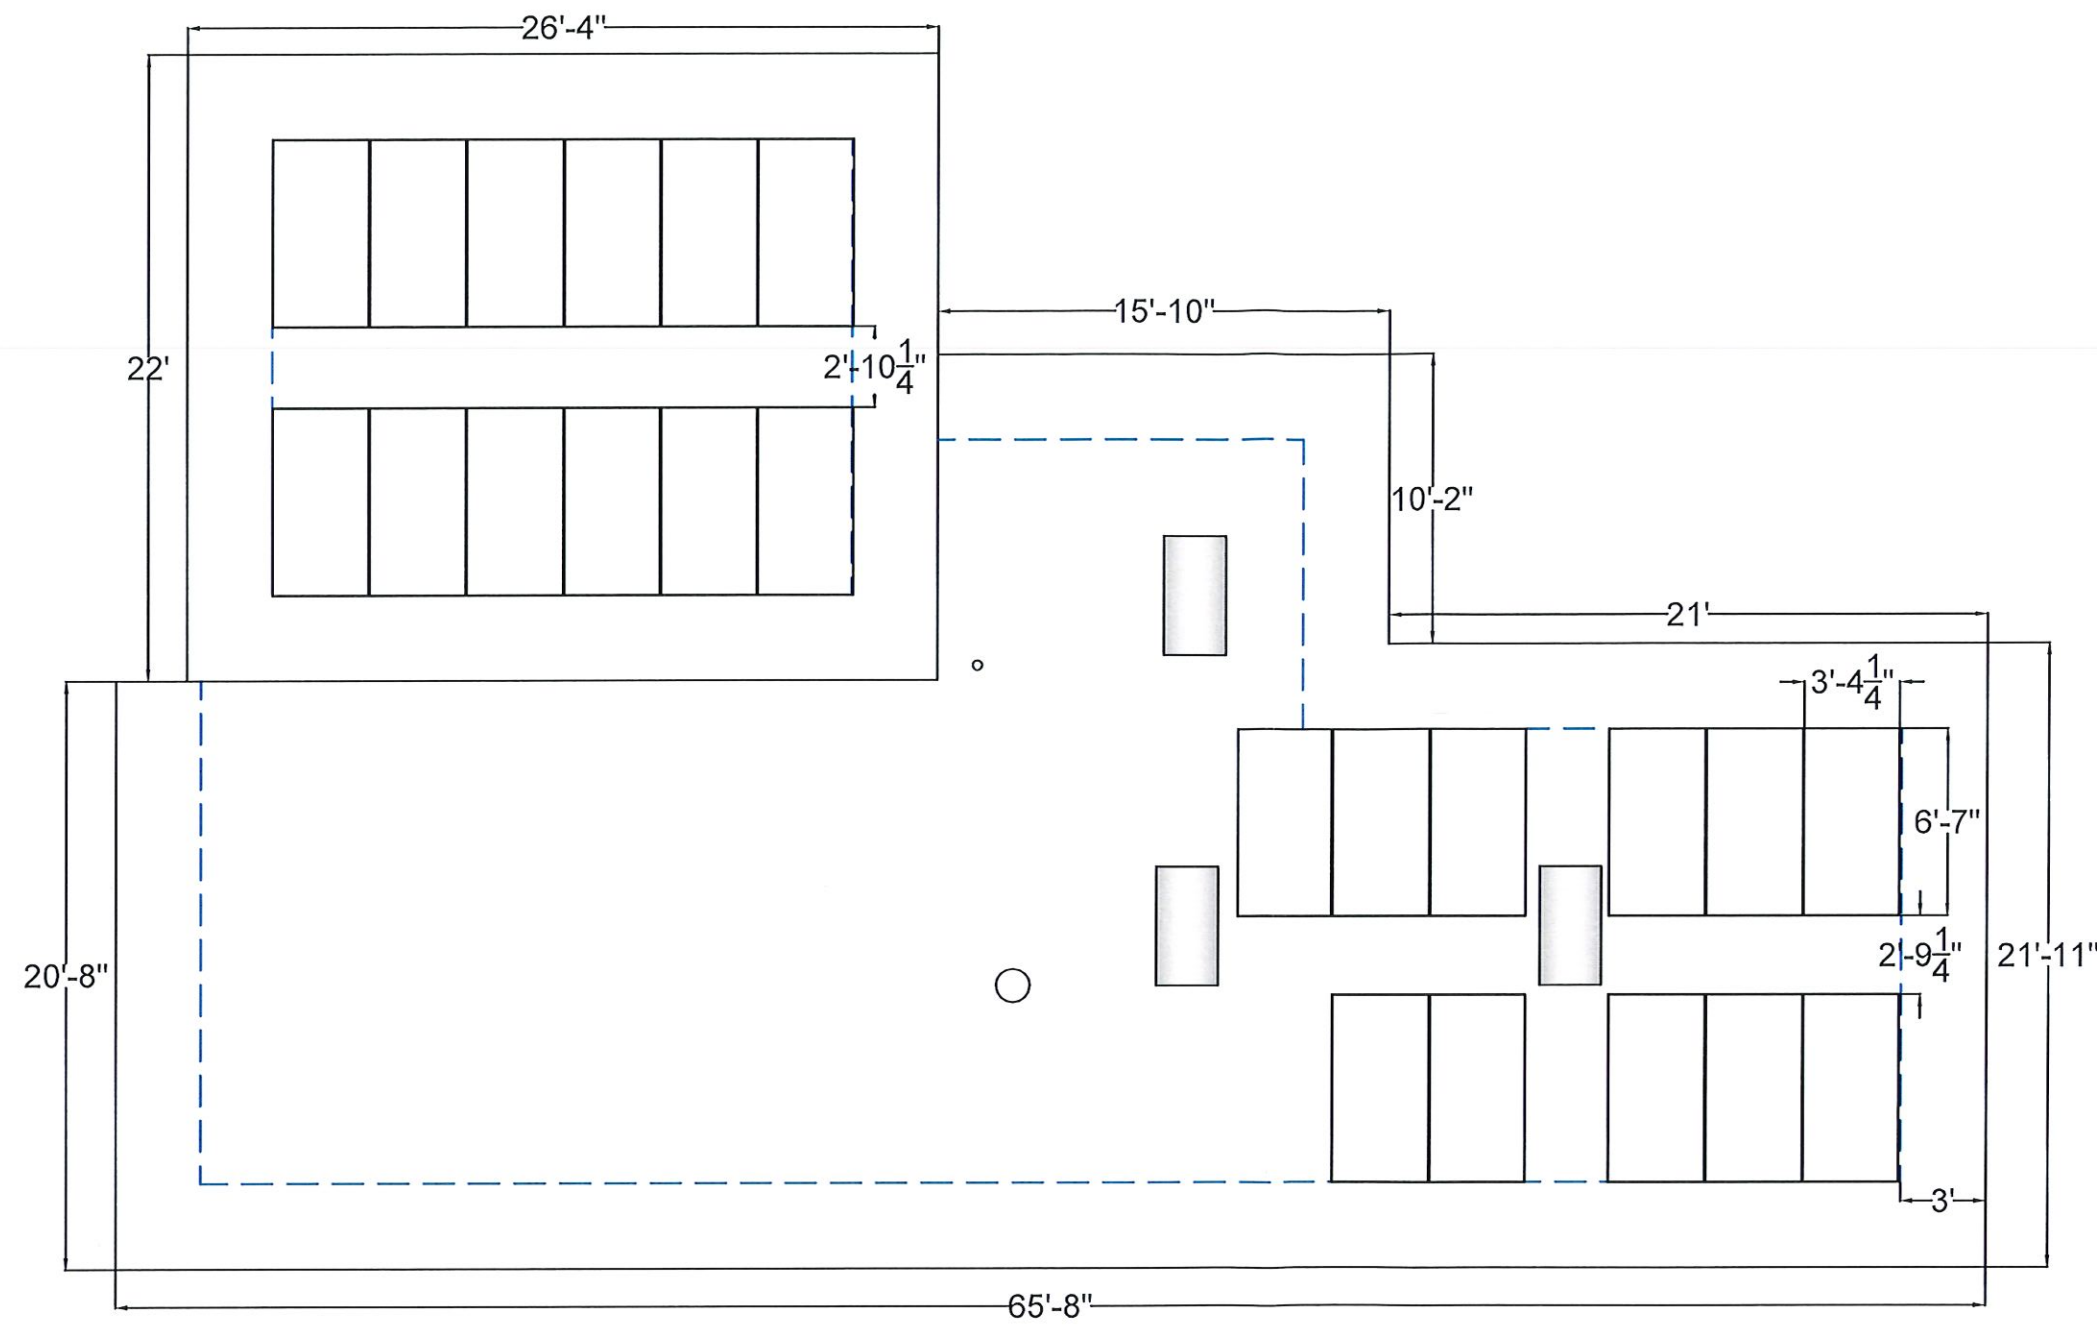ARRAY LAYOUT
 DATE: 09.05.2021
 DESIGNED BY: YO
 CHECKED BY: RB

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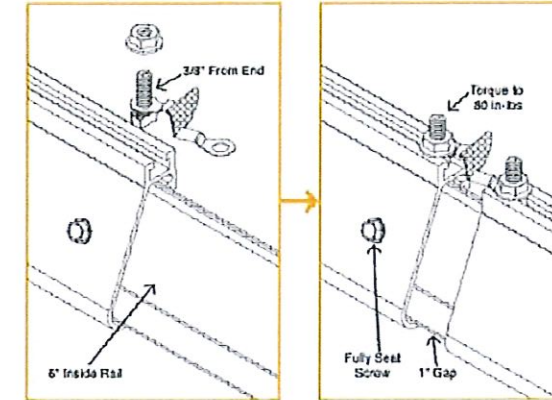
A-2

TILT MOUNT




TYPICAL SIDE VIEW

1. INSERT AN XR RAIL BONDED SPLICE INTO ONE XR RAIL AND SECURE WITH THE INCLUDED SCREW
2. SECURE ONE END OF THE GROUNDING STRAP EXPANSION JOINT 3/8" FROM THE END OF THE RAIL WITH THE INCLUDED T-BOLT
3. SLIDE THE SECOND XR RAIL OVER THE BONDED SPLICE, LEAVING A 1" GAP BETWEEN THE TWO RAILS
4. SECURE THE OTHER END OF THE GROUNDING STRAP EXPANSION JOINT 3/8" FROM THE END OF THE SECOND XR RAIL WITH THE INCLUDED T-BOLT
5. TORQUE T-BOLT HEX NUTS TO 80 IN-LBS
6. DO NOT INSTALL SOLAR PV MODULES OVER THE EXPANSION JOINT LOCATION





DETAIL D
(EXPANSION JOINT DETAIL)

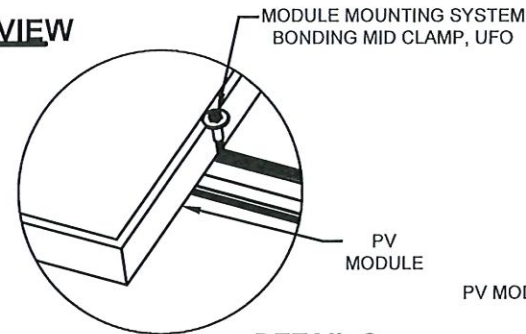


DETAIL C
(MODULE REMOVED FOR CLARITY)

DETAIL A
SOUTH TILT KIT ASSEMBLY

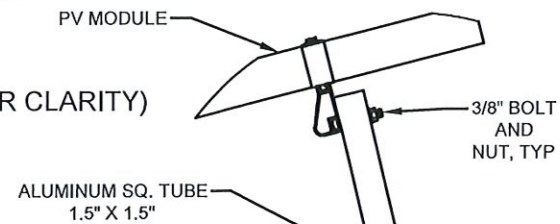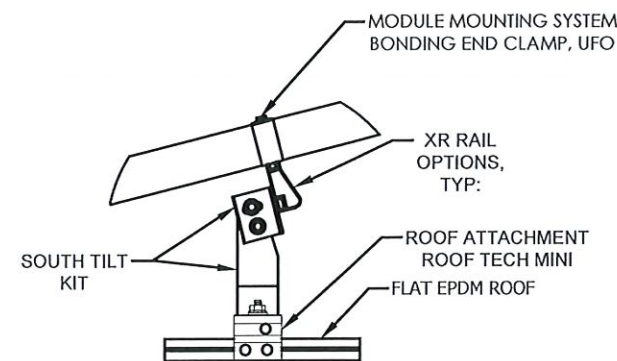

DETAIL B
NORTH TILT KIT ASSEMBLY

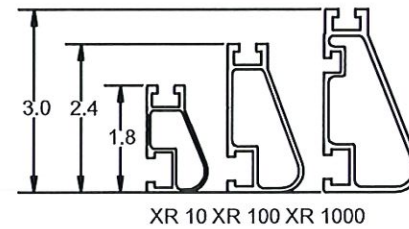

1
PV-09

RACKING DETAILS-2

SCALE: NOT TO SCALE

NOTE: USE ROOF TECH RT-MINI AS ROOF ATTACHMENT ON THIS PROJECT.

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RI REG# 3973

ROOF MOUNT PV SYSTEM
9.085 KW DC / 6.67 KW AC
PAULA MARTIESIAN
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PROVIDENCE, RI 02906

RACKING SYSTEM (1)

DATE: 09.05.2021


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A-3



GOTSUN GOSOLAR

1547 FALL RIVER AVE

SUITE #1

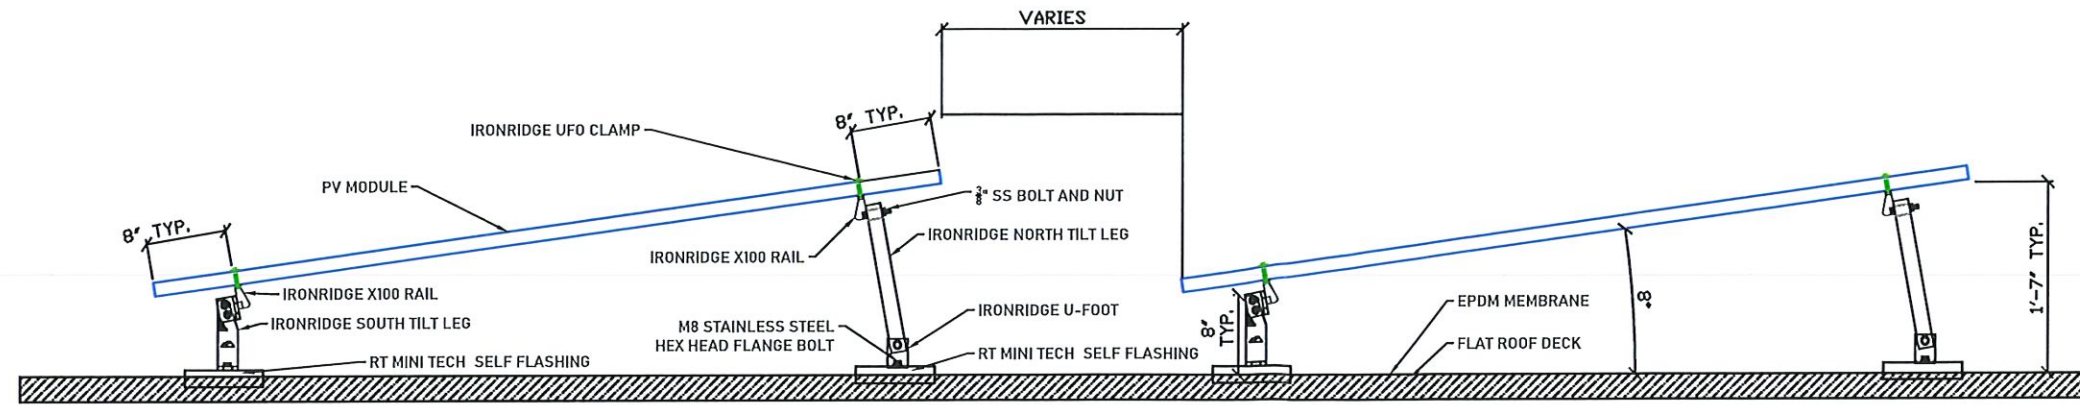
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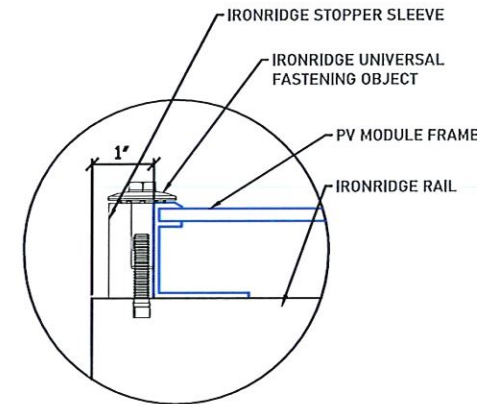
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MA HIC# 180717


RI REG# 3973




4 END CLAMP DETAIL, PLAN
PV-10

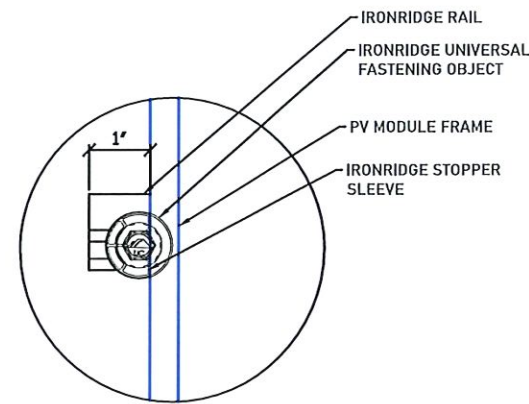

5 END CLAMP DETAIL, FRONT
PV-10 SCALE: NOT TO SCALE

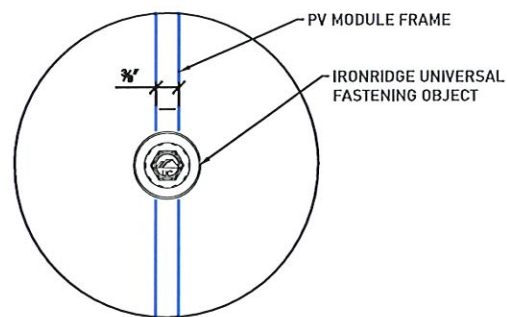

6 MID CLAMP DETAIL, PLAN
PV-10

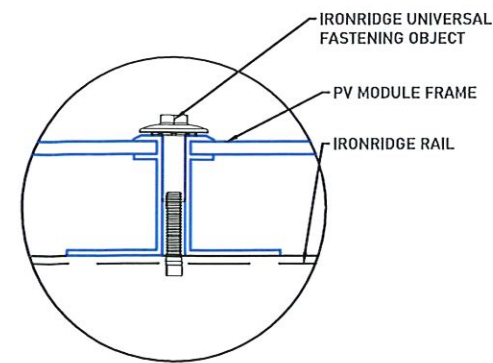

7 MID CLAMP DETAIL, FRONT
PV-10 SCALE: NOT TO SCALE

ROOF MOUNT PV SYSTEM
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RACKING SYSTEM

DATE: 09.05.2021

DESIGNED BY: YO

CHECKED BY: RB

REVISIONS
REV0

A-4

MICRO-INVERTERS

REF	QTY	MAKE AND MODEL	AC VOLTAGE	MAX OCPD RATING	RATED POWER	MAX OUTPUT CURRENT	CEC WEIGHTED EFFICIENCY
I 1-23	23	ENPHASE IQ 7+	240V	20A	290 W	1.21A	97.5%

MODULES

REF	QTY	MAKE AND MODEL	P _{max}
M 1- 23	23	LG395N2K A5	395 W

OCPDs

REF	QTY	RATED CURRENT	MAX VOLTAGE
CB1	1	20A	240V
CB2	1	20A	240V

DISCONNECTS

REF	QTY	MAKE AND MODEL	RATED CURRENT
SW1	1	SQUARE D OR EQUIV	60A DISCONNECT 35A FUSES
SW2	1	SQUARE D OR EQUIV	200A MAIN BREAKER OR FUSED DISCONNECT FOR INTERCONNECTION METHOD



GOTSUN GOSOLAR

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ROOF MOUNT PV SYSTEM
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PAULA MARTIESIAN
 65 HALSEY ST
 PROVIDENCE, RI 02906

COMPONENTS
INFORMATION

DATE: 09.05.2021

DESIGNED BY: YO

CHECKED BY: RB

REVISIONS
REV1

E-1



Tilt Mount System

Datasheet



Trust your system at every angle.

The IronRidge Tilt Mount System supports a wide range of solar module tilting angles, while also resisting the extreme wind and snow forces experienced over a building's lifetime.

Every component has been carefully engineered and rigorously tested, and the entire system uses only aluminum and stainless steel materials to resist corrosion.



Roof Friendly

Lightweight and compatible with industry-standard attachments.



Strength Tested

All components evaluated for superior structural performance.



UL 2703 Listed System

Meets newest effective UL 2703 standard.



PE Certified

Pre-stamped engineering letters available in most states.



Design Assistant

Online software makes it simple to create, share, and price projects.



25-Year Warranty

Products guaranteed to be free of impairing defects.

XR Rails & Tilt Legs

Datasheet

XR Rails



Attach directly to Tilt Legs. Available in three targeted sizes to support specific wind and snow loads.

- Unique curved profile
- Spanning capabilities up to 12'
- Clear and black finish

Tilt Legs



Tilt assembly to desired angle, up to 30 degrees. Kits include South and North Tilt Leg and all hardware.

- Available in multiple lengths for a wide angle range
- Assembled South Tilt Legs include angle indicators
- Legs are electrically bonded to rails

Grounding Clamps

UFOs



Universal Fastening Objects secure and bond modules to rails.

- Fully assembled and lubricated
- Single, universal size
- Clear and black finish

Stopper Sleeves



Snap onto the UFO to transform into a bonded end clamp.

- Bonds modules to rails
- Sized to match modules
- Clear and black finish

CAMO



Bond modules to rails while staying completely hidden.

- Universal end-cam clamp
- Tool-less installation
- Fully assembled

Accessories

BOSS™ Bonded Splices



Bonded Structural Splices connect and bond XR Rails together.

- Integrated bonding
- No tools or hardware
- Self-centering stop tab

Grounding Lugs



Connects Tilt Mount system to equipment ground.

- Low profile
- Single tool installation
- Mounts in any direction

Ends Caps & Wire Clips



Provide a finished look and organize electrical wires.

- Simple snap-in installations
- Clips hold up to ten 5mm wires
- UV-stabilized polymer

Resources



Design Assistant

Go from rough layout to fully engineered system. For free.

Go to IronRidge.com/design



NABCEP Certified Training

Earn free continuing education credits, while learning more about our systems.

Go to IronRidge.com/training



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RACKING DATASHEET

DATE: 09.05.2021

DESIGNED BY: YO

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REVISIONS

REV1

D-3

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DATASHEET

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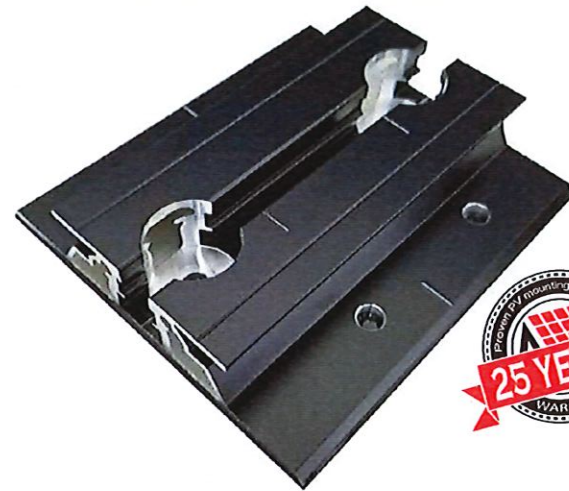
REVISIONS
REV1

D-4

RT-MINI

Self-flashing base for asphalt & metal roof-top PV mounting systems

RT-MINI is suitable for mounting any rail system with a conventional L-Foot.




Dual bolt design: M8 or 5/16" for L-Foot & 1/4" for EMC



Installation Manual



ICC ESR 3575

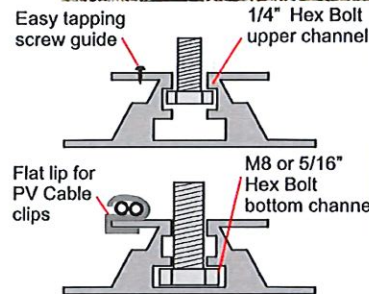

RT-MINI

Flexible Flashing certified by the International Code Council (ICC)

Engineered to ASTM D 1761 (Standard Test Methods for Mechanical Fasteners in Wood)

Components

RT2-00-MINIBK



MINI base : 20 ea.
Screw : 40 ea.
Extra RT-Butyl : 10 ea.

Optional item

5 x 60mm Mounting screw (RT2-04-SD5-60) : 100 ea./Bag
5/16" Hex bolt, washer & nut set (RT-04-BN30SL-US) : 100 ea./Bag
RT-Butyl (RT2-04-BUTYLT) : 10 ea./Box

RT-Butyl is Roof Tech's flexible flashing used in one million residential PV systems for the last 26 years. It is the first PV mounting system with Flexible Flashing certified by the ICC. Engineered to withstand wind speeds up to 180 mph and ground snow up to 90 psf.

Metal Flashing Retrofit Flexible Flashing




Shedding water? 100% Waterproof

ICC ESR-3575 ASTM2140 testing UV testing (7500 hrs.)




P.E. Stamped Letters available at www.roof-tech.us/support
TAS 100 A on metal and asphalt roof.


Dimensions in (mm)

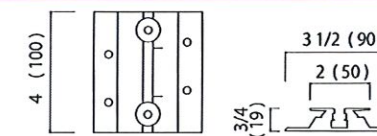

Rafter installation

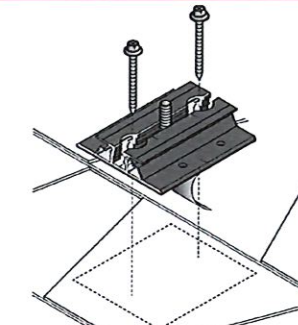

Deck installation

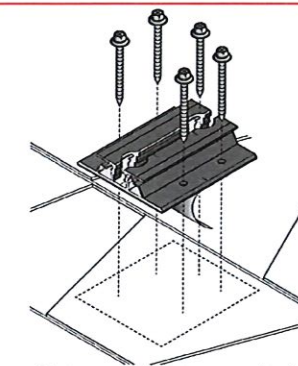

Roof Tech
The Standard for Waterproof Flexible Flashing Since 1994
www.roof-tech.us info@roof-tech.us

Roof Tech Inc.
www.roof-tech.us info@roof-tech.us
10620 Treena Street, Suite 230, San Diego, CA 92131
858.935.6064

March 2020