


PROPOSED GROUND LEVEL

SCALE: 1/8"=1'-0"





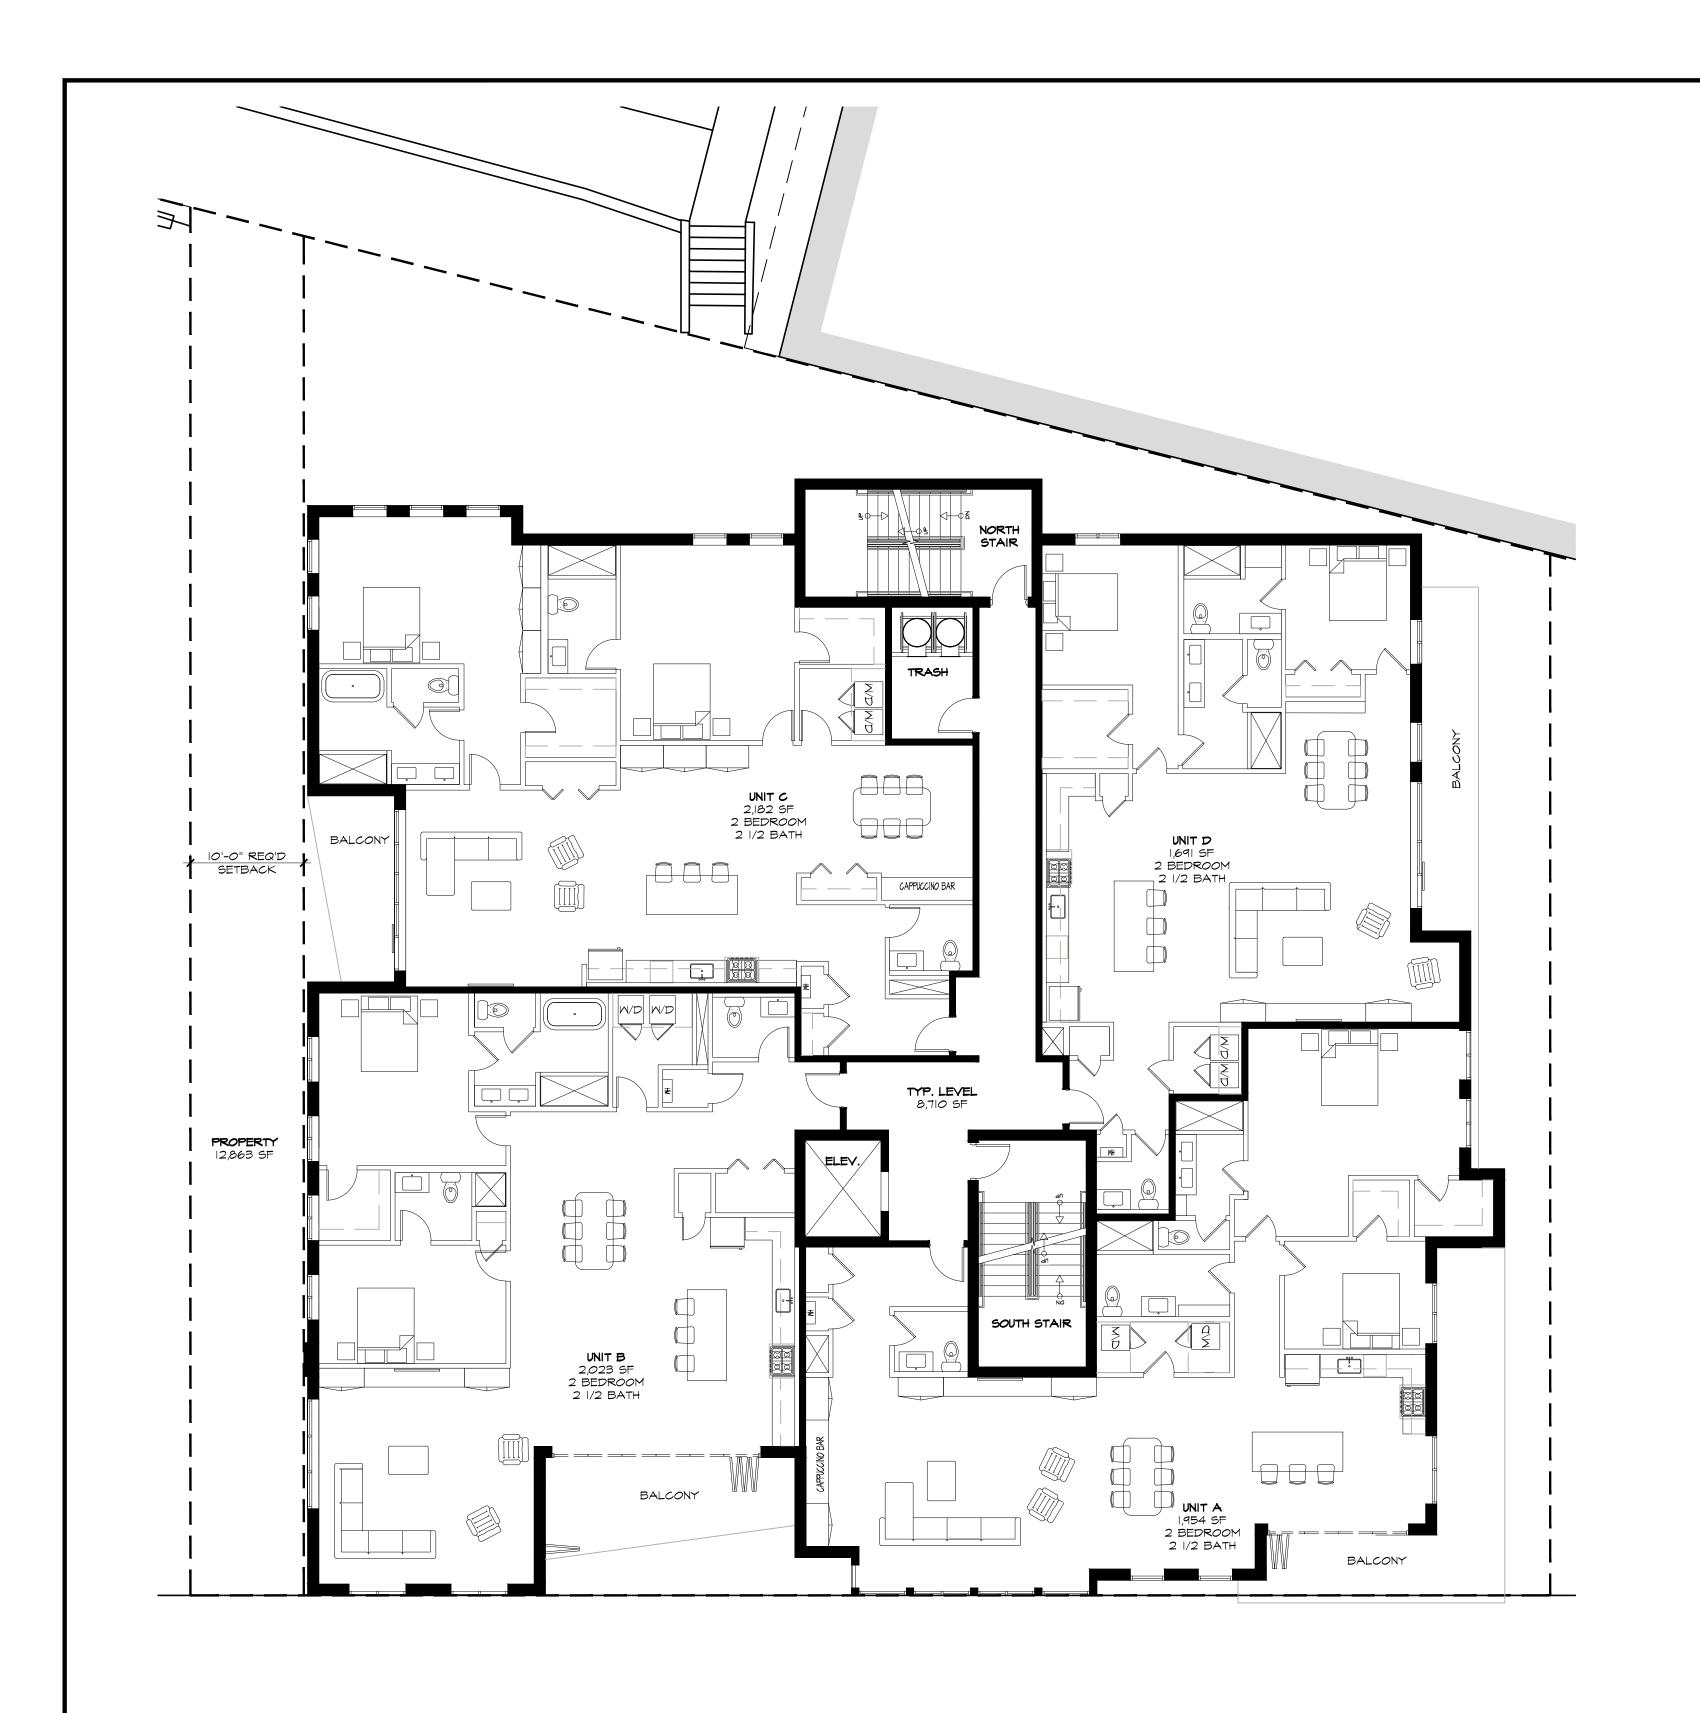

PROPOSED TYPICAL LEVEL

SCALE: 1/8"=1'-0"

PROPOSED ROOF TOP LEVEL

SCALE: 1/8"=1'-0"



PITMAN STREET DEVELOPMENT PROVIDENCE, RHODE ISLAND DECEMBER 1, 2023



PROPOSED SOUTH ELEVATION

SCALE: 1/8"=1'-0"





SITE IMPROVEMENT PLANS FOR A MINOR LAND DEVELOPMENT PROJECT

PITMAN STREET REDEVELOPMENT

A PROPOSED MULTI-FAMILY STRUCTURE **CONSISTING OF 16 RESIDENTIAL UNITS**

150, 154, & 158 PITMAN STREET PROVIDENCE, RHODE ISLAND **AP 15, LOTS 238-240**

ZONING DISTRICT: GENERAL COMMERCIAL DISTRICT (C-2)

LOTS 238 & 239 WALTER L. BRONHARD 972 HIGHLAND AVENUE FALL RIVER, MA 02720	LOT 240 150 PITMAN STREET LLC C/O WALTER L. BRONHARD 972 HIGHLAND AVENUE FALL RIVER, MA 02720	APPLICANT WALTER L. BRONHARD 972 HIGHLAND AVENUE FALL RIVER, MA 02720
JOE CASALI ENGINEERING, INC. 300 POST ROAD WARWICK, RI 02888 (401) 944-1300 PHONE WWW.JOECASALI.COM	ARCHITECT AHARONIAN & ASSOCIATES, INC. 310 GEORGE WASHINGTON HWY SMITHFIELD, RI 02917 (401) 944-1300 PHONE	WATERMAN ENGINEERING CO. 46 SUTTON AVENUE EAST PROVIDENCE, RI 02914 (401) 438-5773 PHONE

GENERAL NOTES:

- THIS PLAN IS BASED ON CLASS I COMPREHENSIVE BOUNDARY AND CLASS III TOPOGRAPHIC SURVEY DATED AUGUST 2018, PERFORMED BY WATERMAN ENGINEERING COMPANY LOCATED AT 46 SUTTON AVENUE, EAST PROVIDENCE, RI.
- THE LOCATION AND DEPTH OF EXISTING UTILITIES ARE APPROXIMATE AND HAVE BEEN PLOTTED FROM THE LATEST AVAILABLE INFORMATION. THE UTILITY LOCATIONS ARE APPROXIMATE AND MAY NOT BE ALL INCLUSIVE. THE CONTRACTOR SHALL CHECK AND VERIFY THE LOCATIONS OF ALL EXISTING UTILITIES, BOTH OVERHEAD AND UNDERGROUND, AND "DIG-SAFE" MUST BE NOTIFIED PRIOR TO COMMENCING AN' CONSTRUCTION OPERATIONS. RESTORATION AND REPAIR OF DAMAGE TO EXISTING UTILITIES SHALL BE THE RESPONSIBILITY OF THE CONTRACTOR WITH NO ADDITIONA COST THE OWNER. NO EXCAVATION SHALL COMMENCE UNTIL ALL INVOLVED UTILITY COMPANIES AND/OR CITY WHOSE FACILITIES MIGHT BE AFFECTED BY ANY WORK TO BE PERFORMED BY THE CONTRACTOR ARE NOTIFIED AT LEAST 72 HOURS IN ADVANCE.
- . THE SITE IS LOCATED ON THE FLOOD INSURANCE RATE MAP FOR PROVIDENCE COUNTY, MAP NUMBER 440007C0309K, DATED OCTOBER 2, 2015. THE ENTIRE PROJECT SITE IS LOCATED WITHIN FLOOD ZONE X, WHICH IS DEFINED AS AREAS OUTSIDE OF THE 0.2% ANNUAL CHANCE FLOOD HAZARD AREA.
- 4. SOILS ON THE SITE CONSIST OF UDORTHENTS-URBAN LAND COMPLEX (UD) AND MERRIMAC-URBAN LAND COMPLEX, 0-8% SLOPES. UD SOILS CONSIST OF HUMAN TRANSPORTED MATERIALS.
- 5. THERE ARE NO KNOWN WETLANDS ON SITE. THE SITE IS LOCATED WITHIN THE SEEKONK-PROVIDENCE RIVER WATERSHED (RIDEM INVENTORY NO. 010900040901).
- 6. THERE ARE NO KNOWN EASEMENTS WITHIN THE PROJECT SITE.
- 7. PUBLIC WATER, SEWER, ELECTRIC/COMMUNICATIONS AND GAS ARE AVAILABLE TO THE PROJECT SITE.

ZONING CRITERIA	REQUIRED
ZONING DISTRICT	C-2
MINIMUM LOT AREA	NONE
MINIMUM BUILDING HEIGHT	16 FT
MINIMUM FIRST STORY HEIGHT	SEE NOTE 1
MAXIMUM BUILDING HEIGHT	50 FT ²
MAXIMUM BUILDING COVERAGE	NONE
TOTAL MAX. IMPERVIOUS SURFACE COVERAGE	NONE
MINIMUM FRONT SETBACK	SEE NOTE 3
MINIMUM SIDE SETBACK	SEE NOTE 4
MINIMUM REAR SETBACK	SEE NOTE 5

- 1. 9 FT RESIDENTIAL USE; 11' NON-RESIDENTIAL USE 2. 50 FT, NOT TO EXCEED 4 STORIES
- 3. BUILD TO ZONE OF 0-5 FT; THE REQUIRED BUILD-TO
- PERCENTAGE IS 60% ON THE FRONT LOT LINE 4. NONE, UNLESS ABUTTING A RESIDENTIAL DISTRICT, THEN 10 FT
- 5. NONE; UNLESS ABUTTING A RESIDENTIAL DISTRICT, THEN 20 FT


CATION OF EXISTING UTILITIES SHOWN, ARE FROM GATE LOCATION AND KISTING DOCUMENTATION AND MAY NOT BE ACCURATE. EXACT LOCATION TO E DONE BY THE APPROPRIATE UTILITY COMPANY OR MUNICIPALITY PRIOR


SOIL EROSION NOTE:

CONTRACTOR SHALL ESTABLISH SUFFICIENT SOIL EROSION AND SEDIMENTATION CONTROL MEASURES ALONG THE NORTHERN AND EASTERN, DOWN GRADIENT SIDE OF PROJECT AREA INCLUDING BUT NOT LIMITED TO COMPOST SOCK AND SILTSACK SEDIMENT TRAPS ILLUSTRATED ON THE PLANS.

NOTES TO CONTRACTOR - WORK IN CITY RIGHT-OF-WAY:

- A PHYSICAL ALTERATION PERMIT MUST BE OBTAINED FROM THE CITY OF PROVIDENCE'S DEPARTMENT OF PUBLIC WORKS (DPW) ENGINEERING DIVISION PRIOR TO THE REMOVAL OF SIDEWALK WITHIN CITY RIGHT-OF-WAYS. A DPW TRAFFIC ENGINEERING PERMIT IS REQUIRED FOR THE CLOSING OF THE SIDEWALK TO PEDESTRIAN TRAFFIC. APPLICATION MUST ADDRESS ALTERNATIVE PEDESTRIAN PATH OF TRAVEL.
- ANY AND ALL SURPLUS CURB IS THE PROPERTY OF THE CITY OF PROVIDENCE AND SHALL BE TRANSPORTED AND STOCKPILED, AS DIRECTED, AT THE DEPARTMENT OF PUBLIC WORKS (DPW) FACILITY AT 20 ERNEST STREET, PROVIDENCE, RI.
- ALL CONSTRUCTION WITHIN THE CITY RIGHT-OF-WAY MUST BE IN ACCORDANCE WITH THE CITY'S STANDARD DETAILS AVAILABLE AT HTTPS://WWW.PROVIDENCERI.GOV/ PUBLIC-WORKS/FORMS/ UNDER "REPORTS + PUBLICATIONS"

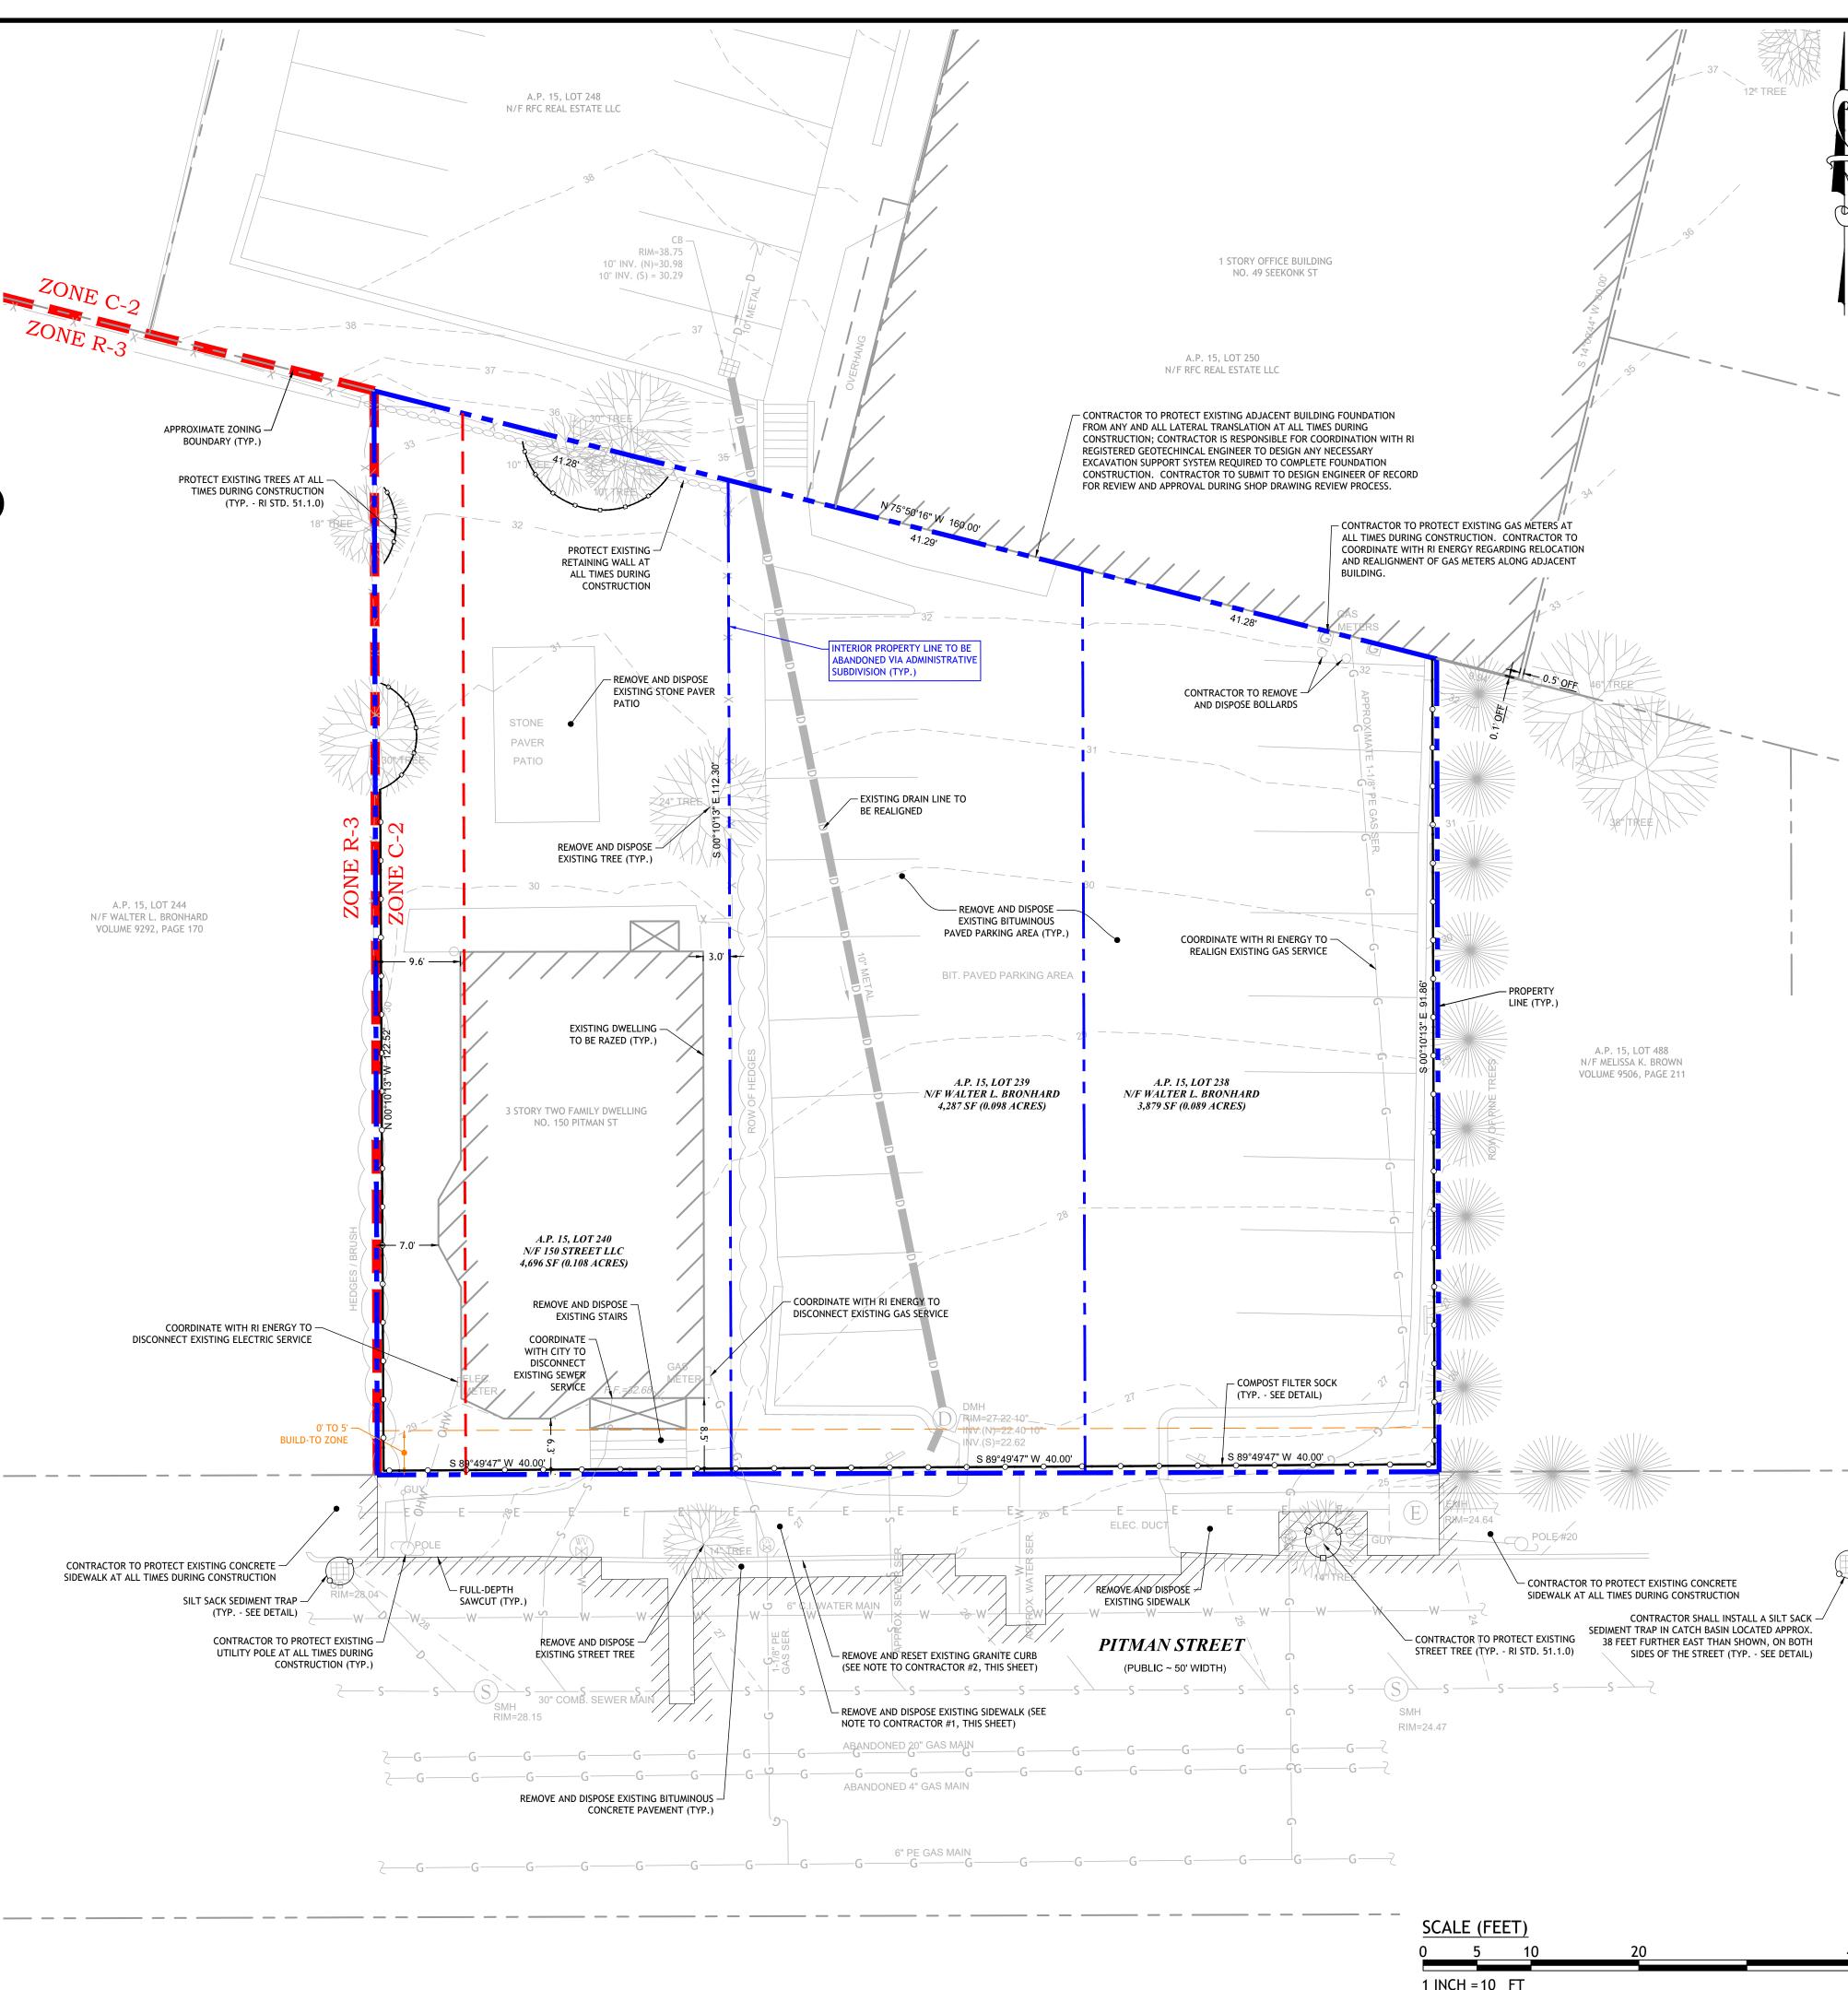

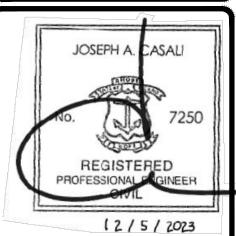

NO. DATE. DESCRIPTION 1 12/5/23 PLANNING COMMENTS

DESIGNED BY: WLMJR DRAWN BY: SD/SEP CHECKED BY: JAC PROJECT NO: 19-19s

PRELIMINARY, NOT FOR CONSTRUCTION

EXISTING CONDITIONS

> SHEET 1 OF 5

ZONING CRITERIA	DECLUBED	PROPOSED
ZONING CRITERIA	REQUIRED	PROPOSED
ZONING DISTRICT	C-2	C-2
MINIMUM LOT AREA	NONE	12,862 SF
MINIMUM BUILDING HEIGHT	16 FT	>16 FT
MINIMUM FIRST STORY HEIGHT	SEE NOTE 1	11 FT
MAXIMUM BUILDING HEIGHT	50 FT ²	57 FT (5 STORIES)
MAXIMUM BUILDING COVERAGE	NONE	74.2%
TOTAL MAX. IMPERVIOUS SURFACE COVERAGE	NONE	76.1%
MINIMUM FRONT SETBACK	SEE NOTE 3	0 FT - 3.33 FT
MINIMUM SIDE SETBACK	SEE NOTE 4	6 FT
MINIMUM REAR SETBACK	SEE NOTE 5	3.94 FT

NOTES:
1. 9 FT RESIDENTIAL USE; 11' NON-RESIDENTIAL USE

50 FT, NOT TO EXCEED 4 STORIES
 BUILD TO ZONE OF 0-5 FT; THE REQUIRED BUILD-TO PERCENTAGE IS 60% ON

THE FRONT LOT LINE
4. NONE, UNLESS ABUTTING A RESIDENTIAL DISTRICT, THEN 10 FT

NONE; UNLESS ABUTTING A RESIDENTIAL DISTRICT, THEN 20 FT
 ADJUSTMENT REQUESTED FOR ONE (1) ADDITIONAL STORY / 7 FEET

VEHICLE AND BICYCLE PARKING REQUIREMENTS:

VEHICLE PARKING: PER SECTION 1402, TABLE 14-1: OFF STREET VEHICLE AND BICYCLE PARKING REQUIREMENTS

USE: MULTI-FAMILY DWELLING MINIMUM 1 PARKING SPACE PER DWELLING UNIT 16 DWELLING UNITS PROPOSED

REQUIRED: 16 PARKING SPACES

PROVIDED: 16 PARKING SPACES (1 VAN ACCESSIBLE ADA SPACE)

BICYCLE PARKING: ONE (1) BICYCLE SPACE IS REQUIRED PER FIVE (5) DWELLING UNITS. 16 UNITS ARE PROPOSED, THEREFORE 4 BICYCLE SPACES ARE REQUIRED. ALL 4 BICYCLE SPACES ARE PROPOSED WITHIN THE BASEMENT OF THE PROPOSED STRUCTURES; REFER TO ARCHITECTURAL PLANS FOR DETAILED LOCATIONS.

LOADING SPACE REQUIREMENT:

LOADING SPACE: PER SECTION 1403, TABLE 14-2: OFF STREET LOADING REQUIREMENTS

USE: MULTI-FAMILY DWELLING
MINIMUM 1 LOADING SPACE FOR 40,000 SF OR MORE GFA*
*NOT INCLUDING INTERIOR PARKING SPACES

PROPOSED GFA* = 37,729 SF NO LOADING SPACE REQUIRED

LANDSCAPING REQUIREMENTS:
PER SECTION 1503, - ONSITE LANDSCAPING AND REQUIRED TREES
SECTION C - REQUIRED TREE CANOPY
(ALL OTHER DISTRICTS: 15% OF THE SF OF THE LOT)

12,862 SF TOTAL LOT AREA x 15% OF LOT AREA = 1,929 SF OF TREE CANOPY

REQUIRED: 1,929 SF OF TREE CANOPY
PROPOSED: 2,000 SF OF TREE CANOPY*
*ONE (1) EXISTING STREET TREE ADJACENT TO THE SUBJECT
PROPERTY AND ONE (1) PROPOSED STREET TREE ARE ASSUMED TO
MEET THIS REQUIREMENT (LARGE STREET TREE = 1,000 SF CANOPY)

CITY OF PROVIDENCE DEPT. OF PUBLIC WORKS (DPW) NOTES:

1. CONTACT DPW ENGINEERING BEFORE ANY EXCAVATION IN THE

PUBLIC RIGHT-OF-WAY OR SEWER CONNECTION AT 401-680-7525.


ALL CONSTRUCTION WITHIN THE PUBLIC RIGHT-OF-WAY MUST BE IN ACCORDANCE WITH THE CITY'S STANDARD DETAILS.


ANY AND ALL SURPLUS GRANITE CURBING SHALL BE RETURNED TO THE CITY OF PROVIDENCE DEPARTMENT OF PUBLIC WORKS.


ANY CONSTRUCTION ACTIVITY THAT HINDERS VEHICLE TRAFFIC OR PEDESTRIAN TRAFFIC MUST BE PERMITTED THROUGH THE CITY TRAFFIC ENGINEER.


5. CONTRACTOR WILL BE RESPONSIBLE FOR OBTAINING A LETTER OF APPROVAL AND SUBMITTING TO THE DEPARTMENT OF STANDARDS. A PHYSICAL ALTERATION PERMIT, ROAD EXCAVATION PERMIT FOR EACH UTILITY AND SEWER PERMITS ARE REQUIRED BEFORE THAT PARTICULAR WORK COMMENCES.

5. ROOF DRAINS SHALL NOT BE TIED INTO THE SANITARY SEWER CONNECTION.

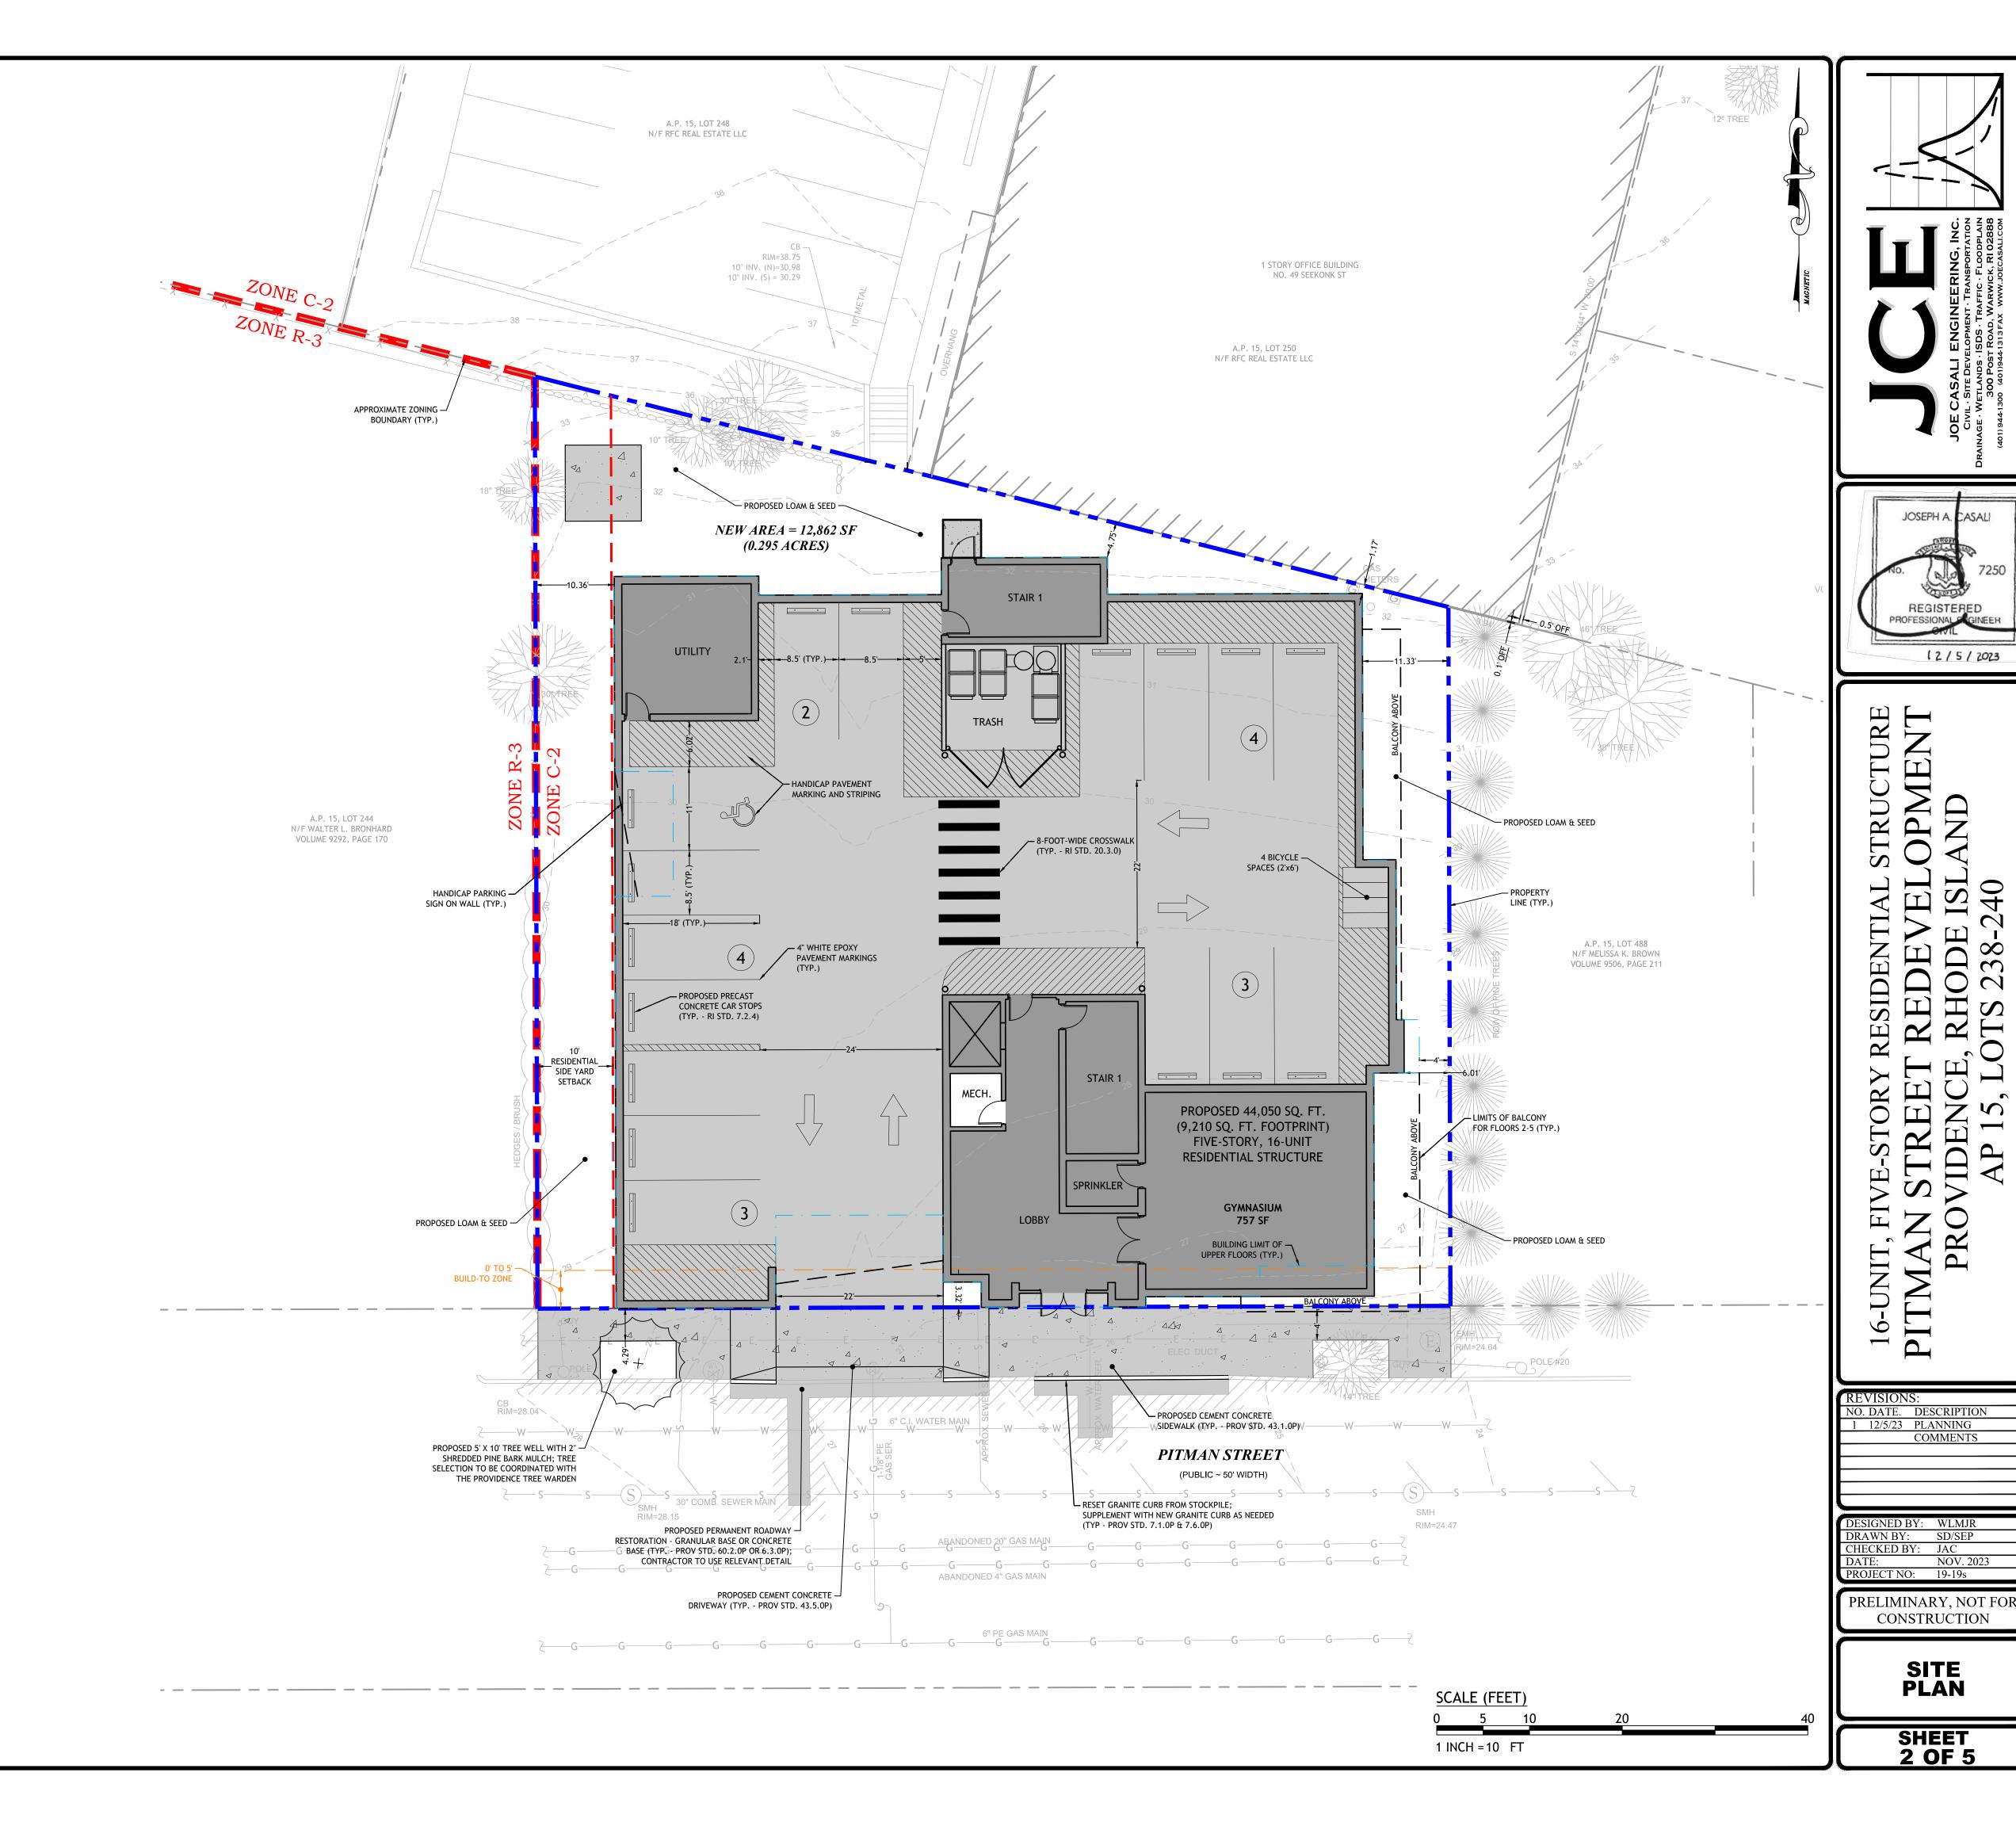

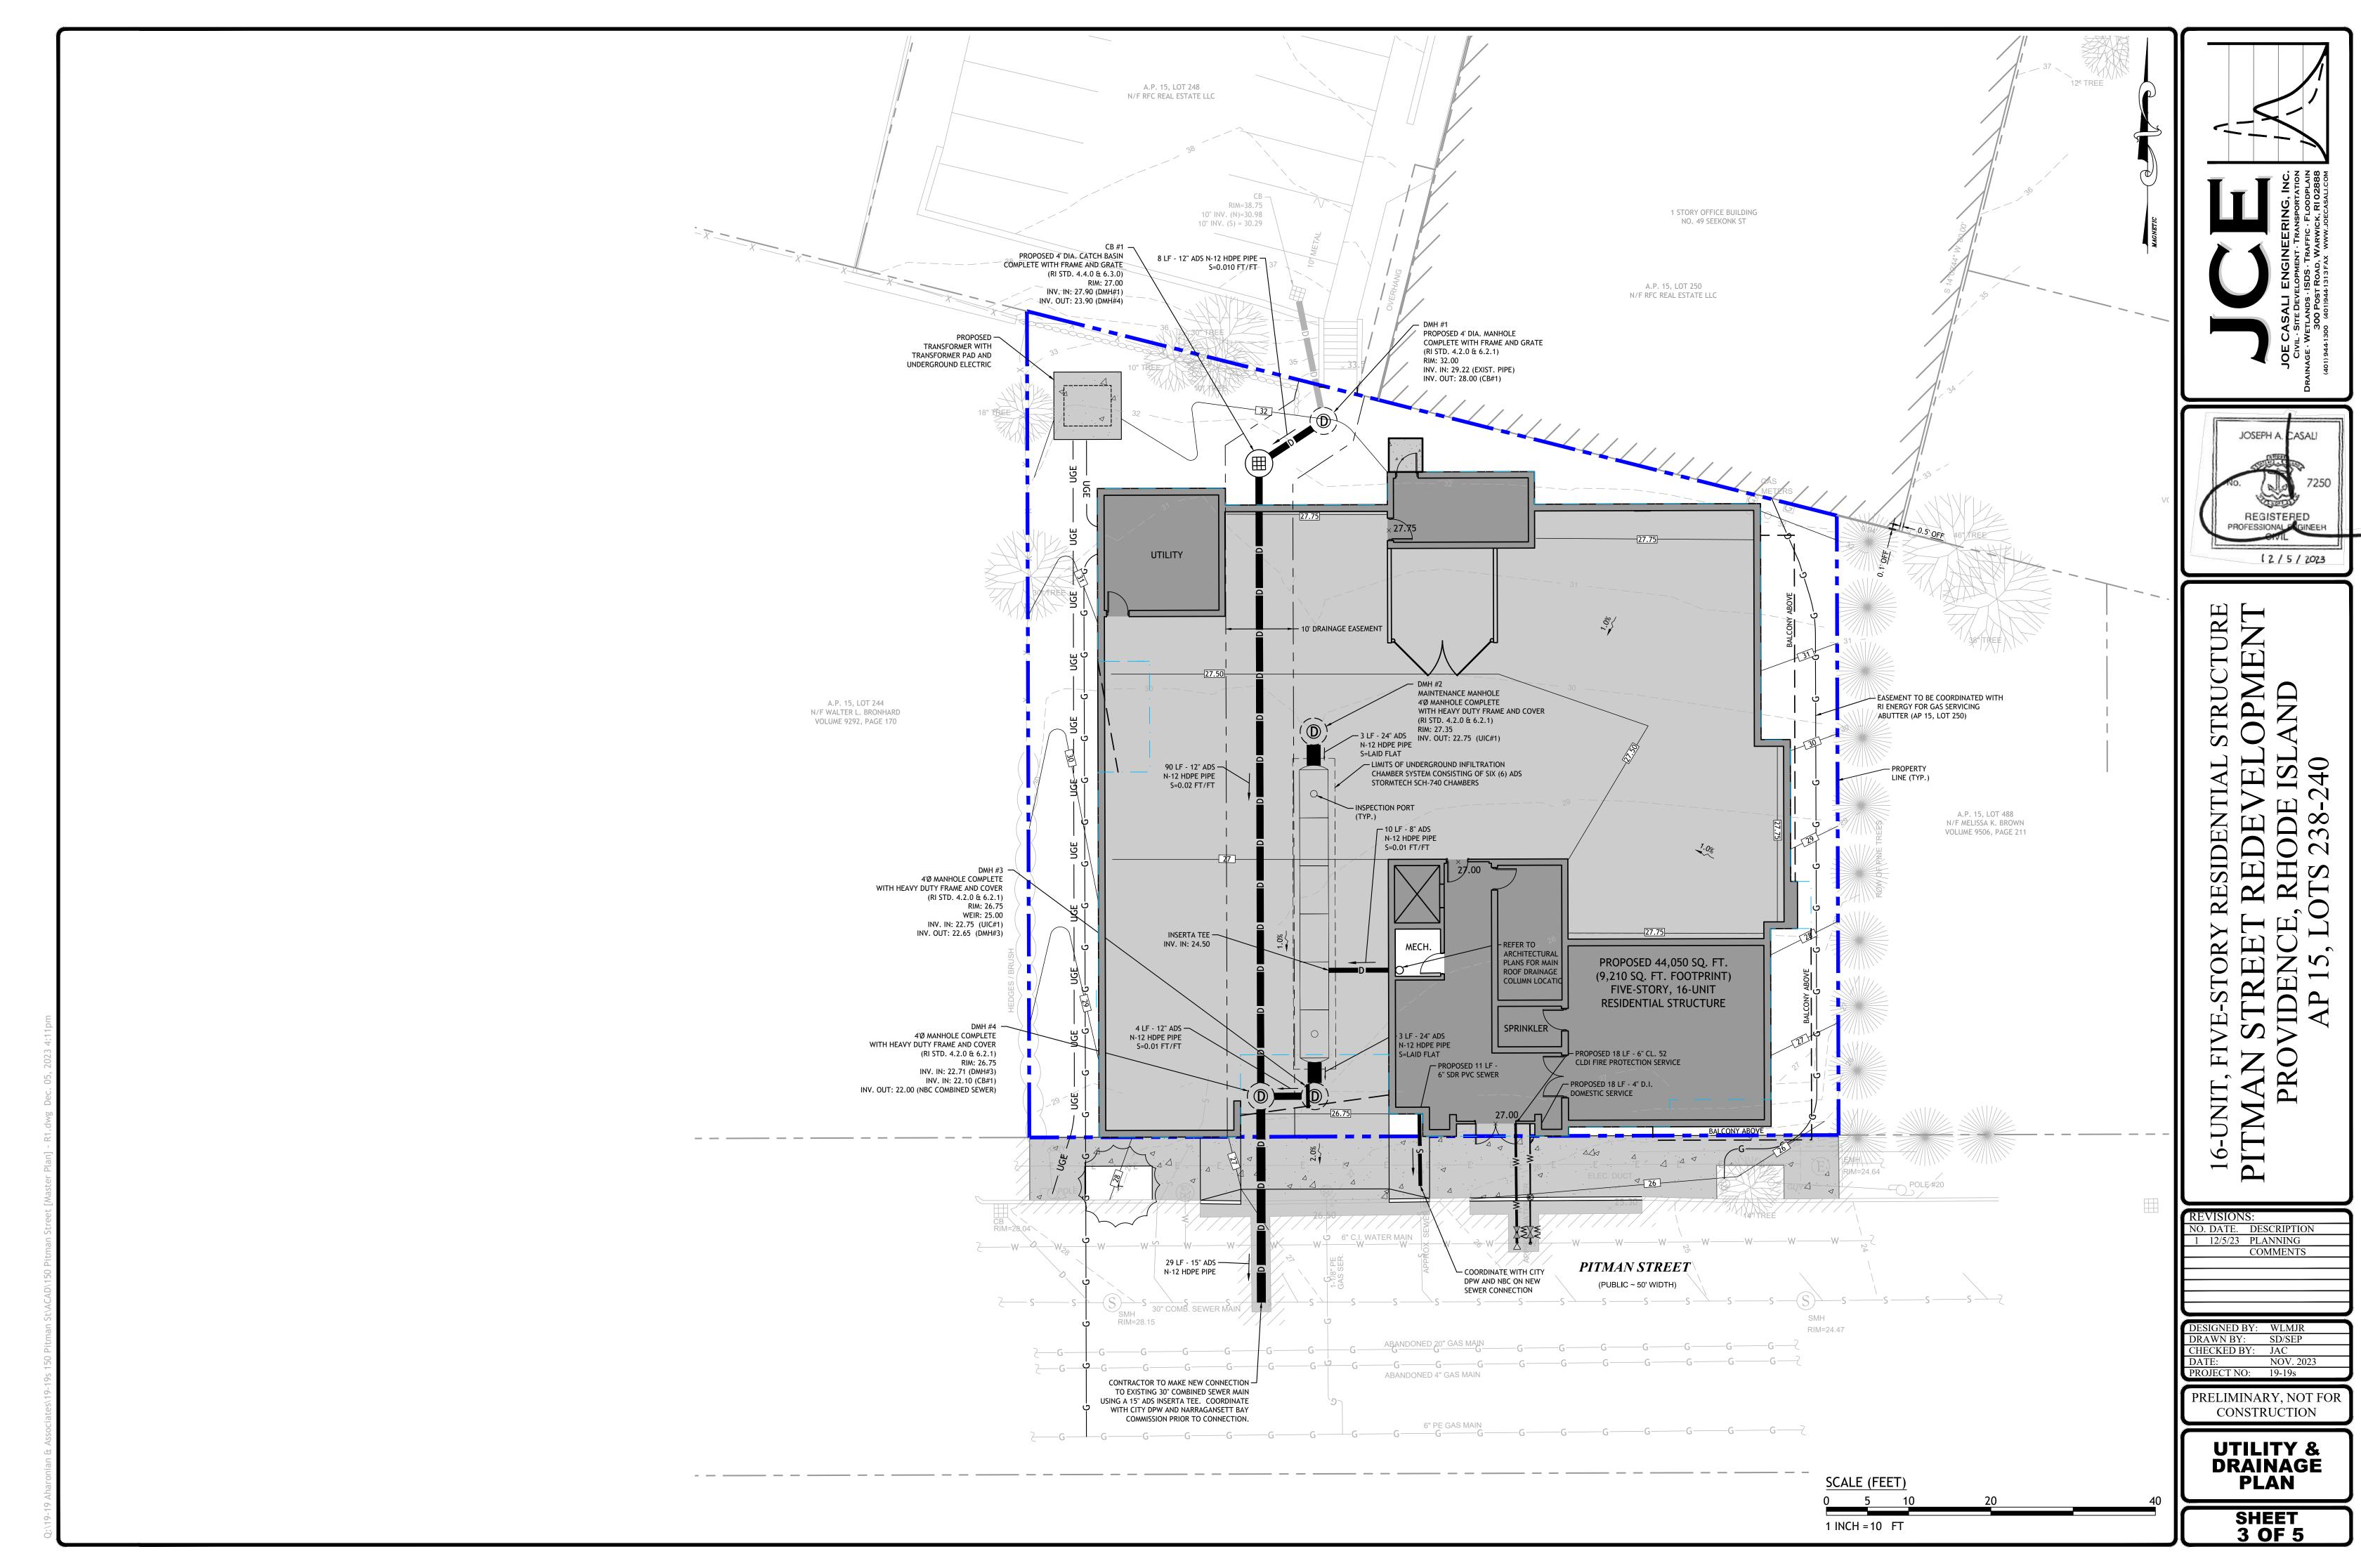

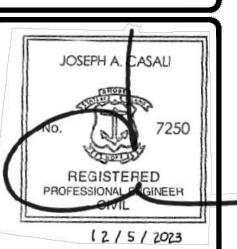

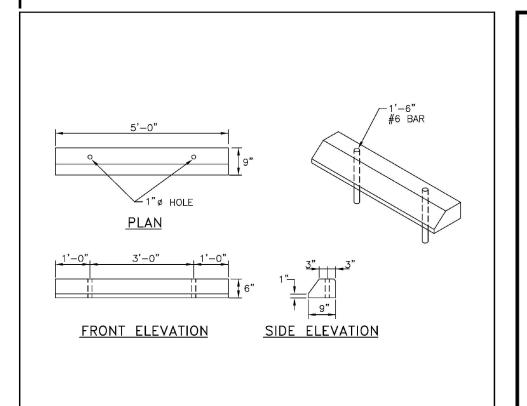

NOTES:
1. SHALL BE IN ACCORDANCE WITH SECTION 906 OF THE R.I. STANDARD SPECIFICATIONS.
2. ALL EXPOSED EDGES TO HAVE A 3/4" CHAMFER.
3. ALL SURFACES TO HAVE A SPONGE FLOAT FINISH.

RHODE ISLAND DEPARTMENT OF TRANSPORTATION

REVISIONS

NO. BY DATE

1 MLP Mgr 05

PRECAST CONCRETE CAR STOPS

1 MLP Mgr 05

CHIEF DESIGN ENGINEER TRANSPORTATION

CHIEF DESIGN ENGINEER TRANSPORTATION


CHIEF DESIGN ENGINEER TRANSPORTATION

TRANSPORTATION


TO TRANSPORTATION


R.I. STANDARD


7.2.4

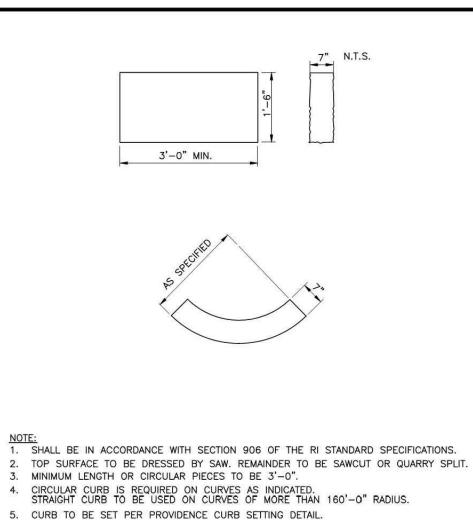



GRANITE CURB - STRAIGHT AND CIRCULAR

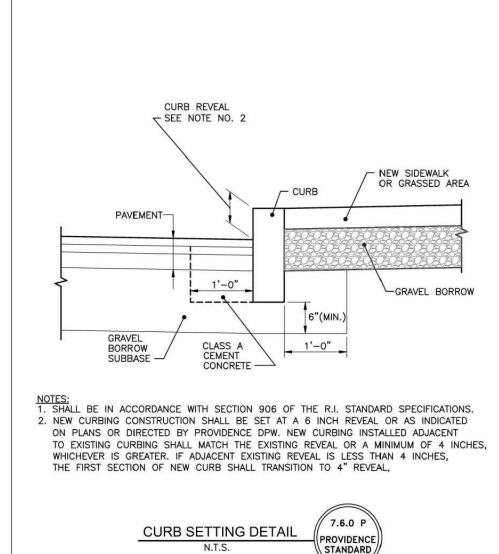

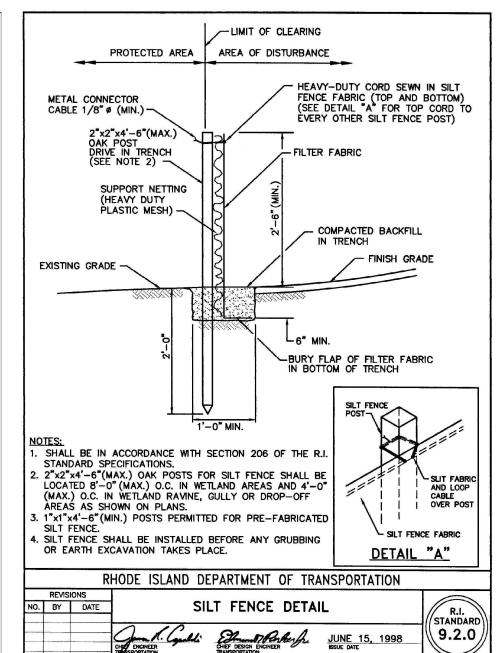

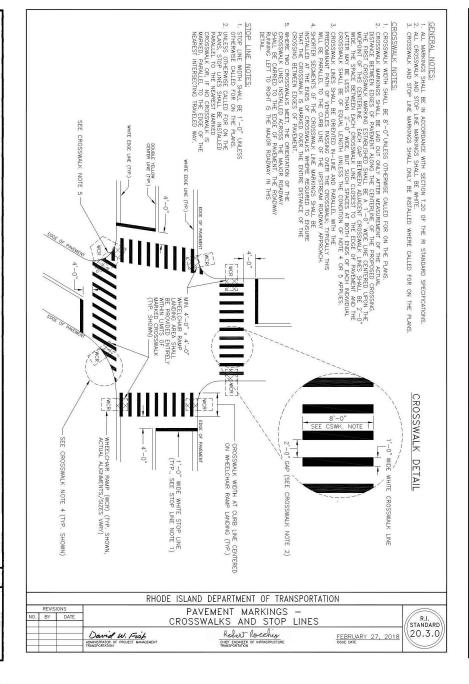

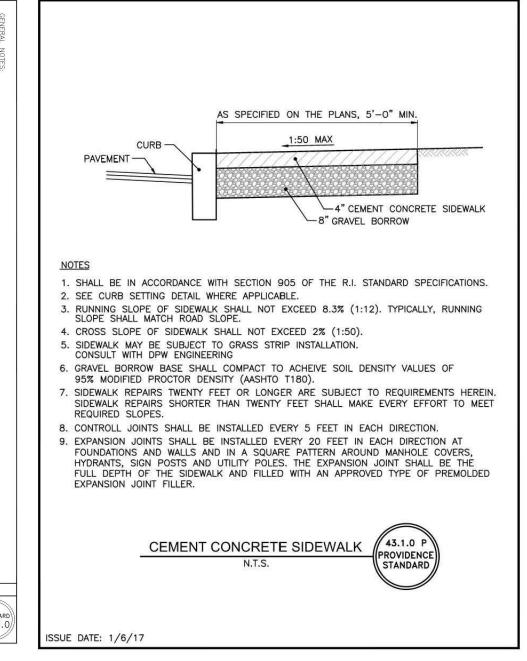

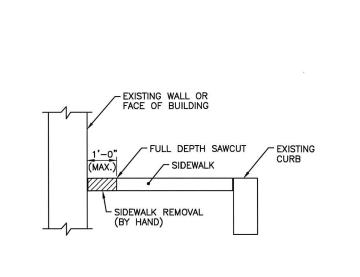

NOTES:


1. IN AREAS WHERE SIDEWALKS ARE TO BE REMOVED IN FRONT OF EXISTING WALLS OR BUILDINGS, THE CONTRACTOR SHALL SAWCUT ONE(1) FOOT (MAXIMUM) IN FRONT OF THE WALL/BUILDING AND REMOVE THE SIDEWALK STRUCTURE BY HAND.


2. IN THE EVENT THAT THE EXISTING SIDEWALK IS A STRUCTURAL ELEMENT OF THE WALL/BUILDING, THE EXISTING SIDEWALK IN FRONT OF THESE STRUCTURES WILL REMAIN IN-PLACE AND A NEW SIDEWALK CONSTRUCTED TO MATCH THE EXISTING SECTION.

3. ANY DAMAGE TO THE WALL OR BUILDING BY THE CONTRACTOR SHALL BE REPAIRED BY THE CONTRACTOR AT NO ADDITIONAL COST TO THE CITY.


SIDEWALK REMOVAL DETAIL
N.T.S.


ISSUE DATE: 1/6/17

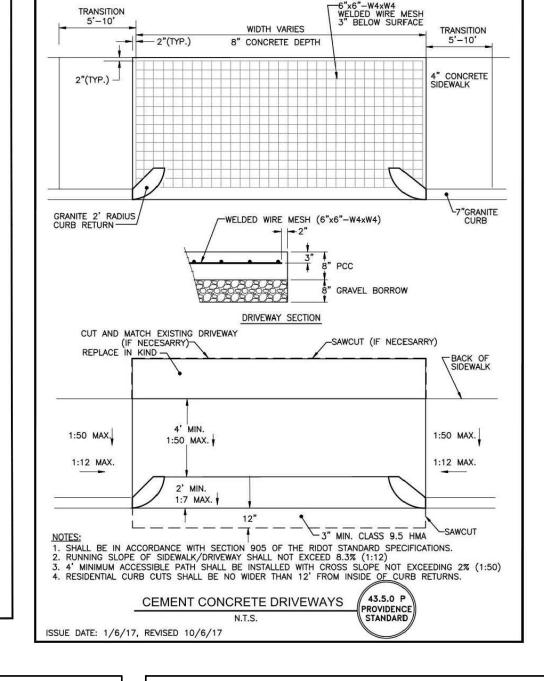


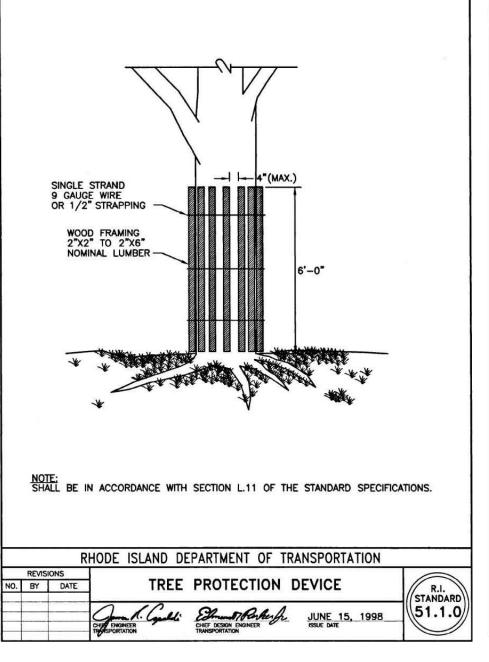

ISSUE DATE: 1/6/17

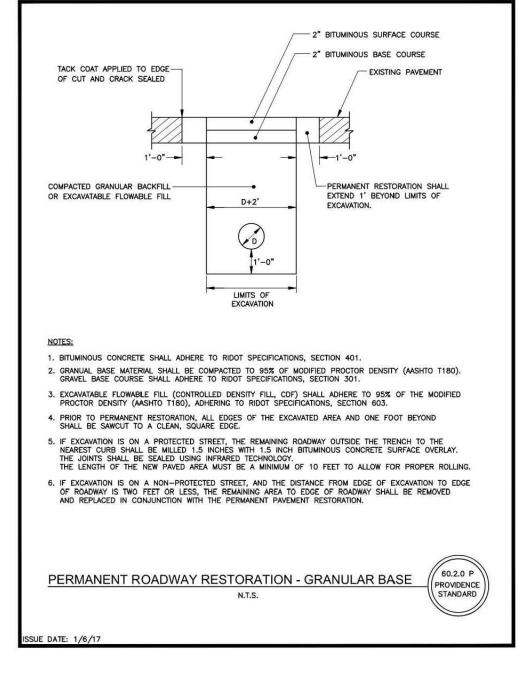

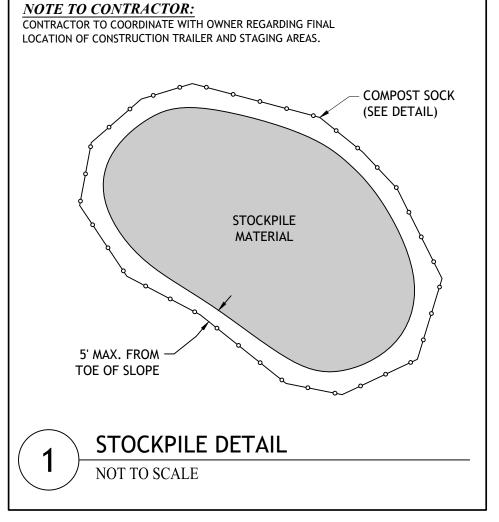

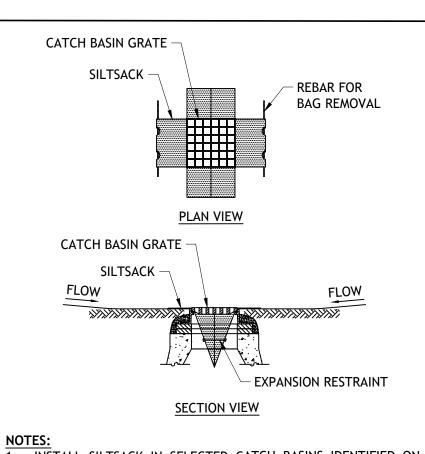


INSTALL SILTSACK IN SELECTED CATCH BASINS IDENTIFIED ON THE EXISTING CONDITIONS AND SITE PREPARATION PLAN BEFORE COMMENCING WORK.

GRATE TO BE PLACED OVER SILTSACK. SILTSACK SHALL BE INSPECTED PERIODICALLY AND AFTER ALL STORM EVENTS AND

2. GRATE TO BE PLACED OVER SILTSACK. SILTSACK SHALL BE INSPECTED PERIODICALLY AND AFTER ALL STORM EVENTS AND CLEANING OR REPLACEMENT SHALL BE PERFORMED PROMPTLY AS NEEDED. MAINTAIN UNTIL UPSTREAM AREAS HAVE BEEN PERMANENTLY STABILIZED.



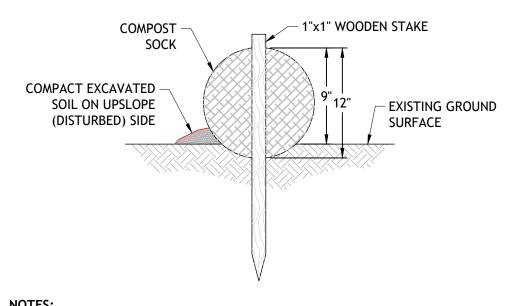


1. BEGIN WATTLE INSTALLATION BY EXCAVATING A 2 TO 3-INCH-DEEP BY 9" WIDE TRENCH ALONG THE CONTOUR OF THE SLOPE OR ALONG THE EXISTING GROUND SURFACE. EXCAVATED SOIL SHOULD BE PLACED UP-SLOPE OR ON THE DISTURBED SIDE OF THE ANCHOR TRENCH.


2. PLACE WATTLE IN THE TRENCH SUCH THAT IT CONTOURS TO THE EXISTING SOIL


SURFACE. COMPACT SOIL FROM THE EXCAVATED TRENCH AGAINST THE WATTLE ON THE UP-SLOPE OR DISTURBED SIDE. ADJACENT WATTLES SHOULD TIGHTLY ABUT.

3. SECURE WATTLE WITH 18 TO 24-INCH-LONG STAKES. INSTALL AN ADDITIONAL STAKE AT EACH END OF THE WATTLE. STAKES SHOULD BE DRIVEN THROUGH THE MIDDLE OF THE WATTLE LEAVING AT LEAST 2 TO 3 INCHES OF STAKE EXTENDING ABOVE. THE STAKES SHOULD BE DRIVEN PERPENDICULAR TO THE SLOPE FACE OR GROUND SURFACE.



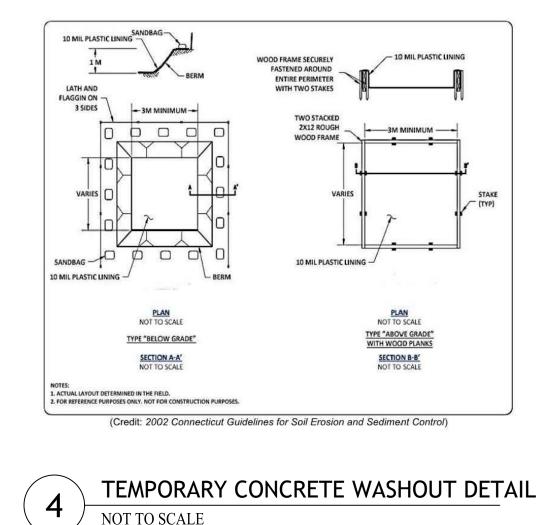

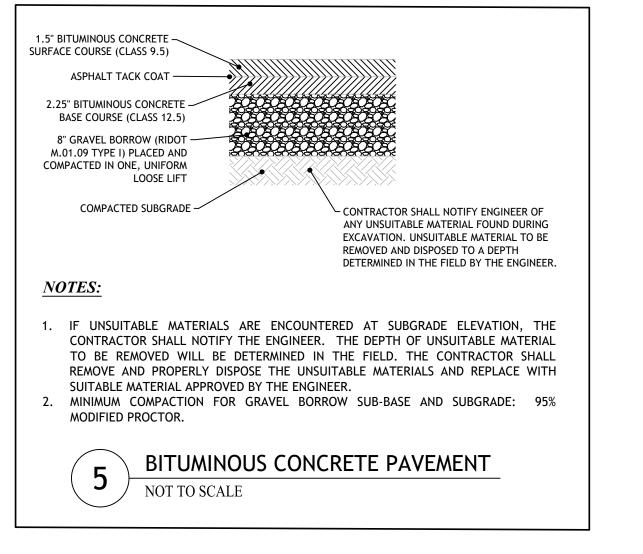

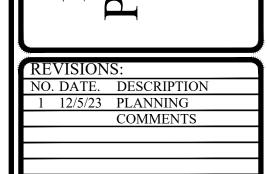

JOSEPH A. CASALI

REGISTERED

DEN DE OD 238

A A L

AP AP

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12/5/2023

PROFESSIONAL


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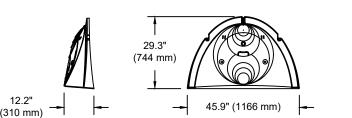
DESIGNED BY:	WLMJR
DRAWN BY:	SD/SEP
CHECKED BY:	JAC
DATE:	NOV. 2023
PROJECT NO:	19-19s

PRELIMINARY, NOT FOR CONSTRUCTION

CIVIL DETAILS

SHEET 4 OF 5



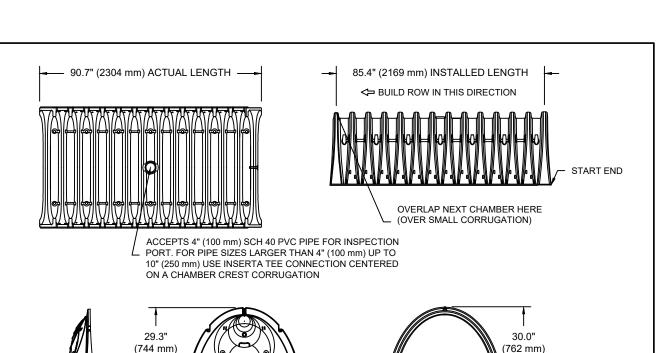

51.0" X 30.0" X 85.4" (1295 mm X 762 mm X 2169 mm)

MINIMUM INSTALLED STORAGE* 75.0 lbs. *ASSUMES 6" (152 mm) STONE ABOVE, BELOW, AND BETWEEN CHAMBERS

SIZE (W X H X INSTALLED

CHAMBER STORAGE

45.9 CUBIC FEET (1.30 m³) 74.9 CUBIC FEET (2.12 m³)

STUBS AT BOTTOM OF END CAP FOR PART NUMBERS ENDING WITH "B"

STUBS AT TOP OF END CAP FOR PART NUMBERS ENDING WITH "T" PART# STUB 18.5" (470 mm) SC740EPE06T / SC740EPE06TP 6" (150 mm) 10.9" (277 mm) 0.5" (13 mm) SC740EPE06B / SC740EPE06BPC SC740EPE08T /SC740EPE08TP0 12.2" (310 mm) 0.6" (15 mm) SC740EPE08B / SC740EPE08BPC SC740EPE10B / SC740EPE10BPC 10" (250 mm) 13.4" (340 mm) 0.7" (18 mm) SC740EPE12B / SC740EPE12BPC 12" (300 mm) SC740EPE12T / SC740EPE12TP 14.7" (373 mm) 1.2" (30 mm) SC740EPE15T / SC740EPE15TP0 15" (375 mm) 18.4" (467 mm) SC740EPE15B / SC740EPE15BPC SC740EPE18T / SC740EPE18TP 18" (450 mm) 19.7" (500 mm) 1.6" (41 mm) SC740EPE18B / SC740EPE18BPC

* FOR THE SC740EPE24B THE 24" (600 mm) STUB LIES BELOW THE BOTTOM OF THE END CAP APPROXIMATELY 1.75" (44 mm). BACKFILL MATERIAL SHOULD BE REMOVED FROM BELOW THE N-12 STUB SO THAT THE FITTING SITS LEVEL.

THE STUB IS FLUSH WITH THE BOTTOM OF THE END CAP. FOR ADDITIONAL INFORMATION CONTACT STORMTECH AT


ALL STUBS, EXCEPT FOR THE SC740EPE24B ARE PLACED AT BOTTOM OF END CAP SUCH THAT THE OUTSIDE DIAMETER OF



REQUIREMENTS OF LAYER 'C' OR 'D' AT THE SITE DESIGN ENGINEER'S DISCRETION.

NOTE: ALL DIMENSIONS ARE NOMINAL

SC-740 TECHNICAL SPECIFICATION

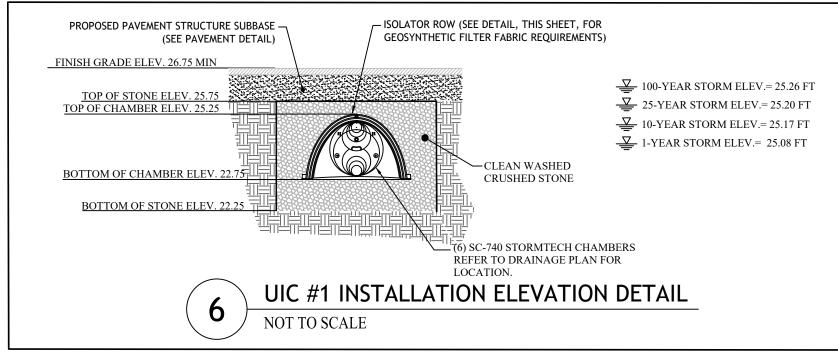

NOTES FOR THE INSTALLATION OF THE SC-740 SYSTEM


- 1. STORMTECH SC-310 & SC-740 CHAMBERS SHALL NOT BE INSTALLED UNTIL THE MANUFACTURER'S REPRESENTATIVE HAS COMPLETED A PRE-CONSTRUCTION MEETING WITH THE INSTALLERS.
- 2. STORMTECH SC-310 & SC-740 CHAMBERS SHALL BE INSTALLED IN ACCORDANCE WITH THE "STORMTECH SC-310/SC-740/DC-780 CONSTRUCTION GUIDE".
- 3. CHAMBERS ARE NOT TO BE BACKFILLED WITH A DOZER OR AN EXCAVATOR SITUATED OVER THE STORMTECH RECOMMENDS 3 BACKFILL METHODS:
 - STONESHOOTER LOCATED OFF THE CHAMBER BED. BACKFILL AS ROWS ARE BUILT USING AN EXCAVATOR ON THE FOUNDATION STONE OR
 - BACKFILL FROM OUTSIDE THE EXCAVATION USING A LONG BOOM HOE OR EXCAVATOR.
- 4. THE FOUNDATION STONE SHALL BE LEVELED AND COMPACTED PRIOR TO PLACING CHAMBERS
- 5. JOINTS BETWEEN CHAMBERS SHALL BE PROPERLY SEATED PRIOR TO PLACING STONE.
- 6. MAINTAIN MINIMUM 6" SPACING BETWEEN THE CHAMBER ROWS.
- 7. EMBEDMENT STONE SURROUNDING CHAMBERS MUST BE A CLEAN, CRUSHED, ANGULAR STONE
- 8. THE CONTRACTOR MUST REPORT ANY DISCREPANCIES WITH CHAMBER FOUNDATION MATERIALS BEARING CAPACITIES TO THE SITE DESIGN ENGINEER.
- ADS RECOMMENDS THE USE OF "FLEXSTORM CATCH IT" INSERTS DURING CONSTRUCTION FOR ALL INLETS TO PROTECT THE SUBSURFACE STORMWATER MANAGEMENT SYSTEM FROM CONSTRUCTION SITE RUNOFF.


NOTES FOR CONSTRUCTION EQUIPMENT


- 1. STORMTECH SC-310 & SC-740 CHAMBERS SHALL BE INSTALLED IN ACCORDANCE WITH THE "STORMTECH SC-310/SC-740/DC-780 CONSTRUCTION GUIDE".
- 2. THE USE OF CONSTRUCTION EQUIPMENT OVER SC-310 & SC-740 CHAMBERS IS LIMITED:
 - NO EQUIPMENT IS ALLOWED ON BARE CHAMBERS. NO RUBBER TIRED LOADERS, DUMP TRUCKS, OR EXCAVATORS ARE ALLOWED UNTIL PROPER
 - FILL DEPTHS ARE REACHED IN ACCORDANCE WITH THE "STORMTECH SC-310/SC-740/DC-780 CONSTRUCTION GUIDE".
 - WEIGHT LIMITS FOR CONSTRUCTION EQUIPMENT CAN BE FOUND IN THE "STORMTECH SC-310/SC-740/DC-780 CONSTRUCTION GUIDE".
- 3. FULL 36" (900 mm) OF STABILIZED COVER MATERIALS OVER THE CHAMBERS IS REQUIRED FOR DUMP TRUCK TRAVEL OR DUMPING.


USE OF A DOZER TO PUSH EMBEDMENT STONE BETWEEN THE ROWS OF CHAMBERS MAY CAUSE DAMAGE TO THE CHAMBERS AND IS NOT AN ACCEPTABLE BACKFILL METHOD. ANY CHAMBERS


> SHEET OF 1

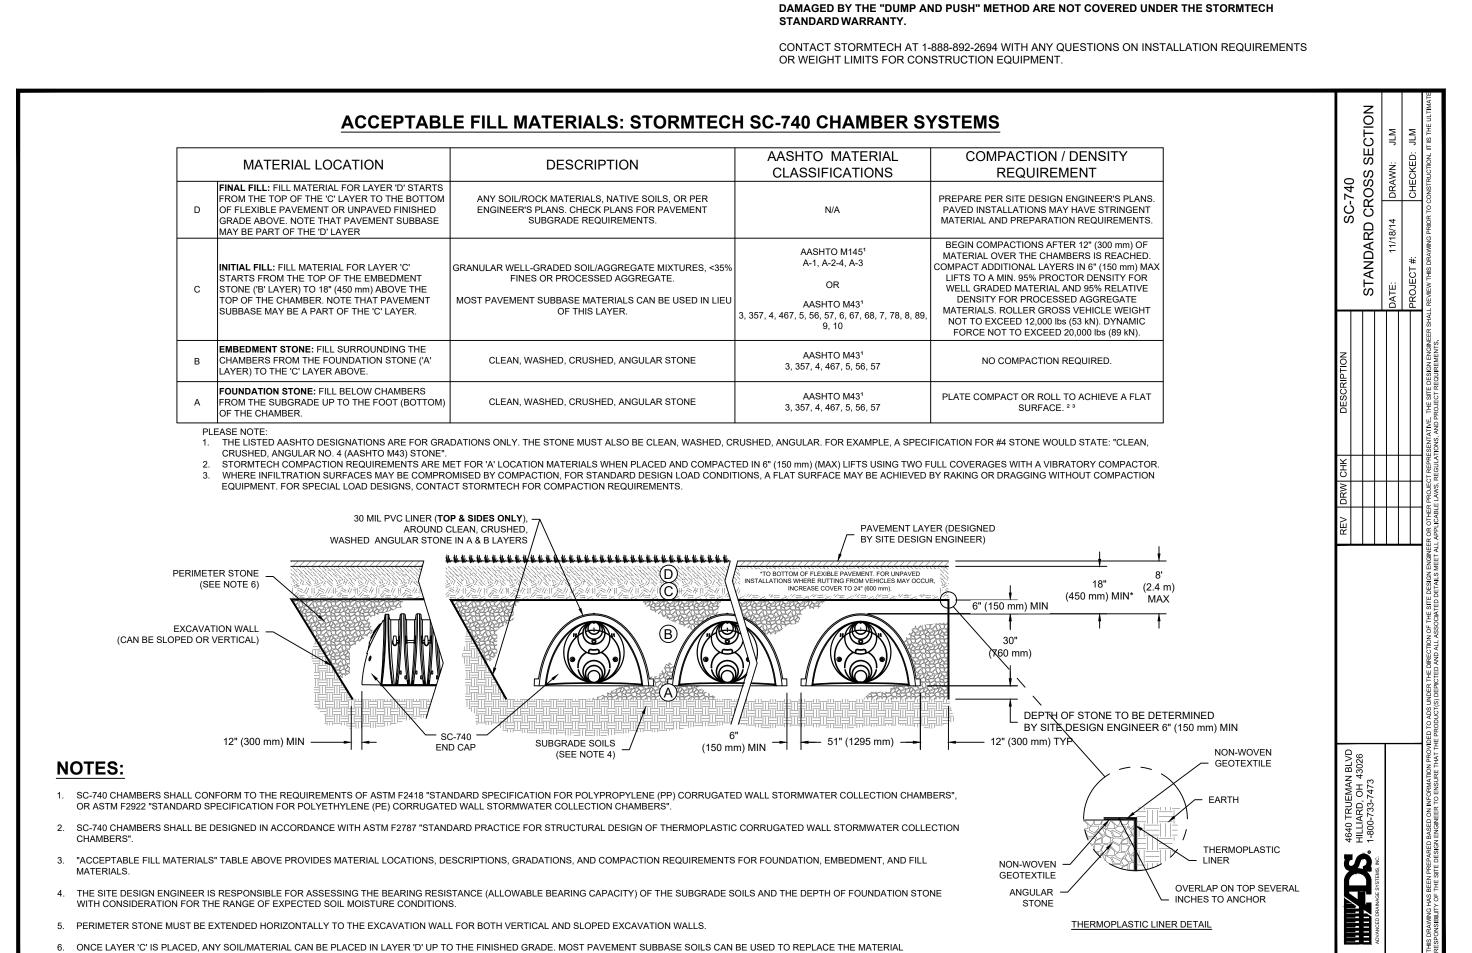

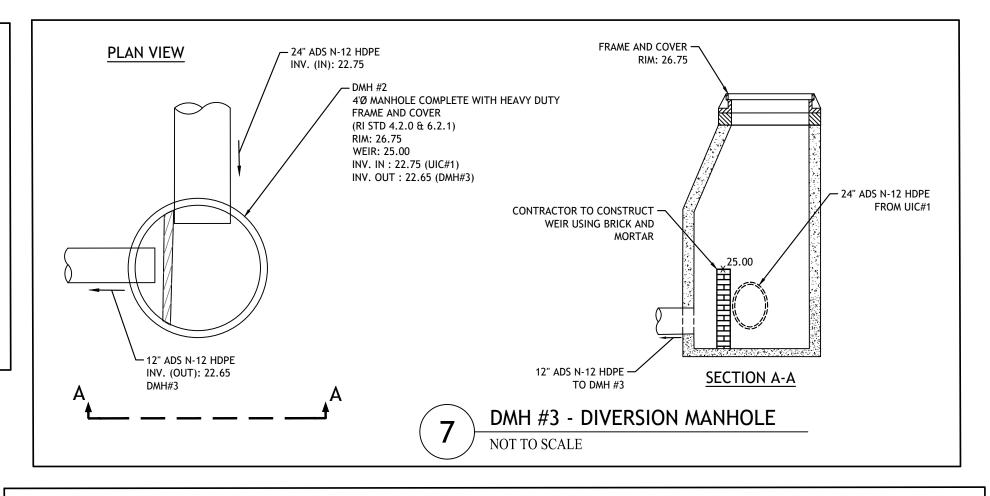

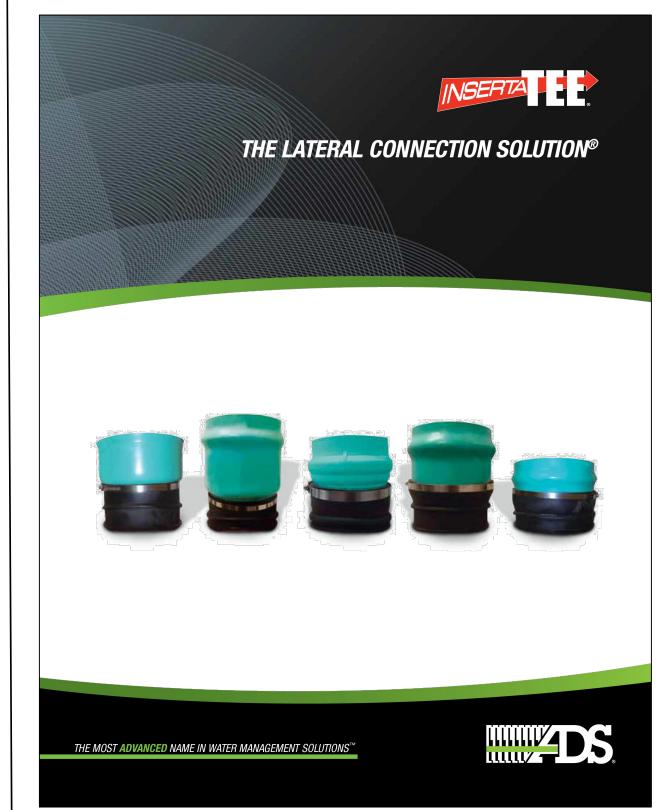

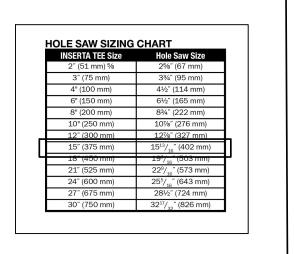

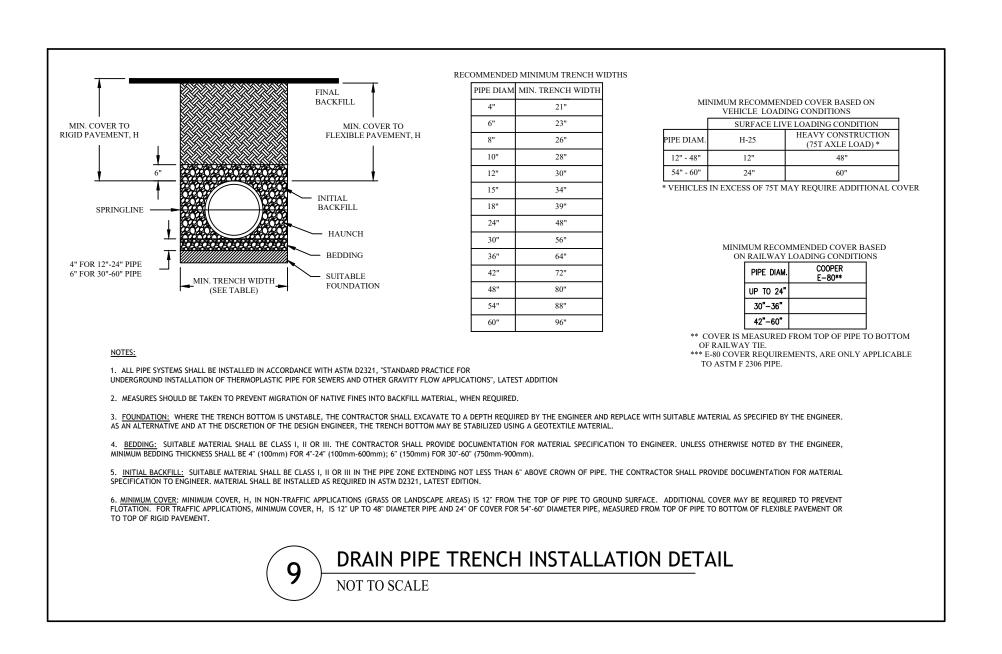

PROJECT NO: 19-19s PRELIMINARY, NOT FOR CONSTRUCTION

NOV. 2023

REGISTERED

12/5/2023

PROFESSIONAL

TURE

DRAINAGE **DETAILS**

NO. DATE. DESCRIPTION

COMMENTS

1 12/5/23 PLANNING

ESIGNED BY: WLMJR

DRAWN BY: SD/SEP

CHECKED BY: JAC

SHEET 5 OF 5

STORMTECH SC-740 CROSS SECTION DETAIL



