


PROJECT REVIEW

1. CASE 24.002, 92 WILLIAMS STREET, Caleb Roffee House, 1824 (COLLEGE HILL)

Federal; 2½-stories, clapboard, gable roof; Five-bay facade; central capped doorway reached by a double flight of wooden steps.
CONTRIBUTING



Arrow indicates 92 Williams Street.

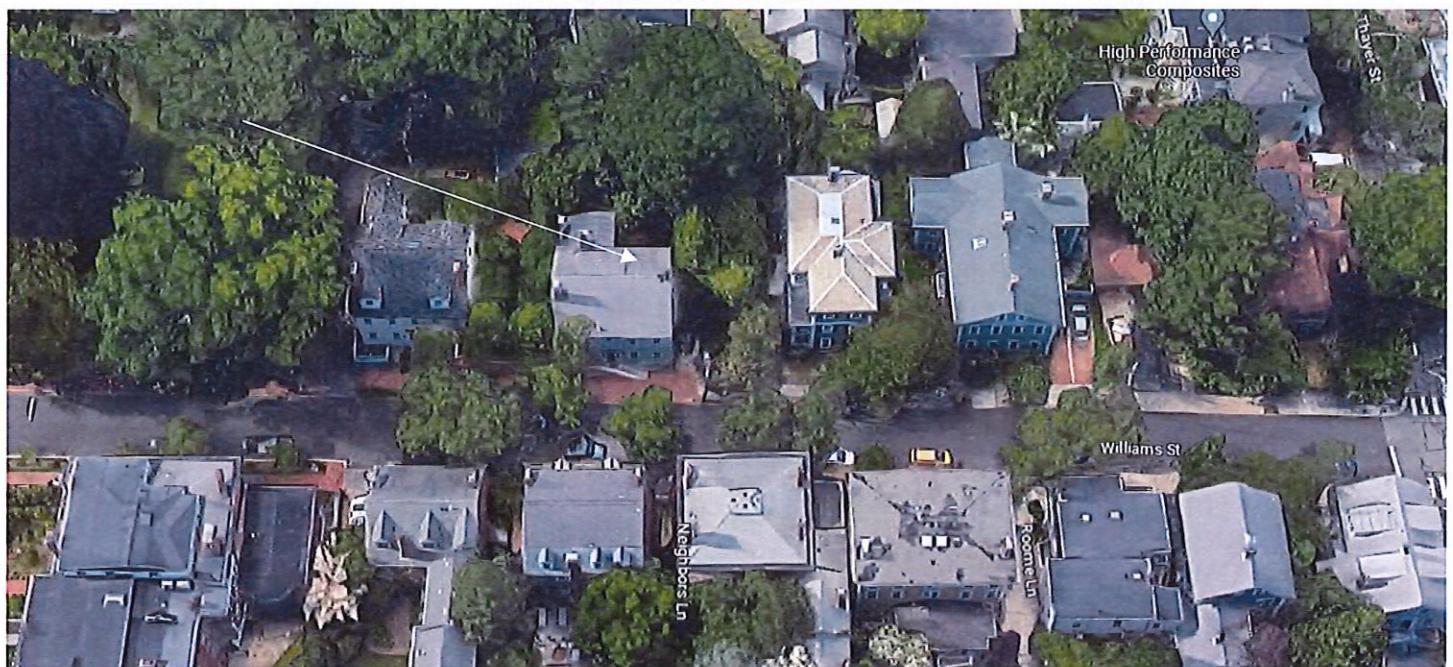

Arrow indicates project location, looking north.

Applicant/Contractor: Rooftop Power, Dan Fisher, 275 West Natick Rd, Suite 800, Warwick, RI 02886

Owner: David Keefe, 92 Williams Street, Providence, RI 02906

Proposal: The scope of work proposed consists of Minor Alterations and includes:

- the installation of 10 solar panels to the front (South) slope of the side-gable roof.

Issues: The following issues are relevant to this application:

- This is a new filing. This application was heard by the Commission at the April 25, 2022 meeting. At that meeting the Commission denied the application as submitted. The application has changed substantially and may be reheard by the Commission. The application as submitted will not be visible from the public rights-of-way;
- The modifications as proposed meets Minor Alterations: Solar Energy Systems Guidelines, Section 2, in the following manner: Panel layout shall be sympathetic or appropriate to design and scale of building. Rectangular configurations are preferred, with ample setback from edge of roof, dormers, chimneys, etc. (2.A); Panels shall be installed parallel to the existing roof slope and matched as closely as possible to the roof plane (2.B); Panels shall be installed without destroying or replacing original or historic materials or significantly compromising or altering the building's structural integrity (2.C); Panels shall be compatible in color to existing roofing insofar as possible (2.D); Installation of panels shall be as inconspicuous as possible when viewed from public right-of-way (2.E); Installation shall be reversible. Panels shall be removed when no longer viable or functioning and roofing restored to pre-existing conditions (2.F); and,
- Plans, specifications and pictures have been submitted.

Recommendations: The staff recommends the PHDC make the following findings of fact:

- a) 72 Williams Street is a structure of historical and architectural significance that contributes to the significance of the College Hill local historic district, having been recognized as a contributing structure to the College Hill National Historic Landmarks District;
- b) The modifications as proposed meets Minor Alterations: Solar Energy Systems Guidelines, Section 2, and the application is considered complete; and,
- c) The work as proposed is in accord with PHDC Standards 8 & 9 as follows: 8) the work will be done so that it does not destroy the historic character of the property or the district as they are not on the primary elevation and will not be visible from the public rights-of-way; and, 9) Whenever possible... alterations to structures shall be done in such a manner that if removed in the future, the essential form and integrity of the structure and the site will be unimpaired.

Staff recommends a motion be made stating that: The application is considered complete. 72 Williams Street is a structure of historical and architectural significance that contributes to the significance of the College Hill local historic district, having been recognized as a contributing structure to the College Hill National Historic Landmarks District. The Commission grants Final Approval of the proposal as submitted as the proposed alteration is appropriate having determined that the proposed alteration does not destroy the historic character of the property or the district and are historically and architecturally compatible with the property and district. The proposed alteration meets Minor Alterations: Solar Energy Systems Guidelines, Section 2, is reversible and will not have an adverse effect on the property or district as they are not on the primary elevation and will not be visible from the public rights-of-way (Standards 8 & 9), and the recommendations in the staff report, with staff to review any additional required details.

Google Maps

94 Williams St



Providence, Rhode Island

Google Street View


Nov 2022

See more dates

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ROOF TOP POWER
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Warwick, RI 02886
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HCF-A001022

Reviewed and approved

प्राचीनकालीन शिल्पों की संरक्षण, प. ए.	प्राचीनकालीन शिल्पों की संरक्षण, प. ए.
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INITIAL RELEASE:	04/07/2025
UR	

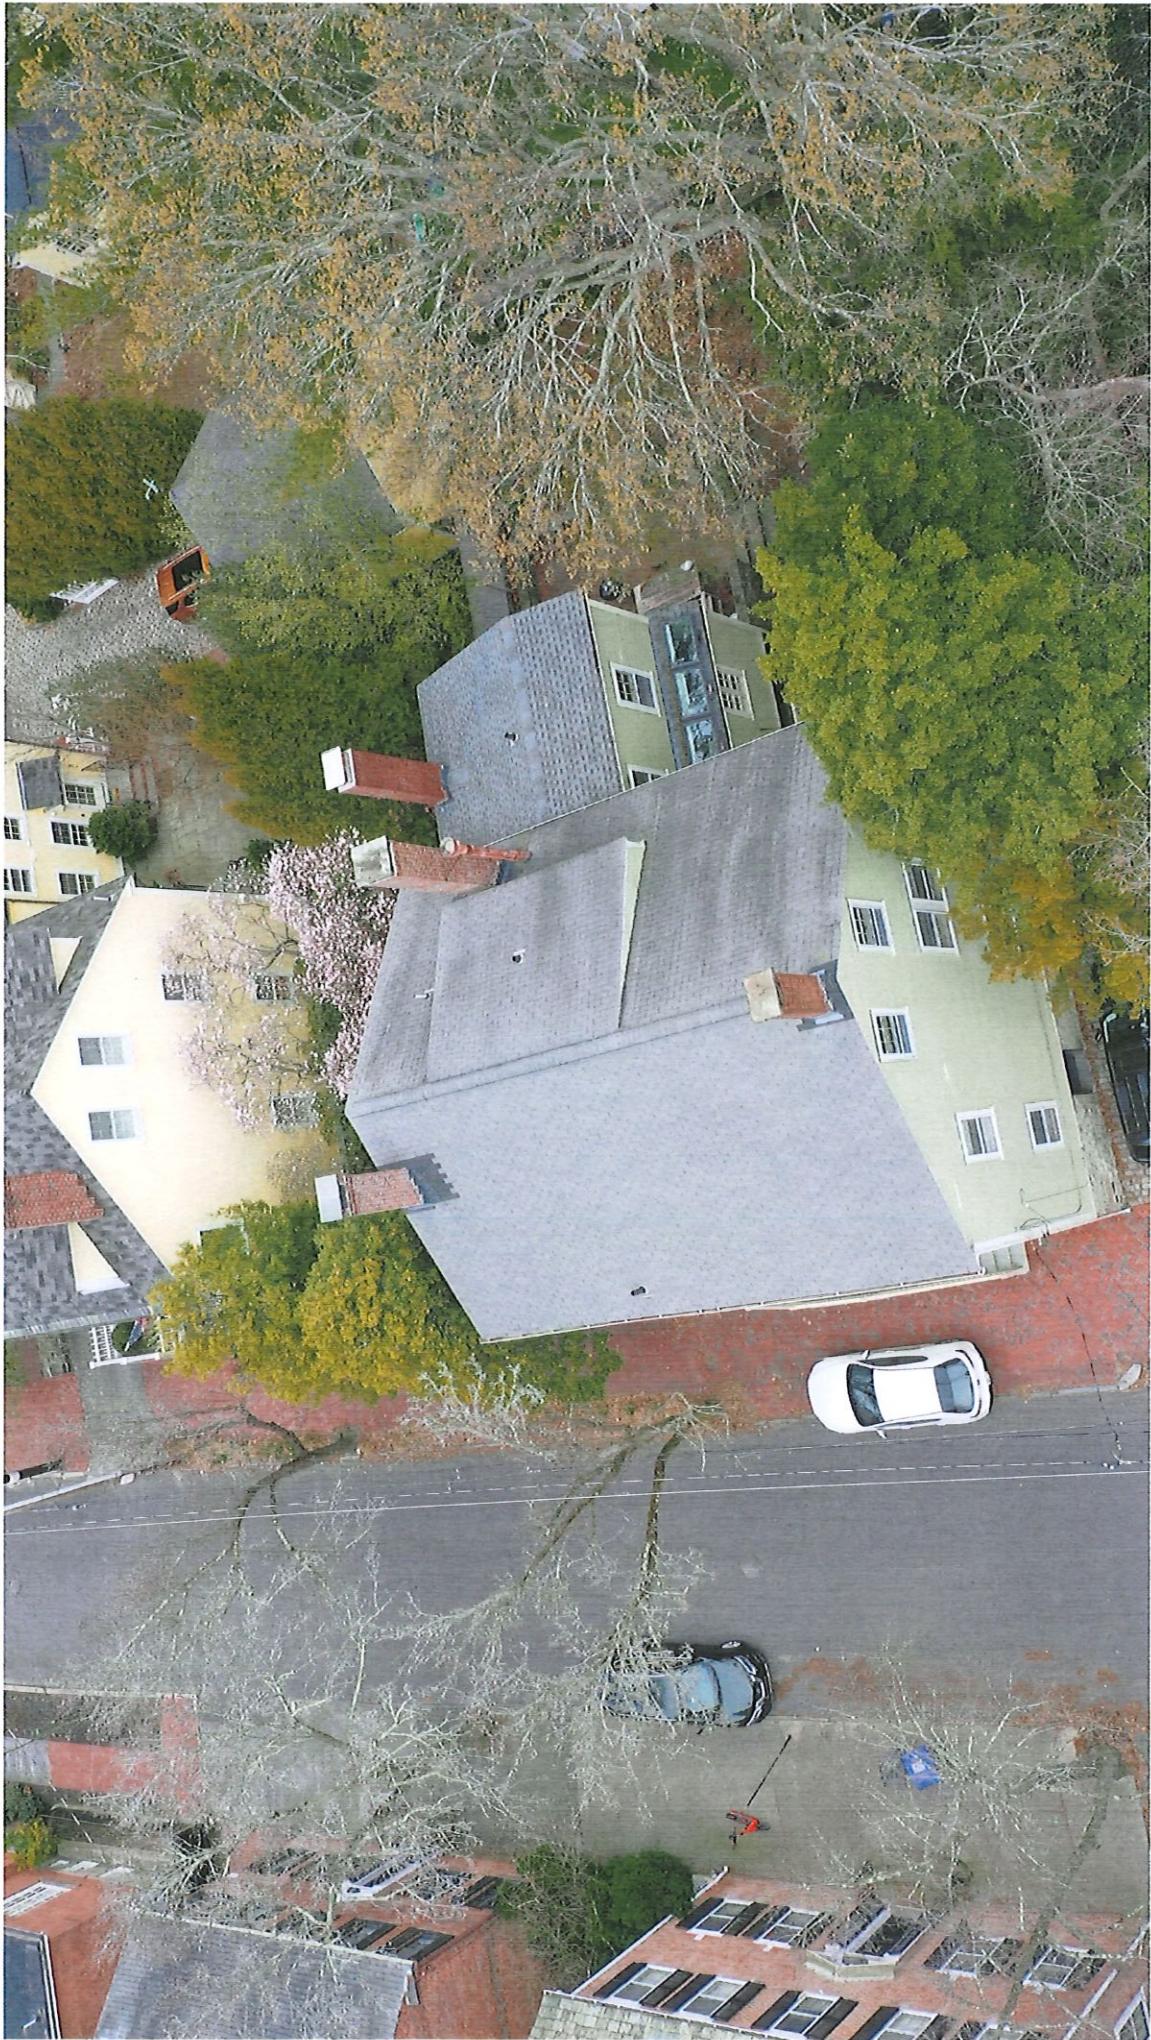PROJECT NAME

DAVID J KEEFE
92 WILLIAMS ST APT 1,
PROVIDENCE, RI 02906 USA
APN# PROVM16L203
UTILITY: RHODE ISLAND ENER
AHL: CITY OF PROVIDENCE

SHEET NAME
**SITE PLAN WITH
ROOF PLAN**

ANSI B
11" x 17"
SHEET SIZE

SHEET NUMBER
PV-1

ROOF ACCESS POINT SHALL BE LOCATED IN AREAS THAT DO NOT REQUIRE THE PLACEMENT OF GROUND LADDERS OVER OPENINGS SUCH AS WINDOWS OR DOORS, AND LOCATED AT STRONG POINTS OF BUILDING CONSTRUCTION IN LOCATIONS WHERE THE ACCESS POINT DOES NOT CONFLICT WITH OVERHEAD OBSTRUCTIONS SUCH AS TREE LIMBS, WIRES OR SIGNS.

LEGEND

<u>LEGEND</u>	
UM	UTILITY METER
MSF	MAIN SERVICE PANEL
ACD	FUSED AC DISCONNECT
ACDF	NON-FUSED AC DISCONNECT
C3	ENPHASE IQ COMBINER 4
J3	JUNCTION BOX
PROPERTY	
	CONDUIT
	GATE
	FENCE
	TREES

NOTE: ALL ELECTRICAL EQUIPMENT, INVERTERS,
DISCONNECTS, MAIN SERVICE PANELS, ETC. SHALL
NOT BE INSTALLED WITHIN 3' OF THE GAS METERS'
SUPPLY OR DEMAND PIPING.

PHOTOVOLTAIC MODULES
JA SOLAR JAM54S31-395/MR (395W)

 44.64"
 67.79"
 70.00"

WILLIAMS ST

SCALE: 3/32" = 1'-0"

SITE PLAN WITH ROOF PLAN

