

SITE IMPROVEMENTS AT ROGER WILLIAMS PARK EVENT PAVILION



HONORABLE
BRETT P. SMILEY
MAYOR

WENDY NILSSON
SUPERINTENDENT OF PARKS

JUAN PICHARDO
CITY COUNCILOR



PROVIDENCE
PARKS DEPARTMENT
DALRYMPLE BOATHOUSE
ROGER WILLIAMS PARK
PROVIDENCE, RI 02905

COPYRIGHT (C) CITY OF
PROVIDENCE PARKS
DEPARTMENT, ALL RIGHTS
RESERVED 2023.

NO PART OF THIS DOCUMENT MAY BE
REPRODUCED, STORED IN A RETRIEVAL
SYSTEM OR TRANSMITTED IN ANY FORM OR
BY ANY MEANS, ELECTRONIC,
MECHANICAL, PHOTOCOPIING,
RECORDING OR OTHERWISE WITHOUT THE
PRIOR WRITTEN PERMISSION OF THE CITY
OF PROVIDENCE PARKS DEPARTMENT. ANY
MODIFICATIONS TO THIS DOCUMENT
WITHOUT THE WRITTEN PERMISSION OF
THE CITY OF PROVIDENCE PARKS
DEPARTMENT SHALL RENDER IT INVALID
AND UNUSABLE.

GENERAL CONSTRUCTION NOTES

- INFORMATION FOR THE EXISTING CONDITIONS PLAN WAS OBTAINED FROM GIS, AERIAL IMAGERY, FIELD OBSERVATION (AND XYZ SURVEY, IF APPLICABLE). ALL EXISTING CONDITIONS ARE TO BE CONSIDERED APPROXIMATE. THIS IS NOT A REGISTERED SURVEY.
- ANY ERRORS OR DISCREPANCIES ON THE DRAWINGS, SHOP DRAWINGS, AND DETAILS ARE TO BE BROUGHT TO THE ATTENTION OF THE OWNER'S REPRESENTATIVE BEFORE THE WORK HAS COMMENCED.
- THE CONTRACTOR IS RESPONSIBLE FOR FIELD VERIFICATION OF ALL LOCATIONS AND DIMENSIONS. DISCREPANCIES BETWEEN LAYOUT DIMENSIONS ON PLANS AND ACTUAL MEASUREMENTS IN FIELD ARE TO BE REPORTED TO THE OWNER'S REPRESENTATIVE BEFORE CONSTRUCTION BEGINS.
- THE CONTRACTOR SHALL NOTIFY THE OWNER'S REPRESENTATIVE PRIOR TO DEMOLITION OR INSTALLATION OF ANY PORTION OF THE SITE WORK.
- THE CONTRACTOR SHALL STAKE OUT ALL LAYOUTS OF PROPOSED WORK FOR APPROVAL BY THE OWNER'S REPRESENTATIVE PRIOR TO COMMENCING WORK.
- THE CONTRACTOR SHALL BE RESPONSIBLE FOR ESTABLISHING AND MAINTAINING ALL CONTROL POINTS AND BENCHMARKS DURING CONSTRUCTION INCLUDING BENCHMARK LOCATIONS AND ELEVATIONS AT CRITICAL AREAS. THE LOCATION OF ALL CONTROL POINTS AND BENCHMARKS SHALL BE COORDINATED WITH THE OWNER'S REPRESENTATIVE.
- UNLESS OTHERWISE SPECIFIED ON THE PLANS AND DETAILS/SPECIFICATIONS, ALL SITE CONSTRUCTION MATERIALS AND METHODOLOGIES ARE TO CONFORM TO THE MOST RECENT VERSION OF THE RHODE ISLAND DEPARTMENT OF TRANSPORTATION STANDARD SPECIFICATIONS (THE RHODE ISLAND DEPARTMENT OF TRANSPORTATION STANDARD SPECIFICATIONS FOR ROAD AND BRIDGE CONSTRUCTION 2015 EDITION).
- CONSTRUCTION SHALL BE PERFORMED IN ACCORDANCE WITH APPLICABLE LAWS AND REGULATIONS REGARDING NOISE, VIBRATION, DUST, SEDIMENTATION CONTAINMENT, AND TRENCH WORK.
- THE CONTRACTOR SHALL RESTORE ALL SURFACES EQUAL TO THEIR ORIGINAL CONDITION AFTER CONSTRUCTION IS COMPLETE. AREAS NOT DISTURBED BY CONSTRUCTION SHALL BE LEFT NATURAL. THE CONTRACTOR SHALL TAKE CARE TO PREVENT DAMAGE TO SHRUBS, TREES, AND OTHER LANDSCAPING OR NATURAL FEATURES, WHEREAS THE PLANS DO NOT SHOW ALL LANDSCAPING FEATURES. EXISTING CONDITIONS MUST BE VERIFIED BY THE CONTRACTOR IN ADVANCE OF THE WORK.
- ALL UNPAVED AREAS DISTURBED BY THE WORK SHALL HAVE A MINIMUM OF 4-INCHES OF LOAM INSTALLED AND SEEDED WITH GRASS SEED AS SHOWN ON THE PLAN AND/OR DIRECTED BY THE LANDSCAPE ARCHITECT. THE CONTRACTOR SHALL BE RESPONSIBLE FOR WATERING ANY LOAM AND SEEDED AREAS UNTIL LAWN GROWTH IS ESTABLISHED AND APPROVED BY THE LANDSCAPE ARCHITECT AND/OR OWNER'S REPRESENTATIVE.
- THE CONTRACTOR SHALL REGULARLY INSPECT THE PERIMETER OF THE PROPERTY TO CLEAN UP AND REMOVE ANY LOOSE CONSTRUCTION DEBRIS BEFORE IT LEAVES THE SITE. ALL DEMOLITION DEBRIS SHALL BE PROMPTLY REMOVED FROM THE SITE TO AN APPROVED DUMP SITE. ALL TRUCKS LEAVING THE SITE SHALL BE COVERED.
- CONCRETE TRUCKS SHALL NOT BE WASHED ONSITE. ANY CEMENT OR CONCRETE DEBRIS LEFT IN THE DISTURBED AREA SHALL BE REMOVED BY HAND AT THE CONTRACTOR'S EXPENSE.
- IF ANY DEVIATION OR ALTERATION OF THE WORK PROPOSED ON THESE DRAWINGS IS REQUIRED, THE CONTRACTOR IS TO IMMEDIATELY CONTACT AND COORDINATE WITH THE LANDSCAPE ARCHITECT AND THE OWNER'S REPRESENTATIVE.
- AT THE END OF CONSTRUCTION, THE CONTRACTOR SHALL REMOVE ALL CONSTRUCTION DEBRIS AND SURPLUS MATERIAL FROM THE SITE. A THOROUGH INSPECTION OF THE WORK PERIMETER IS TO BE MADE AND ALL DISCARDED MATERIALS, BLOWN OR WATER CARRIED DEBRIS, SHALL BE COLLECTED AND REMOVED FROM THE SITE.
- THE CONTRACTOR IS RESPONSIBLE FOR SECURING THE SITE FOR THE SAFETY OF THE GENERAL PUBLIC AND TO PROTECT PROPERTY AGAINST VANDALISM AND THEFT.
- THE CONTRACTOR MUST OBTAIN ALL REQUIRED CITY, STATE AND FEDERAL PERMITS.
- THE PROVIDENCE PARKS DEPARTMENT ASSUMES NO RESPONSIBILITY IF THE WORK IS NOT INSTALLED AS PER THE PLANS OR IF FIELD CHANGES ARE MADE WITHOUT THE KNOWLEDGE AND APPROVAL OF THE OWNER'S REPRESENTATIVE.

EROSION & SEDIMENT CONTROL NOTES

- THE SITE CONSTRUCTION FOREMAN SHALL BE DESIGNATED AS THE ON-SITE PERSONNEL RESPONSIBLE FOR THE DAILY INSPECTION AND MAINTENANCE OF ALL ESC MEASURES AND SHALL IMPLEMENT ALL NECESSARY MEASURES TO CONTROL EROSION AND PREVENT SEDIMENT FROM LEAVING THE SITE.
- THE CONTRACTOR SHALL INSTALL ALL ESC MEASURES AS SHOWN ON THE DESIGN PLANS AND AS DETERMINED NECESSARY IN THE FIELD BY OWNER'S REPRESENTATIVE BEFORE ANY CONSTRUCTION ACTIVITIES ARE TO BEGIN. THESE MEASURES SHALL BE CHECKED, MAINTAINED/REPLACED AS NECESSARY DURING THE ENTIRE CONSTRUCTION PERIOD OF THE PROJECT. SUCH MEASURES SHALL REPRESENT THE LIMIT OF WORK. WORKERS SHALL BE INFORMED THAT NO CONSTRUCTION ACTIVITY IS TO OCCUR BEYOND THE LIMIT OF WORK AT ANY TIME THROUGH THE CONSTRUCTION PERIOD.
- A MINIMUM SURPLUS OF 100 FEET OF EROSION CONTROL BARRIER (SILT FENCE&/OR SILT SOCK) SHALL BE STOCKPILED ONSITE AT ALL TIMES.
- THE CONTRACTOR SHALL PROTECT THE ADJACENT AREA FROM SEDIMENTATION DURING PROJECT CONSTRUCTION OPERATIONS.
- A CONSTRUCTION EXIT SHALL BE CONSTRUCTED TO SHED DIRT FROM CONSTRUCTION VEHICLE TIRES. THE CONSTRUCTION EXIT SHALL BE REPLACED/CLEANED AS NEEDED TO MAINTAIN ITS EFFECTIVENESS.
- THE LIMIT OF ALL CLEARING, GRADING AND DISTURBANCES SHALL BE KEPT TO A MINIMUM WITHIN THE PROPOSED AREA OF CONSTRUCTION. THE CONTRACTOR SHALL PHASE THE SITE WORK IN A MANNER TO MINIMIZE AREAS OF EXPOSED SOIL.
- IT IS THE CONTRACTOR'S RESPONSIBILITY TO MONITOR LOCAL WEATHER REPORTS DURING CONSTRUCTION AND PRIOR TO SCHEDULING EARTHMOVING OR OTHER CONSTRUCTION ACTIVITIES WHICH WILL LEAVE LARGE DISTURBED AREAS UNSTABILIZED. IF INCLEMENT WEATHER IS PREDICTED, THE CONTRACTOR SHALL USE THEIR BEST PROFESSIONAL JUDGEMENT AND SHALL BE RESPONSIBLE FOR ENSURING THAT NECESSARY EROSION CONTROL DEVICES ARE INSTALLED AND FUNCTIONING PROPERLY TO MINIMIZE EROSION FROM ANY IMPENDING WEATHER EVENTS.
- SOIL ESC MEASURES SHALL BE INSPECTED AND MAINTAINED ON A WEEKLY BASIS AND AFTER EACH RAINFALL EVENT OF 0.25 INCH OR GREATER DURING CONSTRUCTION TO ENSURE THAT THE ESC MEASURES ARE INTACT AND FUNCTIONING PROPERLY. IDENTIFIED DEFICIENCIES SHALL BE CORRECTED IMMEDIATELY NO LATER THAN 24 HOURS AFTER IDENTIFICATION.
- SOIL STOCKPILES LEFT OVERNIGHT SHALL BE SURROUNDED ON THEIR PERIMETERS WITH SILT SOCK.
- DISTURBED AREAS AND SLOPES SHALL NOT BE LEFT UNATTENDED OR EXPOSED FOR EXCESSIVE PERIODS OF TIME SUCH AS THE INACTIVE WINTER SEASON. THE CONTRACTOR SHOULD PROVIDE APPROPRIATE STABILIZATION PRACTICES ON ALL DISTURBED AREAS AS SOON AS POSSIBLE BUT NOT MORE THAN 14 DAYS AFTER THE CONSTRUCTION ACTIVITY IN THAT AREA HAS TEMPORARILY OR PERMANENTLY CEASED. TEMPORARY AREAS HAVING A SLOPE GREATER THAN 3:1 SHALL BE REINFORCED WITH EROSION BLANKETS OR APPROVED EQUAL UNTIL THE SITE IS PROPERLY STABILIZED. TEMPORARY SWALES MAY ALSO BE REQUIRED IF DETERMINED NECESSARY IN THE FIELD BY OWNER'S REPRESENTATIVE.
- THE CONTRACTOR SHALL CONTAIN ALL SEDIMENT ONSITE. ALL EXITS FROM THE SITE WILL BE SWEEP AS NECESSARY INCLUDING ANY SEDIMENT TRACKING. PAVED AREAS SHALL BE SWEEP AS NEEDED TO REMOVE SEDIMENT AND POTENTIAL POLLUTANTS WHICH MAY ACCUMULATE DURING SITE WORK.
- ACCUMULATED SEDIMENT SHALL BE REMOVED FROM ALL ESC MEASURES AND DISPOSED OF IN A PRE-APPROVED LOCATION BY THE CONTRACTOR.
- DUST SHALL BE CONTROLLED BY WATERING OR OTHER APPROVED METHODS AS NECESSARY.

PLANTING NOTES

- ALL NEW PLANT MATERIALS SHALL CONFORM TO THE MINIMUM GUIDELINES ESTABLISHED FOR NURSERY STOCK PUBLISHED BY THE AMERICAN ASSOCIATION OF NURSERYMEN, INC. IN ADDITION, ALL NEW PLANT MATERIAL FOR THE PROJECT SHALL BE OF SPECIMEN QUALITY.
- ALL NEW PLANTS TO BE BALLED AND BURLAPPED OR CONTAINER GROWN, UNLESS OTHERWISE NOTED ON THE PLANT LIST.
- THE CONTRACTOR SHALL SUPPLY ALL NEW PLANT MATERIAL IN QUANTITIES SUFFICIENT TO COMPLETE THE PLANTING SHOWN ON THE DRAWINGS.
- ANY PROPOSED SUBSTITUTIONS OF PLANT SPECIES SHALL BE MADE WITH PLANTS OF EQUIVALENT OVERALL FORM, HEIGHT, BRANCHING HABIT, FLOWER, LEAF, COLOR, FRUIT AND CULTURE, AND ONLY AFTER WRITTEN APPROVAL OF THE LANDSCAPE ARCHITECT.
- ALL NEW PLANTS SHALL BE TAGGED AND APPROVED BY THE LANDSCAPE ARCHITECT AT THE NURSERY PRIOR TO DIGGING OR DELIVERY TO THE SITE.
- CONTRACTOR SHALL LOCATE AND VERIFY ALL EXISTING UTILITY LINES PRIOR TO PLANTING AND SHALL REPORT ANY CONFLICTS TO THE LANDSCAPE ARCHITECT.
- STAKE LOCATIONS OF ALL PROPOSED PLANTING FOR APPROVAL BY THE LANDSCAPE ARCHITECT PRIOR TO THE COMMENCEMENT OF PLANTING. INDIVIDUAL STAKES SHALL BE PLACED FOR TREES AND SHRUBS. EDGE OF PLANTING BEDS SHALL BE PAINTED. NOTIFY LANDSCAPE ARCHITECT 24 HOURS PRIOR TO DESIRED APPROVAL.
- ALL NEW PLANTS SHALL BE SUPPLIED AND INSTALLED DURING THE PERIODS OF APRIL 1 - JUNE 15 AND/OR SEPTEMBER 1 - NOVEMBER 15 PER SPECIFICATIONS.
- PREPARE ALL INDIVIDUAL TREE PITS AND SHRUB PLANTING BEDS TO A MINIMUM DEPTH OF EIGHTEEN INCHES (1'8") WITH SPECIFIED PLANTING MIX: 50% SCREENED TOPSOIL, 40% EXISTING SOIL AND 10% COMPOST. BLEND COMPOST INTO TOP 4" OF SOIL. PLANTING MIX SHALL BE FREE OF LUMPS, STONES, PLANTS, ROOTS, AND OTHER FOREIGN MATTER.
- ALL SHRUB BEDS AND INDIVIDUAL TREE PITS SHALL RECEIVE THREE (3) INCHES OF BARK MULCH PER SPECIFICATIONS. PERENNIAL AND GROUNDCOVER BEDS SHALL RECEIVE TWO INCHES (2"). PROVIDE LANDSCAPE ARCHITECT WITH SAMPLE FOR APPROVAL.
- ALL BURLAP, TWINE AND WIRE SHALL BE COMPLETELY REMOVED OR CUT AWAY AT TIME OF INSTALLATION.
- PRUNE TREES IN ACCORDANCE WITH THE SPECIFICATIONS.
- PLANT WARRANTY SHALL BE FOR ONE FULL GROWING SEASON FROM THE TIME OF SUBSTANTIAL COMPLETION.
- LANDSCAPE CONTRACTOR SHALL BE RESPONSIBLE FOR REPLACING ALL DAMAGED, STOLEN, DEAD, DECLINING OR LOST MATERIAL UNTIL COMPLETION OF MAINTENANCE PERIODS OR GUARANTEE PERIODS.
- IF NO IRRIGATION SYSTEM IS PLANNED, AN APPROPRIATE WATERING SCHEDULE SHALL BE ESTABLISHED BY THE LANDSCAPE CONTRACTOR FOR ALL PLANT MATERIAL BASED UPON PLANT SPECIES REQUIREMENTS AND PROVIDED IN WRITING TO THE LANDSCAPE ARCHITECT AND OWNER FOR REVIEW AND APPROVAL. THE APPROVED SCHEDULE SHOULD BE FOLLOWED UNTIL COMPLETION OF PLANT MAINTENANCE PERIODS OR WARRANTY PERIODS.
- ALL VEGETATION AND DEBRIS SHALL BE REMOVED FROM PROPOSED PLANTING AREAS PRIOR TO PLANTING AND BACKFILLING. CONTRACTOR SHALL REMOVE ALL WEEDS AND DEBRIS FROM SITE AS WORK PROGRESSES AND UNTIL COMPLETION OF PLANT MAINTENANCE PERIODS OR WARRANTY PERIODS.
- ALL AREAS TO BE SEEDED OR SODDED SHALL RECEIVE SIX INCHES (6") OF LOAM, MEASURED AFTER INSTALLATION, PRIOR TO SEEDING.
- ALL EXISTING LAWN AREAS DESIGNED TO REMAIN SHALL BE AERATED, FERTILIZED AND OVERSEEDED, AS DIRECTED BY THE LANDSCAPE ARCHITECT.
- IN ADDITION TO LOCATIONS DEFINED FOR SEED ON THE PLANTING PLAN, THE CONTRACTOR SHALL BE RESPONSIBLE FOR SEEDING ANY DISTURBED AREAS.
- A DETAILED PLANT MAINTENANCE MANUAL SHALL BE ESTABLISHED BY THE LANDSCAPE CONTRACTOR FOR ALL PLANT MATERIAL BASED UPON PLANT SPECIES REQUIREMENTS AND PROVIDED IN WRITING TO THE LANDSCAPE ARCHITECT AND OWNER FOR REVIEW AND APPROVAL. INFORMATION THEREIN SHALL INCLUDE REQUIRED PRUNING SCHEDULE, FERTILIZING AND PROPOSED INTEGRATED PEST MANAGEMENT (IPM) AS NECESSARY. THE APPROVED MAINTENANCE SHOULD BE FOLLOWED UNTIL COMPLETION OF PLANT MAINTENANCE PERIODS OR WARRANTY PERIODS.
- LANDSCAPE CONTRACTOR IS RESPONSIBLE FOR MAINTAINING CLOSE COORDINATION WITH OWNER, GENERAL CONTRACTOR, RELATED SUBCONTRACTORS, LANDSCAPE ARCHITECT, AND ALL SITE WORK RELATED ITEMS.

SHEET SCHEDULE

SHEET #	NAME
L-1	COVER SHEET
L-2	EXISTING CONDITIONS/DEMOLITION PLAN
L-3	GRADING/MATERIALS PLAN
L-4	LAYOUT PLAN
L-5	LIGHTING PLAN
L-6	PLANTING PLAN
L-7	CONSTRUCTION DETAILS 1
L-8	CONSTRUCTION DETAILS 2

DATE	NO.	REVISION

COVER SHEET
 SITE IMPROVEMENTS AT ROGER WILLIAMS PARK EVENT PAVILION
 1000 ELMWOOD AVE, PROVIDENCE, RI
FILE: RWBC-23-01-PLANS-2023.dwg

DATE:	DECEMBER 21, 2023
SCALE:	NTS
DRAWN BY:	SG
CHECKED/ APPROVED:	BB
SHEET NO.:	L-1
	1 OF 8

DEMOLITION PLAN SPECIAL NOTES

- 1 TREE & SHRUB PROTECTION
- 2 R&D (REMOVE & DISPOSE) EX. STONEDUST PATH
- 3 R&S (REMOVE & STOCKPILE) CONCRETE PAVERS AND COBBLES TO LIMITS SHOWN
- 4 R&S GRANITE CURB
- 5 R&D PAVERS, TRENCH DRAIN & DRAIN PIPE
- 6 R&S COBBLESTONE EDGING & ADJACENT ROW OF SQUARE CONCRETE PAVERS
- 7 R&D METAL EDGING, R&S RIVERSTONE. WASH OR SCREEN TO REMOVE SOIL & DEBRIS.
- 8 **ADD ALT #1:**
STRIP & REMOVE TURF & TOPSOIL TO 6" DEPTH
- 9 **ADD/ALT #2:** R&S RIVERSTONE/PEASTONE. WASH OR SCREEN TO REMOVE SOIL & DEBRIS.
- 10 **ADD/ALT #2:** CLEAR & GRUB ALL EXISTING VEGETATION (FULLY ERADICATE LYME GRASS)

PROVIDENCE
PARKS DEPARTMENT
DALRYMPLE BOATHOUSE
ROGER WILLIAMS PARK
PROVIDENCE, RI 02905

COPYRIGHT (C) CITY OF
PROVIDENCE PARKS
DEPARTMENT, ALL RIGHTS
RESERVED 2023.

NO PART OF THIS DOCUMENT MAY BE
REPRODUCED, STORED IN A RETRIEVAL
SYSTEM OR TRANSMITTED IN ANY FORM OR
BY ANY MEANS, ELECTRONIC,
MECHANICAL, PHOTOCOPIING,
RECORDING OR OTHERWISE WITHOUT THE
PRIOR WRITTEN PERMISSION OF THE CITY OF
PROVIDENCE PARKS DEPARTMENT. ANY
MODIFICATIONS TO THIS DOCUMENT
WITHOUT THE WRITTEN PERMISSION OF
THE CITY OF PROVIDENCE PARKS
DEPARTMENT SHALL RENDER IT INVALID
AND UNUSABLE.

DATE	REVISION	NO.

EX. CONDITIONS/DEMO PLAN
SITE IMPROVEMENTS AT ROGER WILLIAMS PARK EVENT PAVILION
1000 ELMWOOD AVE, PROVIDENCE, RI


DATE: DECEMBER 21, 2023

SCALE: 1"=20'

DRAWN BY: SG SHEET NO.

CHECKED/ APPROVED: BB **L-2**

2 OF 8

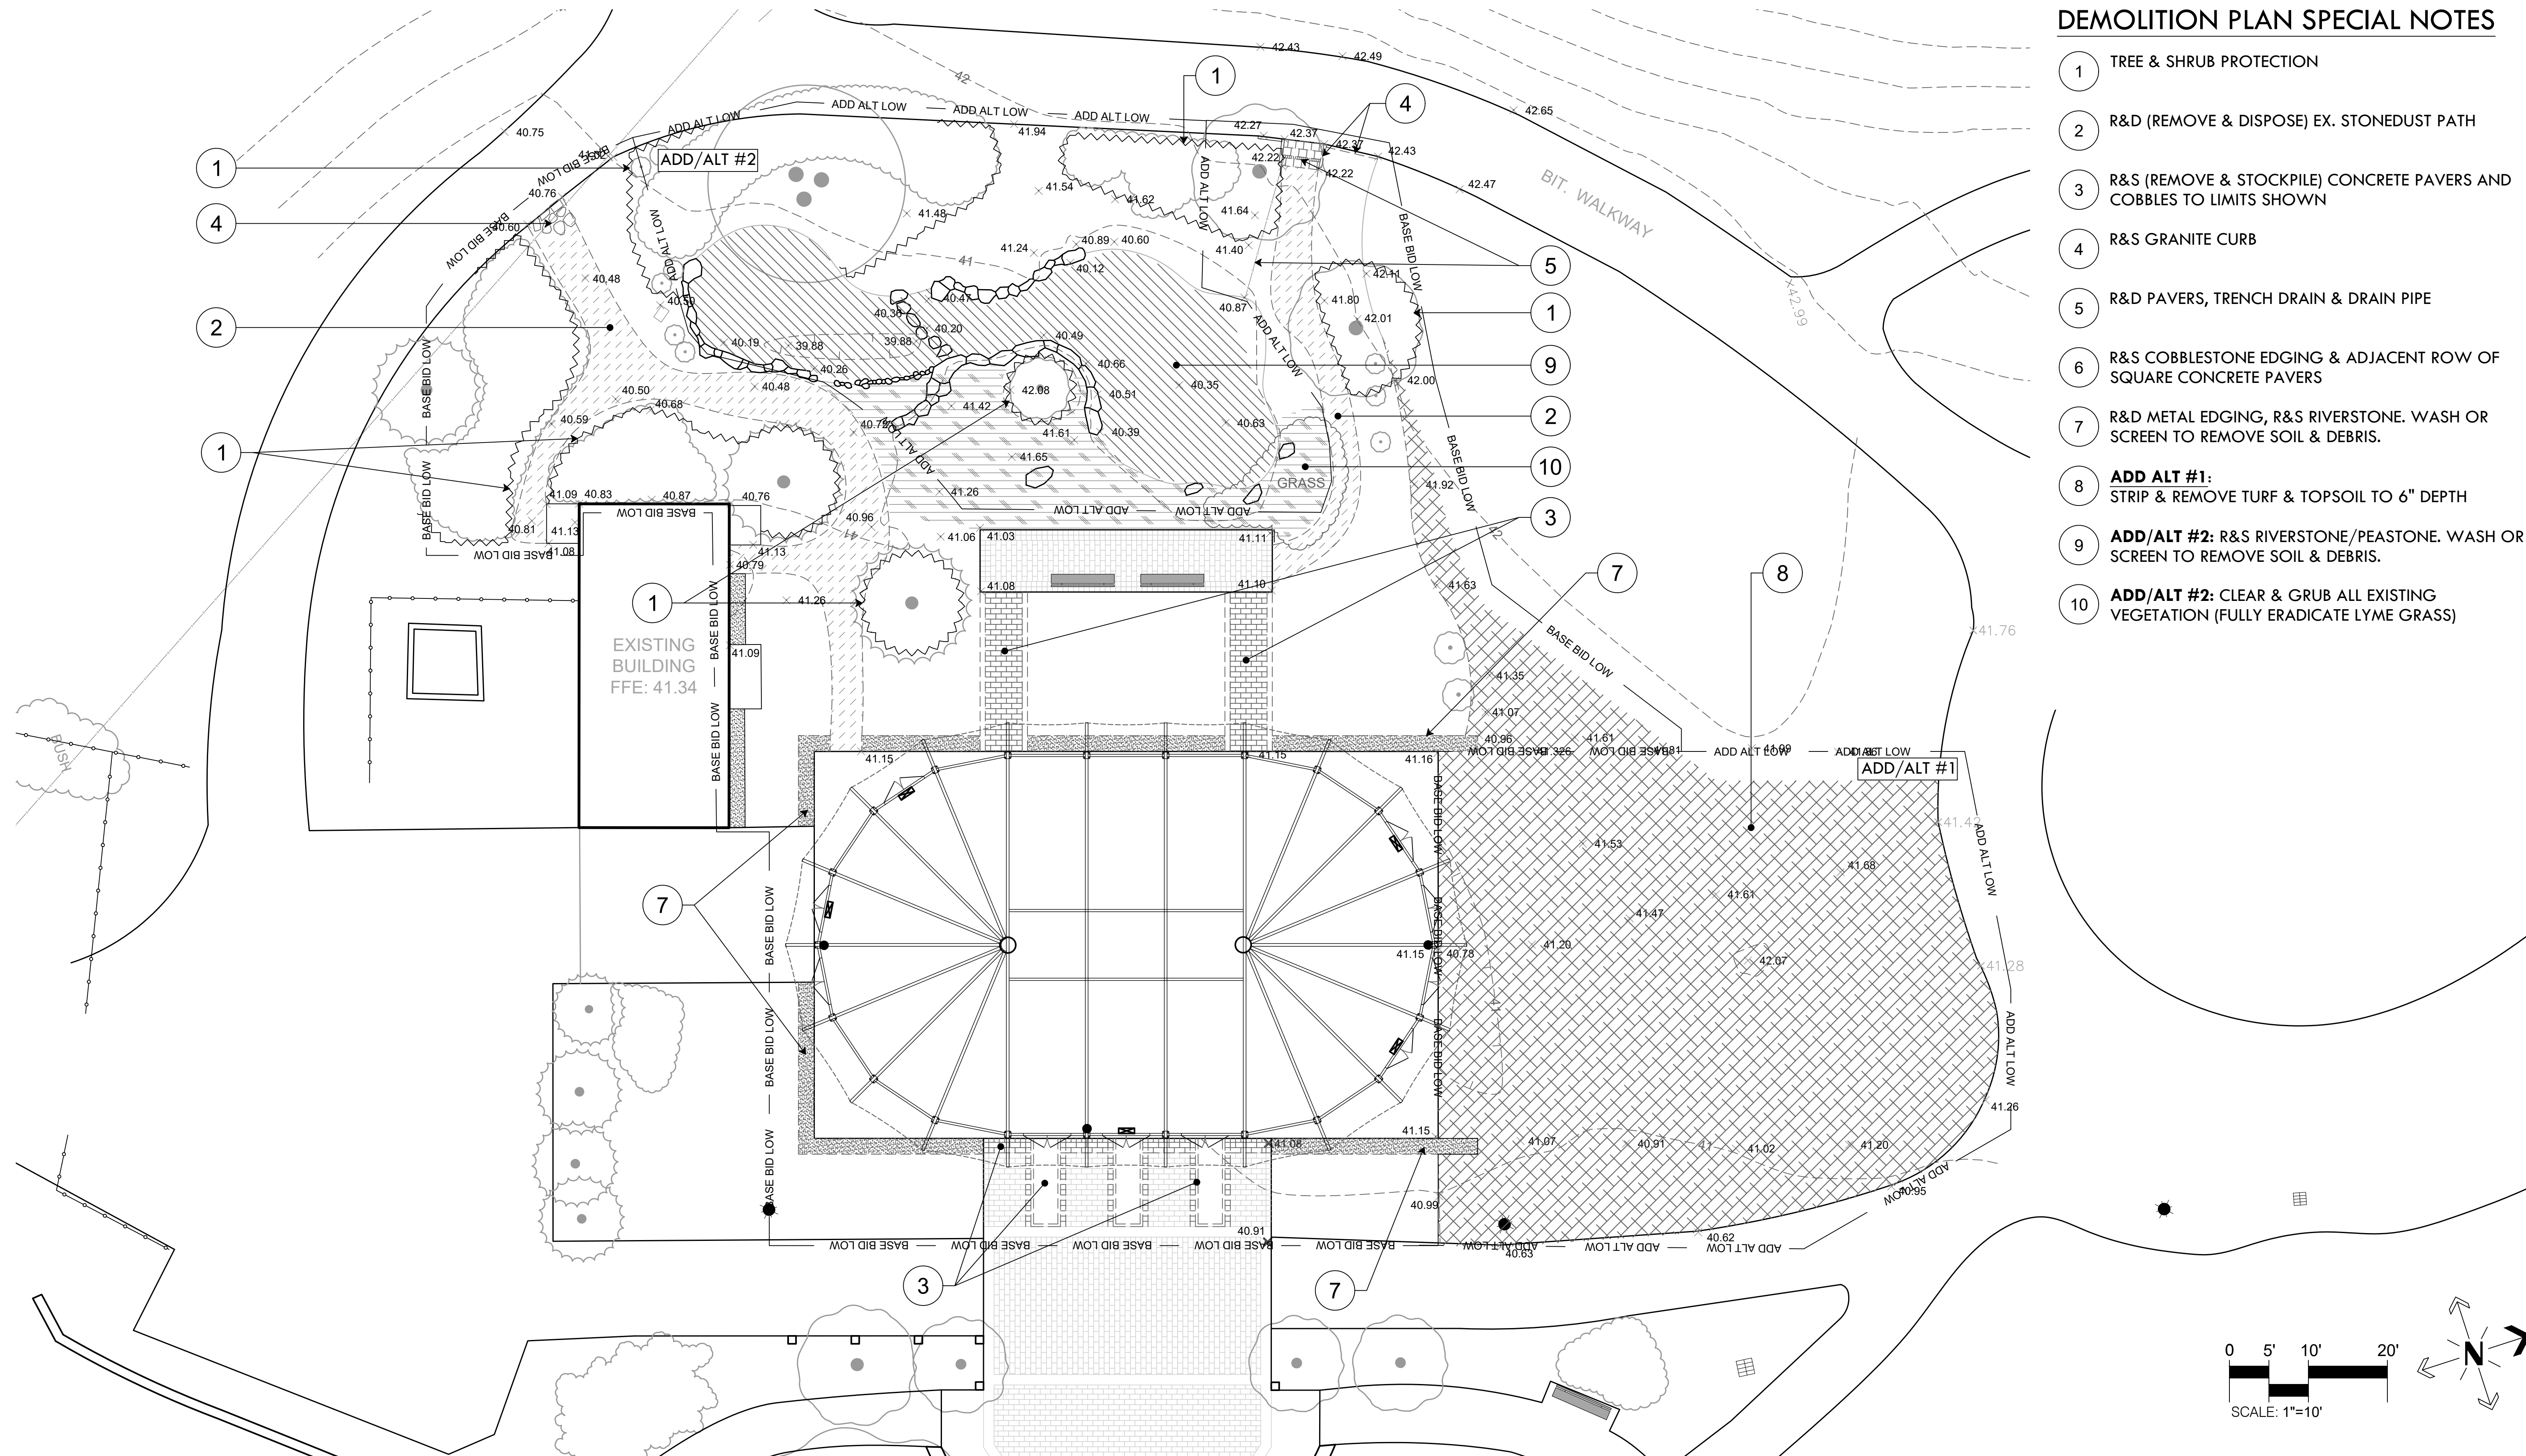

DEMOLITION PLAN LEGEND

- BASE BID LOW — BASE BID LIMIT OF WORK
- ADD/ALT LOW — ADD/ALT LIMIT OF WORK
- ~~~~~ TREE PROTECTION FENCE (1-L-3)
- ||||| SAWCUT (1-L-3)
- TR - TRENCH, PER NOTE ON PLAN
- ▨ R&D EX. STONEDUST AND GRAVEL BASE
- ▨ R&S PEASTONE & RIVERSTONE
- ▨ STRIP TURF & TOPSOIL TO 6" DEPTH
- ▨ CLEAR & GRUB EX. VEGETATION

DEMOLITION PLAN GENERAL NOTES

1. ALL SITE PREPARATION NECESSARY TO COMPLETE THIS PROJECT IS THE SOLE RESPONSIBILITY OF THE CONTRACTOR.
2. IT IS THE CONTRACTOR'S RESPONSIBILITY TO COORDINATE WITH PROVIDENCE PARKS DEPARTMENT STAFF TO DEVELOP A SUITABLE DEMOLITION PLAN, WHICH WILL MINIMIZE PARK DISTURBANCE AND ALLOW ALL FACILITIES TO REMAIN IN OPERATION DURING THE ENTIRETY OF CONSTRUCTION.
3. UNLESS OTHERWISE NOTED, THE CONTRACTOR IS RESPONSIBLE FOR THE RELOCATION, DEMOLITION, REMOVAL AND DISPOSAL, IN A LOCATION APPROVED BY ALL GOVERNING AUTHORITIES, OF ALL EXISTING SITE ELEMENTS AND STRUCTURES INCLUDING BUT NOT LIMITED TO BITUMINOUS CONCRETE, CEMENT CONCRETE, GRAVEL, CURBS, WALKWAYS, SIDEWALKS, BERMS, FENCES, BOLLARDS, POSTS, PLANTING BEDS, TREES, SHRUBS, UTILITIES, DRAINAGE STRUCTURES AND ALL OTHER STRUCTURES SHOWN WITHIN THE LIMITS, AND WHERE NEEDED, TO ALLOW FOR NEW CONSTRUCTION. ALL ELEMENTS TO BE REMOVED SHALL BE UNDERCUT TO SUITABLE MATERIAL AND BROUGHT TO GRADE WITH SUITABLE COMPACTED FILL MATERIAL PER SPECIFICATIONS.
4. THE CONTRACTOR IS RESPONSIBLE FOR REMOVING ALL DEBRIS FROM THE SITE AND DISPOSING OF THE DEBRIS IN A PROPER AND LEGAL MANNER.
5. THE CONTRACTOR IS SPECIFICALLY CAUTIONED THAT THE LOCATION AND/OR ELEVATION OF EXISTING UTILITIES AND STRUCTURES AS SHOWN ON THESE PLANS ARE BASED ON RECORDS OF VARIOUS UTILITY COMPANIES, AND WHEREVER POSSIBLE, MEASUREMENTS TAKEN IN THE FIELD. THIS INFORMATION IS NOT TO BE RELIED UPON AS BEING EXACT OR COMPLETE. THE LOCATION OF ALL UNDERGROUND UTILITIES AND STRUCTURES SHALL BE VERIFIED IN THE FIELD BY THE CONTRACTOR PRIOR TO THE START OF CONSTRUCTION. THE CONTRACTOR MUST CONTACT THE APPROPRIATE UTILITY COMPANY, ANY GOVERNING PERMITTING AUTHORITY IN THE CITY, AND "DIGSAFE" (1-800-344-7233) AT LEAST 72 HOURS PRIOR TO ANY EXCAVATION WORK IN PREVIOUSLY UNALTERED AREAS TO REQUEST EXACT FIELD LOCATION OF UTILITIES. IT SHALL BE THE RESPONSIBILITY OF THE CONTRACTOR TO RESOLVE CONFLICTS BETWEEN THE PROPOSED UTILITIES AND FIELD-LOCATED UTILITIES AND SHALL REPORT ANY DISCREPANCIES TO THE LANDSCAPE ARCHITECT IMMEDIATELY. THE OWNER ASSUMES NO RESPONSIBILITY FOR DAMAGES INCURRED AS A RESULT OF UTILITIES OMITTED, INCOMPLETELY OR INACCURATELY SHOWN. THE CONTRACTOR SHALL BE RESPONSIBLE FOR MAINTAINING ACCURATE RECORDS OF THE LOCATION AND ELEVATION OF ALL WORK INSTALLED AND EXISTING UTILITIES FOUND DURING CONSTRUCTION FOR THE PREPARATION OF THE AS-BUILT PLAN.
6. THE CONTRACTOR IS RESPONSIBLE FOR MAINTAINING ALL EXISTING UTILITIES IN WORKING ORDER AND FREE FROM DAMAGE DURING THE ENTIRE DURATION OF THE PROJECT. ALL COST RELATED TO THE REPAIR OF UTILITIES SHALL BE THE RESPONSIBILITY OF THE CONTRACTOR. EXCAVATION REQUIRED WITHIN THE PROXIMITY OF EXISTING UTILITY LINES SHALL BE DONE BY HAND. CONTRACTOR SHALL REPAIR ANY DAMAGE TO EXISTING UTILITY LINE OR STRUCTURES INCURRED DURING CONSTRUCTION OPERATIONS AT NO COST TO THE OWNER.
7. THE CONTRACTOR SHALL MAINTAIN CONTINUOUS ACCESS AND OPERATION FOR SURROUNDING FACILITIES, AS DEEMED BY THE OWNER, AT ALL TIMES DURING DEMOLITION OF THE EXISTING FACILITIES.
8. PRIOR TO DEMOLITION OCCURRING, ALL EROSION CONTROL DEVICES AND TREE PROTECTIVE MEASURES ARE TO BE INSTALLED.

NO.	REVISION	DATE

LIGHTING PLAN
SITE IMPROVEMENTS AT ROGER WILLIAMS PARK EVENT PAVILION
1000 ELMWOOD AVE, PROVIDENCE, RI
FILE: RWBC-23.01-PLANS-2023.dwg


DATE:
DECEMBER 21, 2023

SCALE:
1"=5'

DRAWN BY:
SG SHEET NO.

CHECKED/
APPROVED:
BB **L-5**


5 OF 8

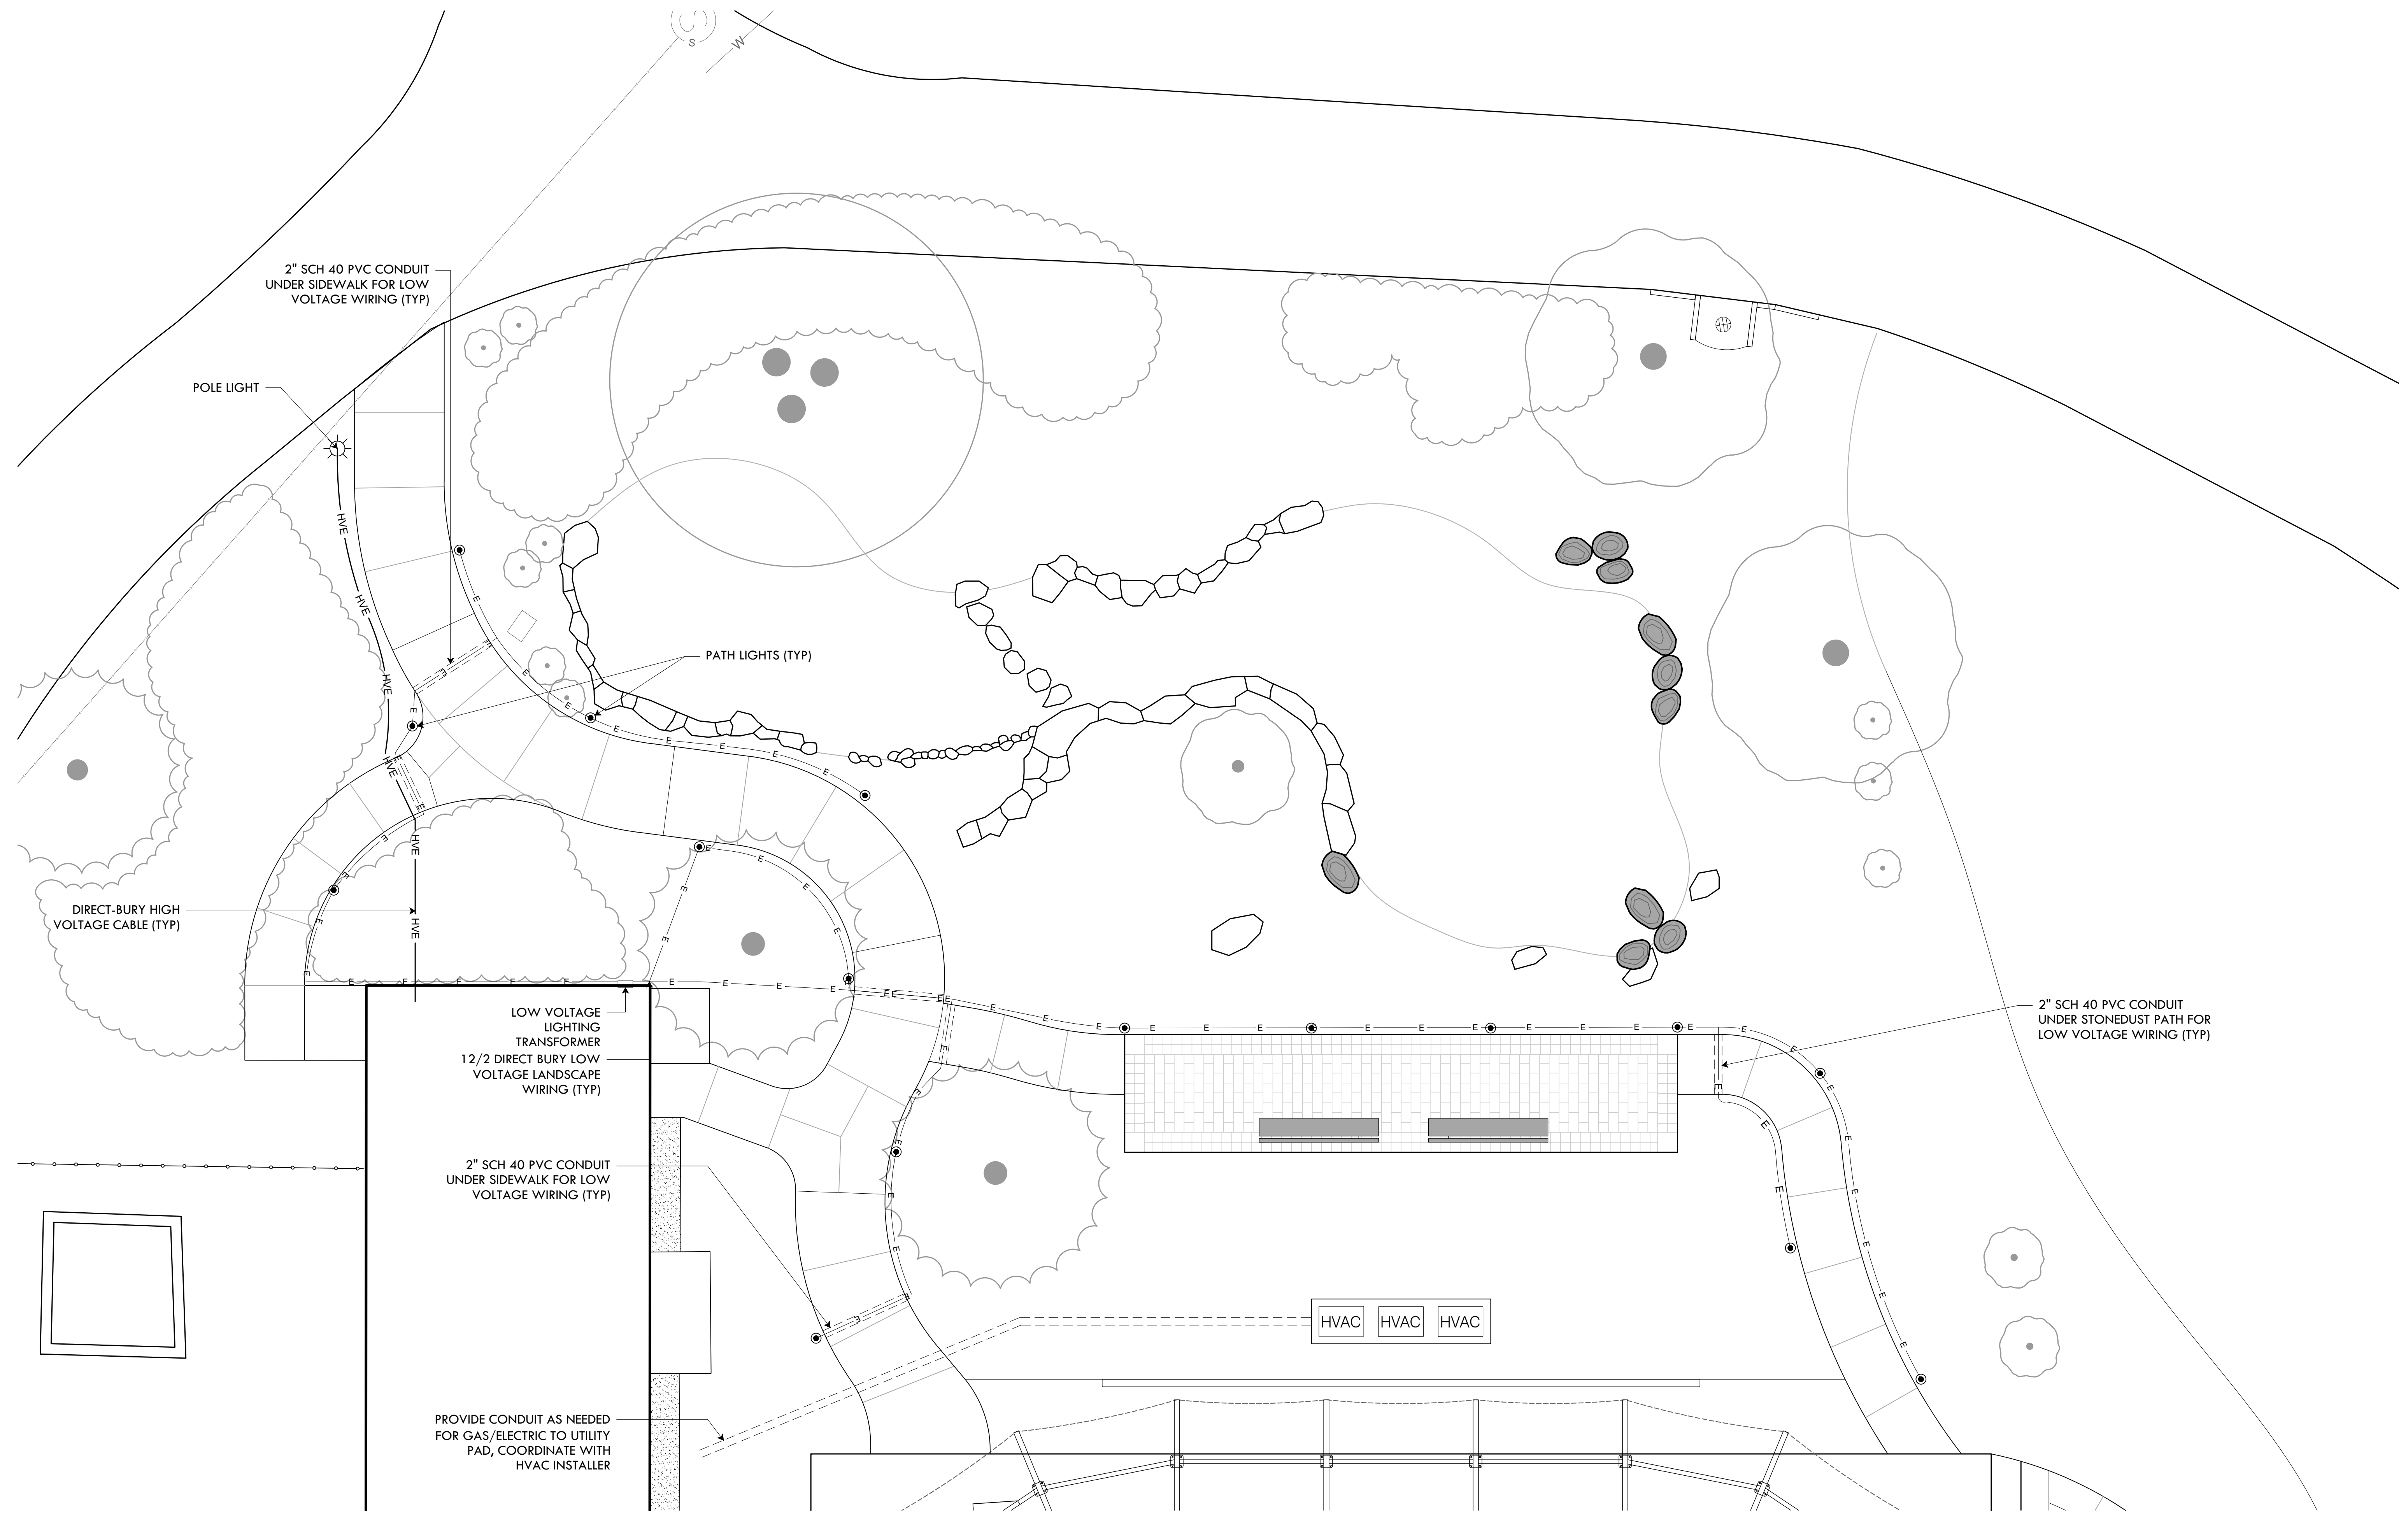


LIGHTING PLAN LEGEND

- SCH 40 PVC CONDUIT
- HVE —— DIRECT-BURIAL HIGH VOLTAGE CABLE
- E — E — 1½ LOW VOLTAGE LIGHTING CABLE

LIGHTING SCHEDULE				
KEY	QTY	LIGHT (BRAND AND ORDERING CODE)	TYPE	VOLTAGE
●	16	HADCO RL4-A-57-LED2W	PATH	12V
☀	1	NLS CAL-1-TP1-S8-T4-16-35-30K-UNV-AM-BLK	PENDANT	120V
☀	1	NLS POLE TO MATCH EXISTING POLES ON SITE	POLE	

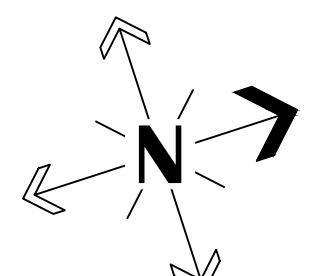

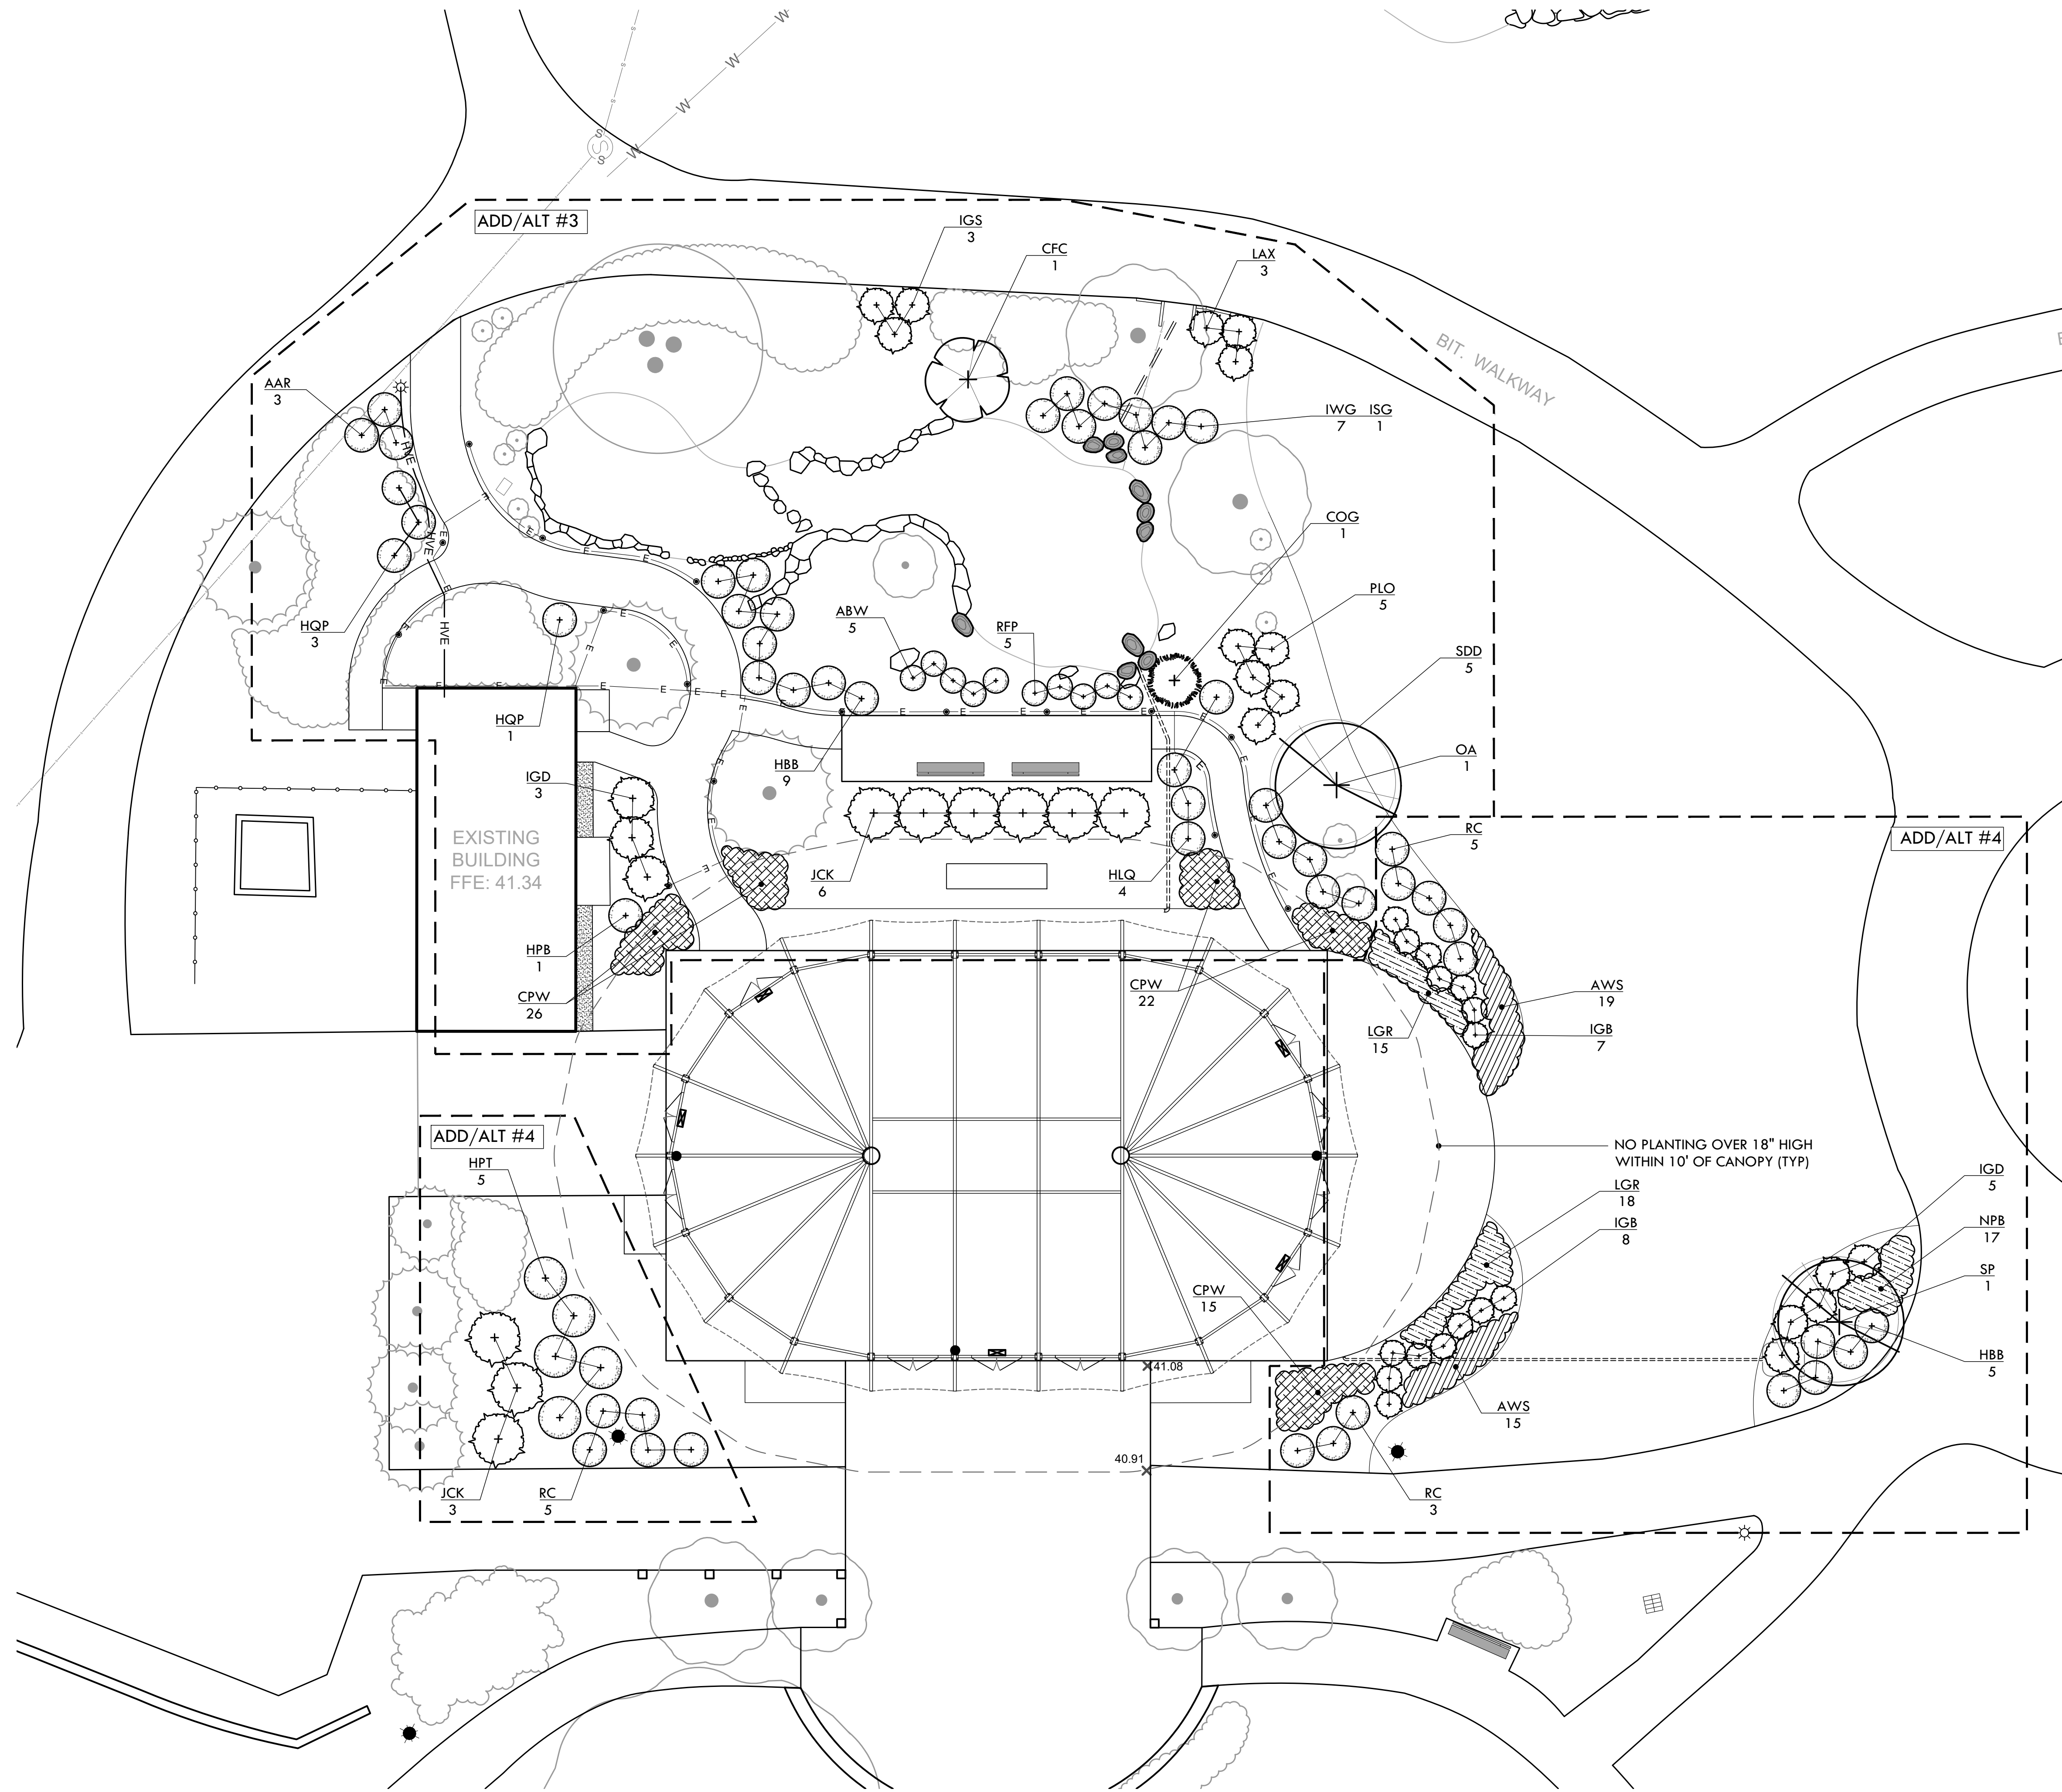

ADD/ALT #3 PLANT SCHEDULE				
KEY	QTY	BOTANICAL NAME COMMON NAME	SIZE	NOTES
TREES				
COG	1	<i>Chamaecyparis obtusa</i> 'Gracilis' Slender Hinoki Cypress	4-5' B&B	Specimen
CFC	1	<i>Cornus florida</i> 'Cherokee Princess' Flowering Dogwood	1.5-2" Cal	Specimen
JCK	6	<i>Juniperus chinensis</i> 'Keteleerii' Keteleer Juniper	6-7' B&B	
OA	1	<i>Oxydendron arboreum</i> Sourwood	6-7' B&B	Specimen
SHRUBS				
AAR	3	<i>Azalea Encore Autumn Royalty</i> Re-Blooming Evergreen Azalea - Pink	#3 CONT.	
ABW	5	<i>Azalea Bloom-A-Thon White</i> Re-Blooming Evergreen Azalea - White	#3 CONT.	
HBB	9	<i>Hydrangea macro</i> 'Blushing Bride' White Endless Summer Hydrangea	#3 CONT.	
HPB	1	<i>Hydrangea paniculata</i> 'Bobo' Bobo Hardy Hydrangea	#3 CONT.	
HLO	4	<i>Hydrangea paniculata</i> 'Little Quickfire' Little Quickfire Hardy Hydrangea	#3 CONT.	
HQP	4	<i>Hydrangea quercifolia</i> 'Pee-Wee' Dwarf Oakleaf Hydrangea	#3 CONT.	
IGD	3	<i>Ilex glabra</i> 'Densa' Densa Inkberry	#5 Cont	
IGS	3	<i>Ilex glabra</i> 'Shamrock' Shamrock Inkberry	#5 Cont	
ISG	1	<i>Ilex verticillata</i> 'Southern Gentleman' Male Winterberry	#3 Cont	
IWG	7	<i>Ilex verticillata</i> 'Winter Gold' Golden Winterberry	#3 Cont	
LAX	3	<i>Leucothoe axillaris</i> Coast Leucothoe	#3 Cont	
PLO	5	<i>Prunus laurocerasus</i> 'Otto Luyken' Dwarf Cherry Laurel	18-24" B&B	
RFP	5	<i>Rosa</i> 'Flowercarpet Pink' Pink Carpet Rose	#3 Cont	
SDD	5	<i>Spirea</i> 'DoublePlay Doozie' Re-blooming Spirea	#3 Cont	
PERENNIALS, GROUNDCOVERS, & GRASSES				
CPW	48	<i>Campanula persicifolia</i> 'Takion Whitte' Takion White Bellflower	#1	20" O.C.
	13	<i>Iris versicolor</i> Blue Flag Iris	#1	Raingarden
	12	<i>Aclepias incarnata</i> Swamp Milkweed	#1	Raingarden

ADD/ALT #4 PLANT SCHEDULE				
KEY	QTY	BOTANICAL NAME COMMON NAME	SIZE	NOTES
TREES				
JCK	3	<i>Juniperus chinensis</i> 'Keteleerii' Keteleer Juniper	6-7' B&B	
SP	1	<i>Stewartia pseudocamellia</i> Japanese Stewartia	6-7' B&B	Specimen
SHRUBS				
HBB	5	<i>Hydrangea macro</i> 'Blushing Bride' White Endless Summer Hydrangea	#3 CONT.	
HPT	5	<i>Hydrangea paniculata</i> 'Tardiva' Tardiva Panicle Hydrangea	#7 CONT.	
IGD	5	<i>Ilex glabra</i> 'Densa' Densa Inkberry	#5 Cont	
IGB	15	<i>Ilex glabra</i> 'Gem Box' Gem Box Inkberry	#3 Cont	
RC	13	<i>Rhododendron carolinianum</i> Carolina Rhododendron	24-30" B&B	
PERENNIALS, GROUNDCOVERS, & GRASSES				
AWS	35	<i>Anemone</i> 'White Swan' White Swan Anemone	#1	20" O.C.
CPW	15	<i>Campanula persicifolia</i> 'Takion White' Takion White Bellflower	#1	20" O.C.
LGR	33	<i>Lavandula</i> x 'Grosso' Grosso Lavender	#1	18" O.C.
NPB	17	<i>Nepeta</i> 'Purrsian Blue' Dark Purple Catmint	#1	18" O.C.


SEED MIX:

LAWN/DISTURBED AREAS -
ENDOPHYTE ENHANCED MIX

Improved Perennial Rye	30%
Turf Type Tall Fescue	30%
Chewings Fescue	35%
Dutch White Clover	5%

Seeding Rate: 7 lb/1,000 sf

Available from: Allen's Seed Store -
693 S County Trail Exeter, RI 02822 Phone: 401.294.2722

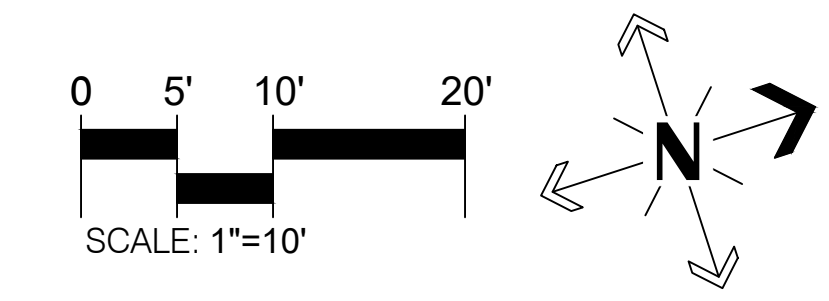

**PROVIDENCE
PARKS DEPARTMENT**
DALRYMPLE BOATHOUSE
ROGER WILLIAMS PARK
PROVIDENCE, RI 02905

COPYRIGHT (C) CITY OF
PROVIDENCE PARKS
DEPARTMENT, ALL RIGHTS
RESERVED 2023.

NO PART OF THIS DOCUMENT MAY BE
REPRODUCED, STORED IN A RETRIEVAL
SYSTEM OR TRANSMITTED IN ANY FORM OR
BY ANY MEANS, ELECTRONIC,
MECHANICAL, PHOTOCOPIING,
RECORDING OR OTHERWISE WITHOUT THE
PRIOR WRITTEN PERMISSION OF THE CITY
OF PROVIDENCE PARKS DEPARTMENT. ANY
MODIFICATIONS TO THIS DOCUMENT
WITHOUT THE WRITTEN PERMISSION OF
THE CITY OF PROVIDENCE PARKS
DEPARTMENT SHALL RENDER IT INVALID
AND UNUSABLE.

DATE	REVISION	NO.

PLANTING PLAN

SITE IMPROVEMENTS AT ROGER WILLIAMS PARK EVENT PAVILION
1 000 ELMWOOD AVE, PROVIDENCE, RI


FILE: RWBC-23.01-PLANS-2023.dwg

DATE: DECEMBER 21, 2023

SCALE: 1"=10'


DRAWN BY: SG SHEET NO. L-6

CHECKED/ APPROVED: BB 6 OF 8


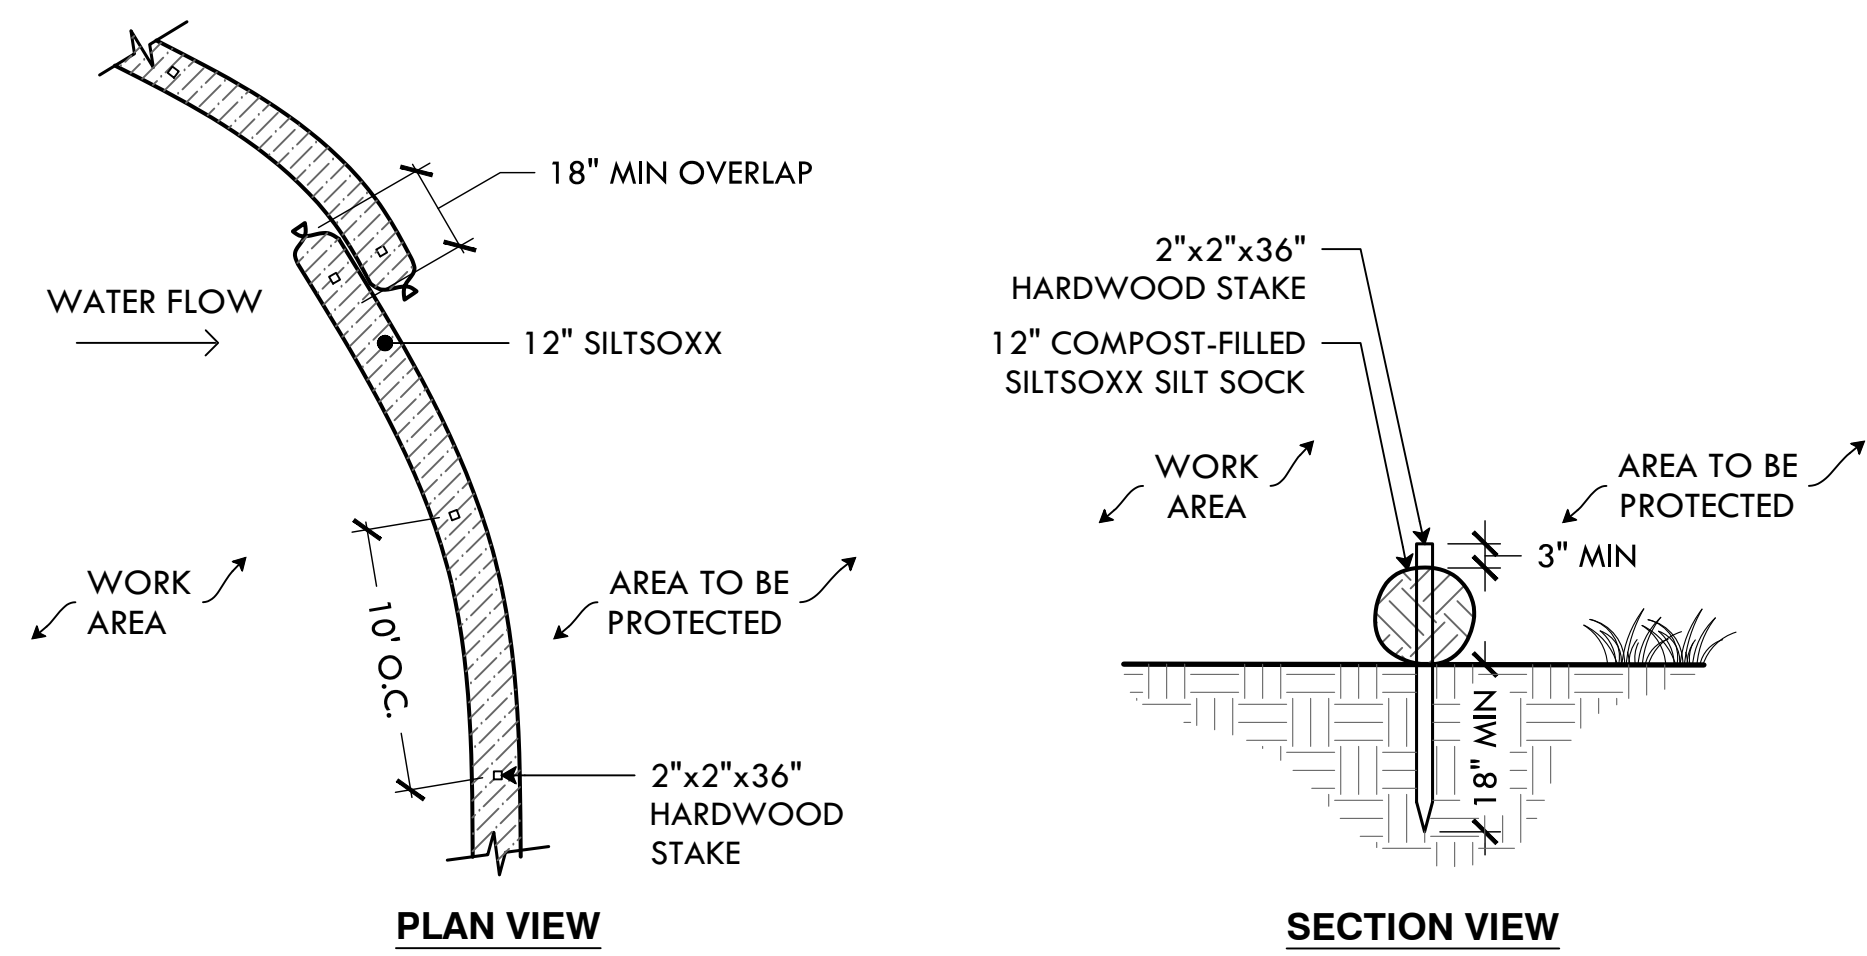


- NOTES:
- SILT SOCK SHALL BE SILT SOCK BY FILTREXX OR LANDSCAPE ARCHITECT APPROVED EQUAL.
 - FILL MATERIAL TO MEET MANUFACTURER'S SPECIFICATIONS
 - FOLLOWING CONSTRUCTION AND SITE STABILIZATION, COMPOST MATERIAL SHALL BE TO BE DISPERSED ON SITE, IN LOCATION SELECTED BY THE LANDSCAPE ARCHITECT.

1 SILT SOCK/COMPOST FILTER SOCK EROSION CONTROL
NTS

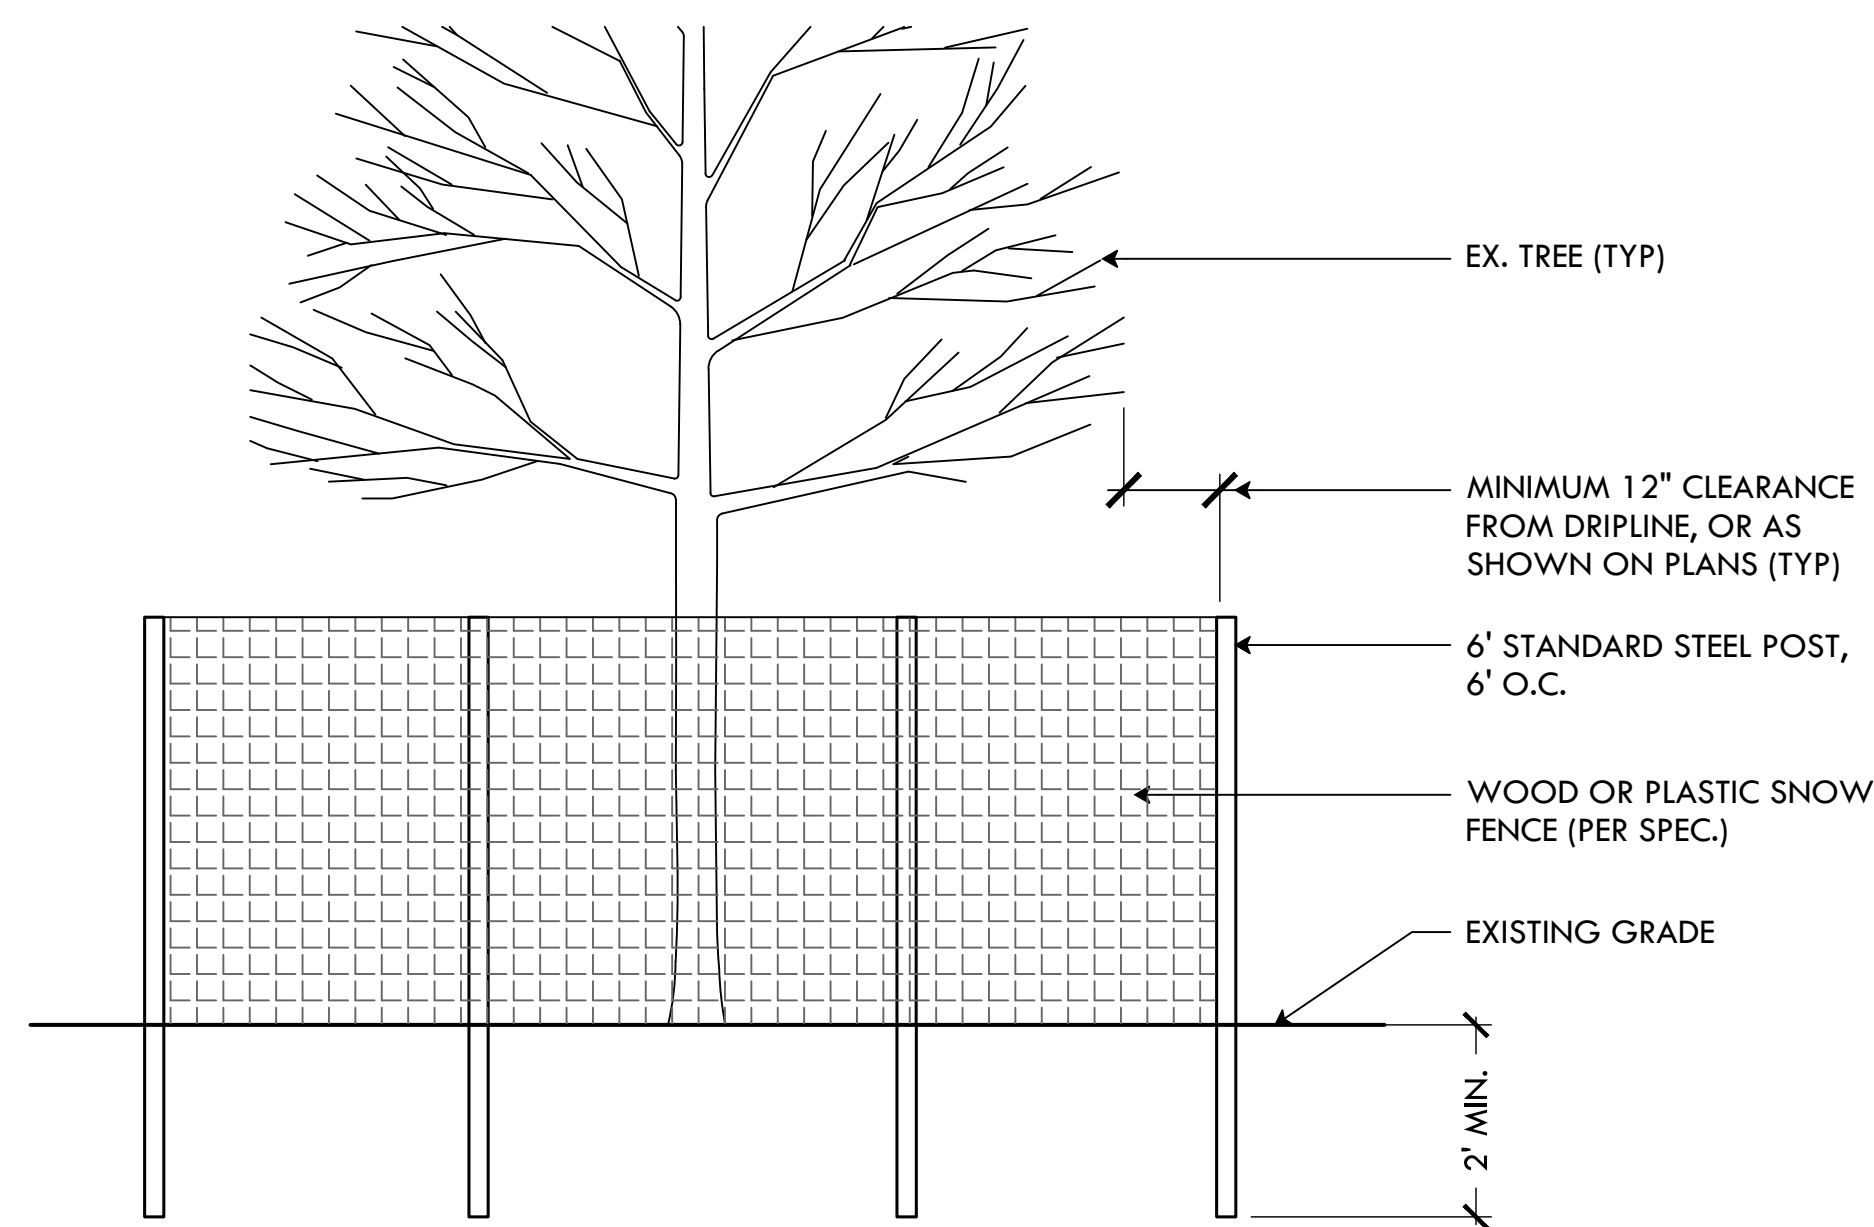


2 TREE PROTECTION FENCE
NTS

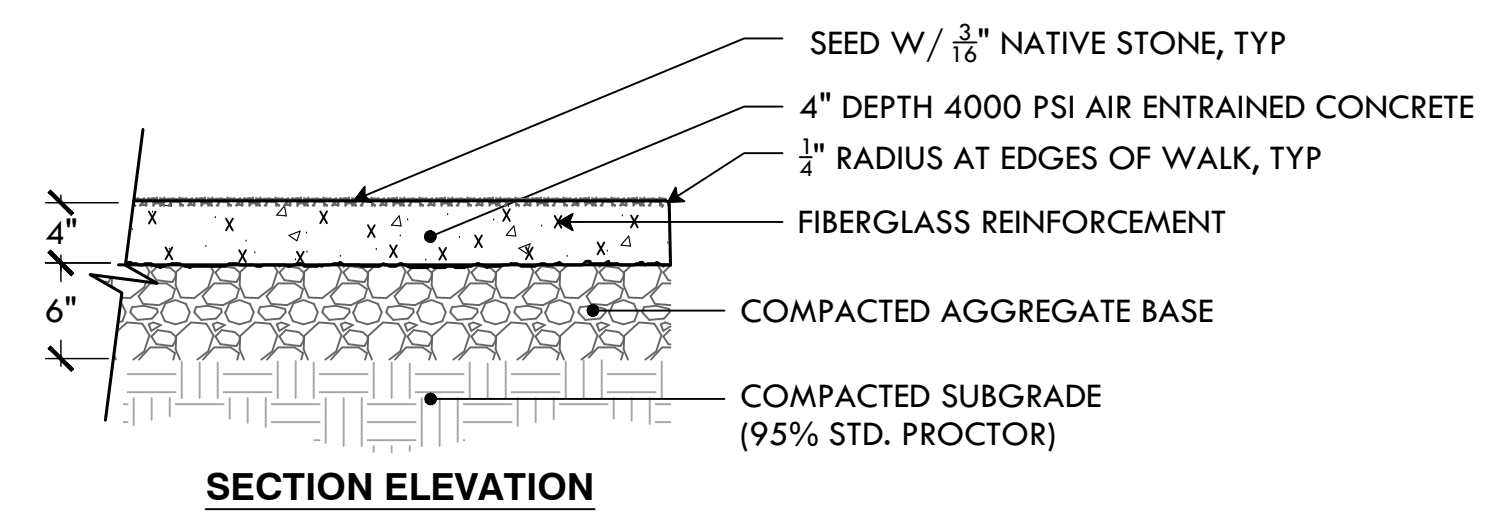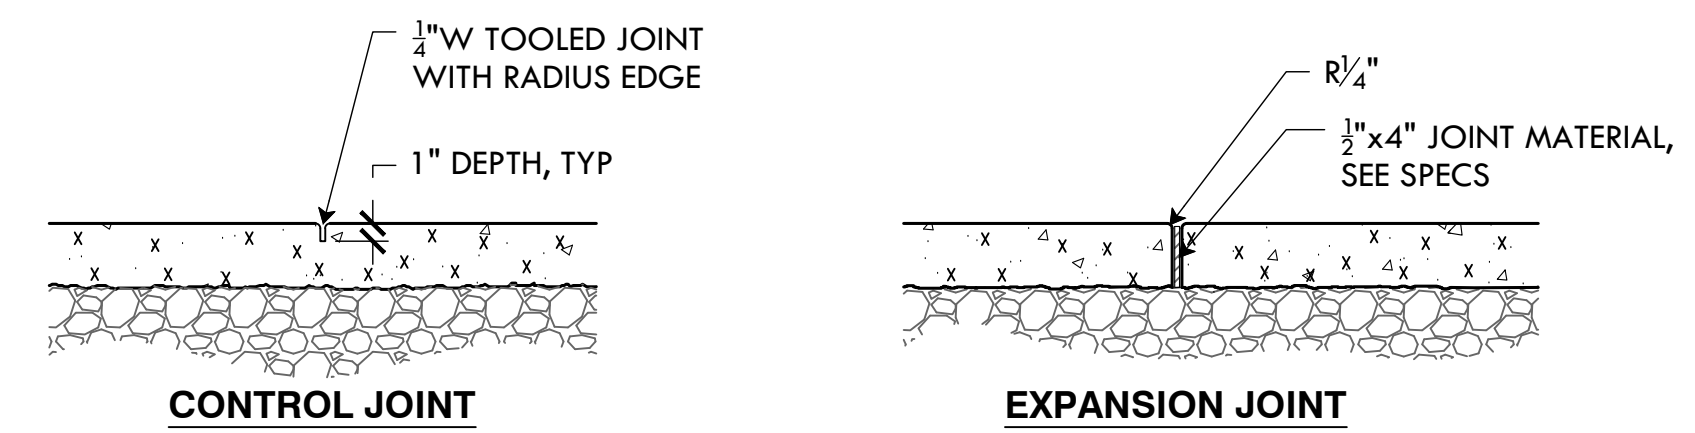


- NOTES:
- PROVIDE SAMPLE OF AGGREGATE PRIOR TO CONSTRUCTION
 - CONSTRUCT MIN 4'x4' MOCKUP SHOWING AGGREGATE FOR APPROVAL PRIOR TO CONSTRUCTION

3 EXPOSED AGGREGATE POURED CONCRETE WALKWAY
NTS

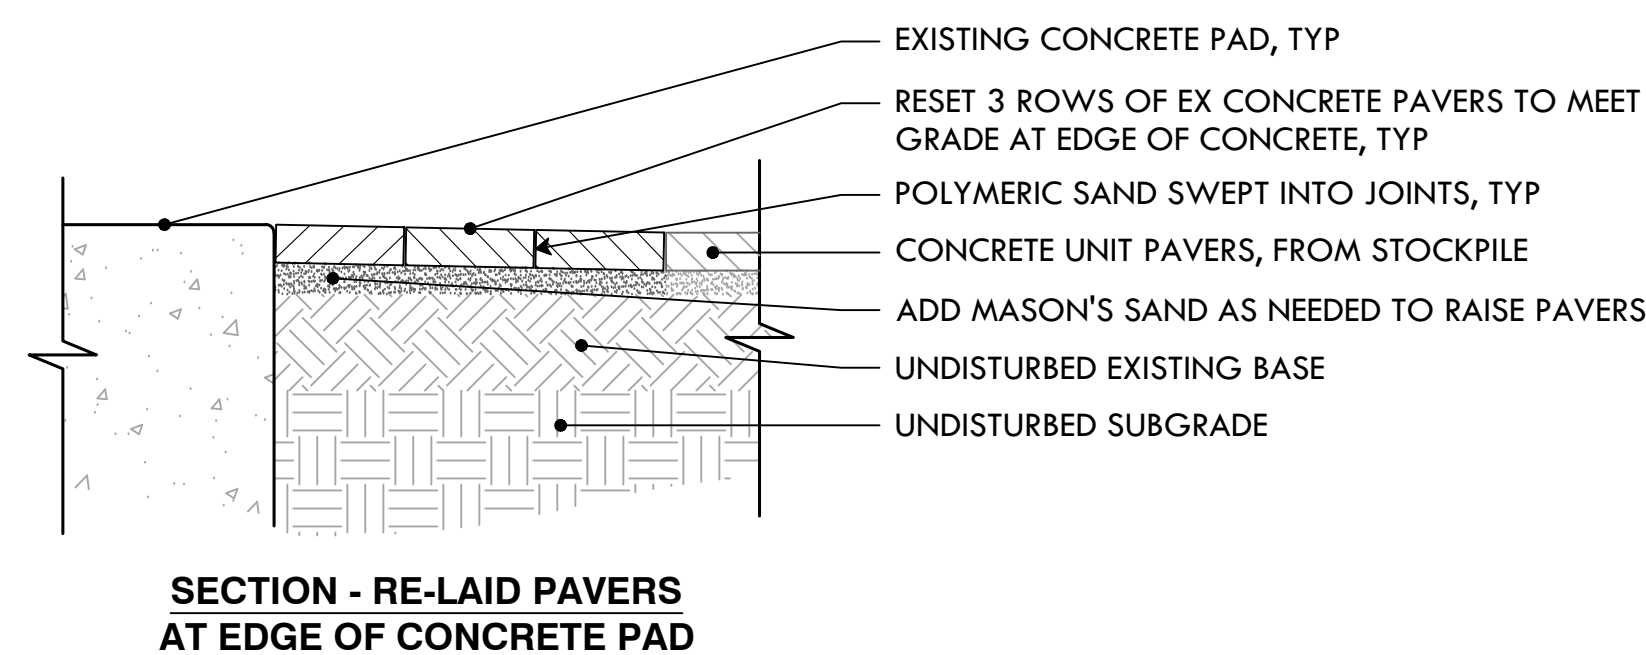


SECTION - RE-LAID PAVERS AT EDGE OF CONCRETE PAD

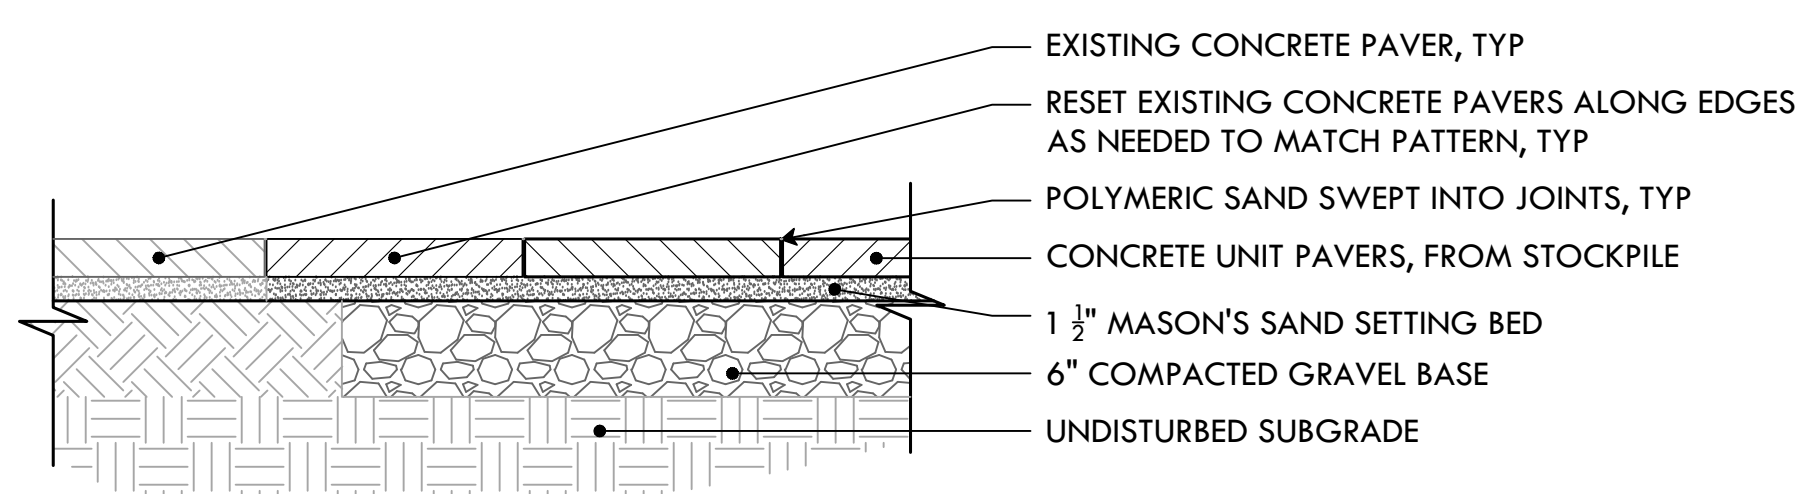

- NOTE:
SEE SHEET L-3 FOR PATTERN AT EACH OPENING


SECTION - PAVER INFILL AT OPENINGS

4 CONCRETE PAVERS FROM STOCKPILE
NTS

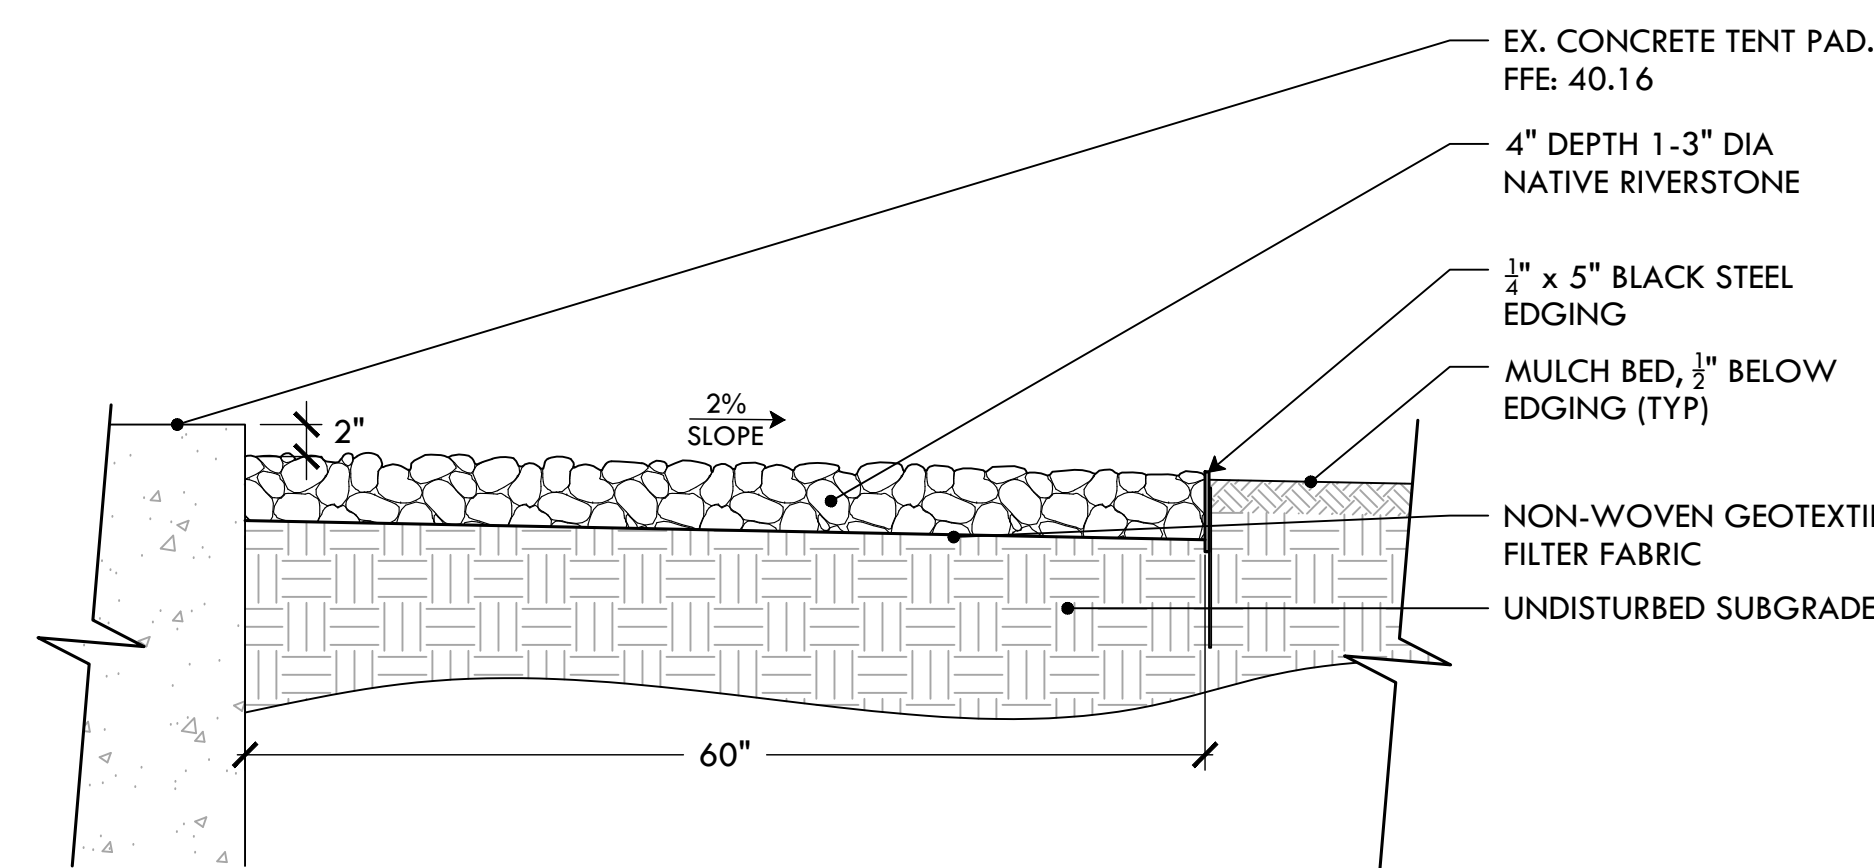


- NOTE:
BEFORE INSTALLATION, STOCKPILED RIVERSTONE SHOULD BE WASHED AND/OR SCREENED TO REMOVE SOIL, LEAVES AND OTHER ORGANIC MATERIAL.

5 RIVERSTONE DRIPLINE W/ STEEL EDGE
NTS

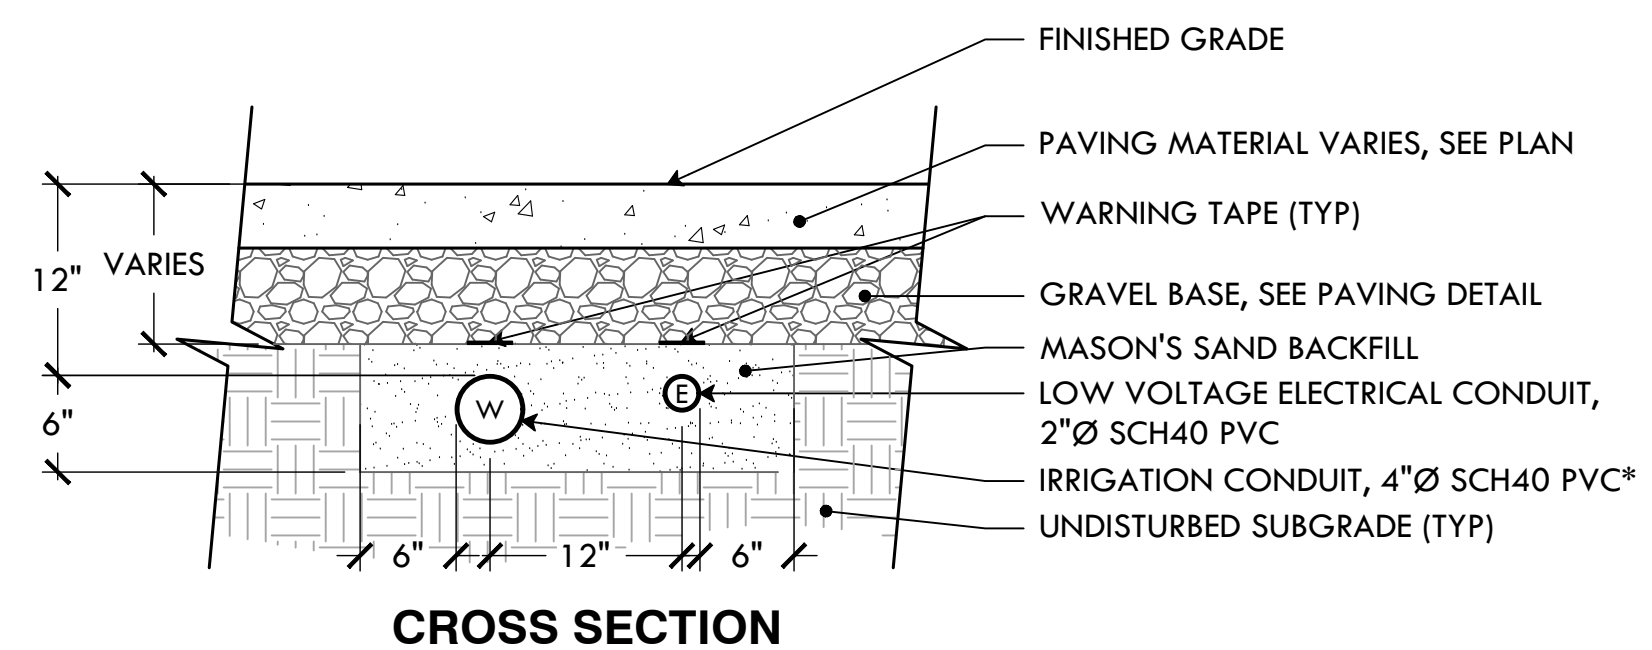


- *NOTE: IRRIGATION CONDUIT ONLY AS NEEDED

6 LOW-VOLTAGE LIGHTING CONDUIT
NTS

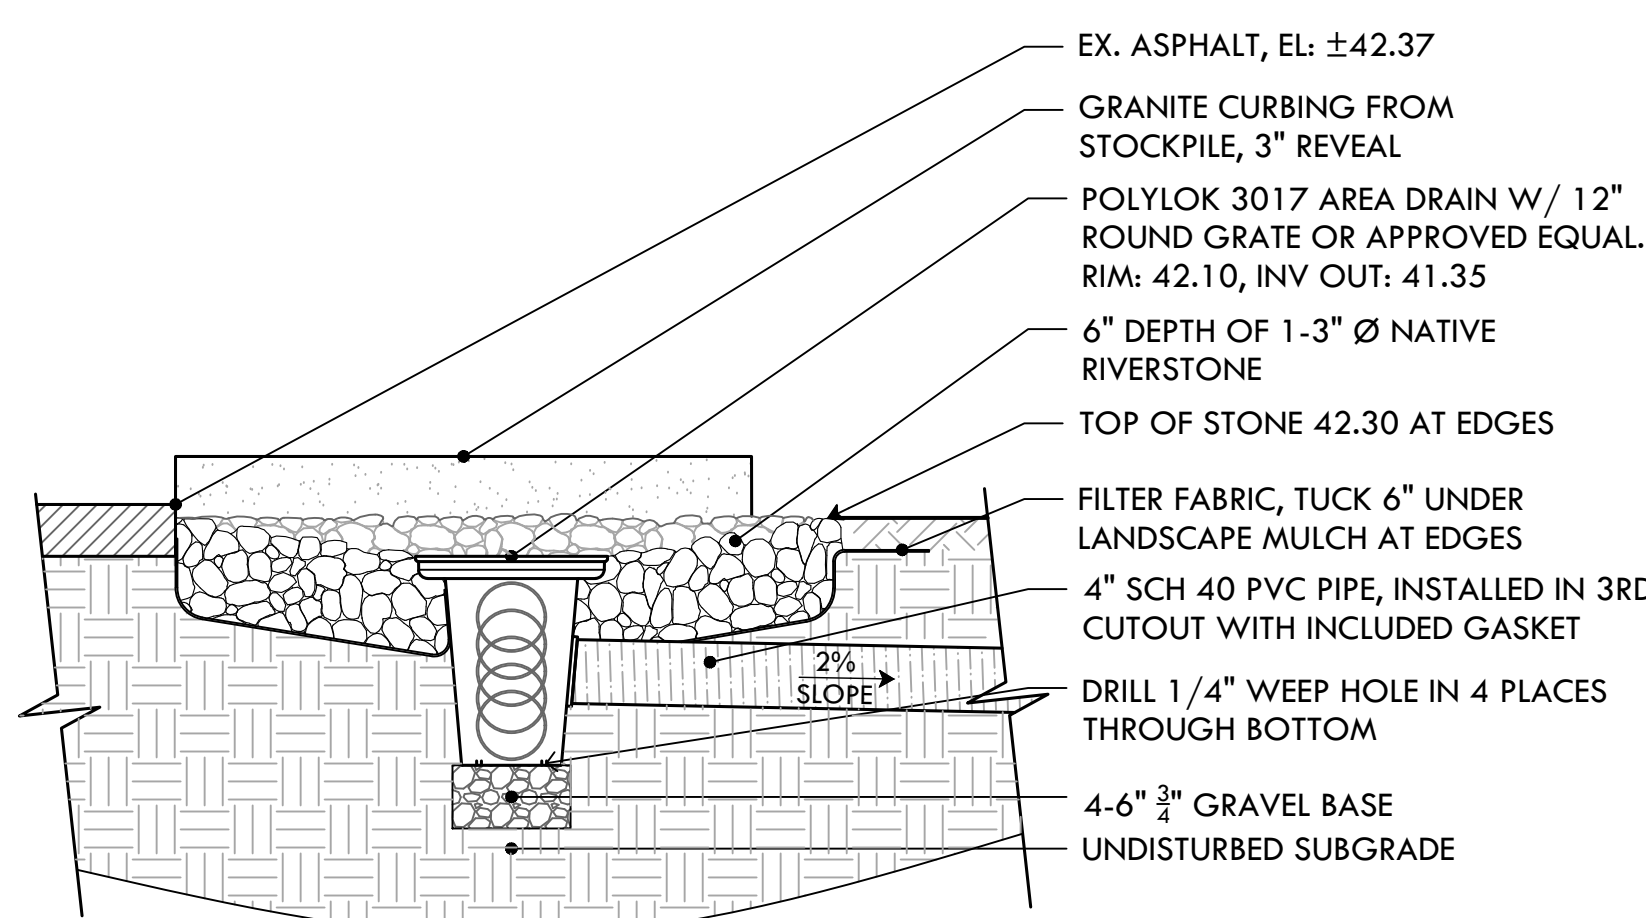


- NOTES:
- GRATE TO BE ATTACHED TO CATCH BASIN WITH SCREW PROVIDED AT TIME OF INSTALLATION.
 - APPROVED EQUAL MUST BE CAPABLE OF INVERT 9" ($\pm 1/2$ ") BELOW RIM

7 12" AREA DRAIN WITH RIVERSTONE SURROUND
NTS

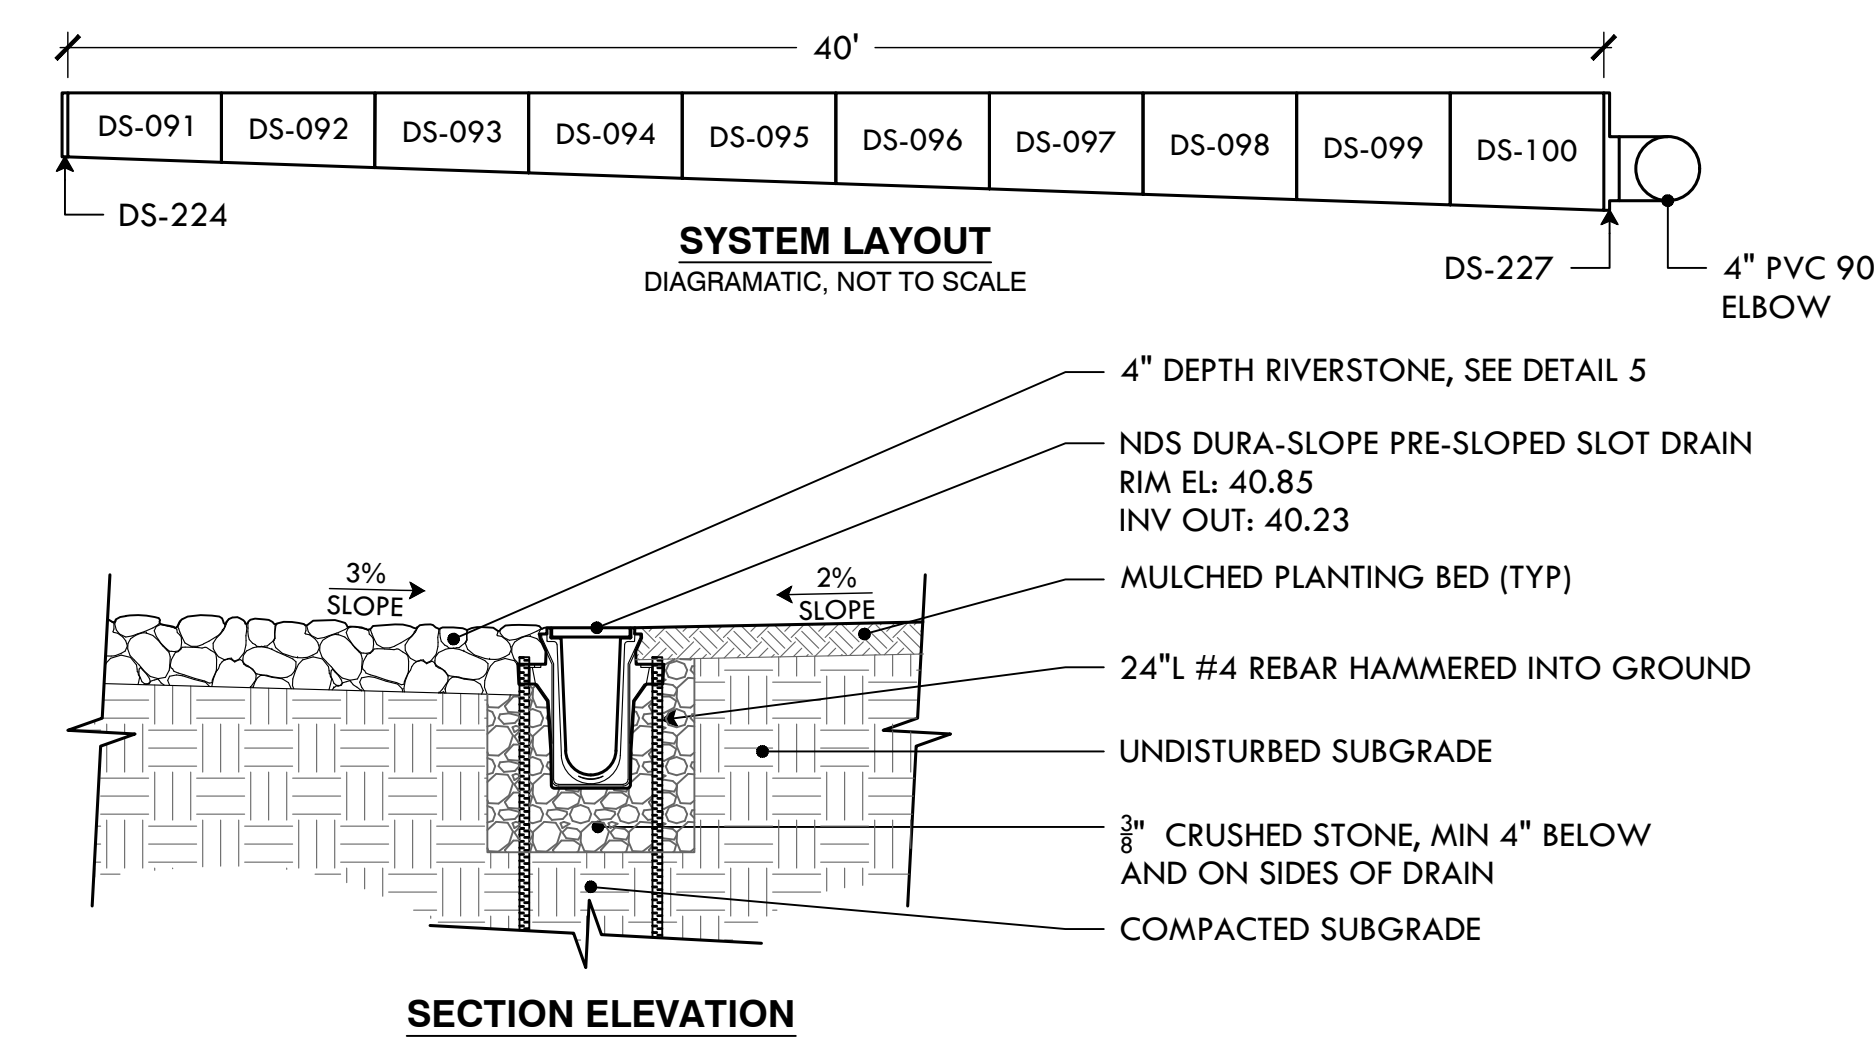



- NOTES:
- DRAIN TO BE NDS 6" DURA-SLOPE OR APPROVED EQUAL
 - DEPTH OF CHANNEL AT START OF DRAIN TO BE 3.998" (DS-091), DEPTH OF CHANNEL AT END OF DRAIN TO BE 7.358" (DS-100).
 - INSTALL UNIVERSAL END OUTLET (DS-227) AT INV OUT
 - ANY SUBSTITUTE DRAIN MUST BE CAPABLE OF AN INV OUT OF 40.15 OR HIGHER

8 PRE-SLOPED CHANNEL DRAIN
NTS

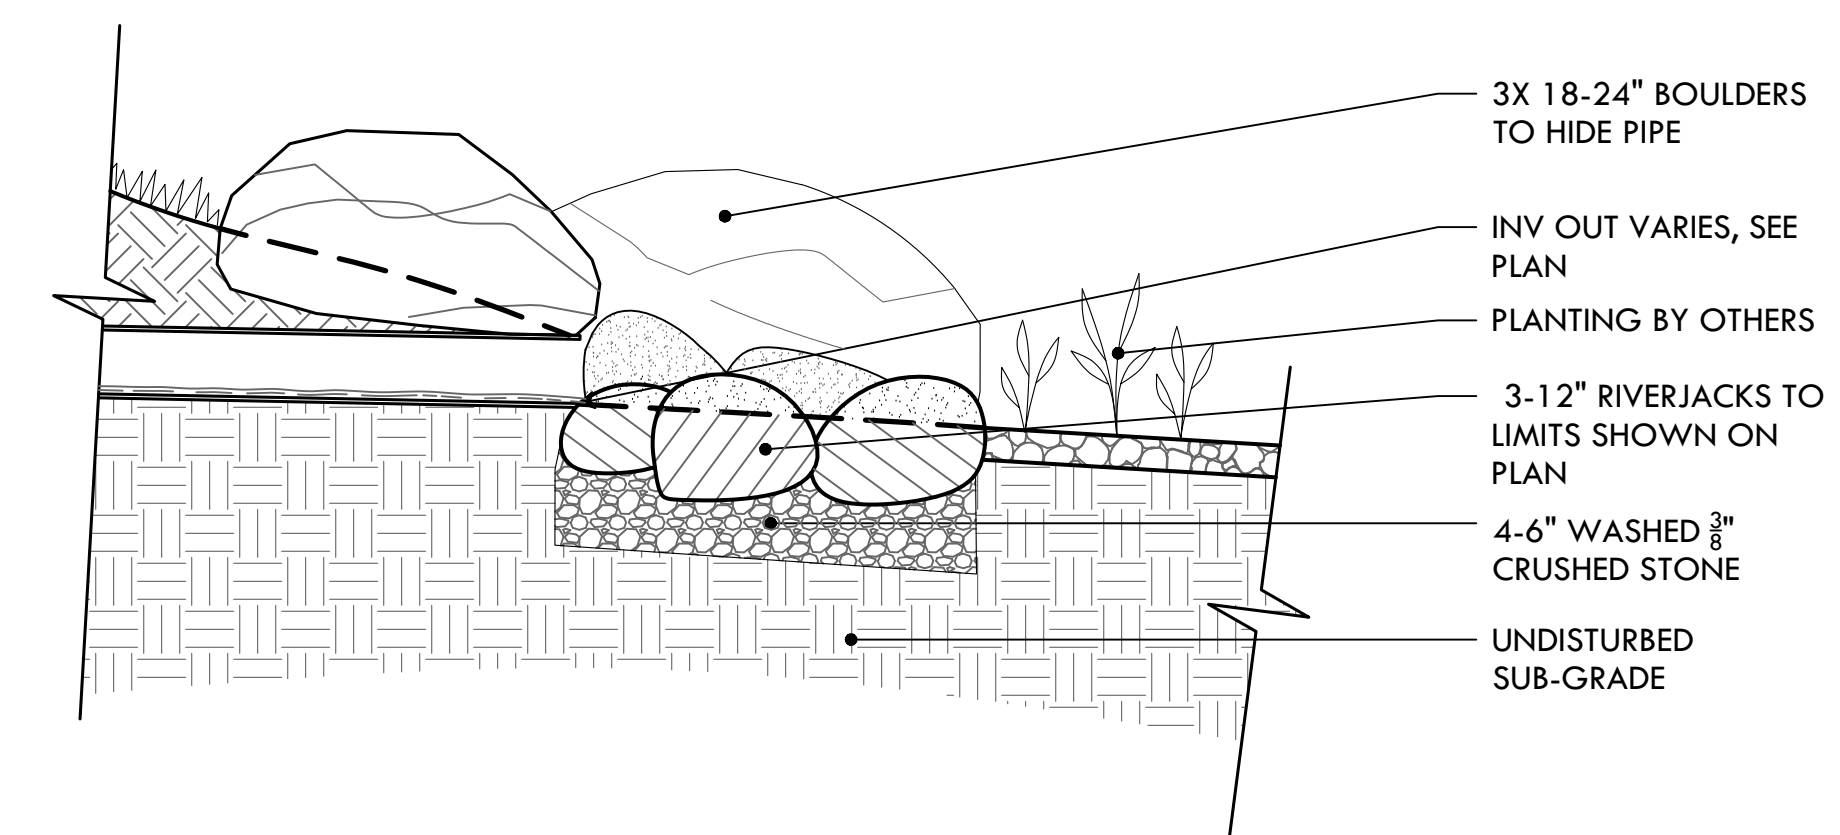


9 STONE DRAIN OUTFALL
NTS

NO.	REVISION	DATE

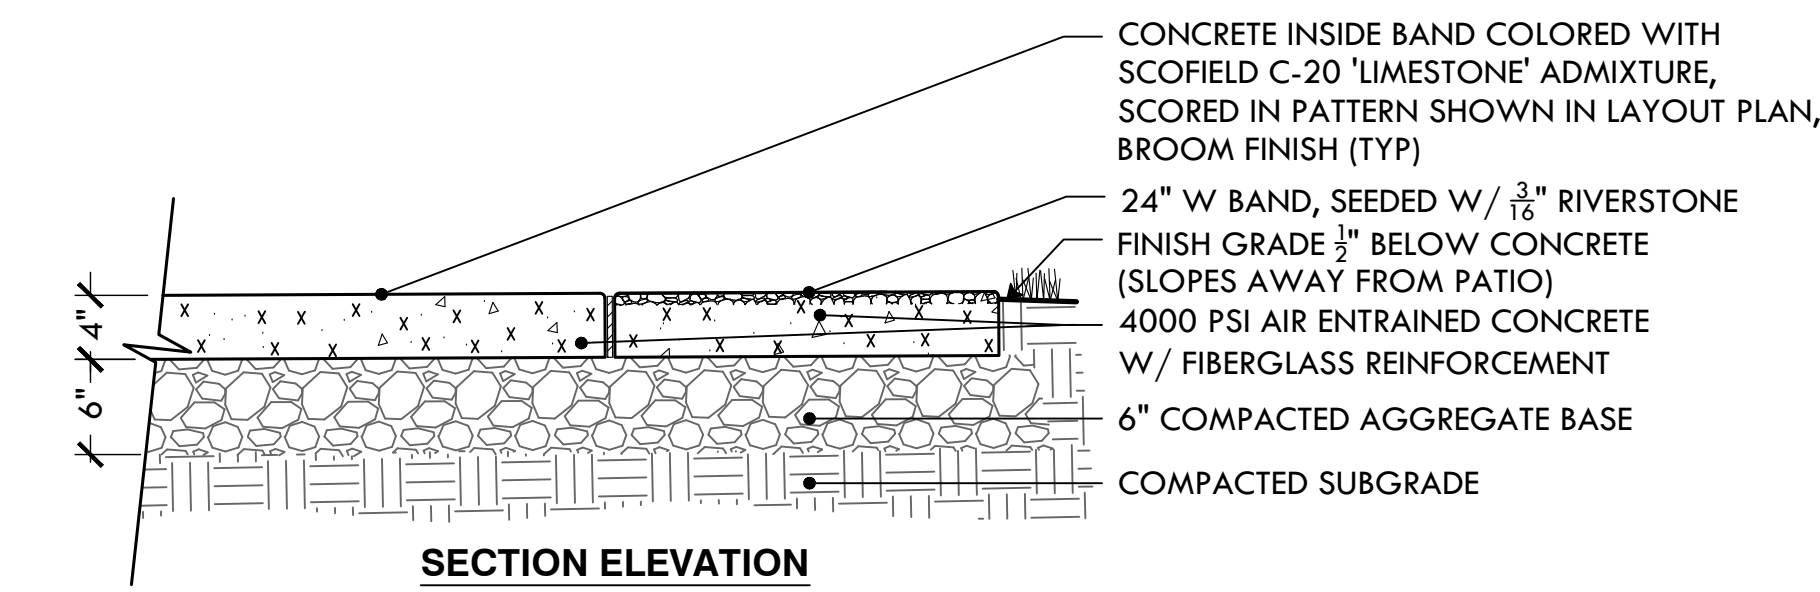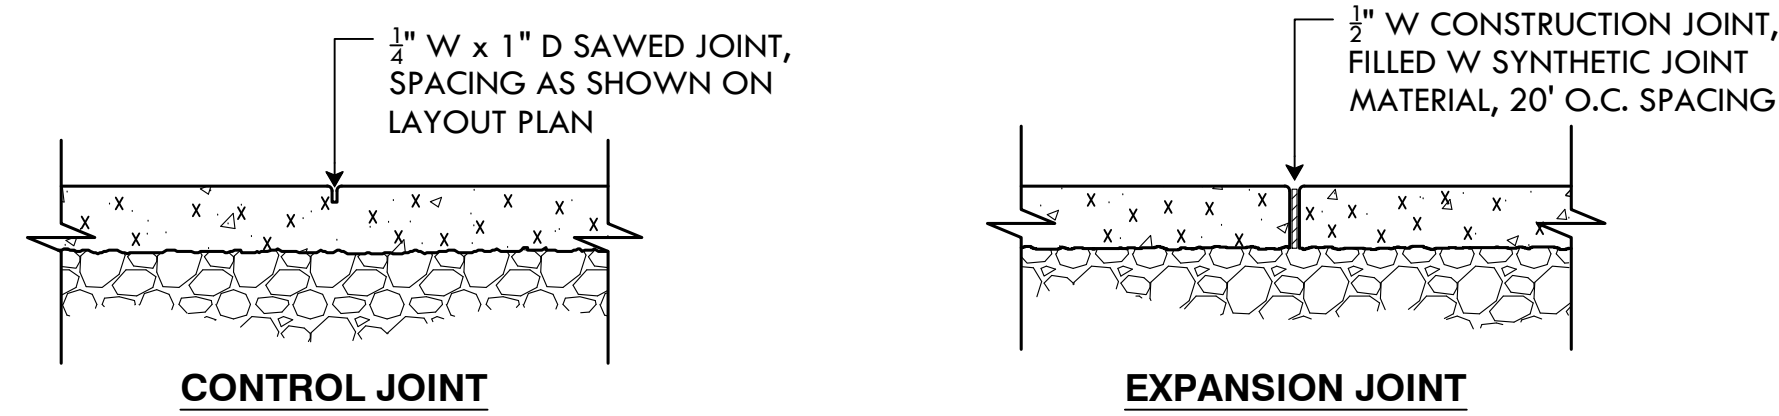


- NOTES:
1. PROVIDE 5LB SAMPLE OF AGGREGATE PRIOR TO CONSTRUCTION
 2. CONSTRUCT MIN 4'x4' MOCKUP SHOWING BAND AND SCORING PATTERN FOR APPROVAL PRIOR TO CONSTRUCTION

10 ADD/ALT#1: 4" POURED CONCRETE TERRACE
BASE BID: NO WORK

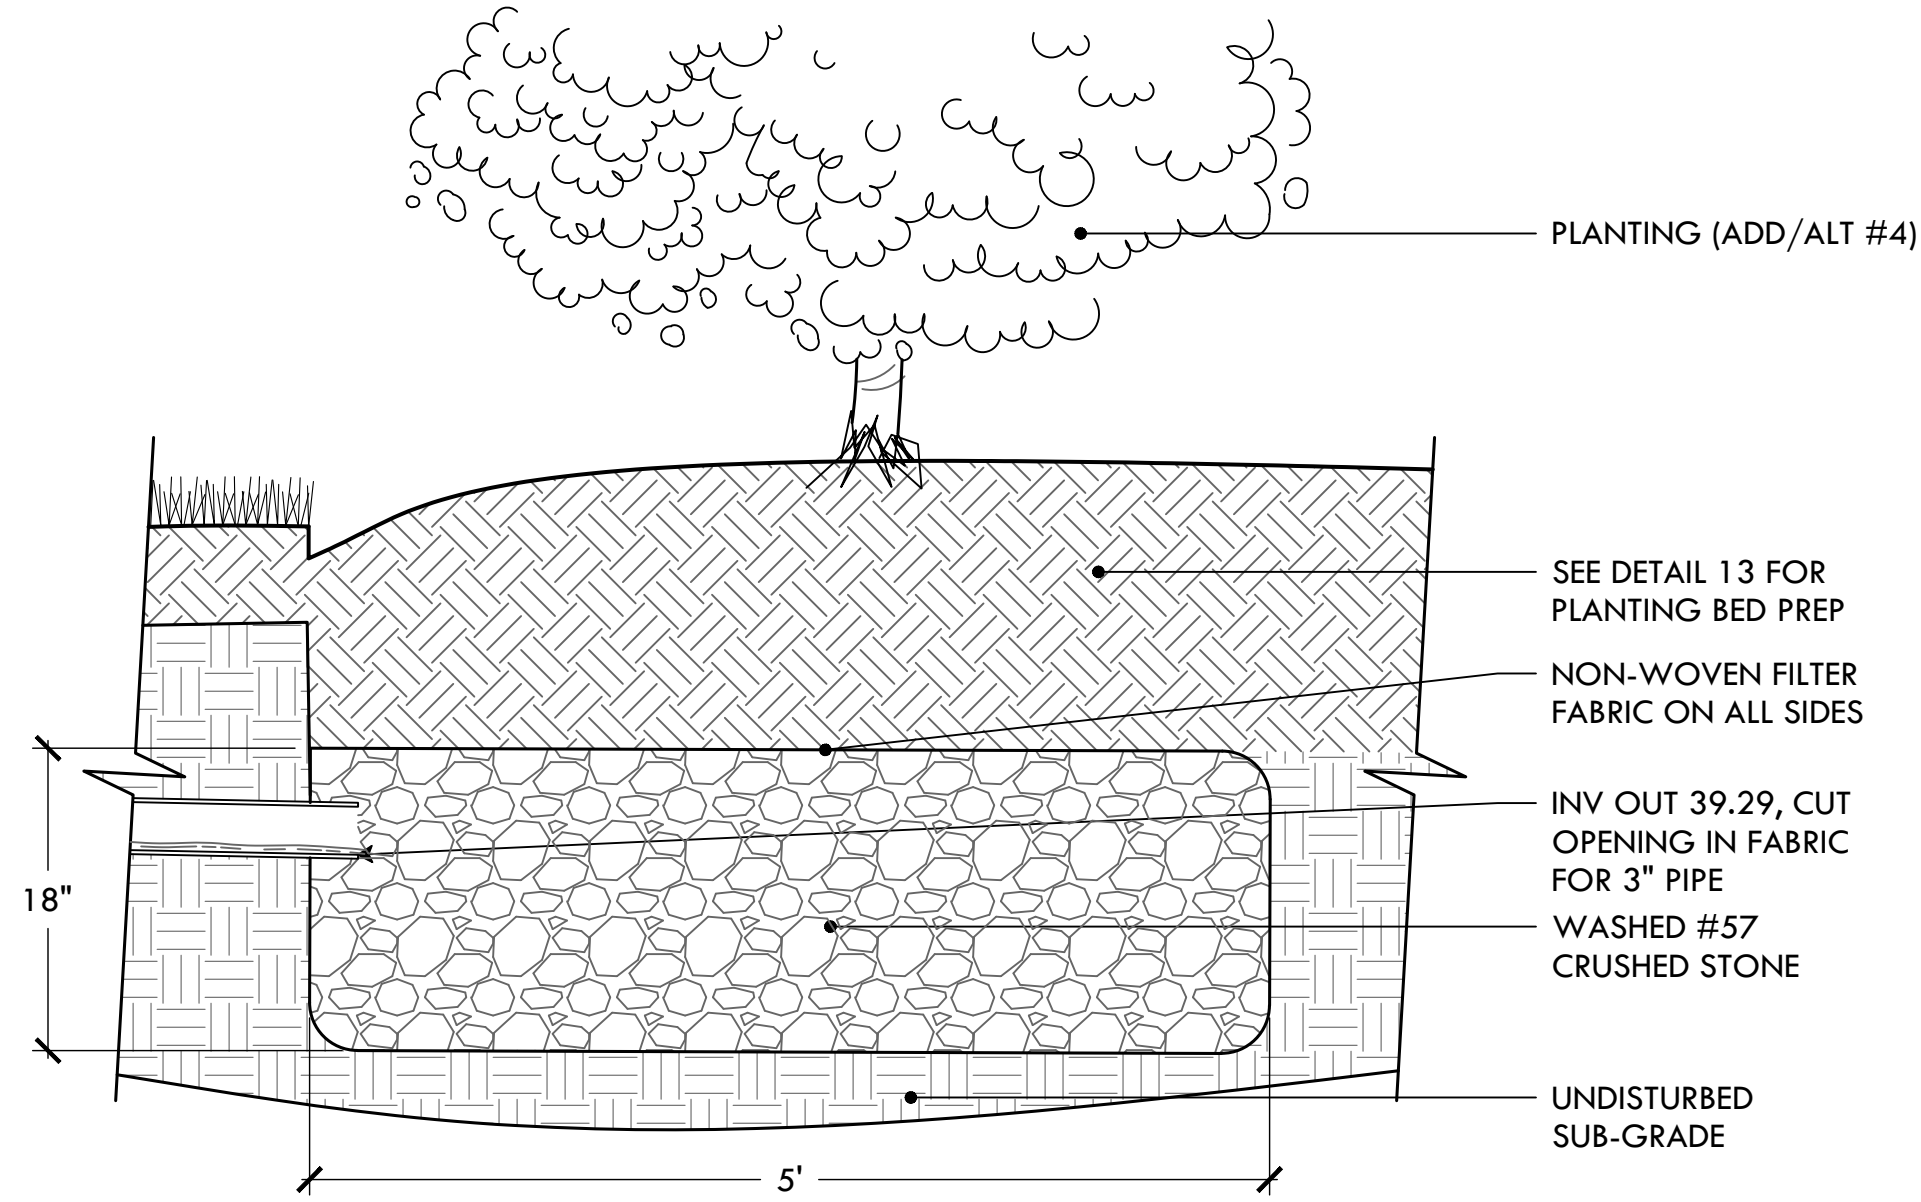

13 ADD/ALT#1: SUBGRADE DRYWELL
BASE BID: NO WORK

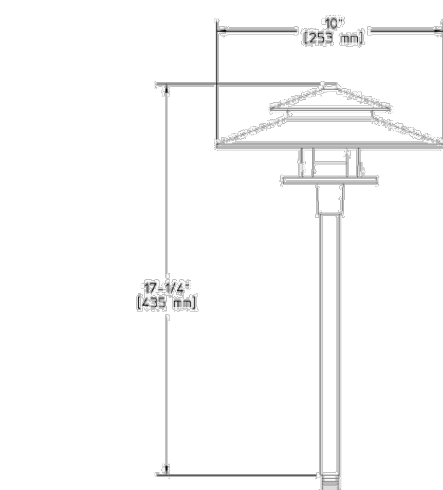

Ordering Guide	
Example: RL4 H S7 LED2W	
Product Code	RL4 LED Aluminum Path Light
Finish	Black
Mounting	S7 Mounting Stake
LED	LED2W LED Lamp

Specifications

HOUSING: Die-cast aluminum. Stem is extruded aluminum. Fasteners are 300 series stainless steel. 1/4" NPS male threads to screw onto accessory mounting stake or junction box, sold separately.

FINISH: Thermat polymer powdercoat is electrostatically applied after a two-stage conversion clearing process and bonded by heat fusion thermosetting. Laboratory tested for superior weatherability and fade resistance in accordance with ASTM B117 specifications.

OPTICAL ASSEMBLY: Frosted tempered glass lens. Spin aluminum reflector with white thermat powdercoat.

LAMPING: Philips 12V LED 1.2W Capsule lamp. Up to 80% energy savings when compared to a 10W Capsule halogen lamp. Long lifetime of 15,000 hours (B50L70). Operating temperature range is between 32C and 35C (90F and 95F). Suitable for use in enclosed luminaires where the case temperature (Tc) remains below Tc MAX. Total Lumens = 100lm. Lamp is included with fixture. Lower wattage lamps are acceptable.


ELECTRICAL ASSEMBLY: Blank socket type (S4) with 200° C high temperature teflon coated wire leads. 12 Volt fixture is pre-wired with 3-ft pigtail of 18-2 AWG, 100° C, SPT-1W wire. Low voltage quick connector, catalog #LVCS included for easy hook-up to the low voltage supply cable, not included. 12 Volt system requires remote transformer, not included.

WARRANTY: Five-year limited warranty.

CERTIFICATIONS: cETL listed to U.S. safety standards for wet locations. cETL listed to Canadian safety standards for wet locations. Manufactured to ISO 9001:2008 Standards.


Height: 17 1/2" (450mm) Width: 10" (255mm) Max. Weight: 3.18 lb.

16 LOW-VOLTAGE PATH LIGHT
NTS

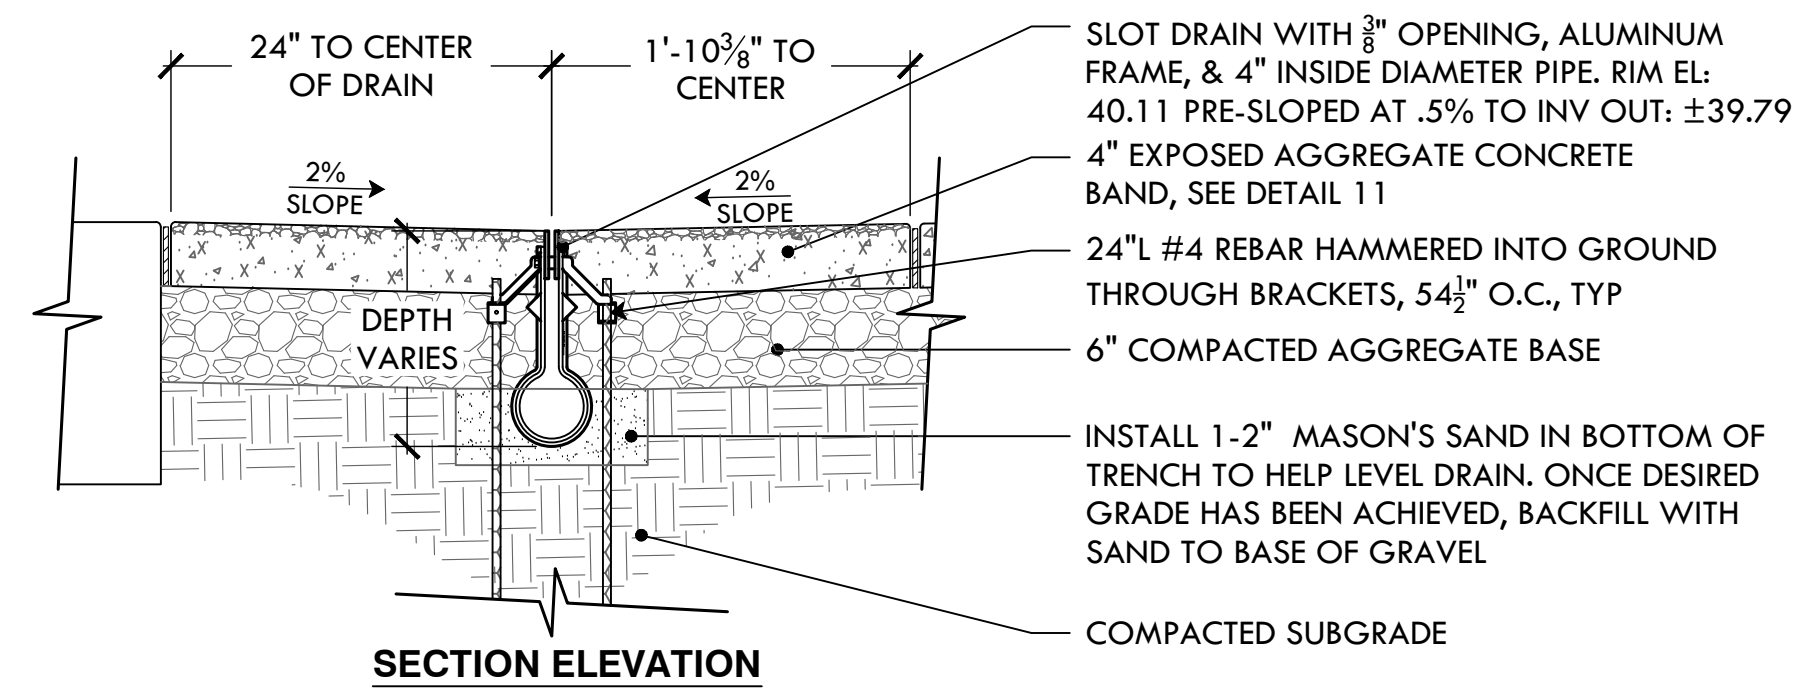


- NOTES:
1. SLOT DRAIN TO BE DURA TRENCH MODEL DTSP4-MDSPALMSV04 OR APPROVED EQUAL
 2. BEGIN INSTALLATION AT OUTLET END OF DRAIN.

11 ADD/ALT#1: 3/8" PRE-SLOPED SLOT DRAIN
BASE BID: NO WORK


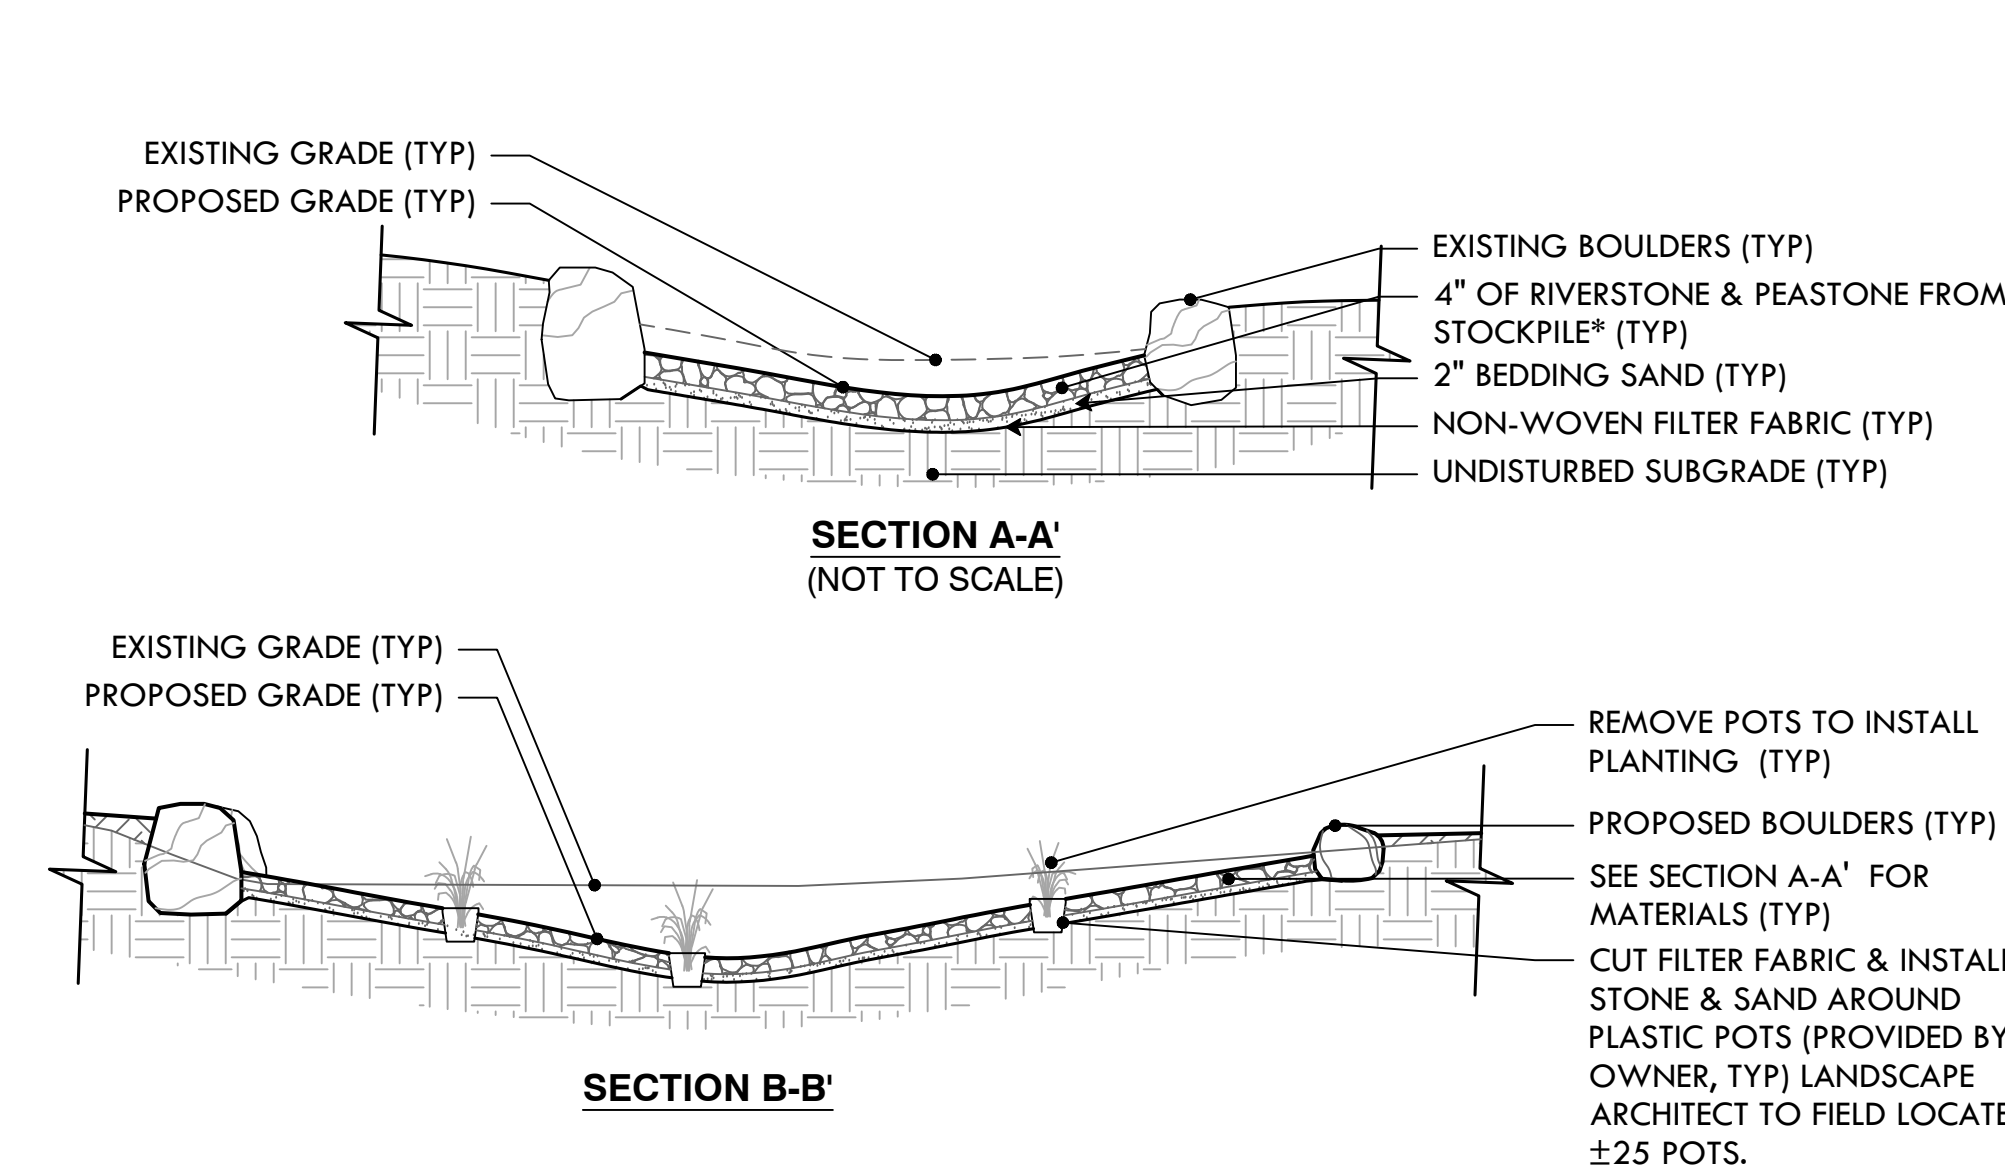


- NOTES:
1. *BEFORE INSTALLATION, STOCKPILED RIVERSTONE/PEASTONE SHOULD BE WASHED AND/OR SCREENED TO REMOVE SOIL, LEAVES AND OTHER ORGANIC MATERIAL.
 2. DO NOT EXCAVATE BELOW DEPTH OF EXISTING BOULDERS


14 ADD/ALT #2: RIVERSTONE RAINGARDEN ADJUSTMENT
NTS

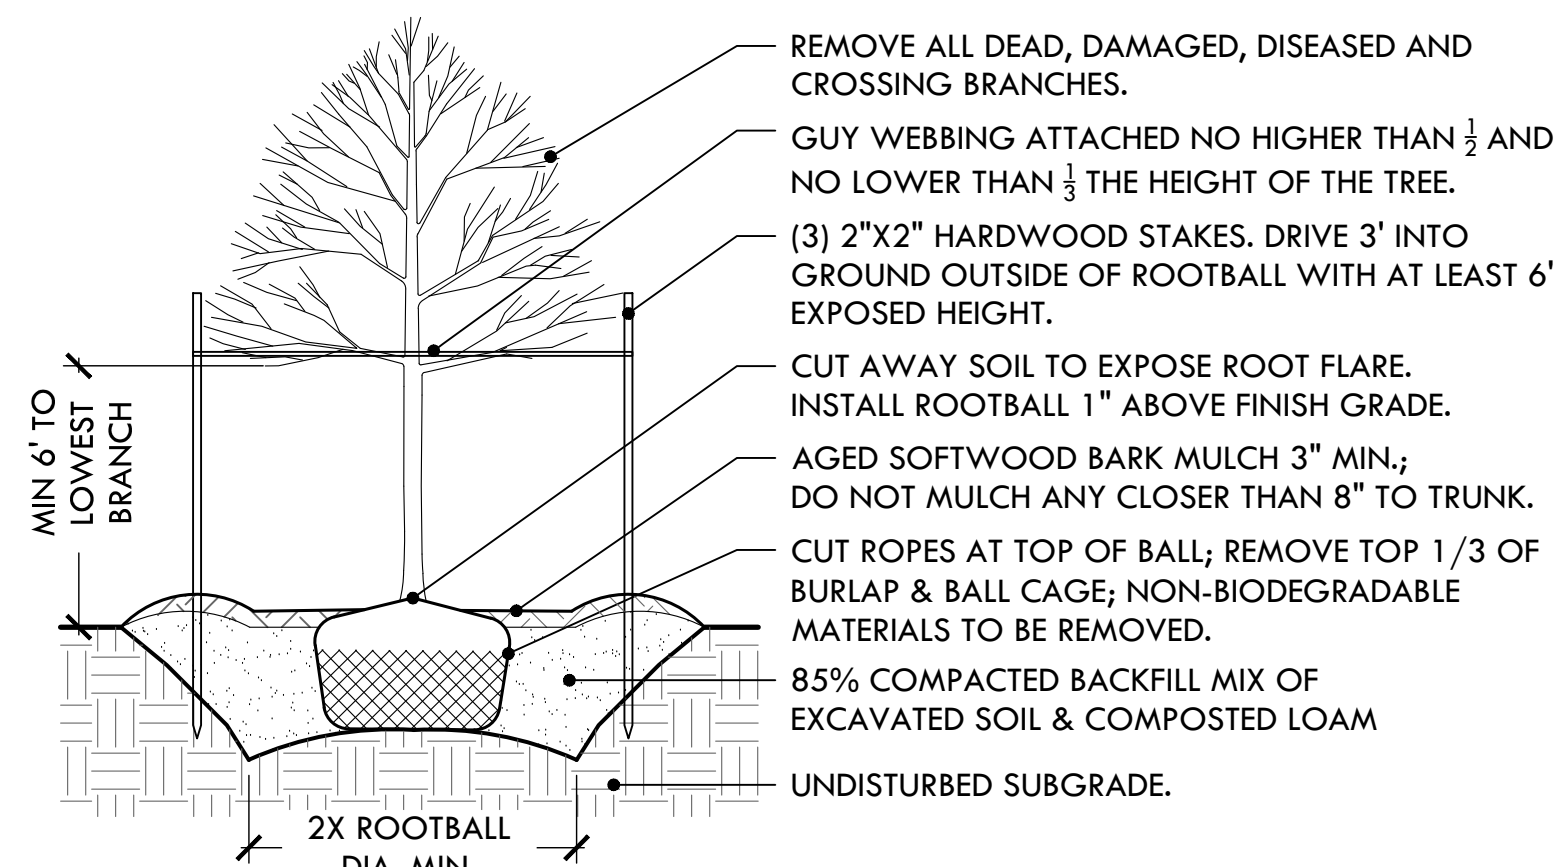


16 TREE PLANTING
NTS

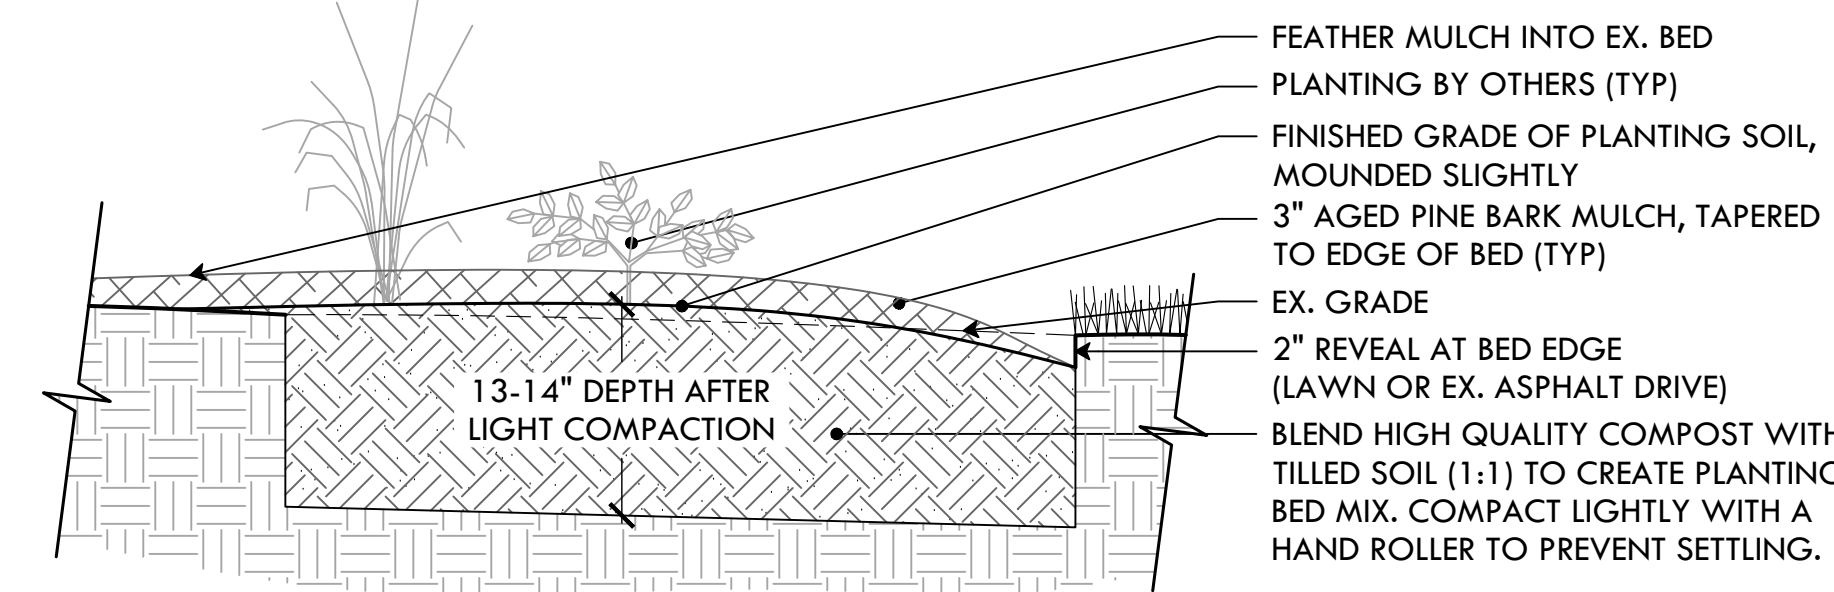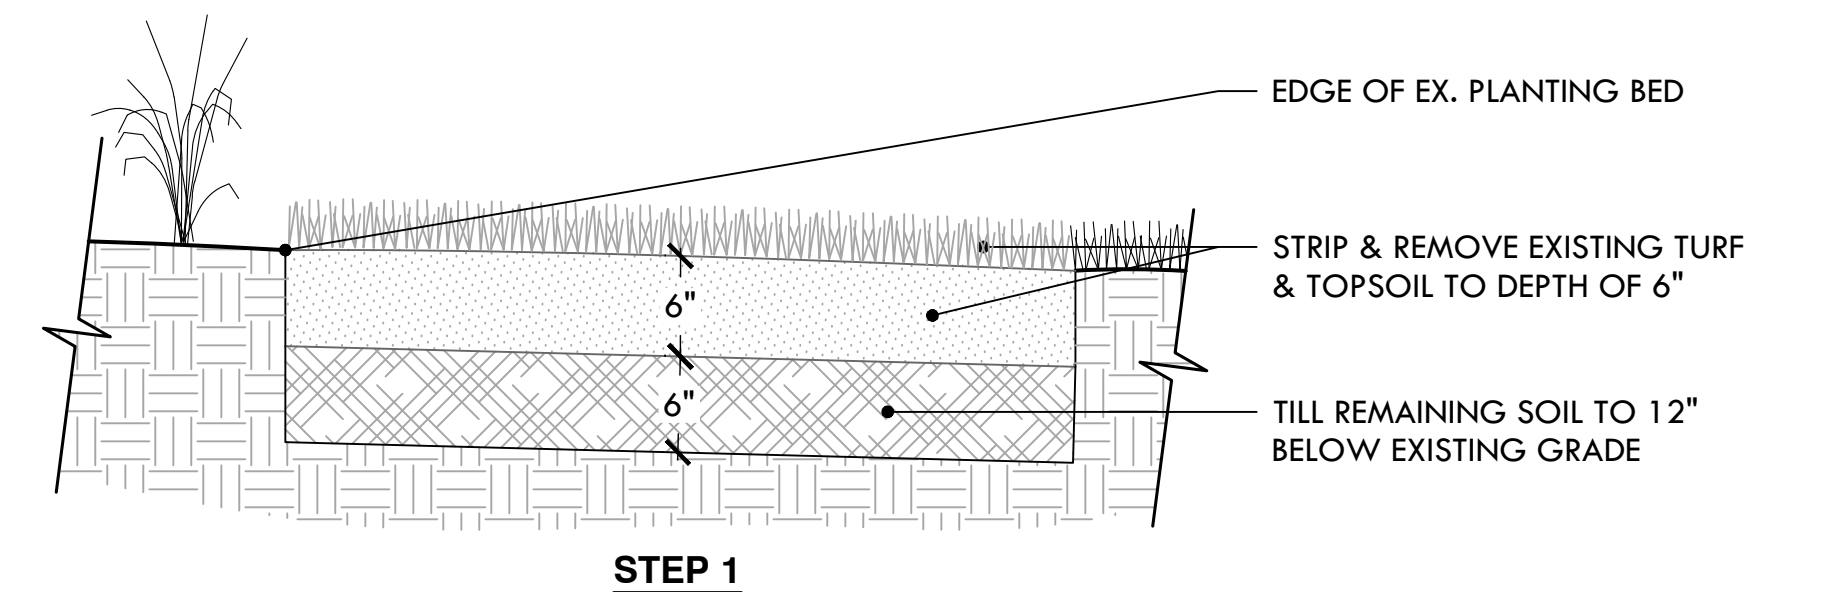

12 ADD/ALT#1: PLANTING BED PREPARATION
BASE BID: NO WORK

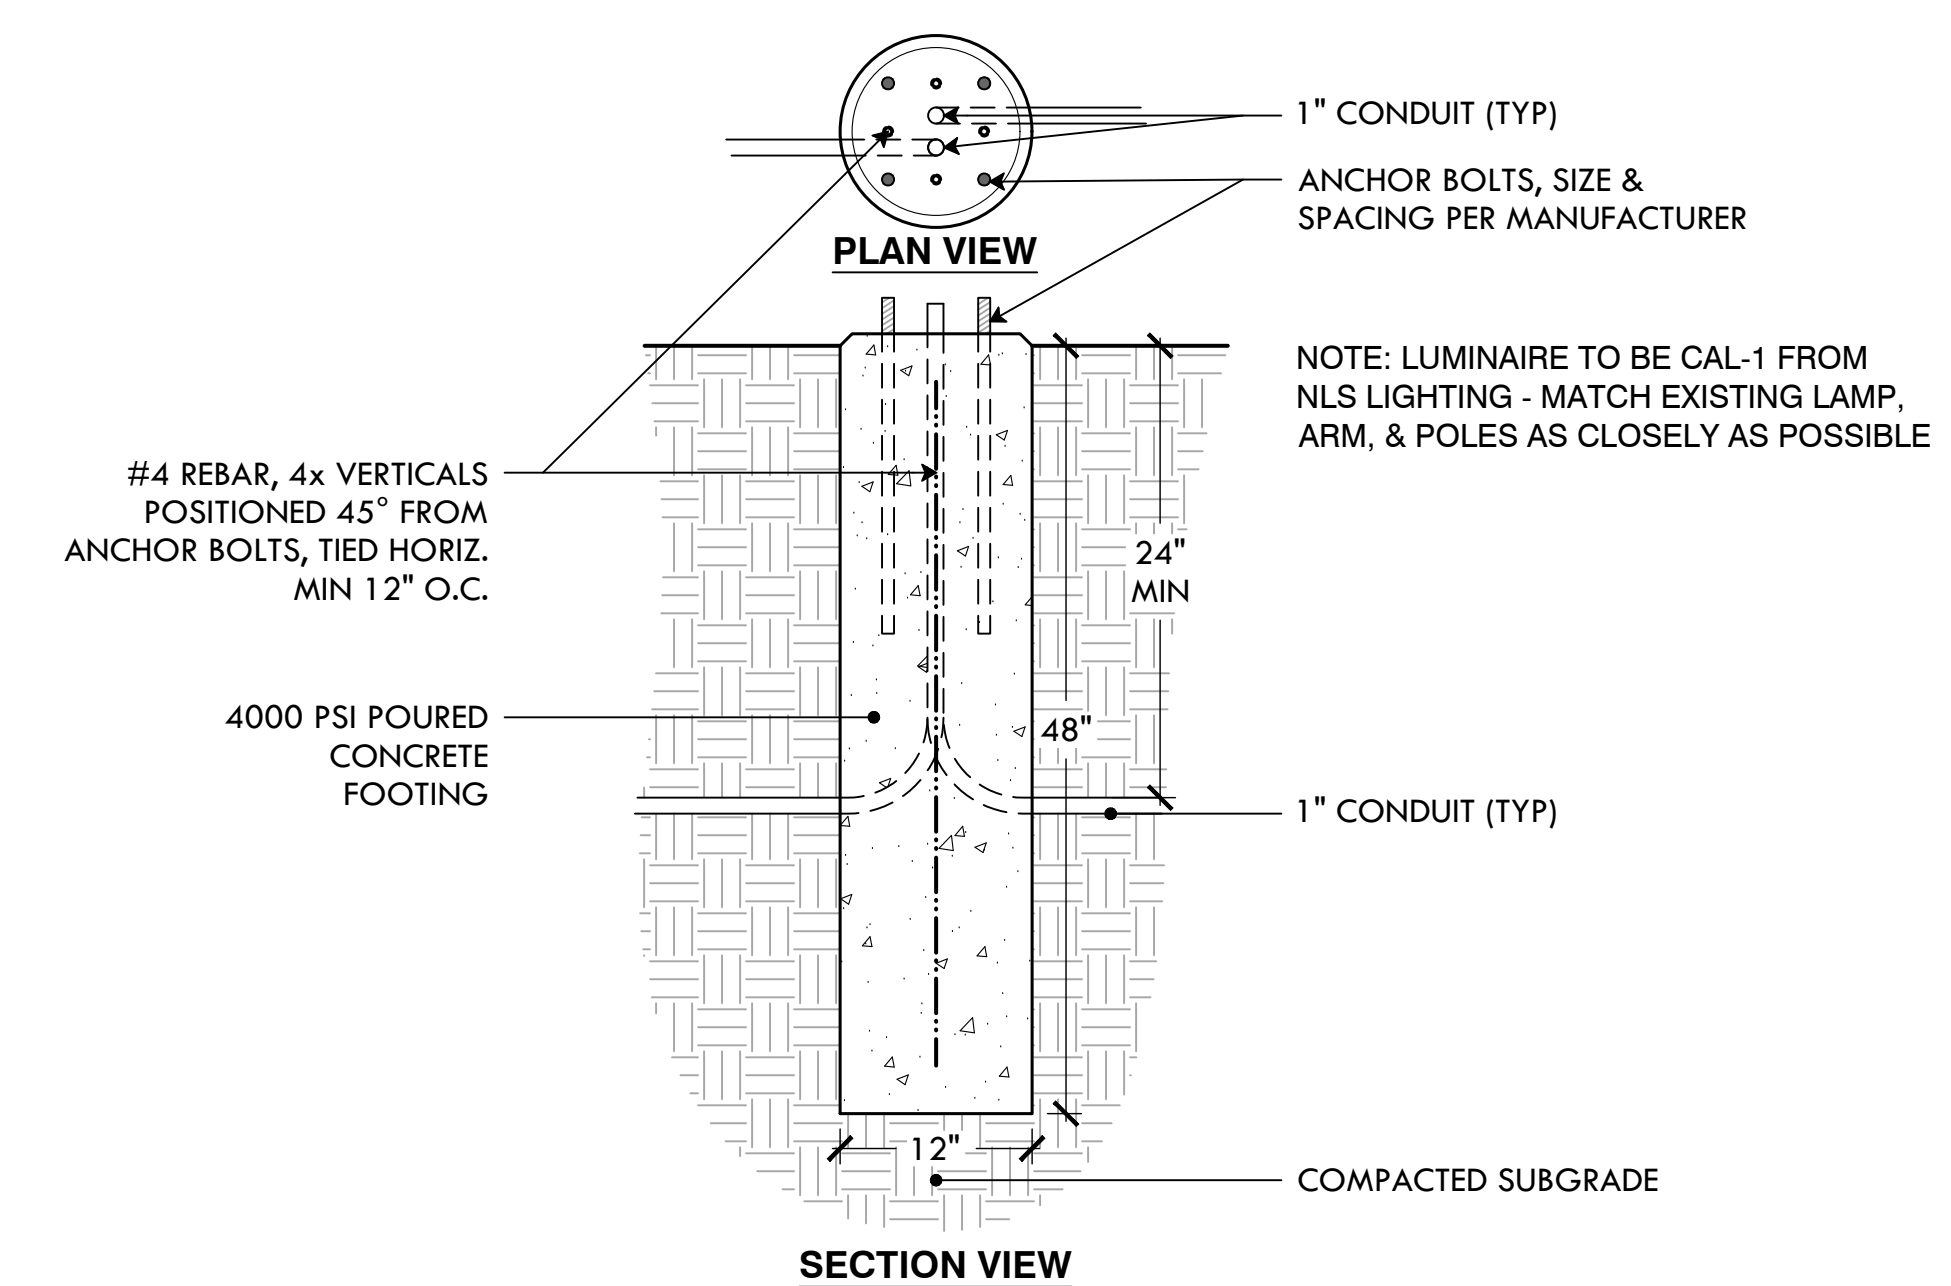

15 POLE LIGHT CONCRETE FOOTING
NTS

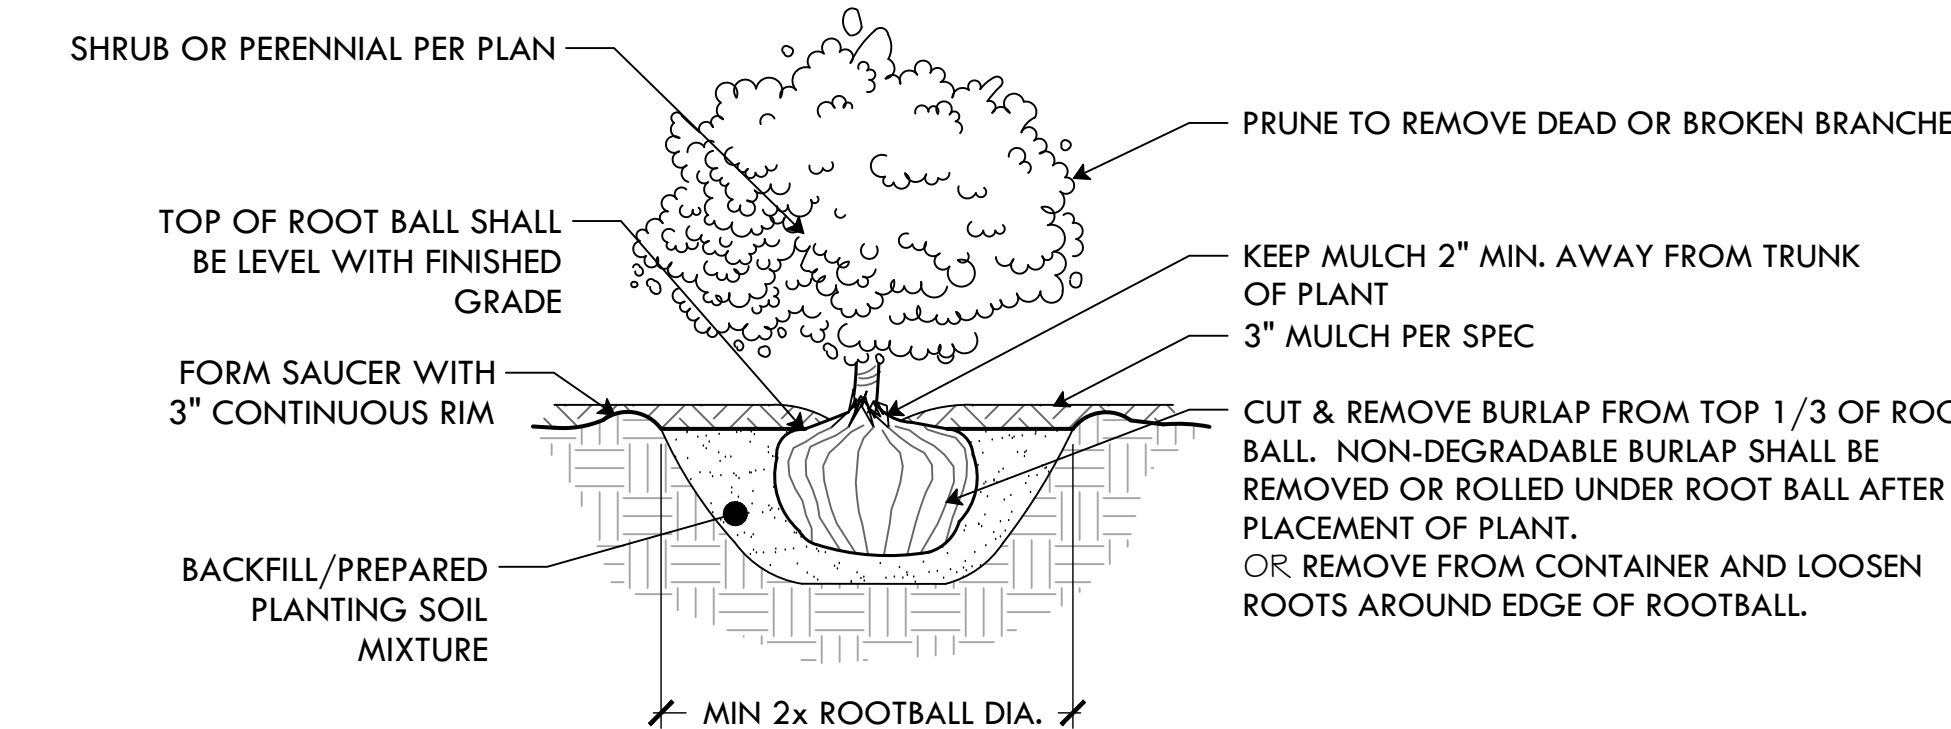

16 SHRUB PLANTING
NTS

PROVIDENCE
PARKS DEPARTMENT
DAIRYMPLE BOATHOUSE
ROGER WILLIAMS PARK
PROVIDENCE, RI 02905

COPYRIGHT (C) CITY OF
PROVIDENCE PARKS
DEPARTMENT. ALL RIGHTS
RESERVED 2023.

NO PART OF THIS DOCUMENT MAY BE
REPRODUCED, STORED IN A RETRIEVAL
SYSTEM OR TRANSMITTED IN ANY FORM OR
BY ANY MEANS, ELECTRONIC,
MECHANICAL, PHOTOCOPYING,
RECORDING OR OTHERWISE WITHOUT THE
PRIOR WRITTEN PERMISSION OF THE CITY
OF PROVIDENCE PARKS DEPARTMENT. ANY
MODIFICATIONS TO THIS DOCUMENT
WITHOUT THE WRITTEN PERMISSION OF
THE CITY OF PROVIDENCE PARKS
DEPARTMENT SHALL RENDER IT INVALID
AND UNUSABLE.

NO.	REVISION	DATE

CONSTRUCTION DETAILS 2
SITE IMPROVEMENTS AT ROGER WILLIAMS PARK EVENT PAVILION
1000 ELMWOOD AVE, PROVIDENCE, RI

DATE:	DECEMBER 21, 2023
SCALE:	NTS
DRAWN BY:	SG
CHECKED/ APPROVED:	BB
SHEET NO.	L-8
	8 OF 8