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EXTERIOR MASSING

RENDERINGS

ENGINEER:

BRETT NEILAN, PE GM2 ASSOCIATES, INC. 200 MAIN STREET, SUITE 300 PAWTUCKET, RI 02860 401-726-4084

<u>TING</u>

LIGHTING DETAILS & NOTES **OVERALL LAYOUT** LAYOUT EAST LAYOUT WEST

<u>SCAPE</u>

PLANTING PLAN

SPAZIANO MIDDLE SCHOOL

254 EASTWOOD AVENUE PLAT 107 PARCEL111 PROVIDENCE, RHODE ISLAND

FEBRUARY 2024

PREPARED FOR CITY OF PROVIDENCE **25 DORRANCE STREET** PROVIDENCE, RI 02903 401.680.5000






LOCATION MAP NOT TO SCALE

CITY OF PROVIDENCE DEPARTMENT OF PLANNING AND DEVELOPMENT MASTER PLAN / PRELIMINARY PLAN SUBMISSION FEBRUARY 20, 2024 (REVISED MARCH 15, 2024)

C-0

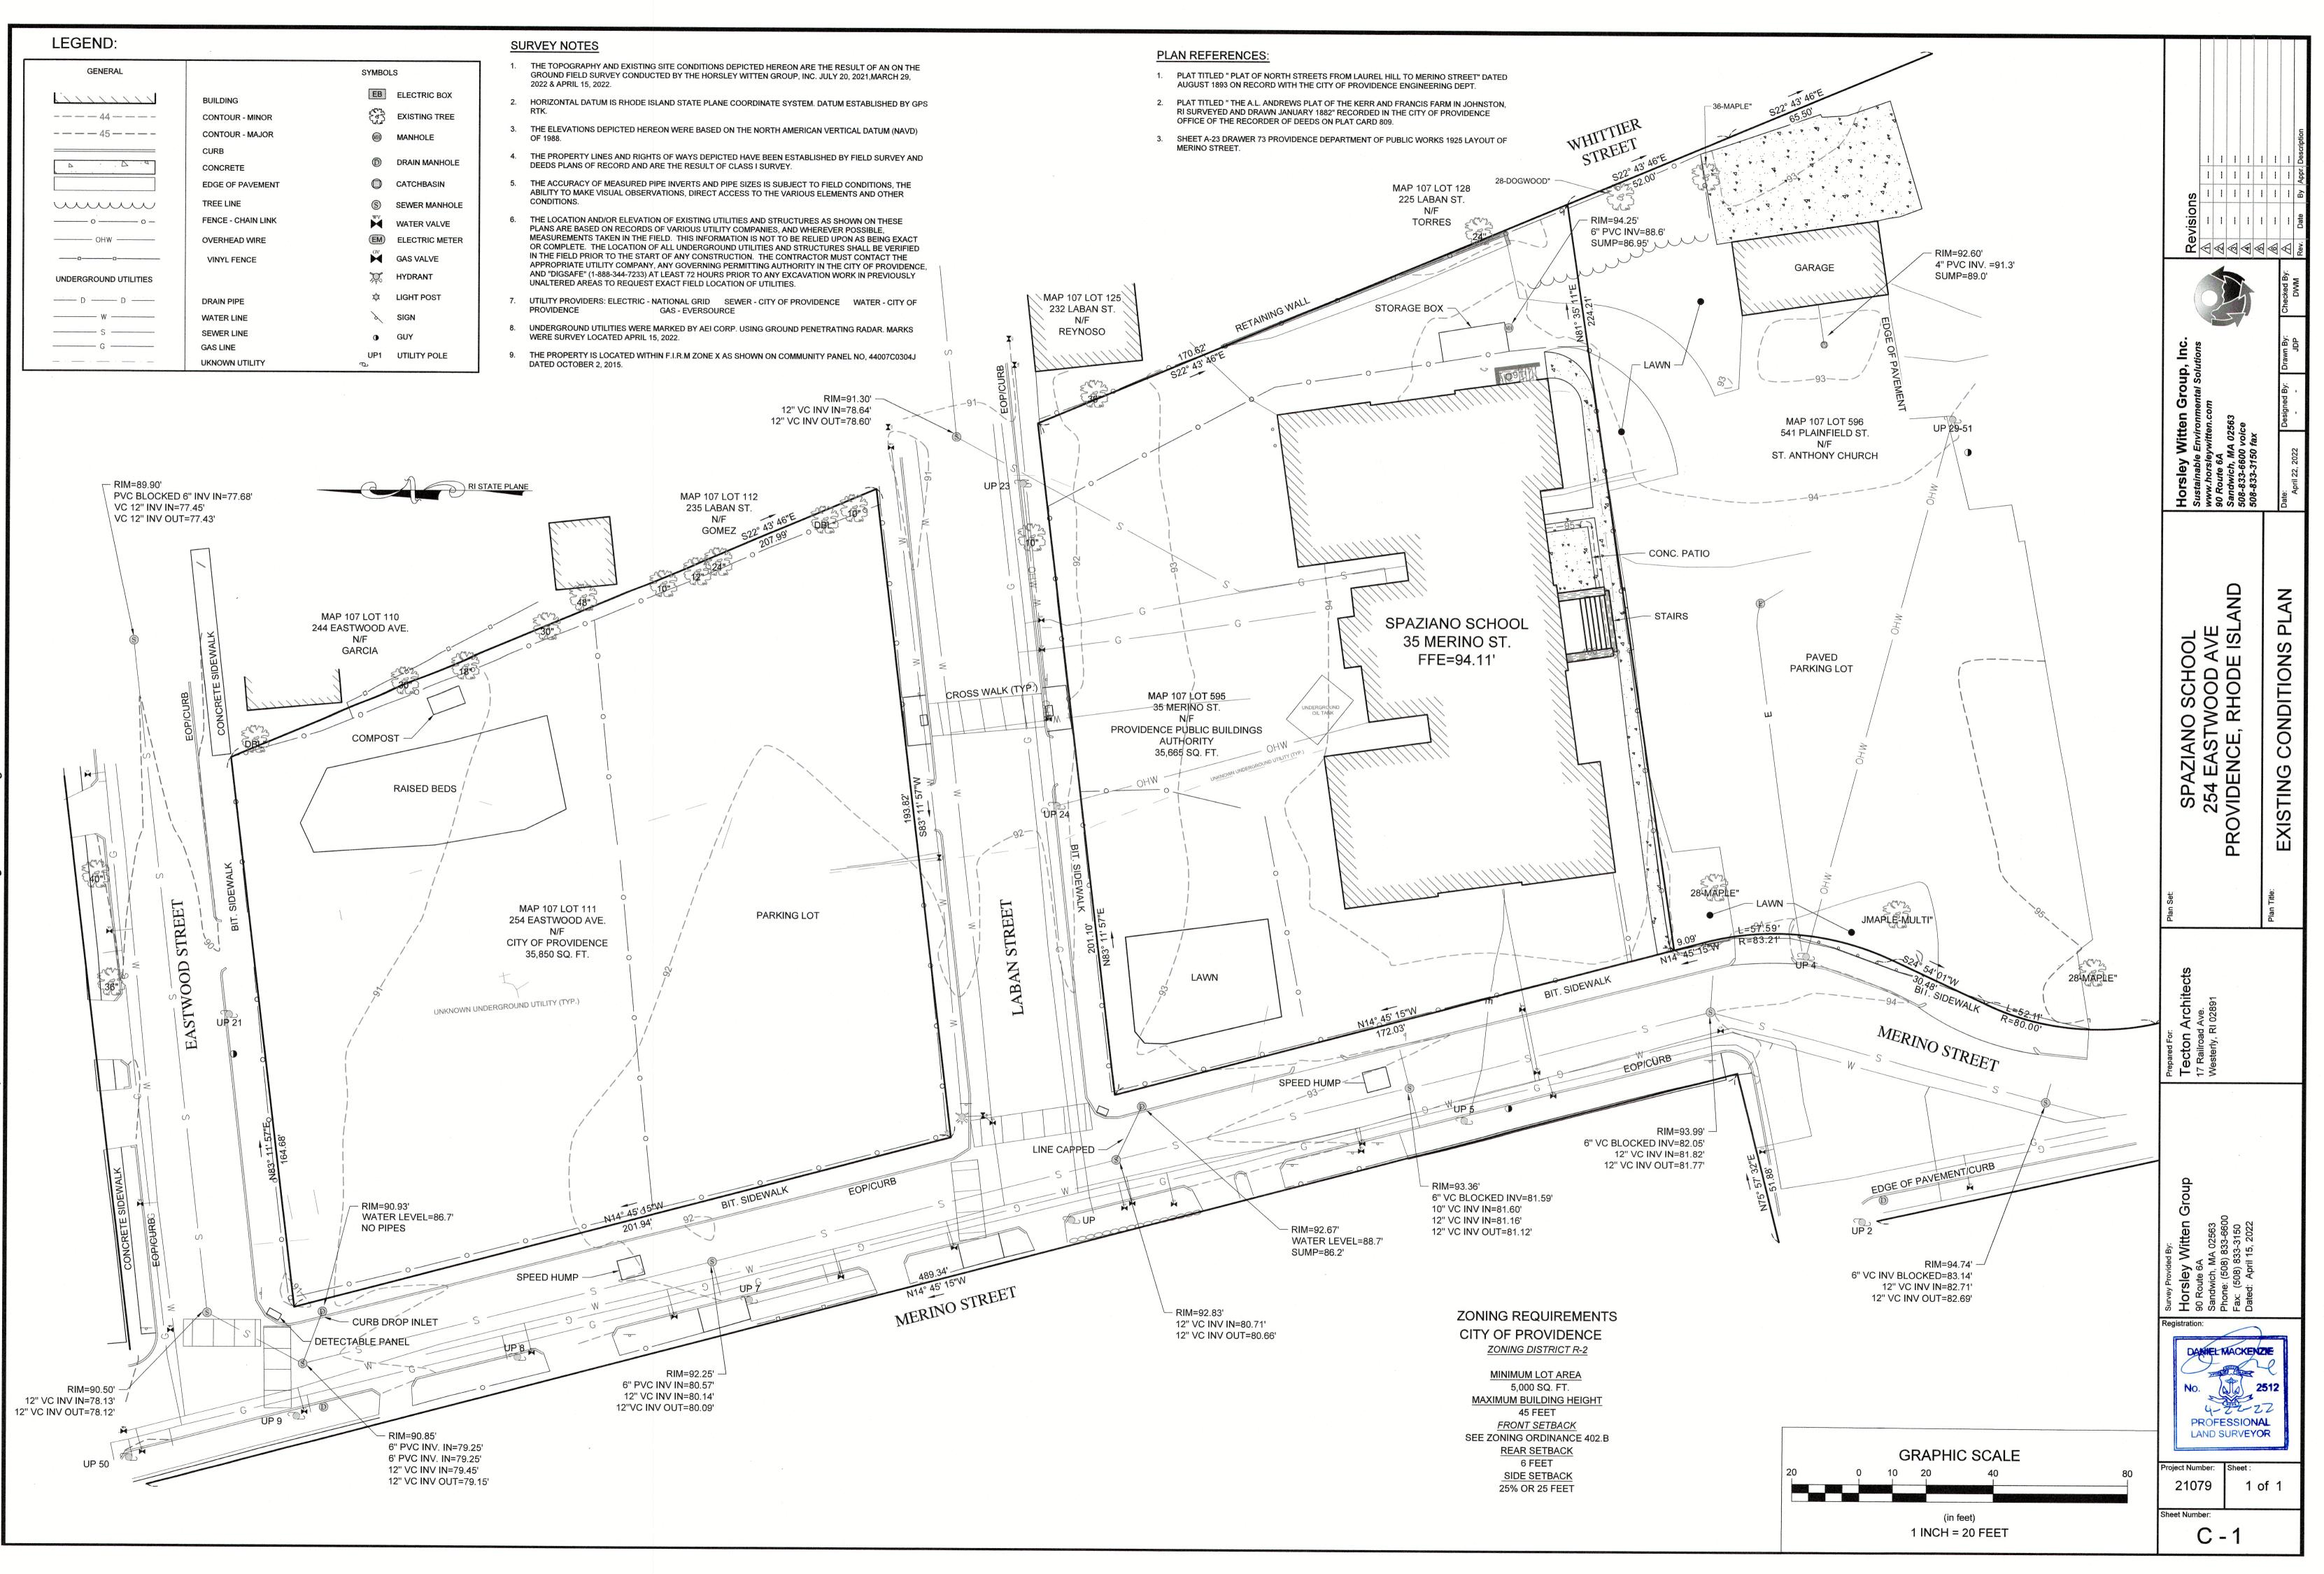

	ĺ	G	ENERAL NOTES:		DF	RAINAGE AND E
	А	1.	REFERENCE IS MADE TO THE LATEST EDITIONS OF THE RHODE ISLAND DEPARTMENT OF TRANSPORTATION (RIDOT) "STANDARD SPECIFICATIONS FOR ROAD AND BRIDGE CONSTRUCTION, 2022 EDITION" (INCLUDING ALL SUBEQUENTLY ISSUED SUPPLEMENTS, REVISIONS AND ADDENDA) AND THE "RHODE ISLAND STANDARD DETAILS, 1998 EDITION" (AMENDED JUNE 2019, INCLUDING ALL SUBEQUENTLY ISSUED SUPPLEMENTS, REVISIONS, AND ADDENDA). ALL PROJECT SITE IMPROVEMENTS SHALL CONFORM TO THE APPLICABLE STANDARDS SET FORTH IN THESE DOCUMENTS (INCLUDING ALL SUB-REFERENCES INCORPORATED THEREIN) UNLESS OTHERWISE NOTED.	·		FOR ALL PROJECTS W RIPTA IS REQUIRED EROSION AND SEDIM COMPLIANCE WITH T DISCHARGES ASSOCI CONTRACTOR SHALL R THE PROVISIONS, CON AND THE SITE SPECI
		1.1	. THE RIDOT "STANDARD SPECIFICATIONS FOR ROAD AND BRIDGE CONSTRUCTION" IS VIEWABLE VIA THE FOLLOWING WEBSITE ADDRESS: http://www.dot.ri.gov/business/bluebook.php			DOCUMENTS ARE INCL ASSOCIATED WITH AN INCIDENTAL TO THE C PRICE FOR SITE WORK.
		1.2	. THE RIDOT "STANDARD DETAILS" IS VIEWABLE VIA THE FOLLOWING WEBSITE ADDRESS: https://www.dot.ri.gov/documents/doingbusiness/RIDOT_Std_Details.pdf	:	2.	NO UNDISTURBED AR AFTER OCTOBER 15 OF OR LIMITED WINTER SI
	В	2.	ANY DAMAGE TO EXISTING PAVEMENT, CONDUIT, UTILITIES, SIDEWALK, FENCES, ETC., CAUSED BY THE CONTRACTOR SHALL BE REPAIRED AND RESTORED BY THE CONTRACTOR AT NO ADDITIONAL COST TO THE CITY OF PROVIDENCE.			OCTOBER 15 OF ANY C THAT DATE. ANY SUCH STABILIZATION, AS ENVIRONMENTAL INSP MUST BE STABILIZED T
	_		THE CONTRACTOR SHALL PLACE ALL EQUIPMENT AND MATERIAL AS FAR AWAY AS POSSIBLE FROM THE EDGE OF THE TRAVEL LANE SO AS NOT TO CAUSE A SAFETY HAZARD, IN ACCORDANCE WITH SECTION 106.06 OF THE R.I.D.O.T. STANDARD SPECIFICATION, LATEST EDITION. EQUIPMENT STORAGE SHALL BE COORDINATED WITH THE RIPTA PRIOR TO CONSTRUCTION.			HAY MULCH, IN ACCOR R.I. SOIL EROSION AND WITHIN ANY OF THES THROUGH APRIL 15, CA REQUIRED FOR THAT MUST BE RESTABILIZED PROBLEMS RESULTING
	С		IT IS THE CONTRACTOR'S RESPONSIBILITY TO ENSURE THAT THE EXISTING CONDITIONS ARE NOT OBLITERATED BEFORE CONTROL POINTS ARE LOCATED AND CONSTRUCTION LAYOUT IS ESTABLISHED. THE FREQUENCY AND APPLICATION RATES FOR THE DUST CONTROL ITEMS			SHALL BE THE RESPO SEPARATE PAYMENT INCIDENTAL TO CONST OR ANOTHER AS DESC FINAL GRADING.
		6.	SHALL BE COMPLETED IN ACCORDANCE WITH THE PROJECTS SOIL EROSION AND SEDIMENT CONTROL (SESC) PLAN, OR AS DIRECTED BY THE OWNER AND/OR ENGINEER. ASPHALT EMULSION TACK COAT SHALL BE PLACED PRIOR TO PAVEMENT		3.	STOCKPILES SHALL F STOCKPILES OF ERODA WITH R.I. STD. 9.1.0
	_		PLACEMENT ON THE CONCRETE BASE OR COLD PLANED PAVEMENT, AND ON ANY NEW COURSE WHICH HAS BEEN OPEN TO TRAFFIC, OR ANY NEW COURSE WHICH HAS BEEN EXPOSED FOR MORE THAN 3 DAYS, AND/OR AS DIRECTED BY THE ENGINEER. IT SHALL ALSO BE APPLIED TO VERTICAL PAVEMENT FACES BETWEEN ADJOINING PAVEMENT SECTIONS. ALL APPLICATIONS ON BOTH HORIZONTAL AND VERTICAL SURFACES SHALL BE PAID FOR UNDER THE CONTRACT UNIT LUMP SUM PRICE FOR SITE WORK.		4.	ACCORDANCE WITH TH IF THE PLANS INCLUDE DEWATERING BASINS STOCKPILING, AND IF AREAS FOR THESE PUI ONLY AFTER OBTAIN MODIFICATIONS FROM
	D	7.	THE LIMITS OF CLEARING AND SURFACE DISTURBANCE MUST BE STRICTLY ADHERED TO IN ALL AREAS.			PERMITTING REQUIRE CONTRACTOR AND SH THE ENGINEER WILL (
			CLEANING AND SWEEPING SHALL BE DONE AT THE CONCLUSION OF EACH WORK DAY WITHIN THE CITY OF PROVIDENCE'S RIGHT-OF-WAY AS NEEDED.	:	5.	APPLICATION MATERIAI SEEDING ON ALL SLC FOLLOWING APPLICATIO
	_	9.	CLEANING AND SWEEPING OF PAVEMENT WILL INCLUDE REMOVAL OF ALL PAVEMENT DEBRIS PRIOR TO THE PLACEMENT OF EACH BITUMINOUS LIFT. ALL CLEANING AND SWEEPING SHALL BE DONE TO THE SATISFACTION OF THE ENGINEER.			SEEDING TYPE I.
		10.	PRIOR TO INSTALLATION, ALL SIGNS, MOUNTINGS AND LOCATIONS SHALL BE APPROVED OR MODIFIED BY THE CITY OF PROVIDENCE AND/OR ENGINEER.		6.	ADHESIVE MULC UNVEGETATED SLOP PERIODS IN EXCESS
	E		PAVEMENT OPERATIONS FOR CURBED SECTIONS: IN AREAS WHERE CURBING IS SET TO FINISH LINE AND GRADE, THE CONTRACTOR WILL NOT BE REQUIRED TO UTILIZE THE SENSOR AND SKY-TYPE DEVICE FOR AUTOMATIC GRADE CONTROL, BUT WILL BE ALLOWED TO MANUALLY ADJUST THE BITUMINOUS PAVER FOR CONTROLLING GRADE.		7.	SEASON. PRIOR TO DRAINAGE RESPONSIBLE FOR VER ALL EXISTING PIPES A ANY VARIATION FOUN ENGINEER'S ATTENTIO
		12.	THE CONTRACTOR SHALL BE RESPONSIBLE FOR MAINTAINING ALL ROADWAYS FREE OF DEBRIS RESULTING FROM THEIR CONSTRUCTION OPERATIONS. ALL DEBRIS SHALL BE REMOVED TO THE SATISFACTION OF THE ENGINEER AT NO ADDITIONAL COST TO THE CITY OF PROVIDENCE.		8.	ALL DRAINAGE AND U SHALL BE ADJUSTED T TO THE WINTER SHUTD
	F	13.	NO FUEL STORAGE, VEHICLE REFUELING, OR EQUIPMENT STORAGE SHALL TAKE PLACE IN DESIGNATED WETLANDS, NOR WITHIN 100' OF ANY WATER BODY. THIS REQUIREMENT SHALL NOT SUPERSEDE ANY FEDERAL, STATE OR LOCAL LAW, ORDINANCE, RULE OR REGULATION THAT APPLIES TO THE SAME, UNLESS THIS REQUIREMENT IS MORE STRINGENT THAN SAID LAW, ORDINANCE, RULE OR REGULATION.			DURING CONSTRUCTIO MAINTAINING DRAINAG OF RAINFALL THROUGH
	_	14.	THE CONTRACTOR SHALL BE RESPONSIBLE TO ENSURE THAT AT THE END OF FINAL PAVING OPERATIONS, FLOW TO EXISTING DRAINAGE STRUCTURES HAS BEEN REESTABLISHED AND THAT NO ISOLATED DEPRESSIONS REMAIN. THERE SHALL BE NO SEPARATE PAYMENT FOR THIS PROVISION; IT SHALL BE CONSIDERED INCIDENTAL TO PAVING AND INCLUDED IN THE BID FOR SITE			APPROVED EROSION C THE PROJECT SOIL WHENEVER SUBBASE I UNTIL THE ABUTTING G THE TOE OF ANY FILI
	G	15.	WORK. ALL EMBANKMENTS SHALL BE PLACED IN HORIZONTAL LAYERS NOT EXCEEDING 12" (AFTER COMPACTION) AND SHALL BE COMPACTED AS SPECIFIED BEFORE THE NEXT LAYER IS PLACED. ALSO, EMBANKMENT CONSTRUCTION SHALL CONFORM TO SECTION 202.03.2 OF THE R.I.D.O.T.			EROSION CONTROLS. U COVER ANY PORTION O ANY MATERIAL THAT CONTRACTOR, OR ANY REMOVED BY THE CO EROSION CONTROLS AO
		16.	STANDARD SPECIFICATIONS, LATEST EDITION. THE CONTRACTOR SHALL READ, BECOME FAMILIAR WITH, AND ADHERE TO ALL OF THE PROVISIONS, CONDITIONS, AND STIPULATIONS STATED IN THE ENVIRONMENTAL APPROVALS ISSUED FOR THE PROJECT FROM THE DEPARTMENT OF ENVIRONMENTAL MANAGEMENT (RIDEM). COPIES OF APPLICABLE PERMITS ARE INCLUDED IN THE CONTRACT DOCUMENTS. ALL		12.	PRIOR TO COMMEN SEDIMENTATION CONTR ON THE PLANS. CLEAR CONTROLS, HOWEVER DISTURBANCE SHALL CLEARING AND SURFAU ALL AREAS.
			COSTS ASSOCIATED WITH THESE CONDITIONS SHALL BE CONSIDERED INCIDENTAL TO THE CONSTRUCTION AND INCLUDED WITH THE BID FOR SITE WORK.		13.	ALL APPROVED EROS REMAIN IN PLACE UNTIL NEEDED, TEMPORARY S SEED WILL CONFORM T
	н				14.	THE NORMAL ACCEPT SUBSECTION L.02.03 C EDITION.
2/15/2024 10:48:21 AM			40	0		
	I		10 I 9 I	8		7

EROSION CONTROL NOTES:

WITH AT LEAST ONE(1) ACRE OF SOIL DISTURBANCE. TO DEVELOP AND ENFORCE A SITE SPECIFIC SOIL MENT CONTROL PLAN IN ORDER TO REMAIN IN THE RIPDES GENERAL PERMIT FOR STORMWATER CIATED WITH CONSTRUCTION ACTIVITIES. THE READ, BECOME FAMILIAR WITH, AND ADHERE TO ALL OF NDITIONS, AND STIPULATIONS OF THE GENERAL PERMIT CIFIC SESC FOR THIS PROJECT. COPIES OF THESE CLUDED IN THE CONTRACT DOCUMENTS. ALL COSTS ADHERENCE TO THE SESC SHALL BE CONSIDERED CONSTRUCTION AND IS INCLUDED IN THE LUMP SUM

EAS SHALL BE CLEARED OF EXISTING VEGETATION ANY CALENDAR YEAR OR DURING ANY PERIOD OF FULL SHUTDOWN. ALL DISTURBED SOILS EXPOSED PRIOR TO CALENDAR YEAR SHALL BE SEEDED OR PROTECTED BY H AREAS THAT DO NOT HAVE ADEQUATE VEGETATIVE DETERMINED BY THE RESIDENT ENGINEER OR PECTOR, BY NOVEMBER 15 OF ANY CALENDAR YEAR, HROUGH THE USE OF EROSION CONTROL MATTING OR RDANCE WITH SPECIFICATIONS CONTAINED WITHIN THE SEDIMENT CONTROL HANDBOOK. IF WORK CONTINUES SE AREAS DURING THE PERIOD FROM OCTOBER 15 ARE MUST BE TAKEN TO ENSURE THAT ONLY THE AREA DAY'S WORK IS EXPOSED, AND ALL ERODABLE SOIL ED WITHIN 5 WORKING DAYS. ANY WORK TO CORRECT G FROM FAILURE TO COMPLY WITH THIS PROVISION DNSIBILITY OF THE CONTRACTOR. THERE WILL BE NO FOR THIS PROVISION, IT SHALL BE CONSIDERED TRUCTION OPERATIONS. STABILIZATION OF ONE FORM RIBED ABOVE SHALL BE ACHIEVED WITHIN 2 WEEKS OF

HAVE SIDE SLOPES NO GREATER THAN 30% AND DABLE MATERIAL SHALL ALSO BE SEEDED AND RINGED TO STABILIZE. STOCKPILES SHALL BE USED IN HE PROJECT SPECIFICATIONS.

E SPECIFIC AREAS FOR PLACEMENT OF CONSTRUCTION AND/OR EQUIPMENT AND MATERIALS STORAGE AND THE CONTRACTOR ELECTS TO UTILIZE ANY OTHER JRPOSES, THIS SHALL BE APPROVED BY THE ENGINEER NING ANY NECESSARY PERMITS AND/OR PERMIT THE APPROPRIATE REGULATORY AUTHORITY(IES). ANY EMENTS SHALL BE THE RESPONSIBILITY OF THE HALL BE ACCOMPLISHED AT NO COST TO THE STATE. COORDINATE SUBMISSION OF ANY REQUIRED PERMIT ALS WITH THE CITY OF PROVIDENCE.

OPES 3 TO 1 OR STEEPER SHALL CONSIST OF THE ONS UNLESS CHANGED IN THE CONTRACT.

CH STABILIZER

PES SHALL NOT BE UNATTENDED OR EXPOSED FOR OF 2 WEEKS OR THROUGH THE INACTIVE WINTER

AND UTILITY CONSTRUCTION, THE CONTRACTOR IS RIFYING THE LOCATION (HORIZONTAL AND VERTICAL) OF AND/OR STRUCTURES WHICH ARE TO BE CONNECTED. ND FROM THE PLANS MUST BE BROUGHT TO THE ON PRIOR TO DRAINAGE AND UTILITY CONSTRUCTION. E ONLY UPON THE ENGINEER'S AUTHORIZATION.

UTILITY STRUCTURES WITHIN THE PAVED ROADWAY TO GRADE WITH THE SURROUNDING PAVEMENT PRIOR DOWN.

ON, THE CONTRACTOR SHALL BE RESPONSIBLE FOR GE AND RUNOFF FLOW DURING STORMS AND PERIODS HOUT THE WORK AREA. DURING CONSTRUCTION,

CONTROLS SHALL BE INSTALLED IN ACCORDANCE WITH EROSION AND SEDIMENT CONTROL (SESC) PLAN IS EXPOSED, AND CONTROLS SHALL REMAIN IN PLACE GROUND SURFACES ARE STABILIZED.

L SLOPE IS TO REMAIN AT LEAST 1' INSIDE OF ALL UNDER NO CIRCUMSTANCES SHALL THE CONTRACTOR OF THE EROSION CONTROL MEASURES WITH MATERIAL. IS PLACED ON ANY EROSION CONTROLS BY THE Y AGENT OF THE CONTRACTOR, SHALL BE IMMEDIATELY ONTRACTOR, AND ANY NECESSARY REPAIRS TO THE ACCOMPLISHED.

NCING CONSTRUCTION ACTIVITIES, EROSION AND ROLS SHALL BE INSTALLED AT THOSE AREAS INDICATED ARING MAY OCCUR PRIOR TO INSTALLATION OF SUCH R NO GRUBBING, GRADING, FILLING, OR OTHER SOIL OCCUR PRIOR TO INSTALLATION. THE LIMITS OF ACE DISTURBANCE MUST BE STRICTLY ADHERED TO IN

SION CONTROLS OR TEMPORARY PROTECTION SHALL IL AN ACCEPTABLE STAND OF GRASS IS ESTABLISHED. IF SEEDING CAN HELP TO MINIMIZE EROSION. TEMPORARY TO R.I.D.O.T. STANDARD TEMPORARY SEED MIX.

TABLE SEASONAL SEEDING DATES ARE SPECIFIED IN OF THE R.I.D.O.T. STANDARD SPECIFICATIONS, LATEST

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UTILITY NOTES:

- 1. EXISTING UTILITIES HAVE BEEN SHOWN ON THE PLANS USING THE BEST AVAILABLE INFORMATION AND ARE APPROXIMATE.
- 2. THE CONTRACTOR SHALL VERIFY THE LOCATIONS OF ALL EXISTING DRAINAGE AND UTILITIES BOTH UNDERGROUND AND OVERHEAD BEFORE EXCAVATION BEGINS IN ACCORDANCE WITH CHAPTER 39-1.2 OF THE R.I. GENERAL LAWS ENTITLED "EXCAVATION NEAR UNDERGROUND UTILITY FACILITIES", WITH AMENDMENTS EFFECTIVE AS OF NOVEMBER 1, 2009 AND, WHEN NECESSARY, BY CONTACTING THE INDIVIDUAL UTILITY COMPANIES. EXCAVATION SHALL BE IN ACCORDANCE WITH ALL STATUTES, ORDINANCES, RULES AND REGULATIONS OF ANY APPLICABLE CITY, TOWN, STATE OR FEDERAL AGENCY. THE CONTRACTOR SHOULD UNDERSTAND THAT NOT ALL UTILITIES SUBSCRIBE TO THE DIG SAFE PROGRAM. IT IS THE CONTRACTOR'S RESPONSIBILITY TO NOTIFY ALL UTILITY COMPANIES AND ENSURE THAT ALL UTILITIES HAVE BEEN MARKED PRIOR TO COMMENCING THEIR WORK. ANY DAMAGE TO EXISTING UTILITIES MARKED IN THE FIELD, OR AS A RESULT OF FAILING TO CONTACT THE APPROPRIATE UTILITY COMPANY, SHALL BE REPAIRED OR REPLACED AT NO ADDITIONAL COST TO THE CITY OF PROVIDENCE.
- 3. ANY/ALL PROPOSED VARIANCE TO THE DRAINAGE AND UTILITY PLAN, OR UTILITY DETAILS PROVIDED HEREIN SHALL BE BROUGHT TO THE ATTENTION OF THE ENGINEER FOR REVIEW AND APPROVAL PRIOR TO CONSTRUCTION.

MAINTENANCE AND PROTECTION OF TRAFFIC NOTES:

- 1. ALL MAINTENANCE AND PROTECTION OF TRAFFIC CONTROL SETUPS, SIGNS, CHANNELIZING DEVICES, ETC., SHALL BE IN ACCORDANCE WITH THE MANUAL ON UNIFORM TRAFFIC CONTROL DEVICES, LATEST EDITION.
- 2. ALL SIGN MOUNTINGS FOR TEMPORARY AND CONSTRUCTION SIGNS SHALL BE IN ACCORDANCE WITH THE R.I.D.O.T. STANDARD SPECIFICATIONS, LATEST EDITION.
- 3. THE CONTRACTOR SHALL COVER ALL EXISTING AND/OR TEMPORARY SIGNS THAT ARE NOT RELEVANT TO THE TRAFFIC CONTROL REQUIRED DURING ANY PARTICULAR STAGE OF THE CONTRACT.
- 4. TEMPORARY CONSTRUCTION SIGNS AND OTHER WORKZONE TRAFFIC CONTROL DEVICES THAT ARE DAMAGED OR REQUIRE RELOCATION SHALL BE REPLACED AND / OR RELOCATED AS REQUIRED. NO SEPARATE PAYMENT SHALL BE MADE FOR REPLACING OR RELOCATING SIGNS AS THIS WORK WILL BE CONSIDERED INCIDENTAL TO THE PROJECT AND INCLUDED IN THE LUMP SUM PRICE FOR SITE WORK.
- 5. THE PRIVATE VEHICLES OF CONSTRUCTION WORKERS SHALL NOT BE PARKED ON THE TRAVEL LANES OR SHOULDERS. PARKING SHALL BE COORDINATED WITH THE CITY OF PROVIDENCE AT ALL TIMES.
- 6. TEMPORARY CONSTRUCTION SIGNS AND OTHER TEMPORARY TRAFFIC CONTROL DEVICES SHALL BE INSTALLED PRIOR TO THE START OF WORK IN ANY AREA OPEN TO TRAFFIC, AND SHALL BE REMOVED AS SOON AS PRACTICAL WHEN THEY ARE NO LONGER APPROPRIATE.

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SURVEY NOTES:

- 1. SURVEY HAS BEEN COMPLETED BY HORSLEY WITTEN GROUP, INC. THE SURVEY WAS COMPLETED FOR THE CITY OF PROVIDENCE AND UTILIZED BY FUSS & O'NEILL, INC. AS PART OF THE PHASE 1 DEVELOPMENT STAGE (SPAZIANO ELEMENTARY SCHOOL PROJECT).
- HORSLEY WITTEN GROUP, INC'S JULY 20, 2021 AND MARCH 29, 2022 FIELD SURVEY UTILIZED:
 - a. HORIZONTAL DATUM IS RHODE ISLAND STATE PLANE COORDINATE SYSTEM. DATUM ESTABLISHED BY GPS RTK.
 - b. THE ELEVATIONS DEPICTED BASED ON NORTH AMERICAN VERTICAL DATUM (NAVD) OF 1988.
- 3. INFORMATION ILLUSTRATED ON THE PHASE II EXISTING CONDITIONS PLANS ARE APPROXIMATE ONLY AND DRAWN BASED ON DOCUMENTS RECEIVED BY GM2, INCLUDING THE ELEMENTARY SCHOOL PLAN SETS AND AS-BUILT DOCUMENTS.
- 4. SITE INFORMATION, INCLUDING BUT NOT LIMITED TO INVERTS, LOCATIONS, AND DIMENSIONS SHOWN AS PART OF THE SPAZIANO MIDDLE SCHOOL PROJECT (PHASE II DEVELOPMENT) ARE APPROXIMATE ONLY AND REPRESENT THE TEMPORARY CONDITIONS FOLLOWING THE PHASE 1 DEVELOPMENT. THESE CONDITIONS HAVE NOT BEEN SURVEYED BY GM2 OR ANY SUBCONSULTANT AS PART OF THE PHASE II DEVELOPMENT STAGE.
- 5. GM2 HAS COMPELTED A VISUAL INSPECTION OF THE SITE CONDITIONS ON FEBRUARY 19, 2024. OBSERVED SITE CONDITIONS ARE REPRESENTED ON THE PHASE II EXISTING CONDITIONS PLANS. GM2 DID NOT COMPLETE SURVEY MEASUREMENTS OR TOPOGRAPHIC INFORMATION AS PART OF THIS SITE RECONNAISSANCE.
- 6. IT IS THE RESPONSIBILITY OF THE CONTRACTOR TO REVIEW SITE CONDITIONS PRIOR TO INITIATING CONSTRUCITON ACTIVITIES. ALL DISCREPENCIES OBSERVED SHALL BE BROUGHT TO THE ATTENTION OF THE ENGINEER IMMEDIATELY.

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Client/ Contractor

PROVIDENCE PUBLIC SCHOOLS

797 WESTMINSTER STREET PROVIDENCE, RI 02903

Project

Seals

SPAZIANO MIDDLE SCHOOL

254 EASTWOOD AVENUE PROVIDENCE, RI 02909

 Issues / Revisions

 No.
 Date

 7/28/2023
 SCHEMATIC DESIGN

 2/20/2024
 CITY OF PROV MASTER PLA

 2/29/2024
 DESIGN DEVELOPMENT

PROGRESS SET

NOT FOR CONSTRUCTION


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No.	Date	Description
	7/28/2023	SCHEMATIC DESIGN
	2/20/2024	CITY OF PROV MASTER PLAN
	2/29/2024	DESIGN DEVELOPMENT
Drawi	ng Title	
V2	INC	DTES

 Project Manager:
 BDN
 Project No:
 41037

 Drawn by:
 LBD
 Scale:
 AS NOTED


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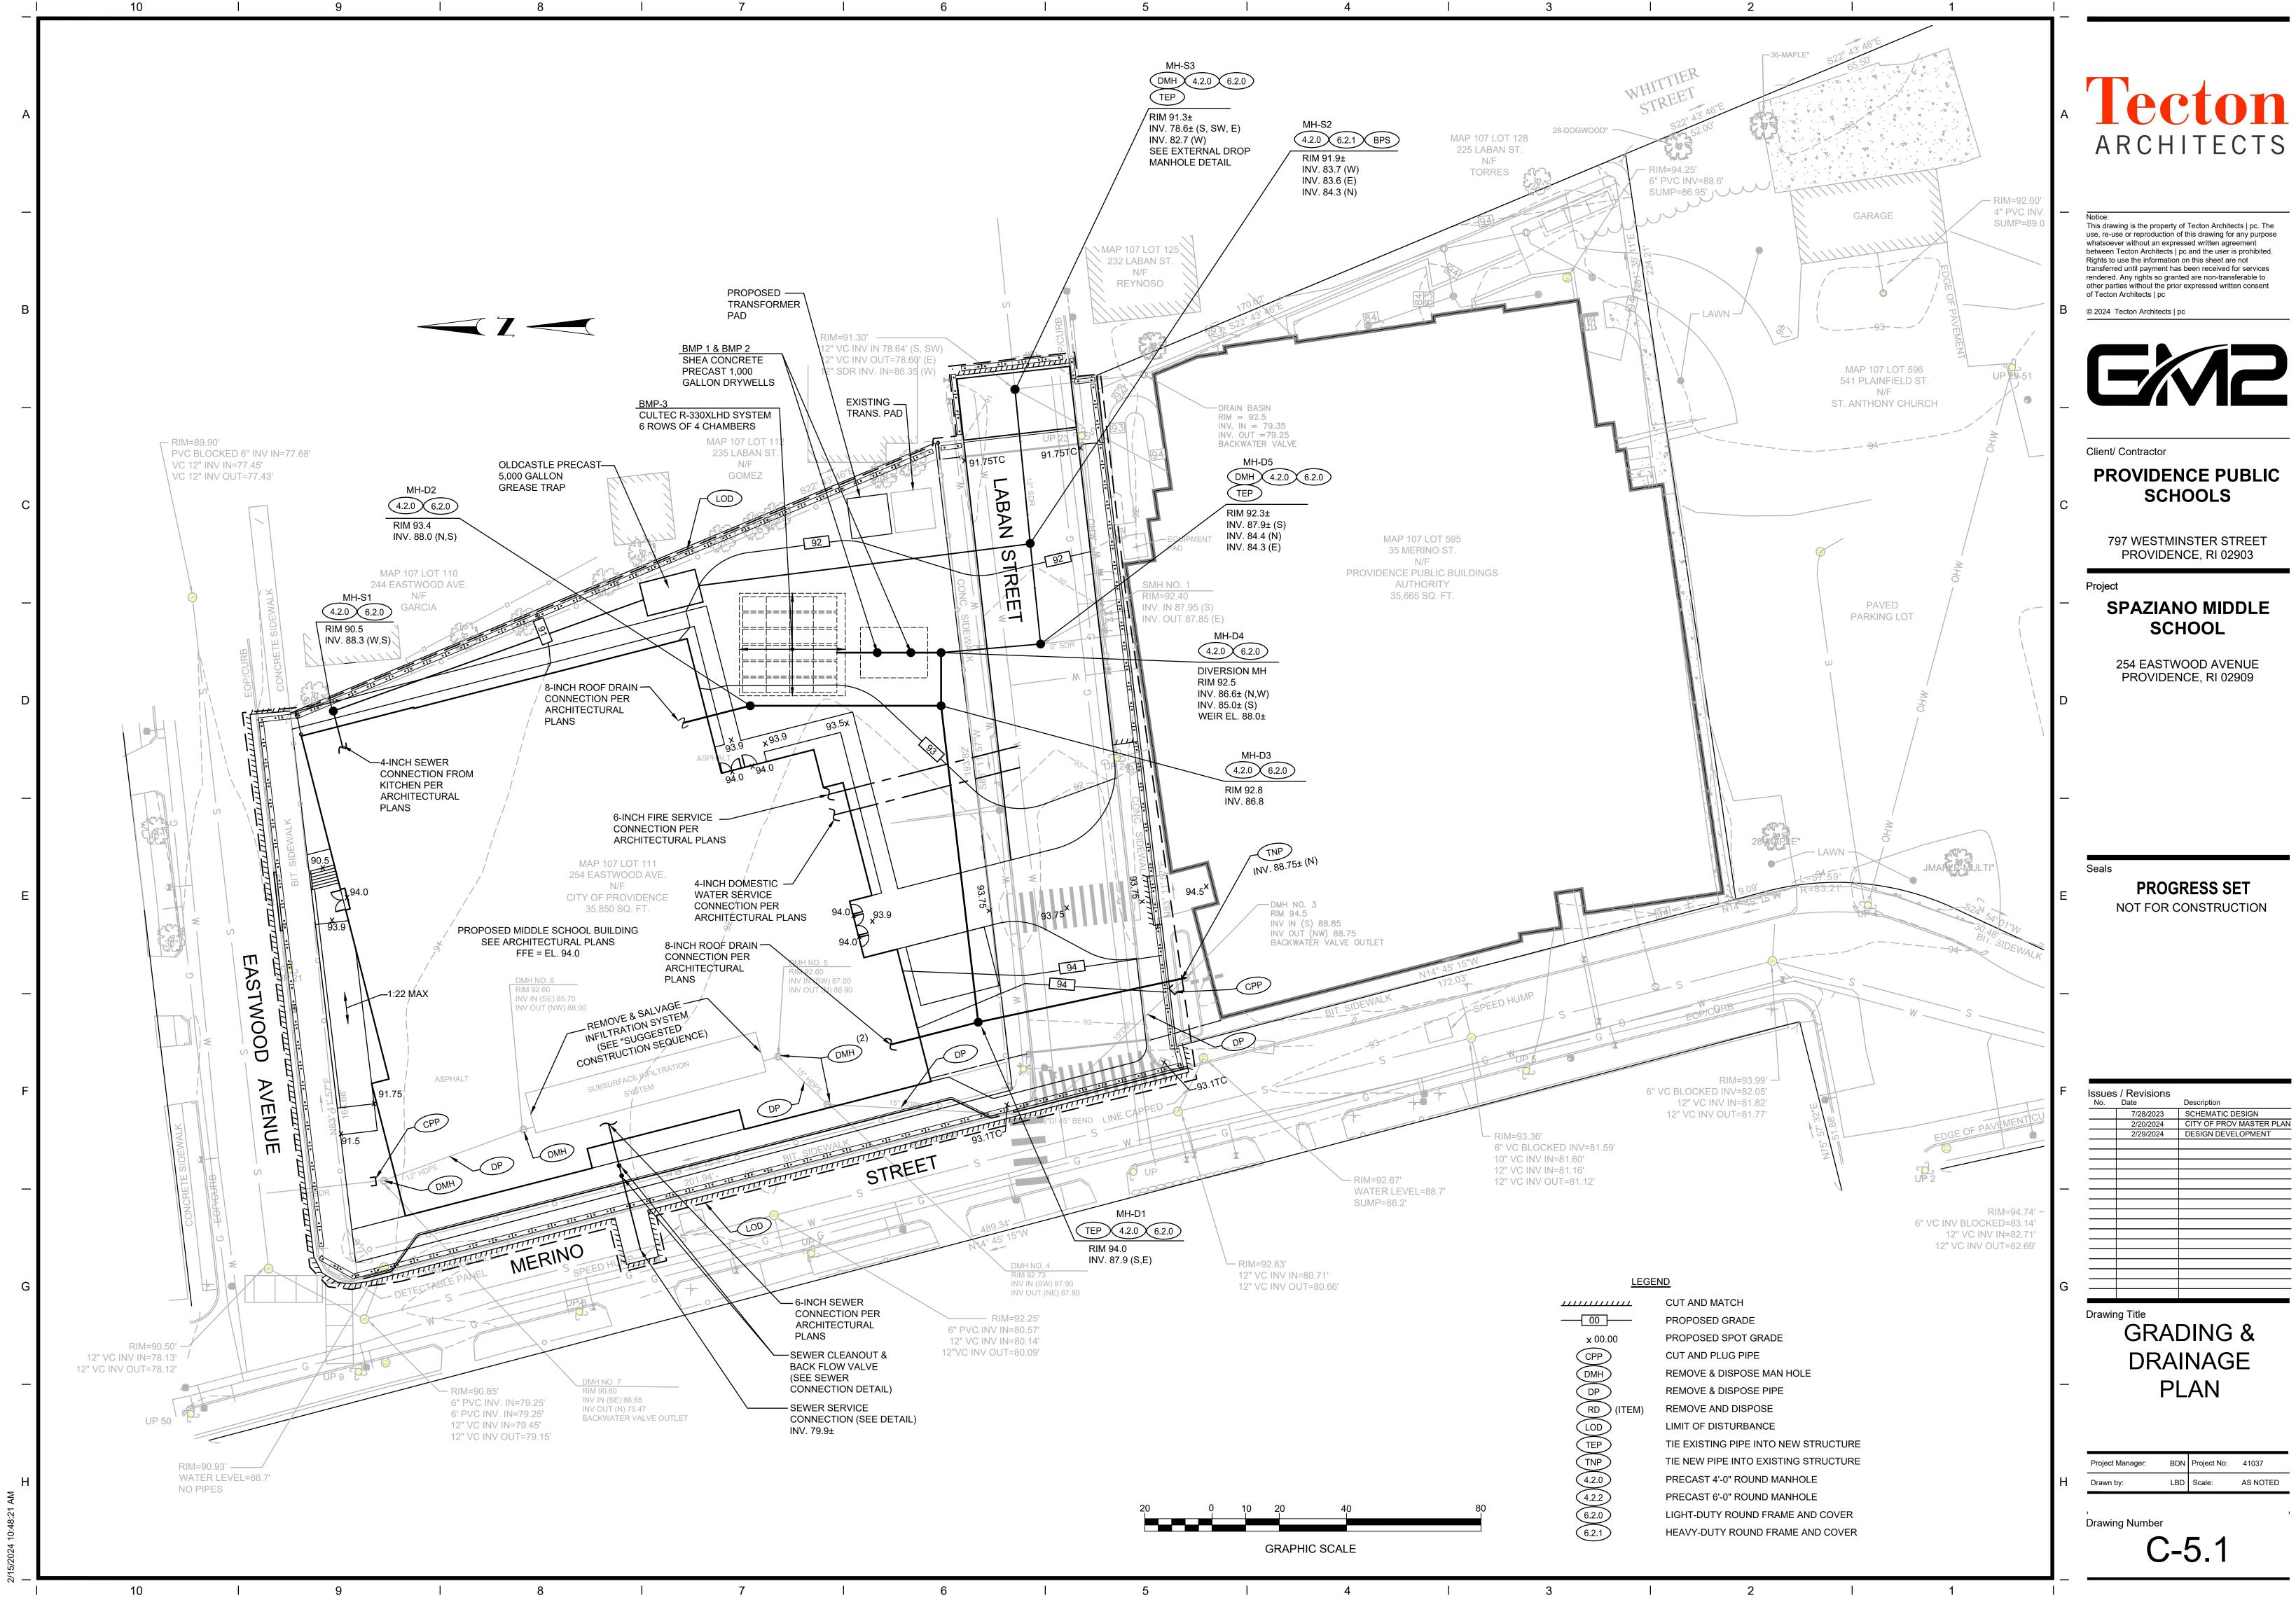


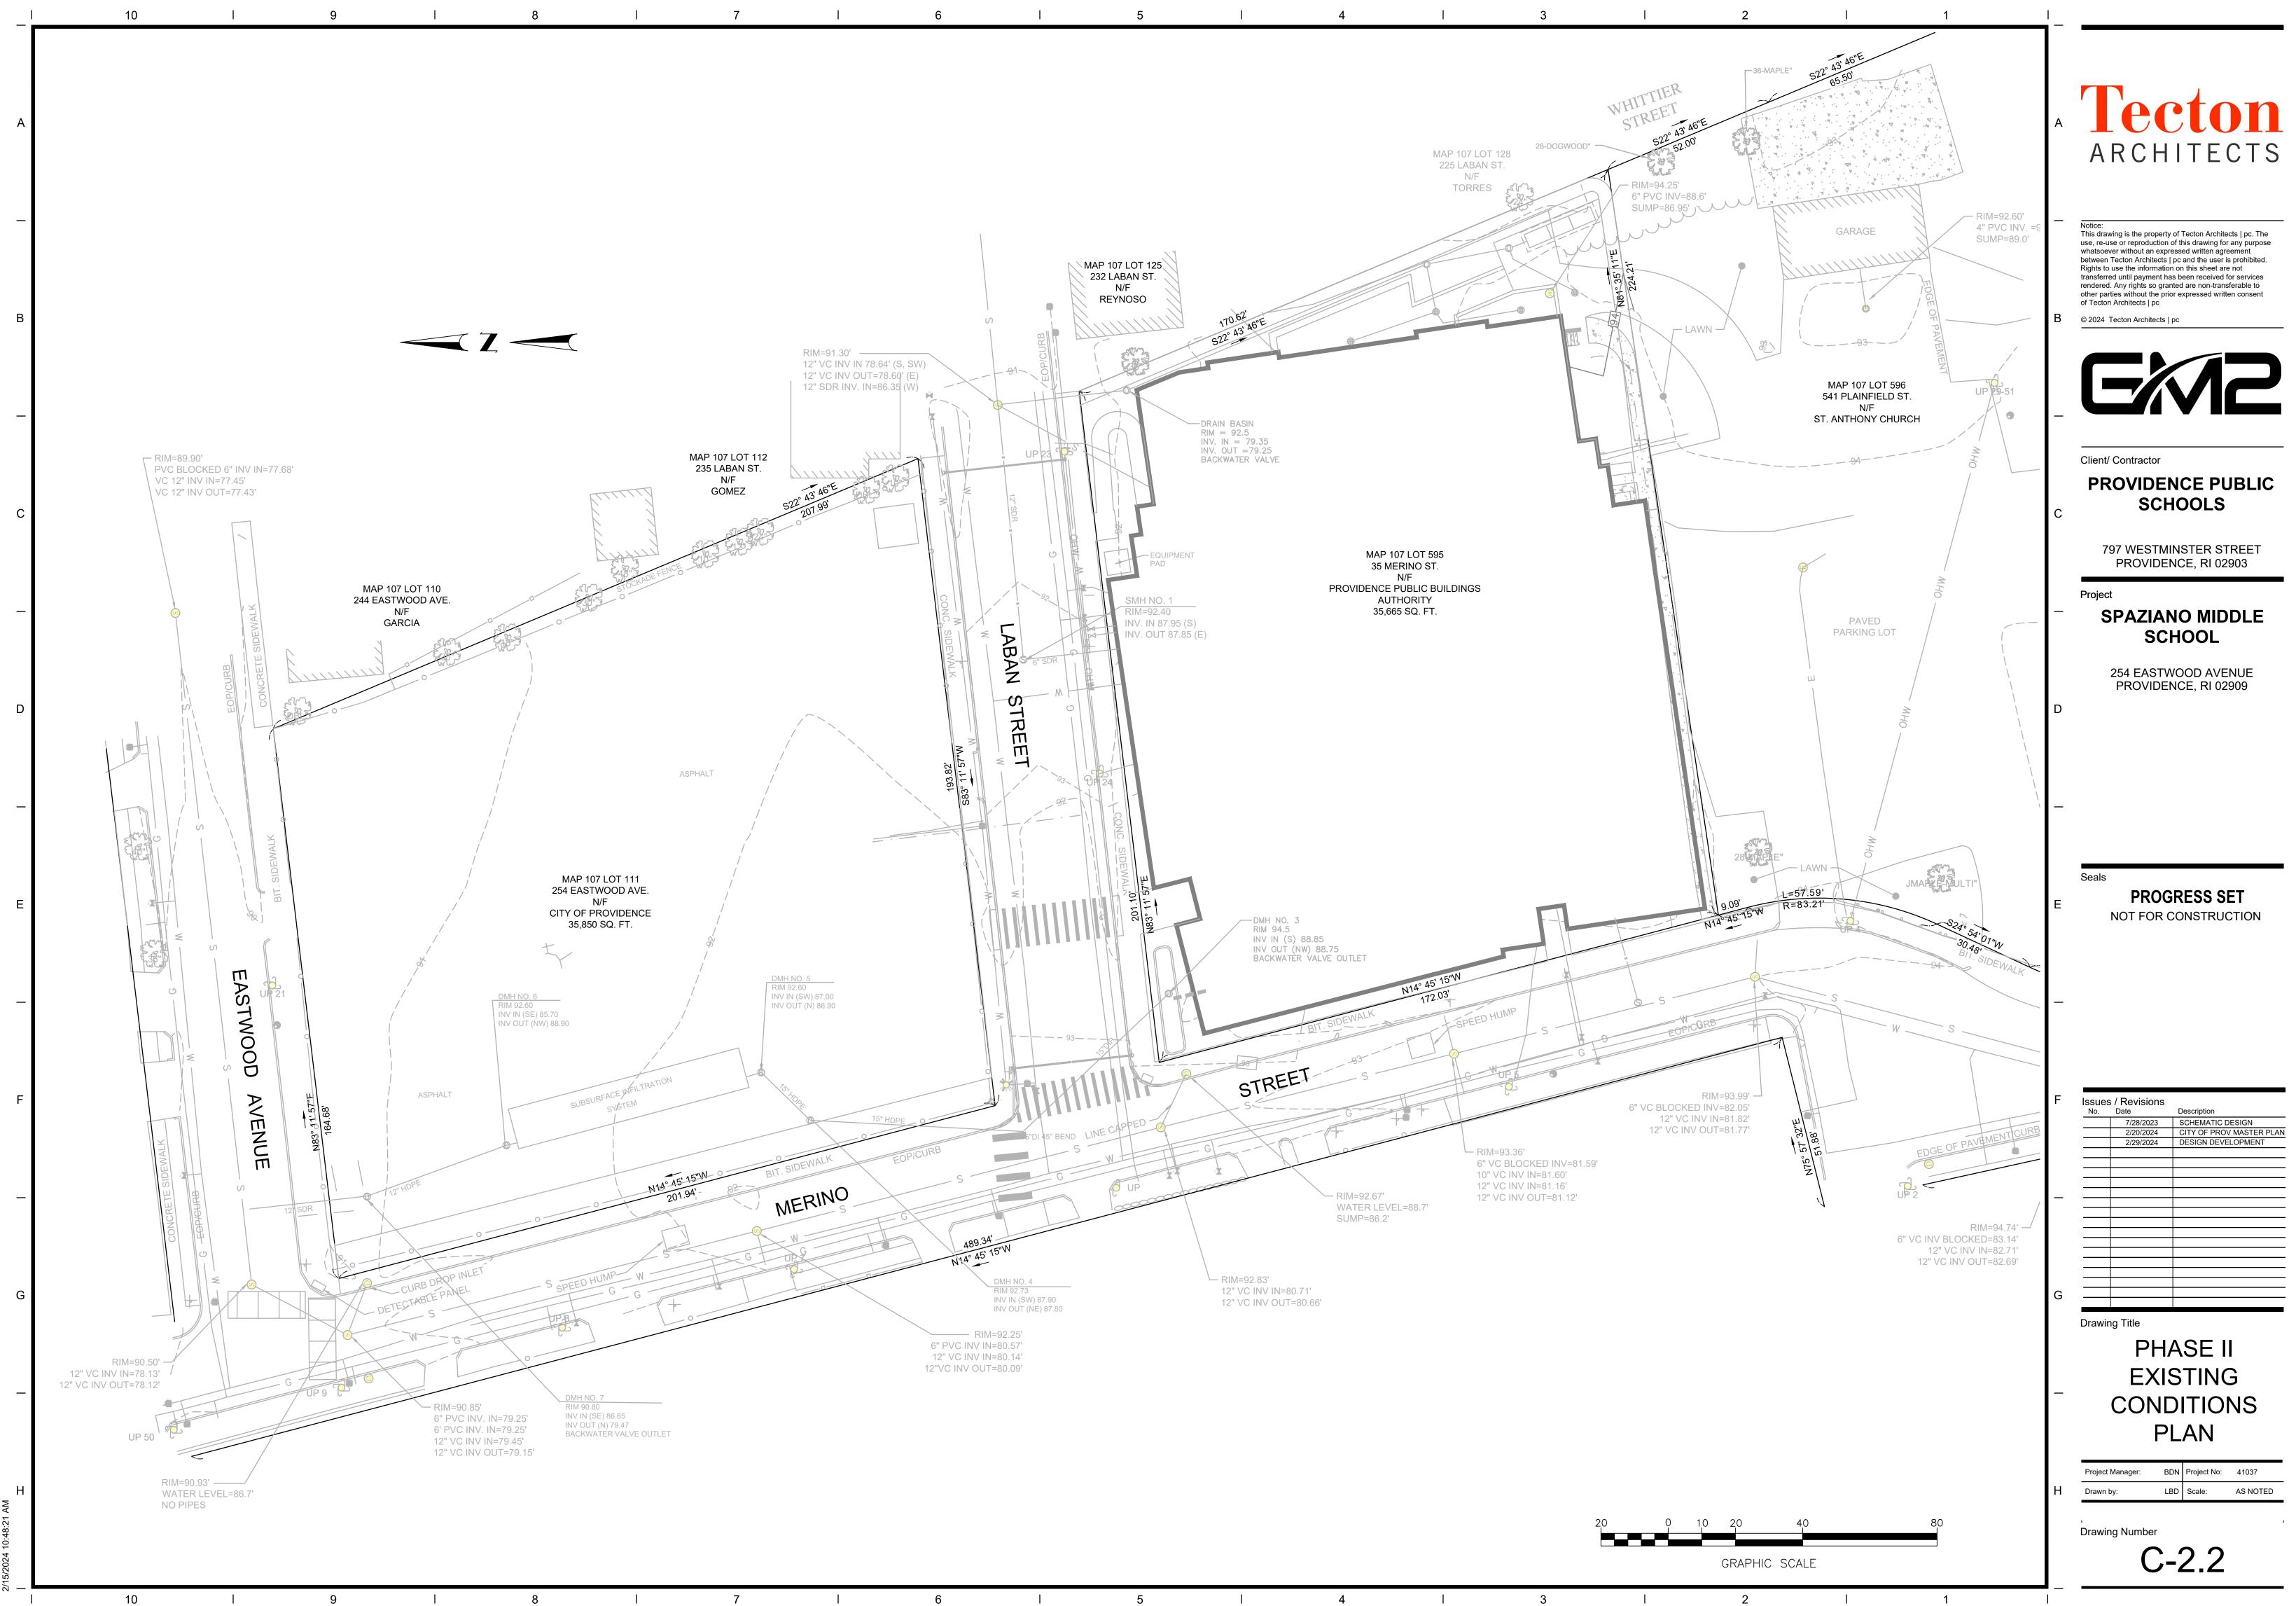


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В	of Tecton Architects pc © 2024 Tecton Architects pc
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с	Client/ Contractor PROVIDENCE PUBLIC SCHOOLS 797 WESTMINSTER STREET
_	PROVIDENCE, RI 02903 Project SPAZIANO MIDDLE SCHOOL
D	254 EASTWOOD AVENUE PROVIDENCE, RI 02909
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E	Seals PROGRESS SET NOT FOR CONSTRUCTION
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F	Issues / Revisions Description No. Date Description 7/28/2023 SCHEMATIC DESIGN 2/20/2024 CITY OF PROV MASTER PLAN 2/29/2024 DESIGN DEVELOPMENT
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G	Drawing Title
_	200' RADIUS MAP
н	Project Manager: BDN Project No: 41037 Drawn by: LBD Scale: AS NOTED Drawing Number


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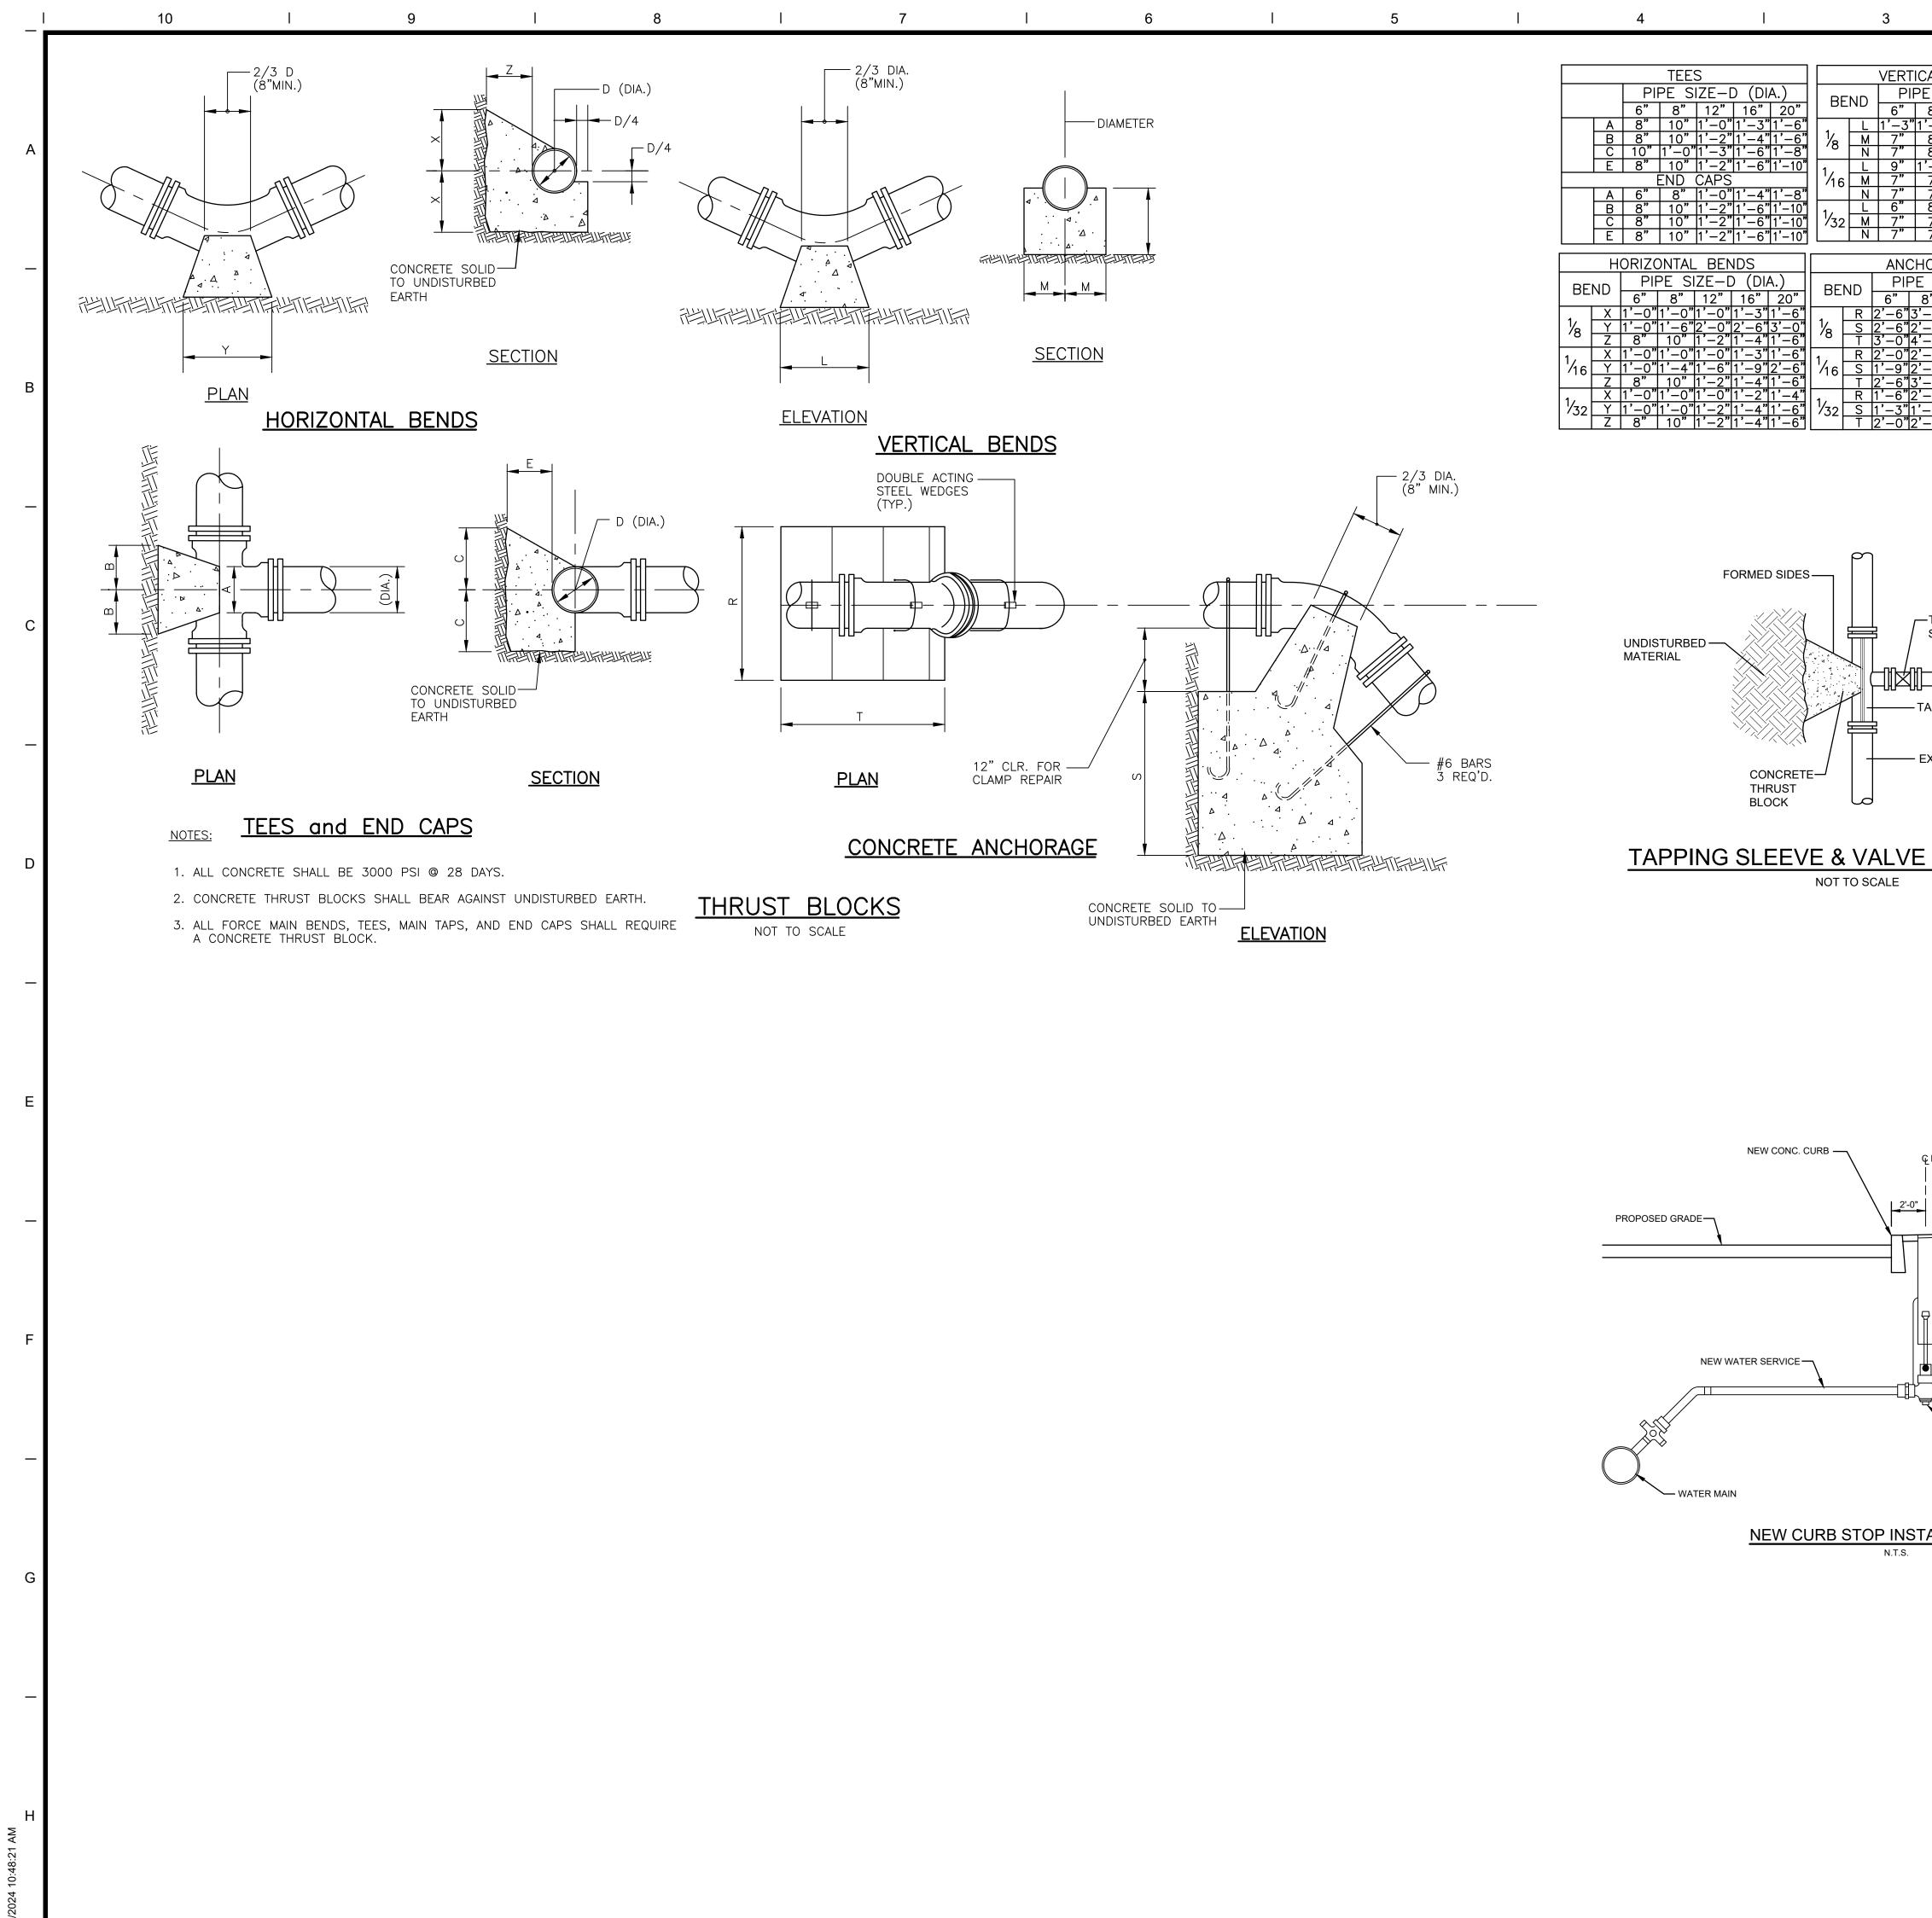




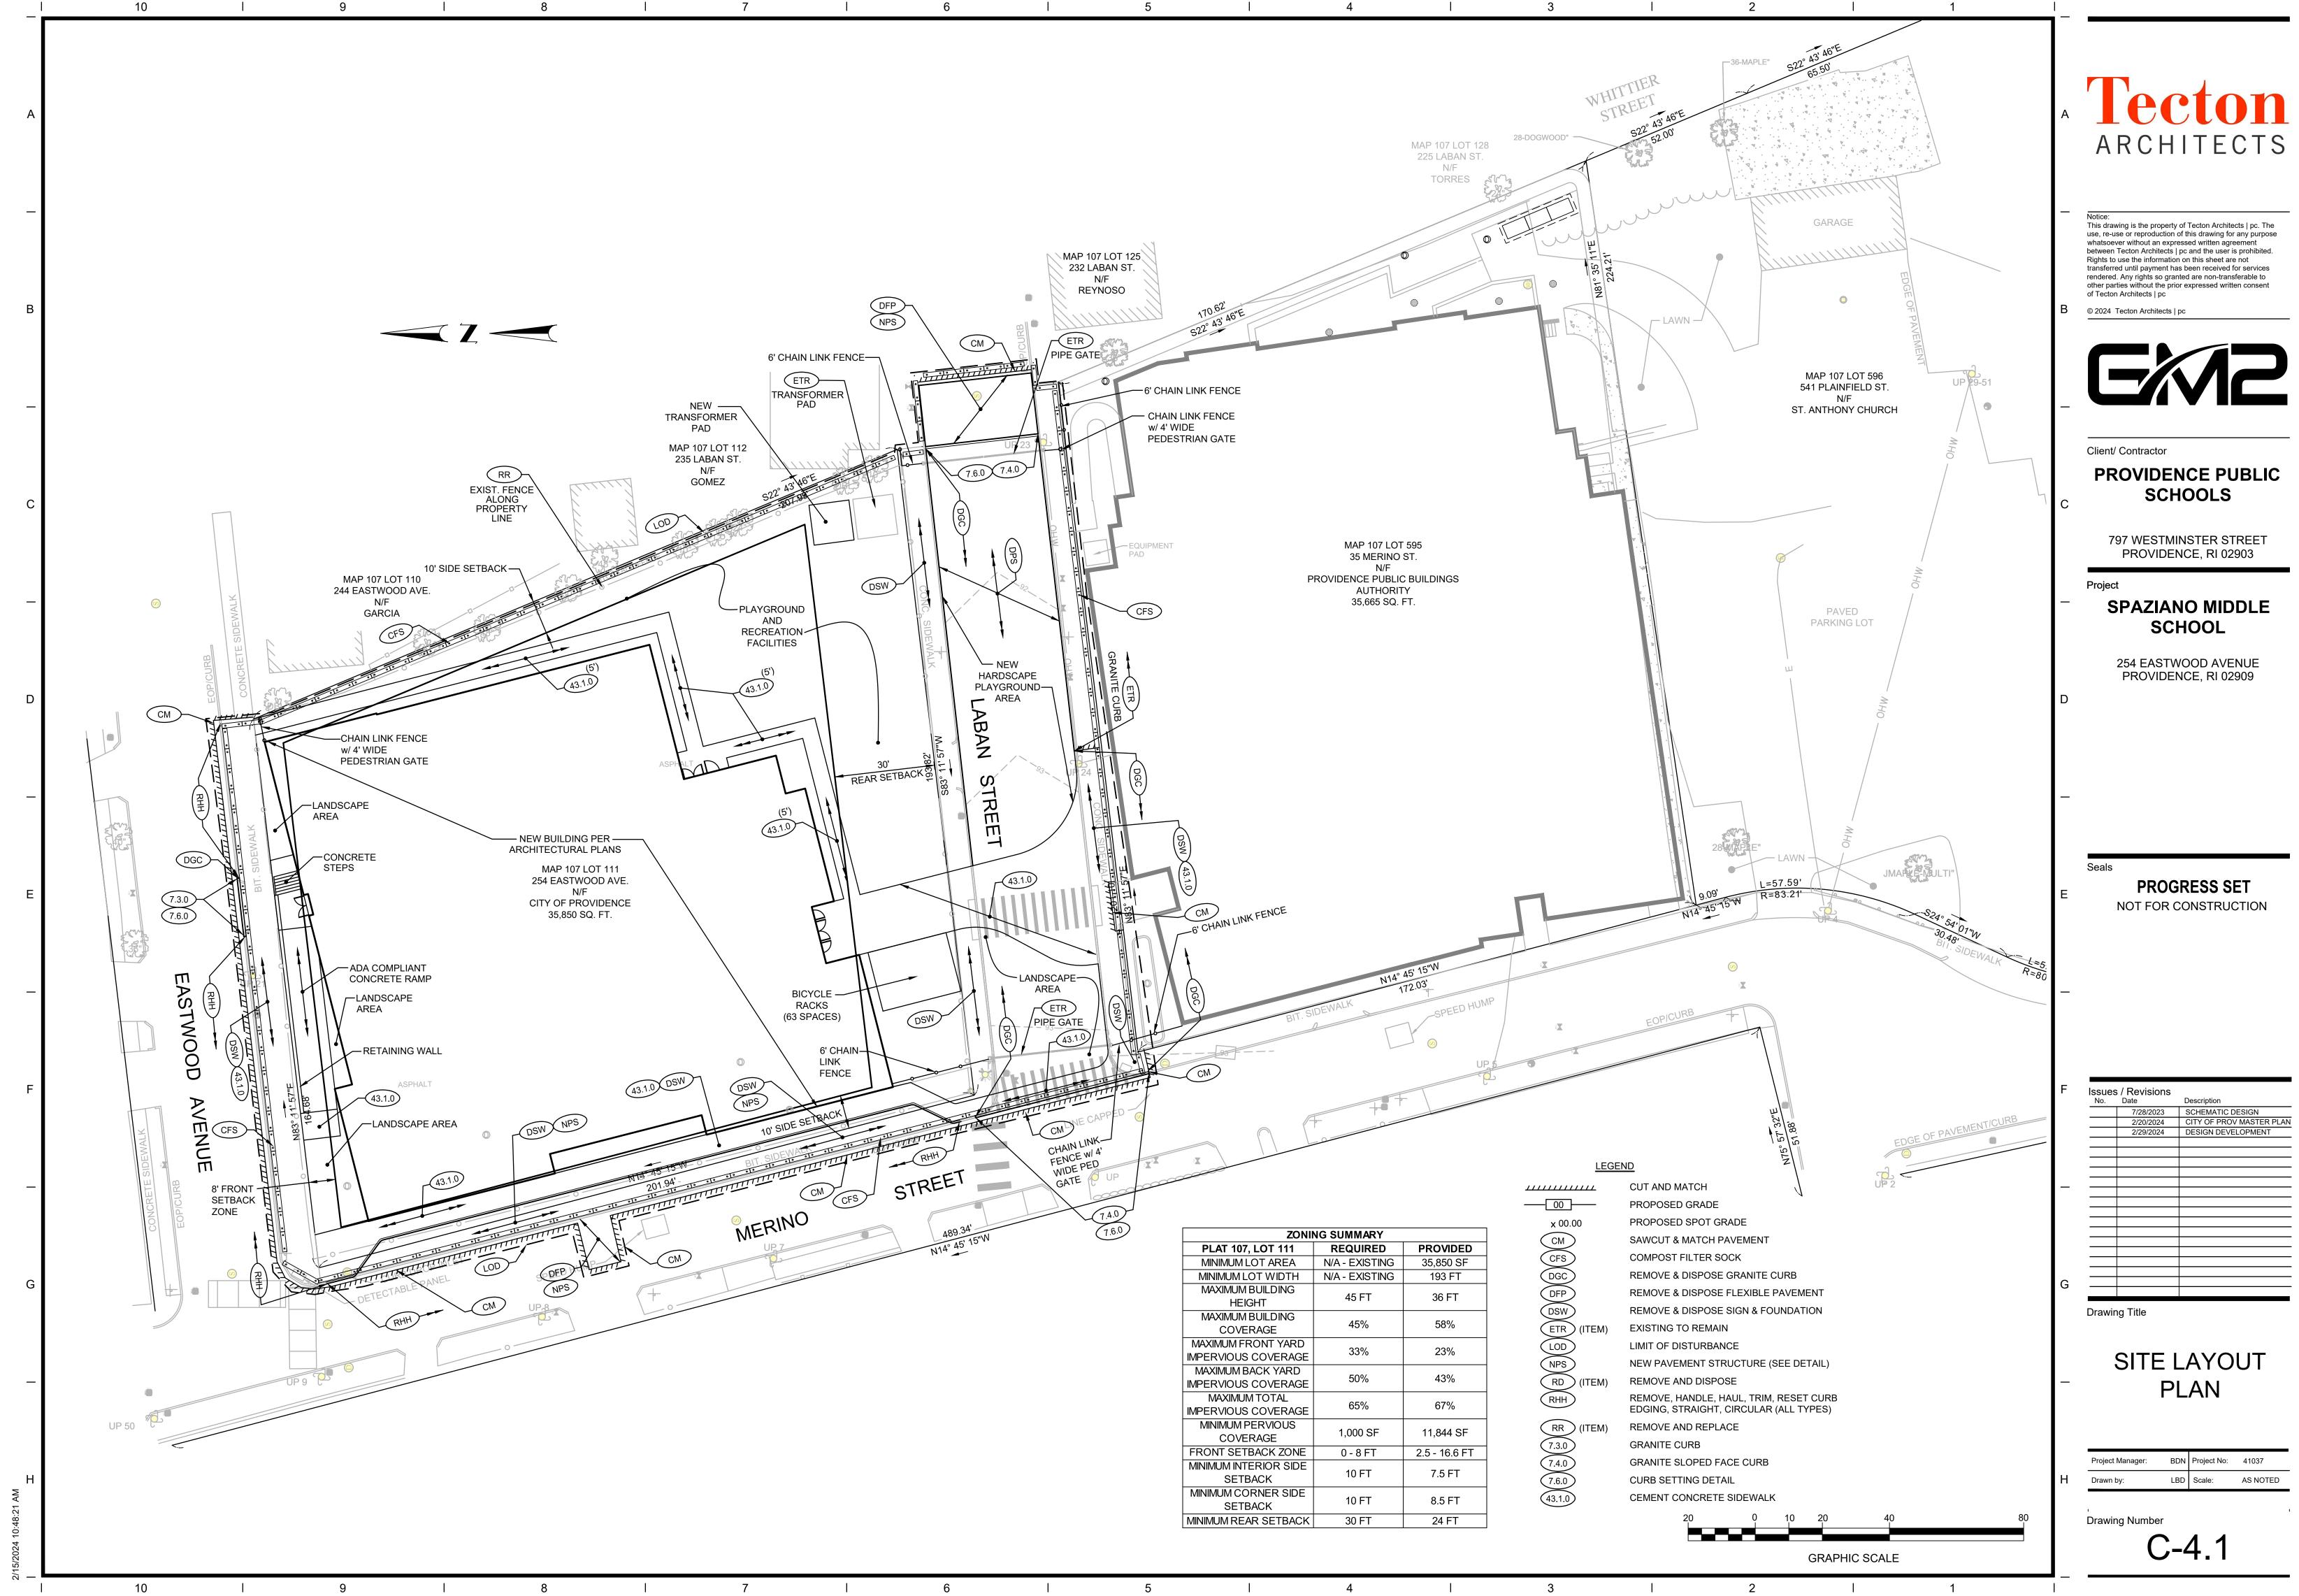
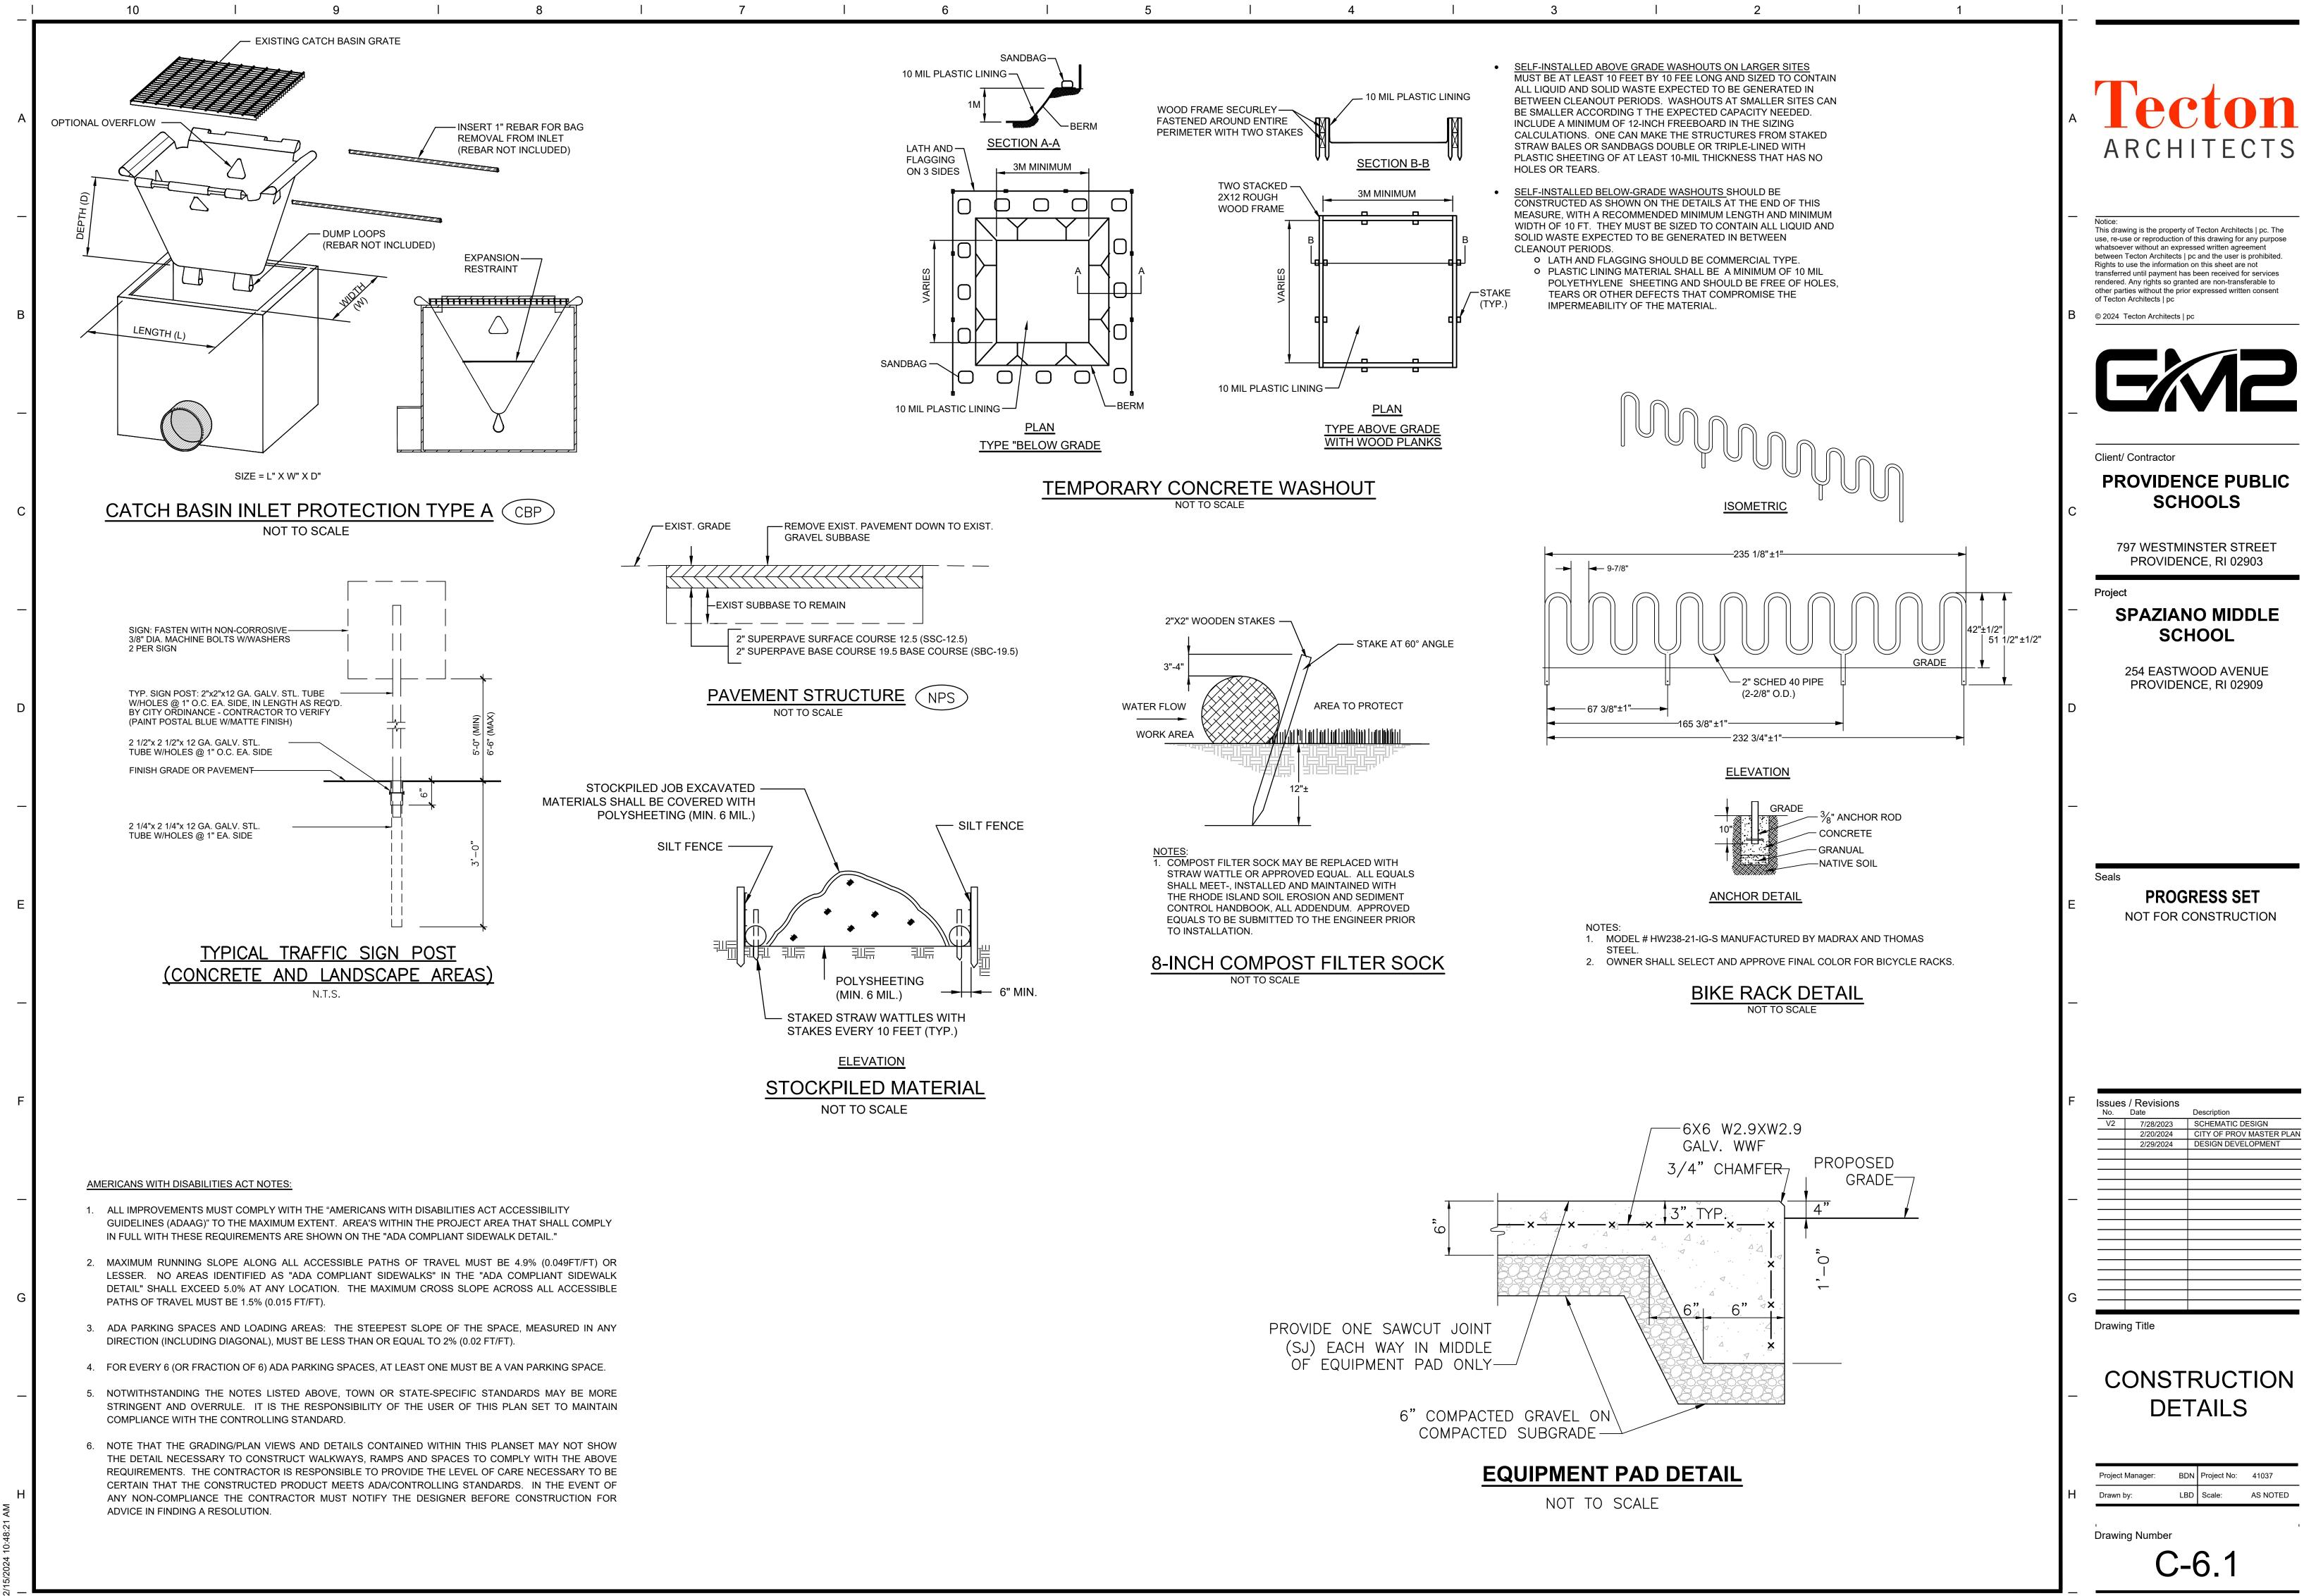
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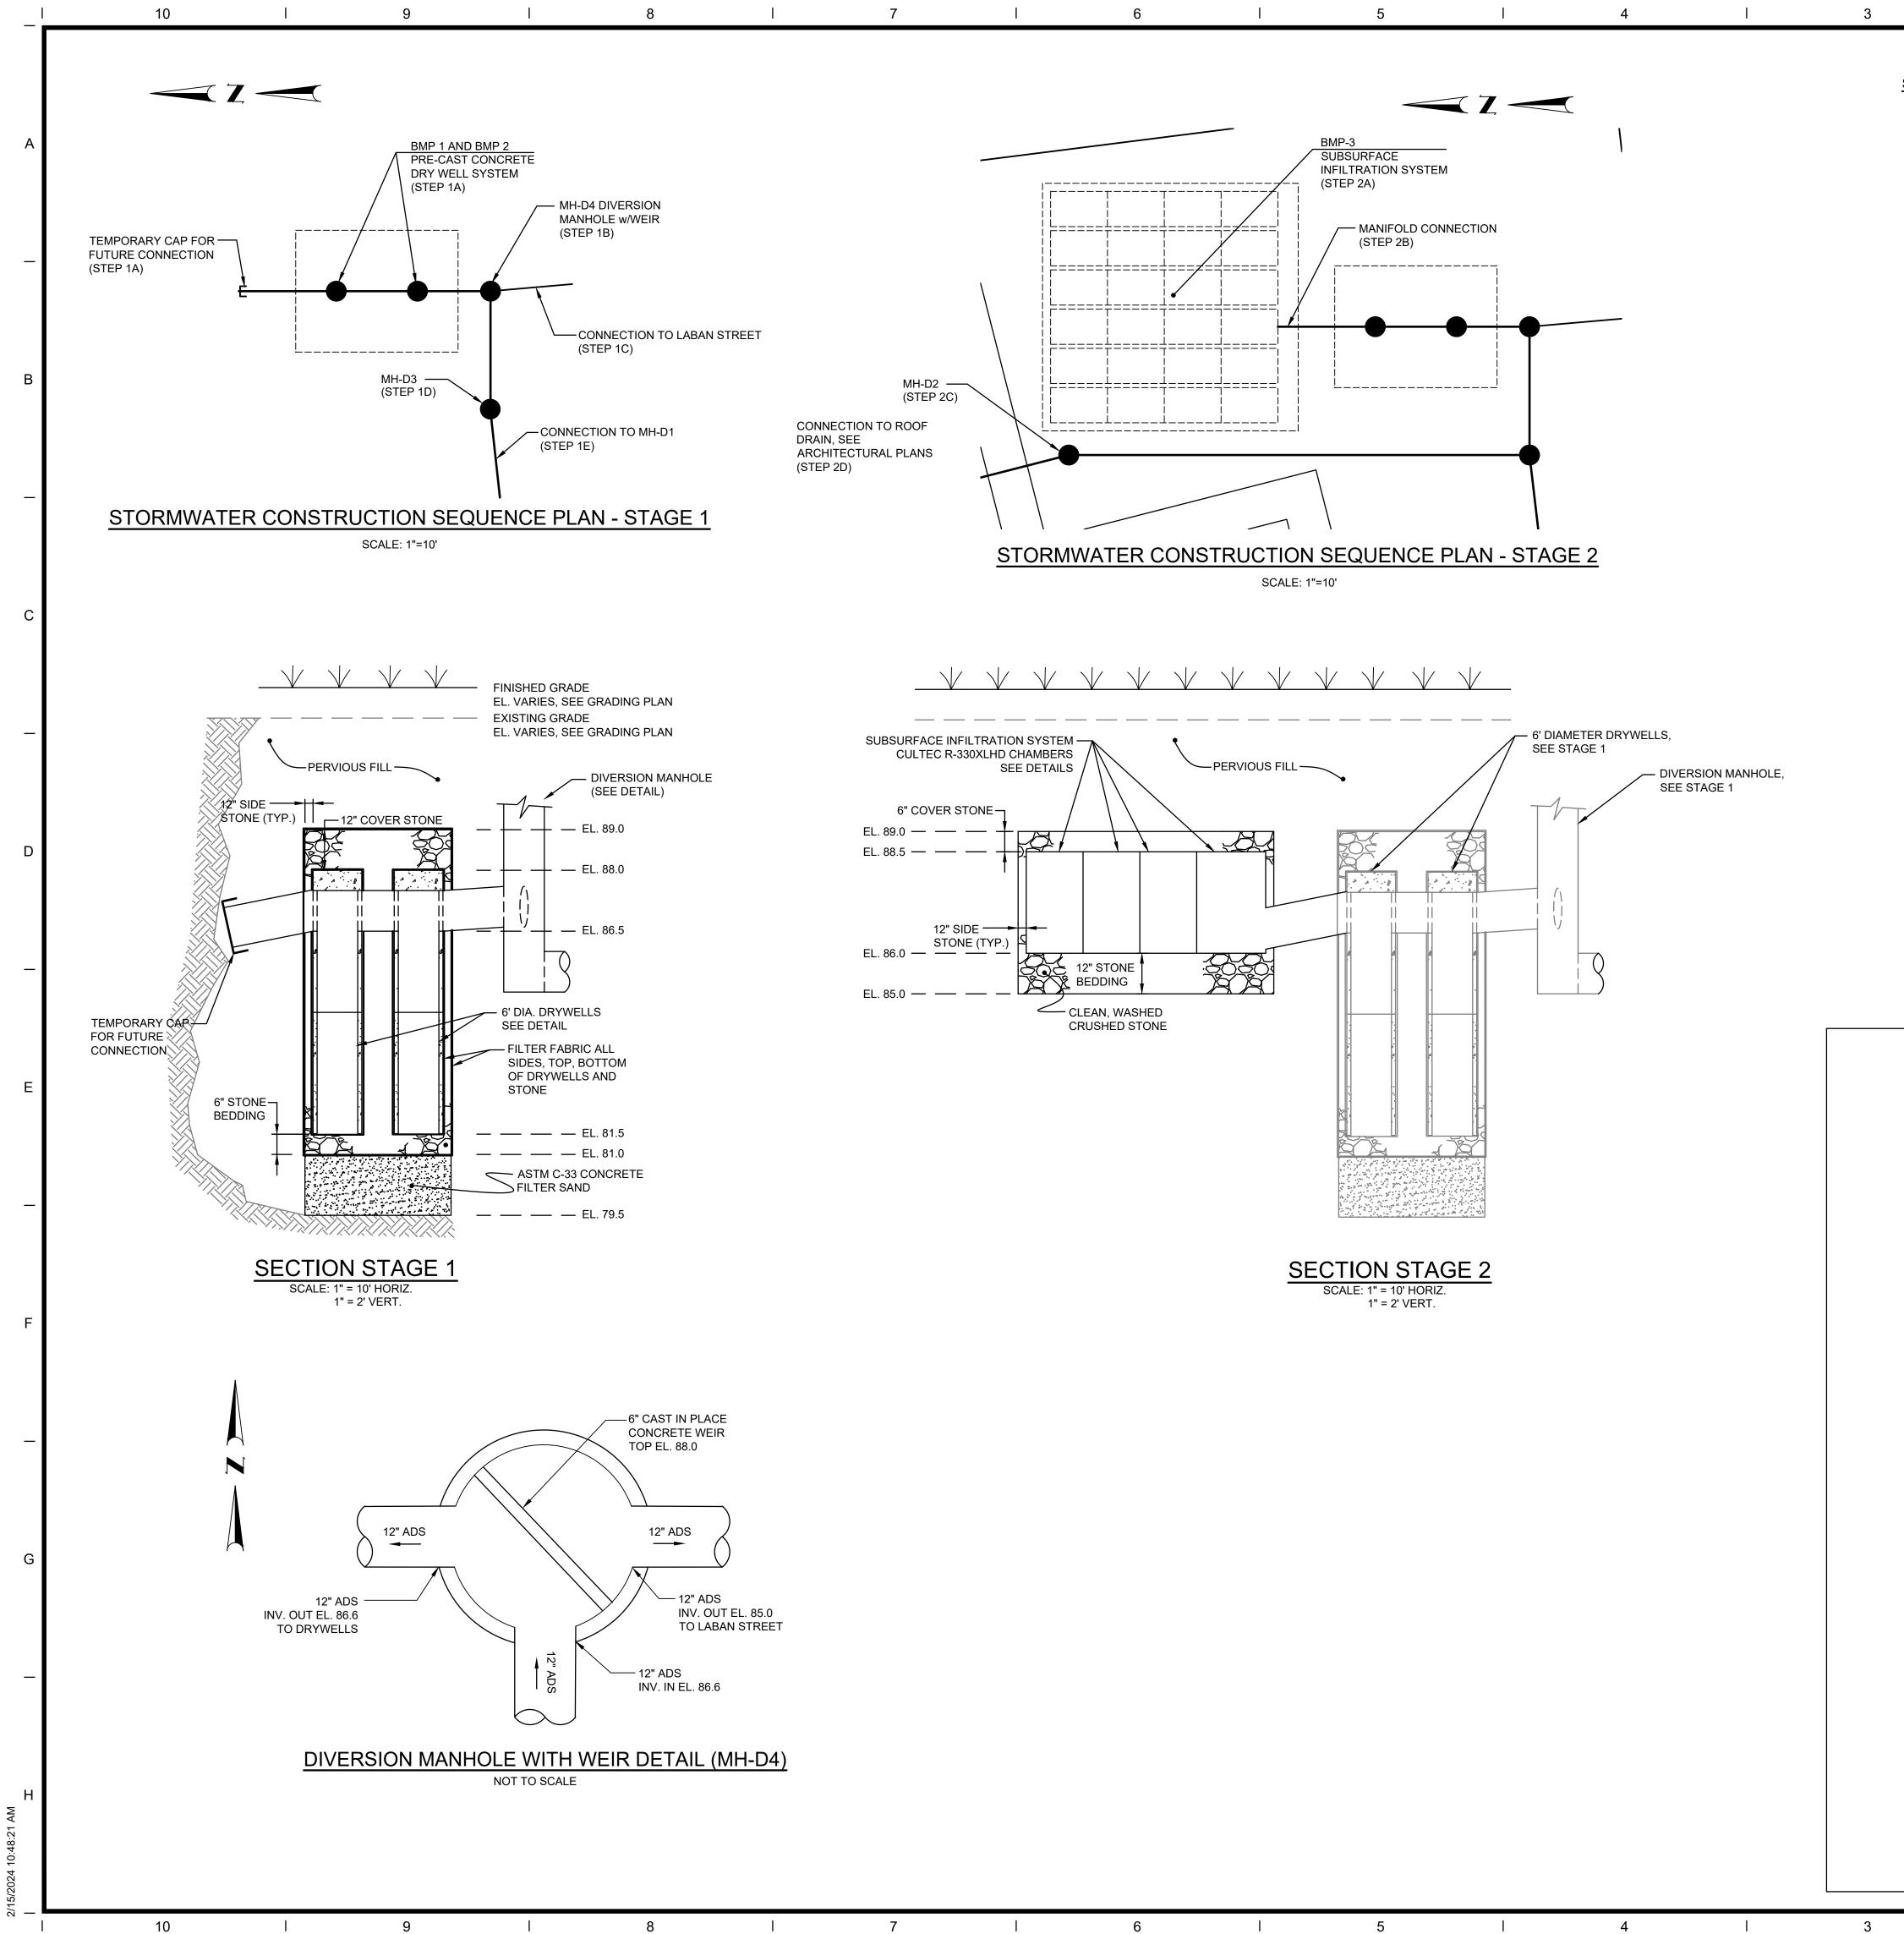
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RTICAL BENDS PIPE SIZE-D (DIA.) "8" 12" 16" 20" 3"1'-8"2'-6"3'-6"4'-8" "8" 11" 1'-4"1'-6" "8" 11" 1'-4"1'-6" "1'-0"1'-9"2'-6"3'-0" "1'-0"1'-9"2'-6"3'-0" "7" 10" 1'-0"1'-2" "7" 8" 10" 1'-0" "8" 12" 16" 20" "9"3'-0"4'-6"5'-4" "12'-9"3'-6"3'-2"3'-8" "14'-0"4'-9"7'-0"9'-6" "14'-0"3'-2"3'-8" "3'-4"4'-0"6'-0" "1'-9"2'-0"3'-8"4'-3" "1'-9"2'-0"3'-8"4'-3" "1'-9"2'-				_	<section-header> Notice The service of reporting the property of Tecton Architects pc. The services of reporting the services of reporting the user is prohibited. Sights to use the information on this sheet are not fransferred until payment has been received for services redered. Any rights so granted are non-transferable to other parties without the prior expressed written consent of the consent of th</section-header>
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— EXISTING MAIN	N				SPAZIANO MIDDLE SCHOOL 254 EASTWOOD AVENUE PROVIDENCE, RI 02909
Ç NEW CURB STOP & BOX	FINISHED GRADE			E	Seals PROGRESS SET NOT FOR CONSTRUCTION
INSTALL NEW CURB S BEHIND NEW CURB) STALLATION DETAIL	STOP & BOX			F G	Issues / Revisions No. Date Description V2 7/28/2023 SCHEMATIC DESIGN 2/20/2024 CITY OF PROV MASTER PLAN 2/29/2024 DESIGN DEVELOPMENT
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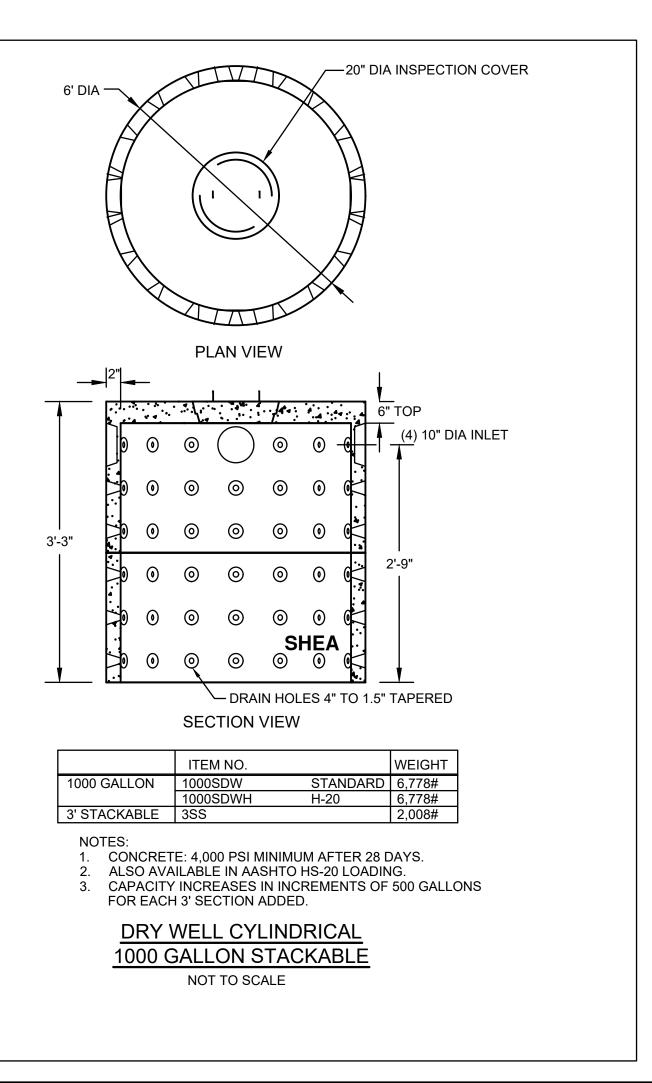
SUGGESTED STORMWATER CONSTRUCTION SEQUENCE:

1. STORMWATER CONSTRUCTION STAGE 1

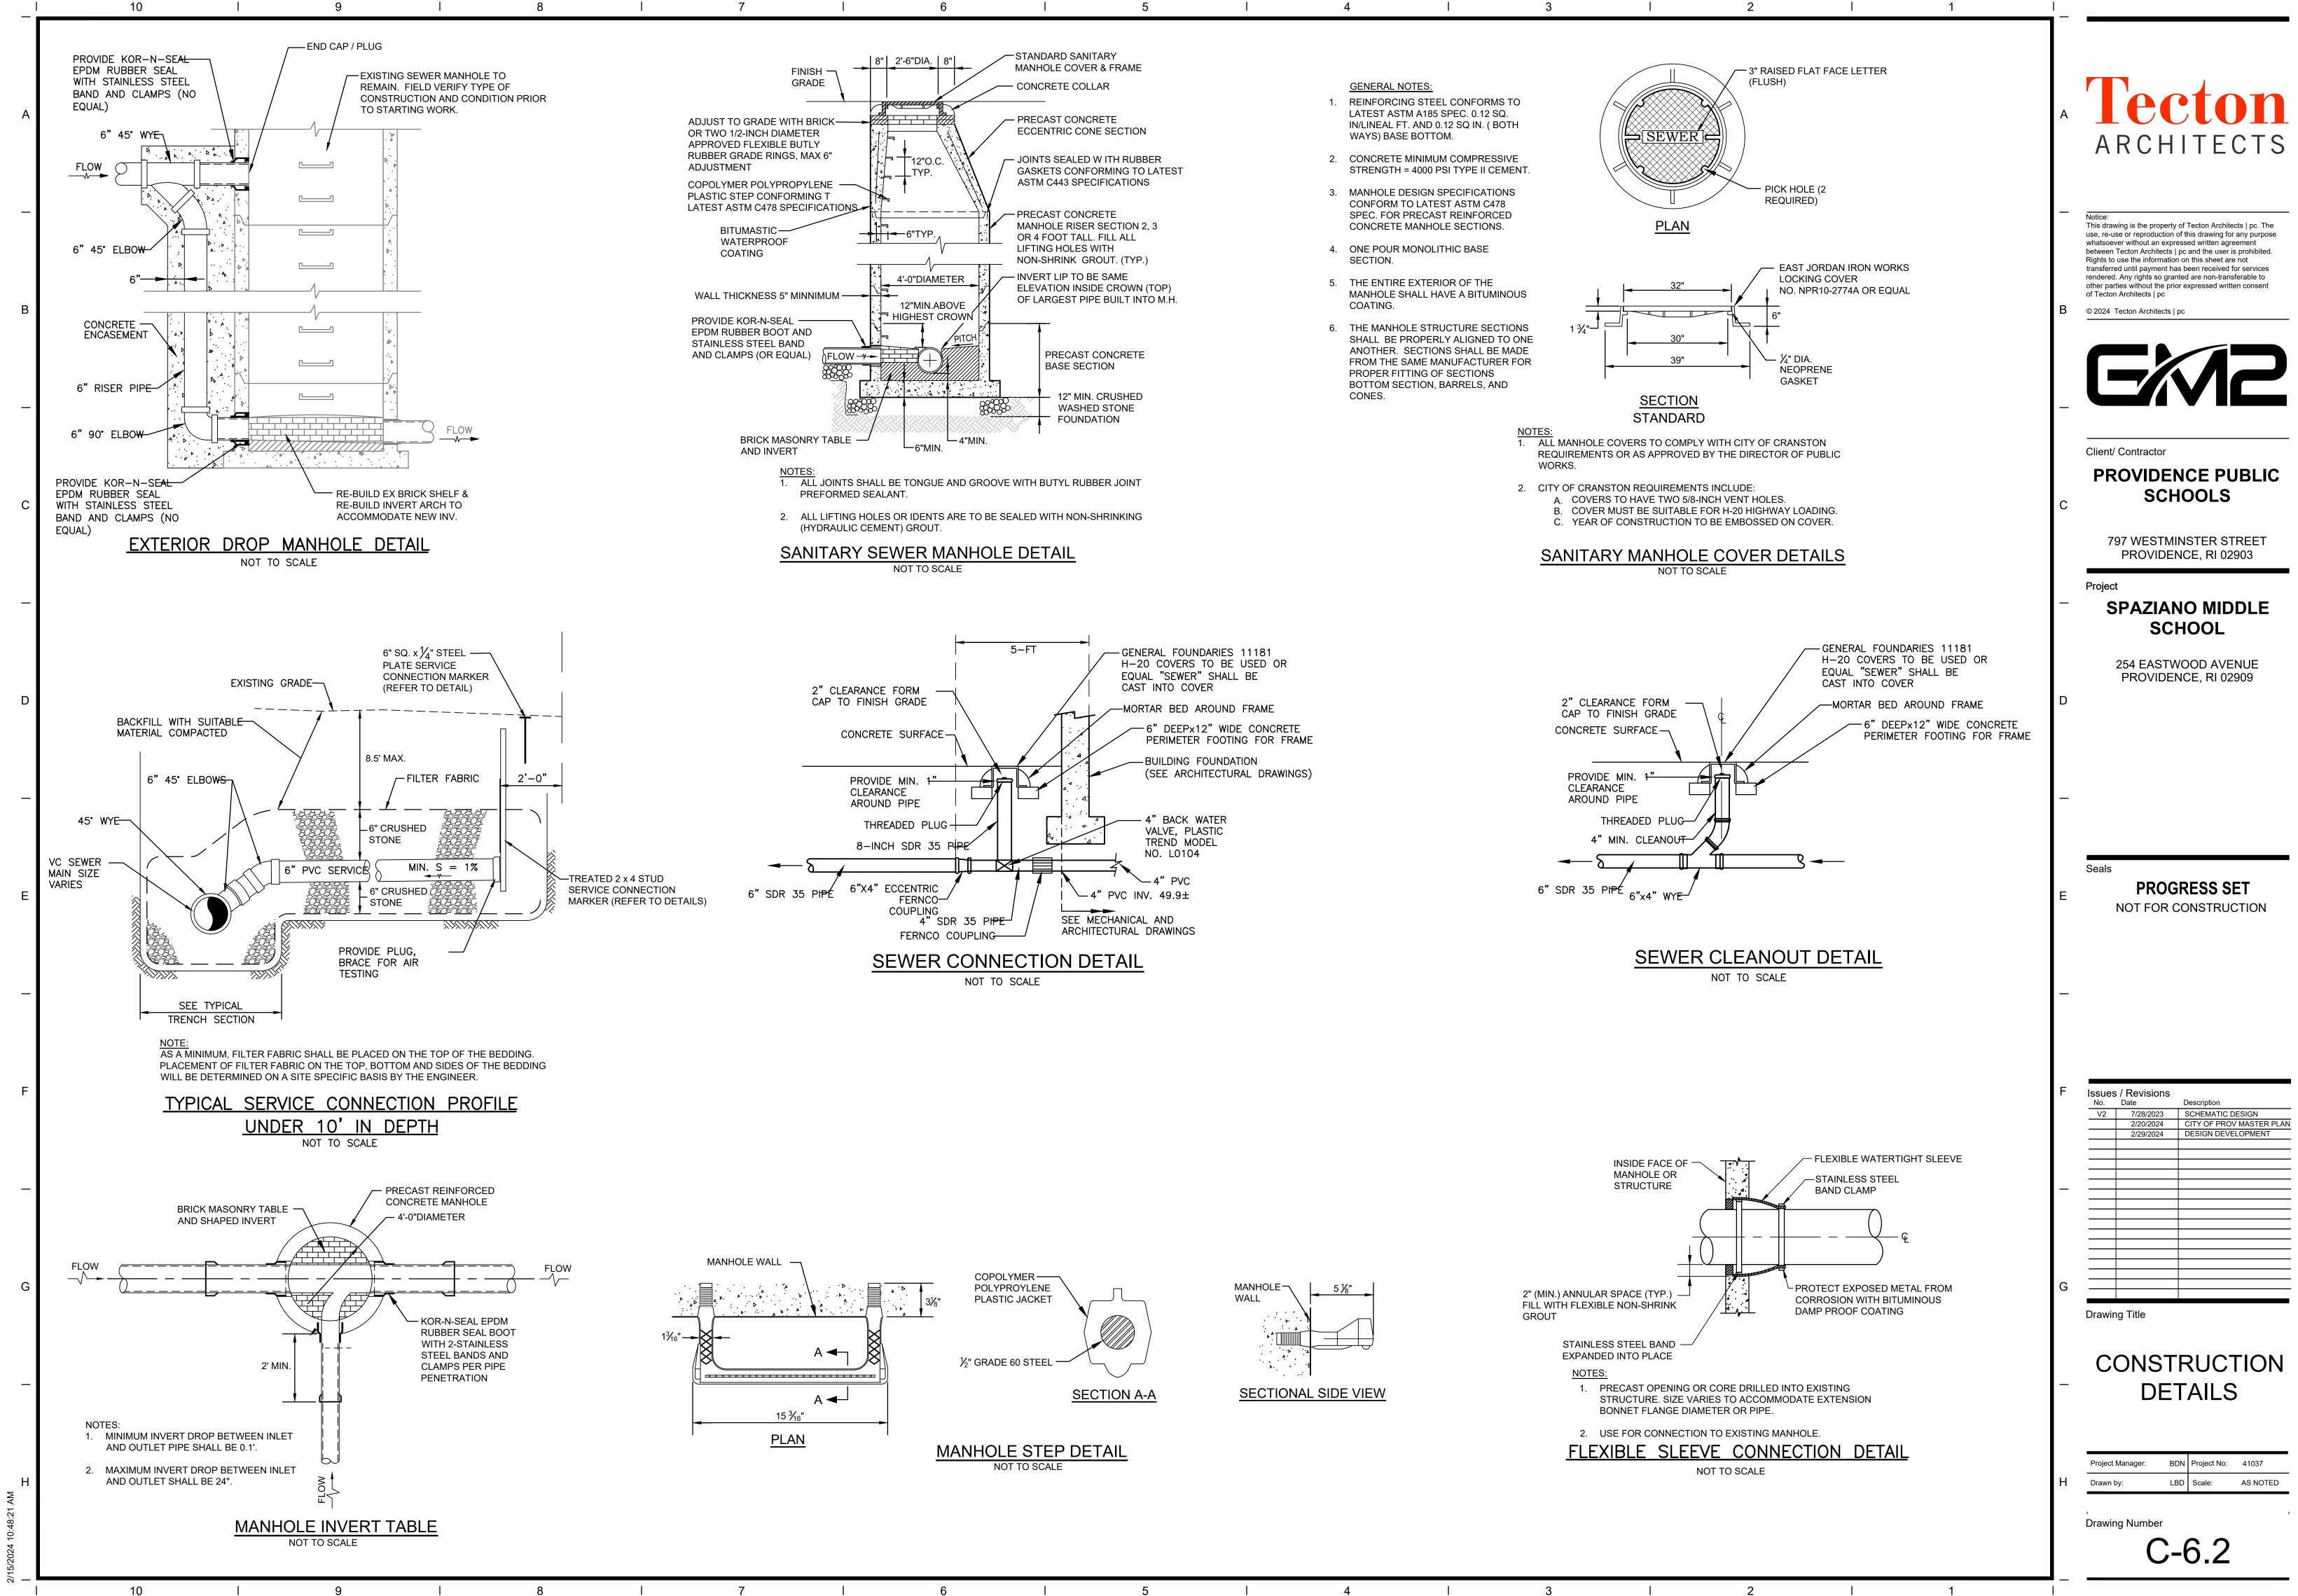- A. CONSTRUCT BMP-1 AND BMP-2, INCLUDING DRYWELL STRUCTURES, DRAINAGE PIPES, FILTER SAND, CRUSHED STONE BASE, SIDE STONE, COVER STONE, FILTER FABRIC, ETC. INSTALL TEMPORARY CAP ON DRAINAGE CONVEYANCE PIPE EXITING BMP-2 FOR FUTURE CONNECTION.
- B. CONSTRUCT THE DIVERSION MANHOLE (MH-D4) WITH INTERNAL WEIR, INCLUDING CONNECTION TO BMP-1. C. TIE NEW PIPE INTO EXISTING SEWER MANHOLE WITHIN LABAN STREET (SMH NO.
- 1). CONNECT NEW PIPE TO MH-D4. D. CONSTRUCT MH-D3, INCLUDING CONNECTION TO MH-D4. CONSTRUCT
- TEMPORARY PLUG ON NORTH INLET FOR FUTURE CONNECTION.
- CONSTRUCT MH-D1 INCLUDING CONNECTION TO MH-D3. F. TIE NEW PIPE INTO EXISTING DRAINAGE MANHOLE (DMH NO. 3). CONNECT NEW PIPE TO MH-D1. CONSTRUCT TEMPORARY PLUG ON NORTH INLET FOR FUTURE CONNECTION. ENSURE ALL CONNECTIONS, CAPS, PLUGS, ETC. ARE SECURE PRIOR TO PROCEEDING TO THE NEXT STEP.
- G. CUT, CAP, REMOVE, AND DISPOSE DRAINAGE PIPE BETWEEN EXISTING DMH NO. 3 AND EXISTING DMH NO. 4.
- H. CUT AND CAP EXISTING DRAINAGE PIPE FROM EXISTING DRAINAGE MANHOLE (DMH NO. 7) TO SEWER CONNECTION WITHIN EASTWOOD AVENUE. REMOVE AND DISPOSE EXISTING DRAINAGE MAHNOLES (DMH NO. 4, 5, 6, & 7) Ι.
- AND ASSOCIATED DRAINAGE PIPES. J. REMOVE AND SALVAGE EXISTING SUBSURFACE INFILTRATION SYSTEM CHAMBERS. SEE NOTE 2 BELOW.
- 2. STORMWATER CONSTRUCTION STAGE 2
- A. CONSTRUCTION BMP-3, INCLUDING ARCH CHAMBERS, MANIFOLD, FILTER FABRIC, AND CRUSHED STONE BEDDING.
- B. REMOVE TEMPORARY CAP ON DRAINAGE PIPE EXISTING BMP-2 AND CONNECT TO MANIFOLD SYSTEM OF BMP-3. C. CONSTRUCT MH-D2, INCLUDING CONNECTION TO MH-D3.
- D. INSTALL ROOF DRAIN CONNECTIONS TO MH-D1 AND MH-D2 PER ARCHITECTURAL PLANS.

NOTES:

- 1. THE SUGGESTED CONSTRUCTION SEQUENCE IS PROVIDED TO MAINTAIN CONVEYANCE AND TREATMENT OF RUNOFF IN ACCORDANCE WITH APPLICABLE REGULATORY PERMITS, ANY DEVIATIONS FROM THE SUGGESTED CONSTRUCTION SEQUENCE MUST BE COORDINATED WITH THE ENGINEER TO ENSURE COMPLIANCE WITH REGULATORY PERMITS.
- 2. THE CONTRACTOR SHALL NOT DISCONNECT THE EXISTING SUBSURFACE INFILTRATION SYSTEM (STEP 1G) FROM SERVICE UNTIL BMP-1 AND BMP-2 ARE PROPERLY INSTALLED AND PLACED ON-LINE.
- 3. THE CONTRACTOR SHALL TAKE CARE AND USE APPROPRIATE MEANS AND METHODS WHEN REMOVING COMPONENTS OF THE EXISTING SUBSURFACE INFILTRATION SYSTEM SO THEY MAY BE RE-USED IN THE CONSTRUCTION OF BMP-3. THE CONTRACTOR SHALL COORDINATE WITH THE OWNER TO STORE THE SALVAGED MATERIALS IN A SAFE AND SECURE LOCATION UNTIL SUCH TIME AS THEY MAY BE INSTALLED PER THE SUGGESTED CONSTRUCTION SEQUENCE. IF ANY COMPONENTS OF THE EXISTING SUBSURFACE INFILTRATION SYSTEM ARE DAMAGED DURING OR AFTER REMOVAL, THE CONTRACTOR SHALL PROVIDE AND INSTALL NEW COMPONENTS AT NO ADDITIONAL COST TO THE OWNER.




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LBD Scale: AS NOTED Drawing Number C-6.4

_	10		9		8		
	CULTEC RECHARGER® 33	OXLHD PRODUCT SPE	ECIFICATIONS				
	GENERAL CULTEC RECHARGER 330) MANAGEMENT. THE CHAN CONTROLLING THE FLOW	BERS MAY BE USED	FOR RETENTION, RECHAI				
A	CHAMBER PARAMETERS 1. THE CHAMBERS SHAL (203-775-4416 OR 1-800-		D BY CULTEC, INC. OF E	ROOKFIELD, CT, USA.			
	2. THE CHAMBER SHALL DENSITY POLYETHYLEN		OFORMED OF HIGH MOL A BLACK INTERIOR AND B				
_	 THE CHAMBER SHALL E THE CHAMBER SHALL E 				÷		
	5. THE CHAMBER SHALL CONNECTIONS MUST E COUPLINGS OR SEPAR.	BE FULLY SHOULDER	AN INTERLOCKING OVERI ED OVERLAPPING RIBS, I		Ĩ	7.5' MIN. WOVEN GEOT BENEATH F	
В	INSTALLED LENGTH OF	L, 52 INCHES (1321 A JOINED RECHARGI	mm) WIDE AND 8.5 FEE ER 330XLHD SHALL BE 7 FI	「 (2.59 m) LONG. THE EET (2.13 m).	 10.0' WOVEN GE BENEAT	CONNECTO MIN. OTEXTILE H INLET	
	SIDE PORTAL SHALL	HAVE TWO SIDE POI ATE AN INTERNAL M 3E 10.5 INCHES (2)		C HVLV® FC-24 FEED DIMENSIONS OF EACH CHES (292 mm) WIDE.	PIPES	()	
_	9. THE NOMINAL CHAMB SHALL BE 12 INCHES (LONG.		THE CULTEC HVLV FC- CHES (406 mm) WIDE AND				
	· · · · · · · · · · · · · · · · · · ·	- WITHOUT STONE.	ECHARGER 330XLHD CH THE NOMINAL STORAGE UNIT (1.478 m ³ / UNIT) - WI	VOLUME OF A JOINED			
С	11. THE NOMINAL STORAG / FT (0.085 m³ / m) - WITH		/LV FC-24 FEED CONNECT	OR SHALL BE 0.913 FT³			
	12. THE RECHARGER 330) INTO THE SIDEWALLS WATER.		LL HAVE FIFTY-SIX DISCI RE TO PROMOTE LATEI				
_	13. THE RECHARGER 330X						
	15. THE RECHARGER 330X	LRHD STAND ALONE		S A WHOLE CHAMBER			
D	HAVING TWO FULLY FO OR SEPARATE END WA 16.THE RECHARGER 3302	LLS.	WALLS AND HAVING NO S				
D	ENDWALL WITH A LOW (876 mm) WIDE.	ER TRANSFER OPEN	DWALL AND ONE PARTIAL ING OF 14 INCHES (356 mi	n) HIGH X 34.5 INCHES			
_		PEN ENDWALL AND	UNIT MUST BE FORMED A ONE PARTIALLY FORMEI INCHES (356 mm) HIGH X	INTEGRAL ENDWALL			
	18. THE RECHARGER 330X ONE FULLY FORMED IN SEPARATE END PLATES	TEGRAL ENDWALL A	ST BE FORMED AS A WHO ND ONE FULLY OPEN END				
F		HAVING NO SEPARA	E FORMED AS A WHOLE (TE END PLATES OR SEPA THE RECHARGER 330XLF	RATE END WALLS. THE			
E	20.CHAMBERS MUST HAV RIBS.	E HORIZONTAL STIFF	ENING FLEX REDUCTION	STEPS BETWEEN THE			
	21.THE CHAMBER SHALL TOP OF THE ARCH IN T PORT OR CLEAN-OUT.		mm) DIAMETER RAISED I UNIT TO BE USED AS AN				
_	22.THE UNITS MAY BE CORRUGATION.	TRIMMED TO CUS	TOM LENGTHS BY CUT	TING BACK TO ANY			
	23.THE CHAMBER SHALL E 24.MAXIMUM ALLOWED CO	OVER OVER TOP OF U	NIT SHALL BE 12 FEET (3.6	6 m)			
F	25.THE CHAMBER SHALL ACCORDING TO CULTE		WITHSTAND TRAFFIC LOA				
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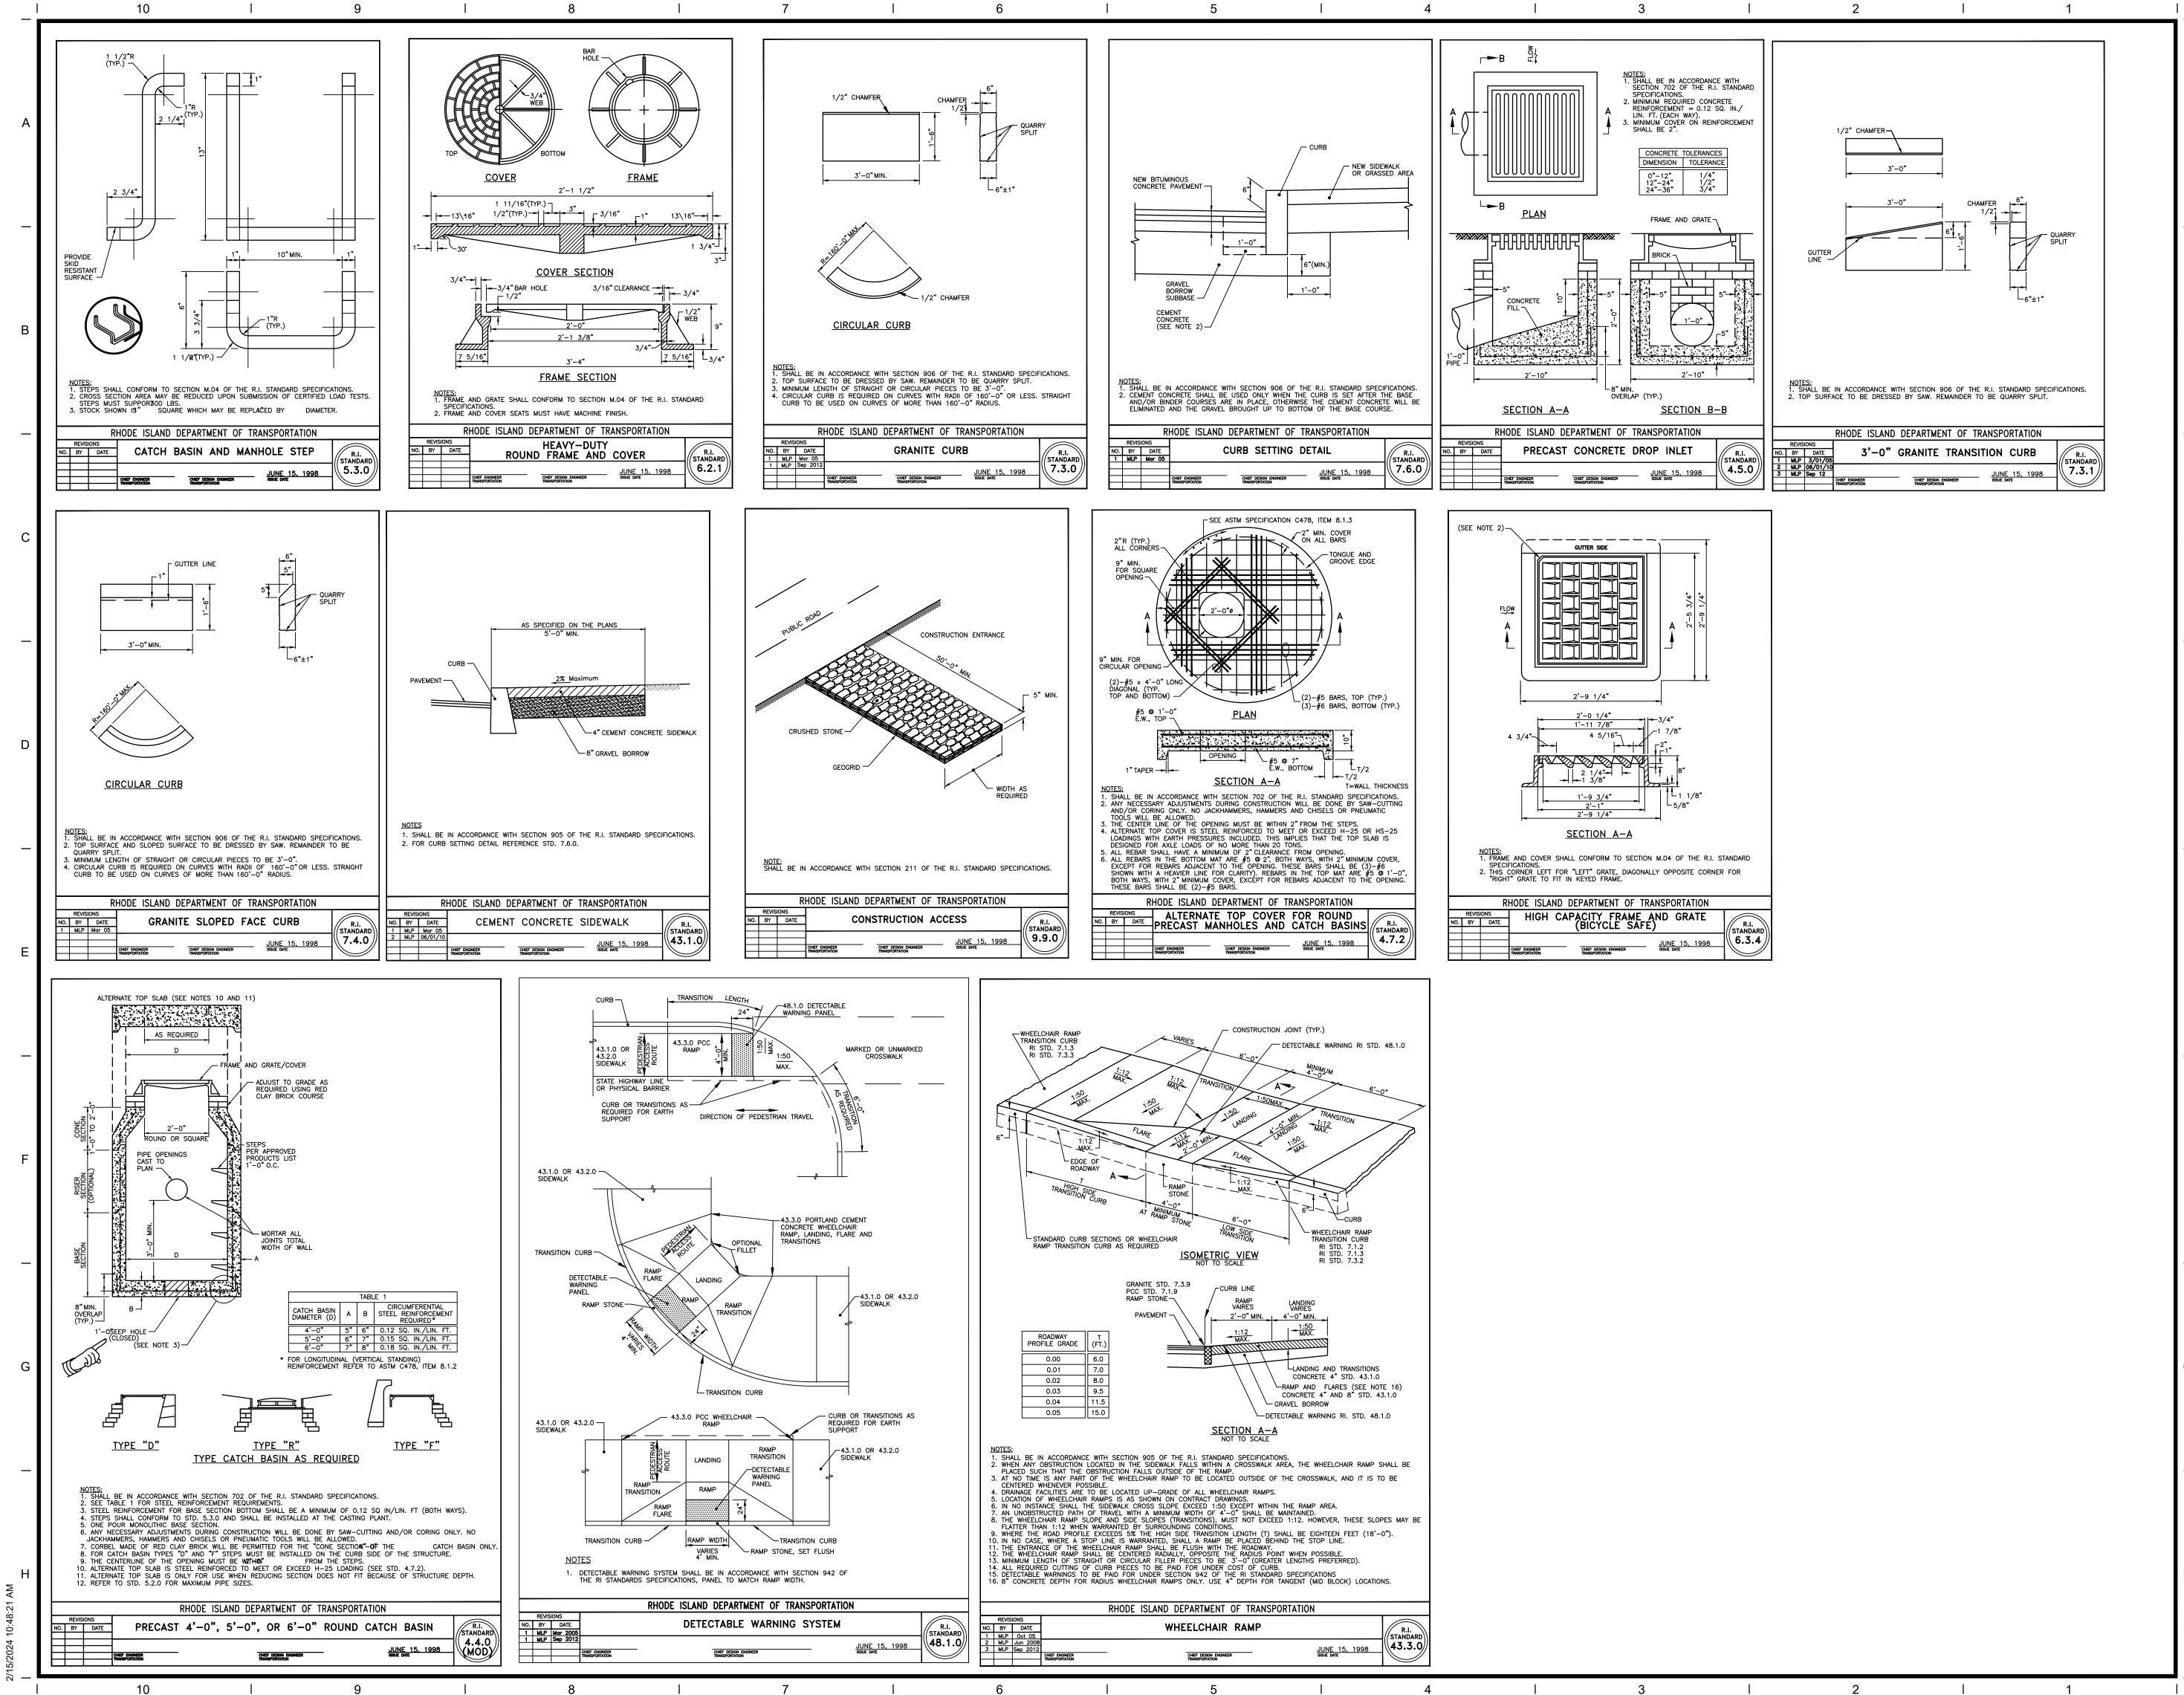


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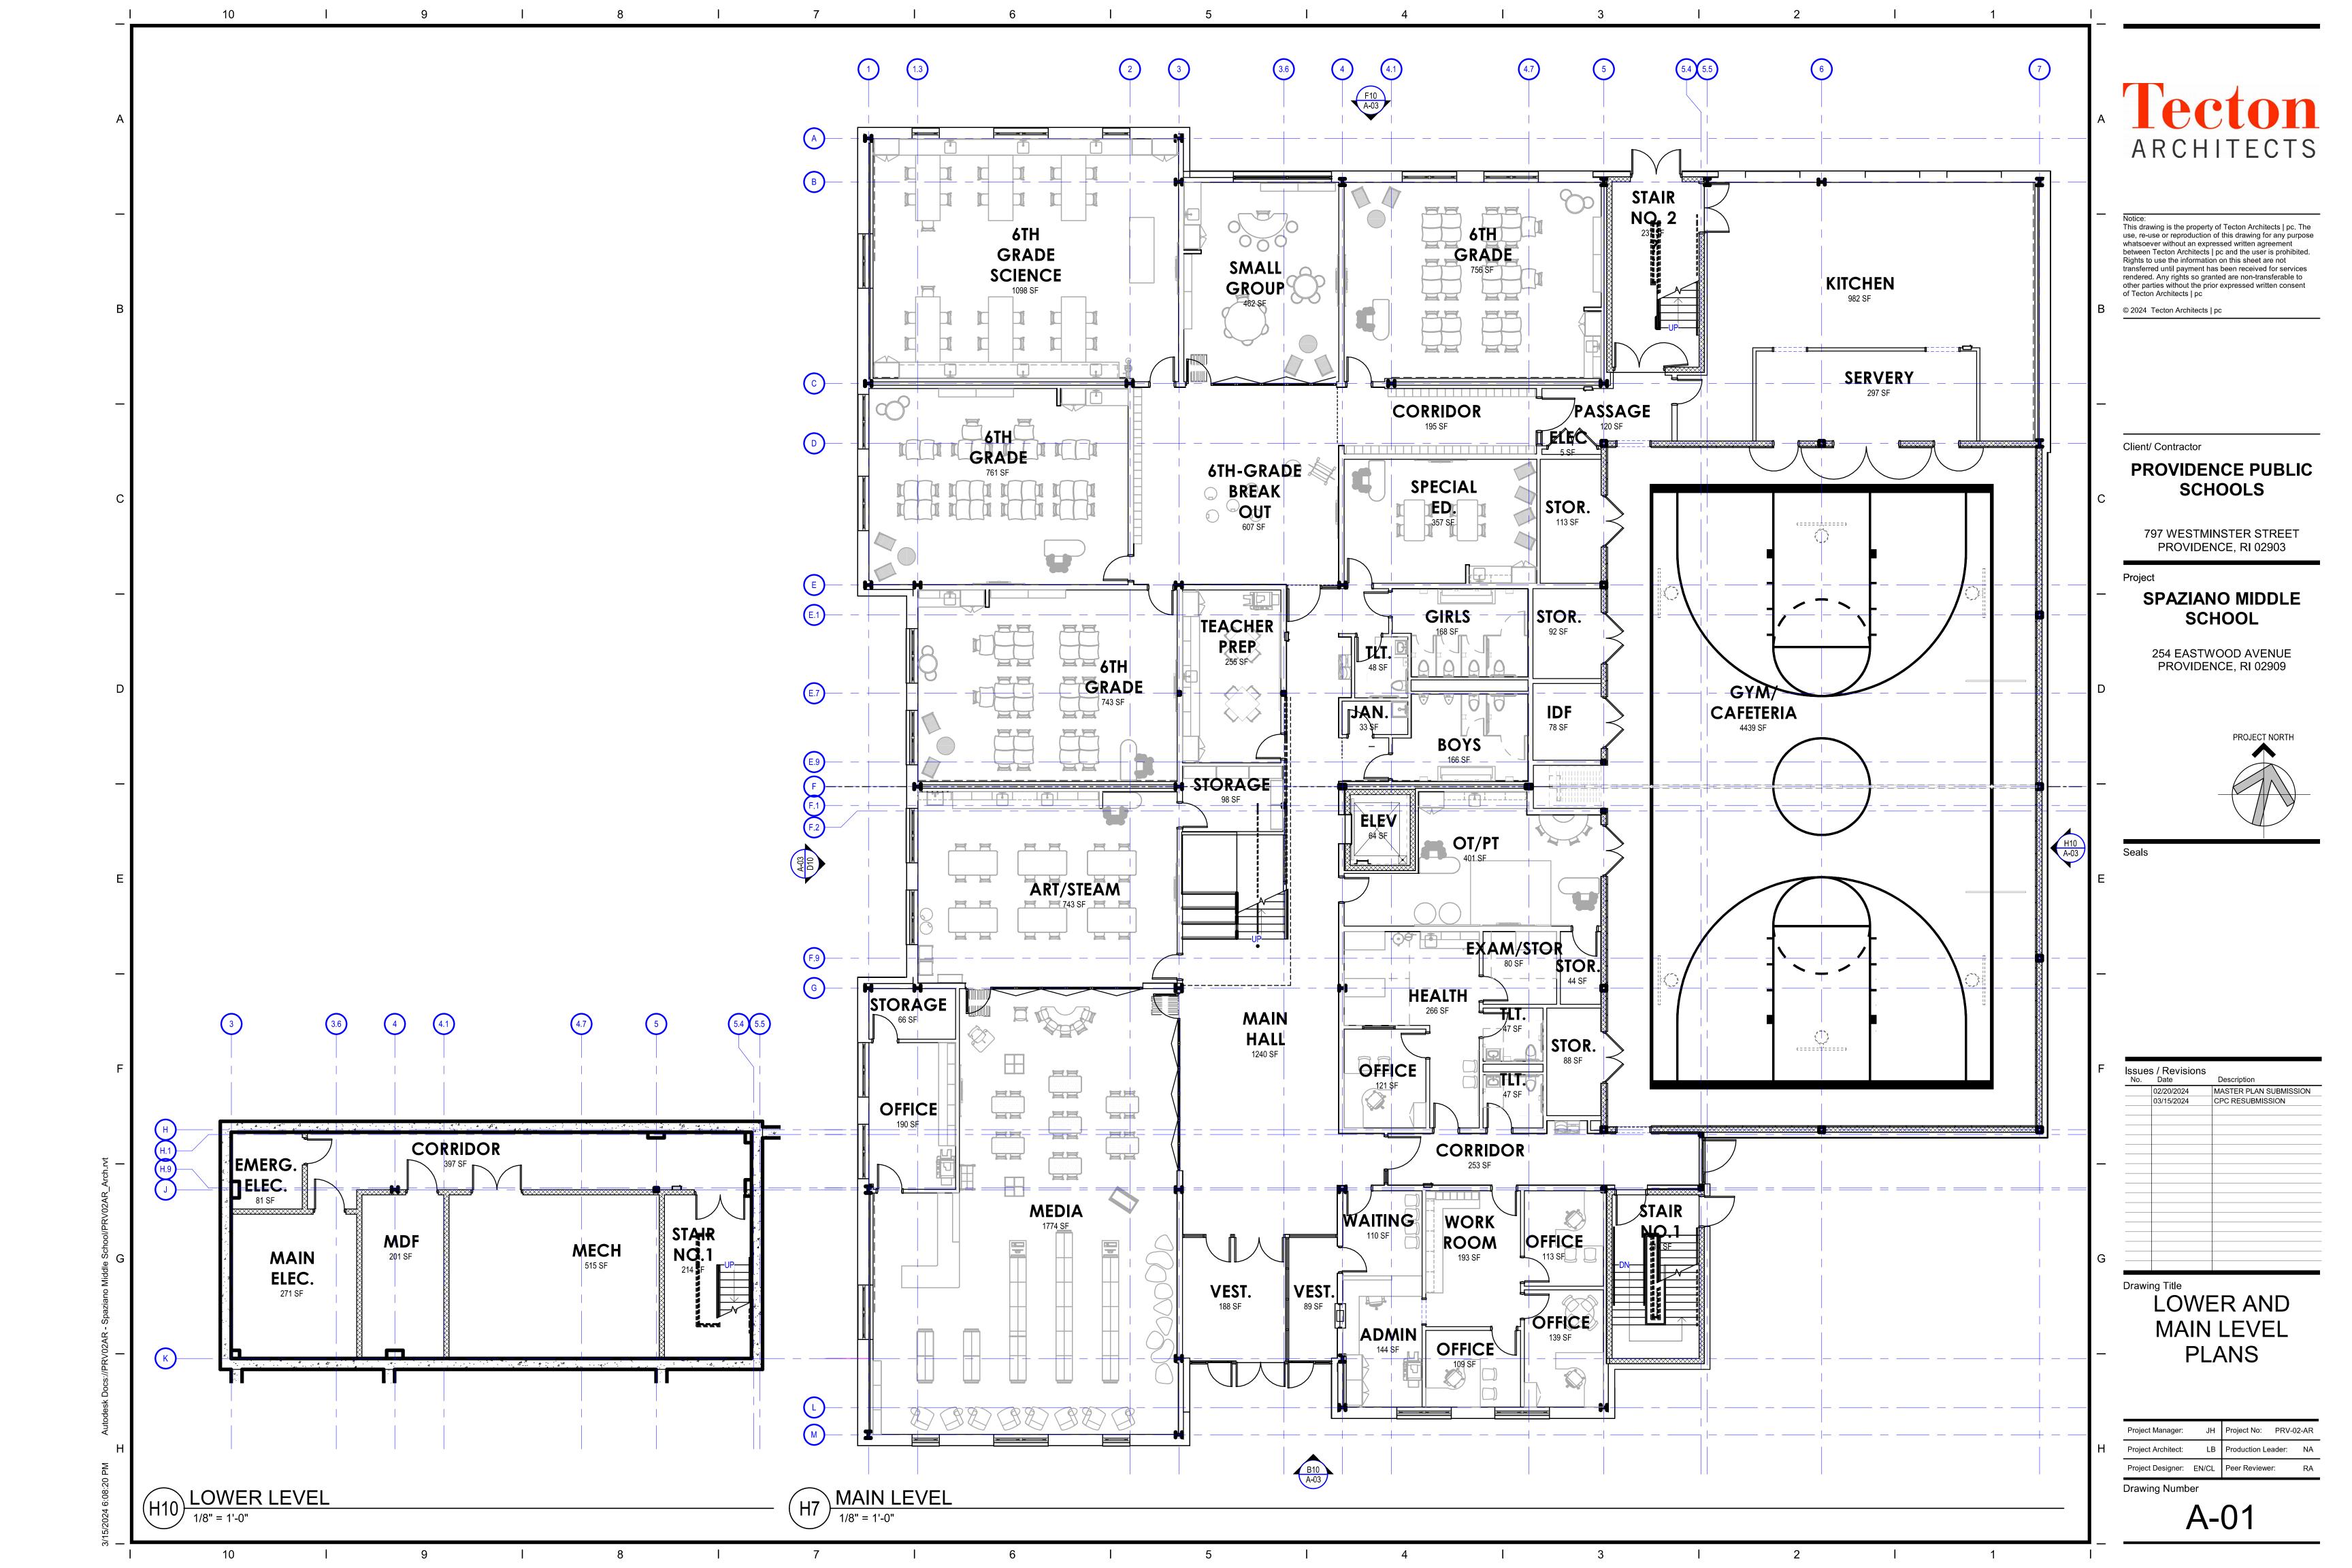
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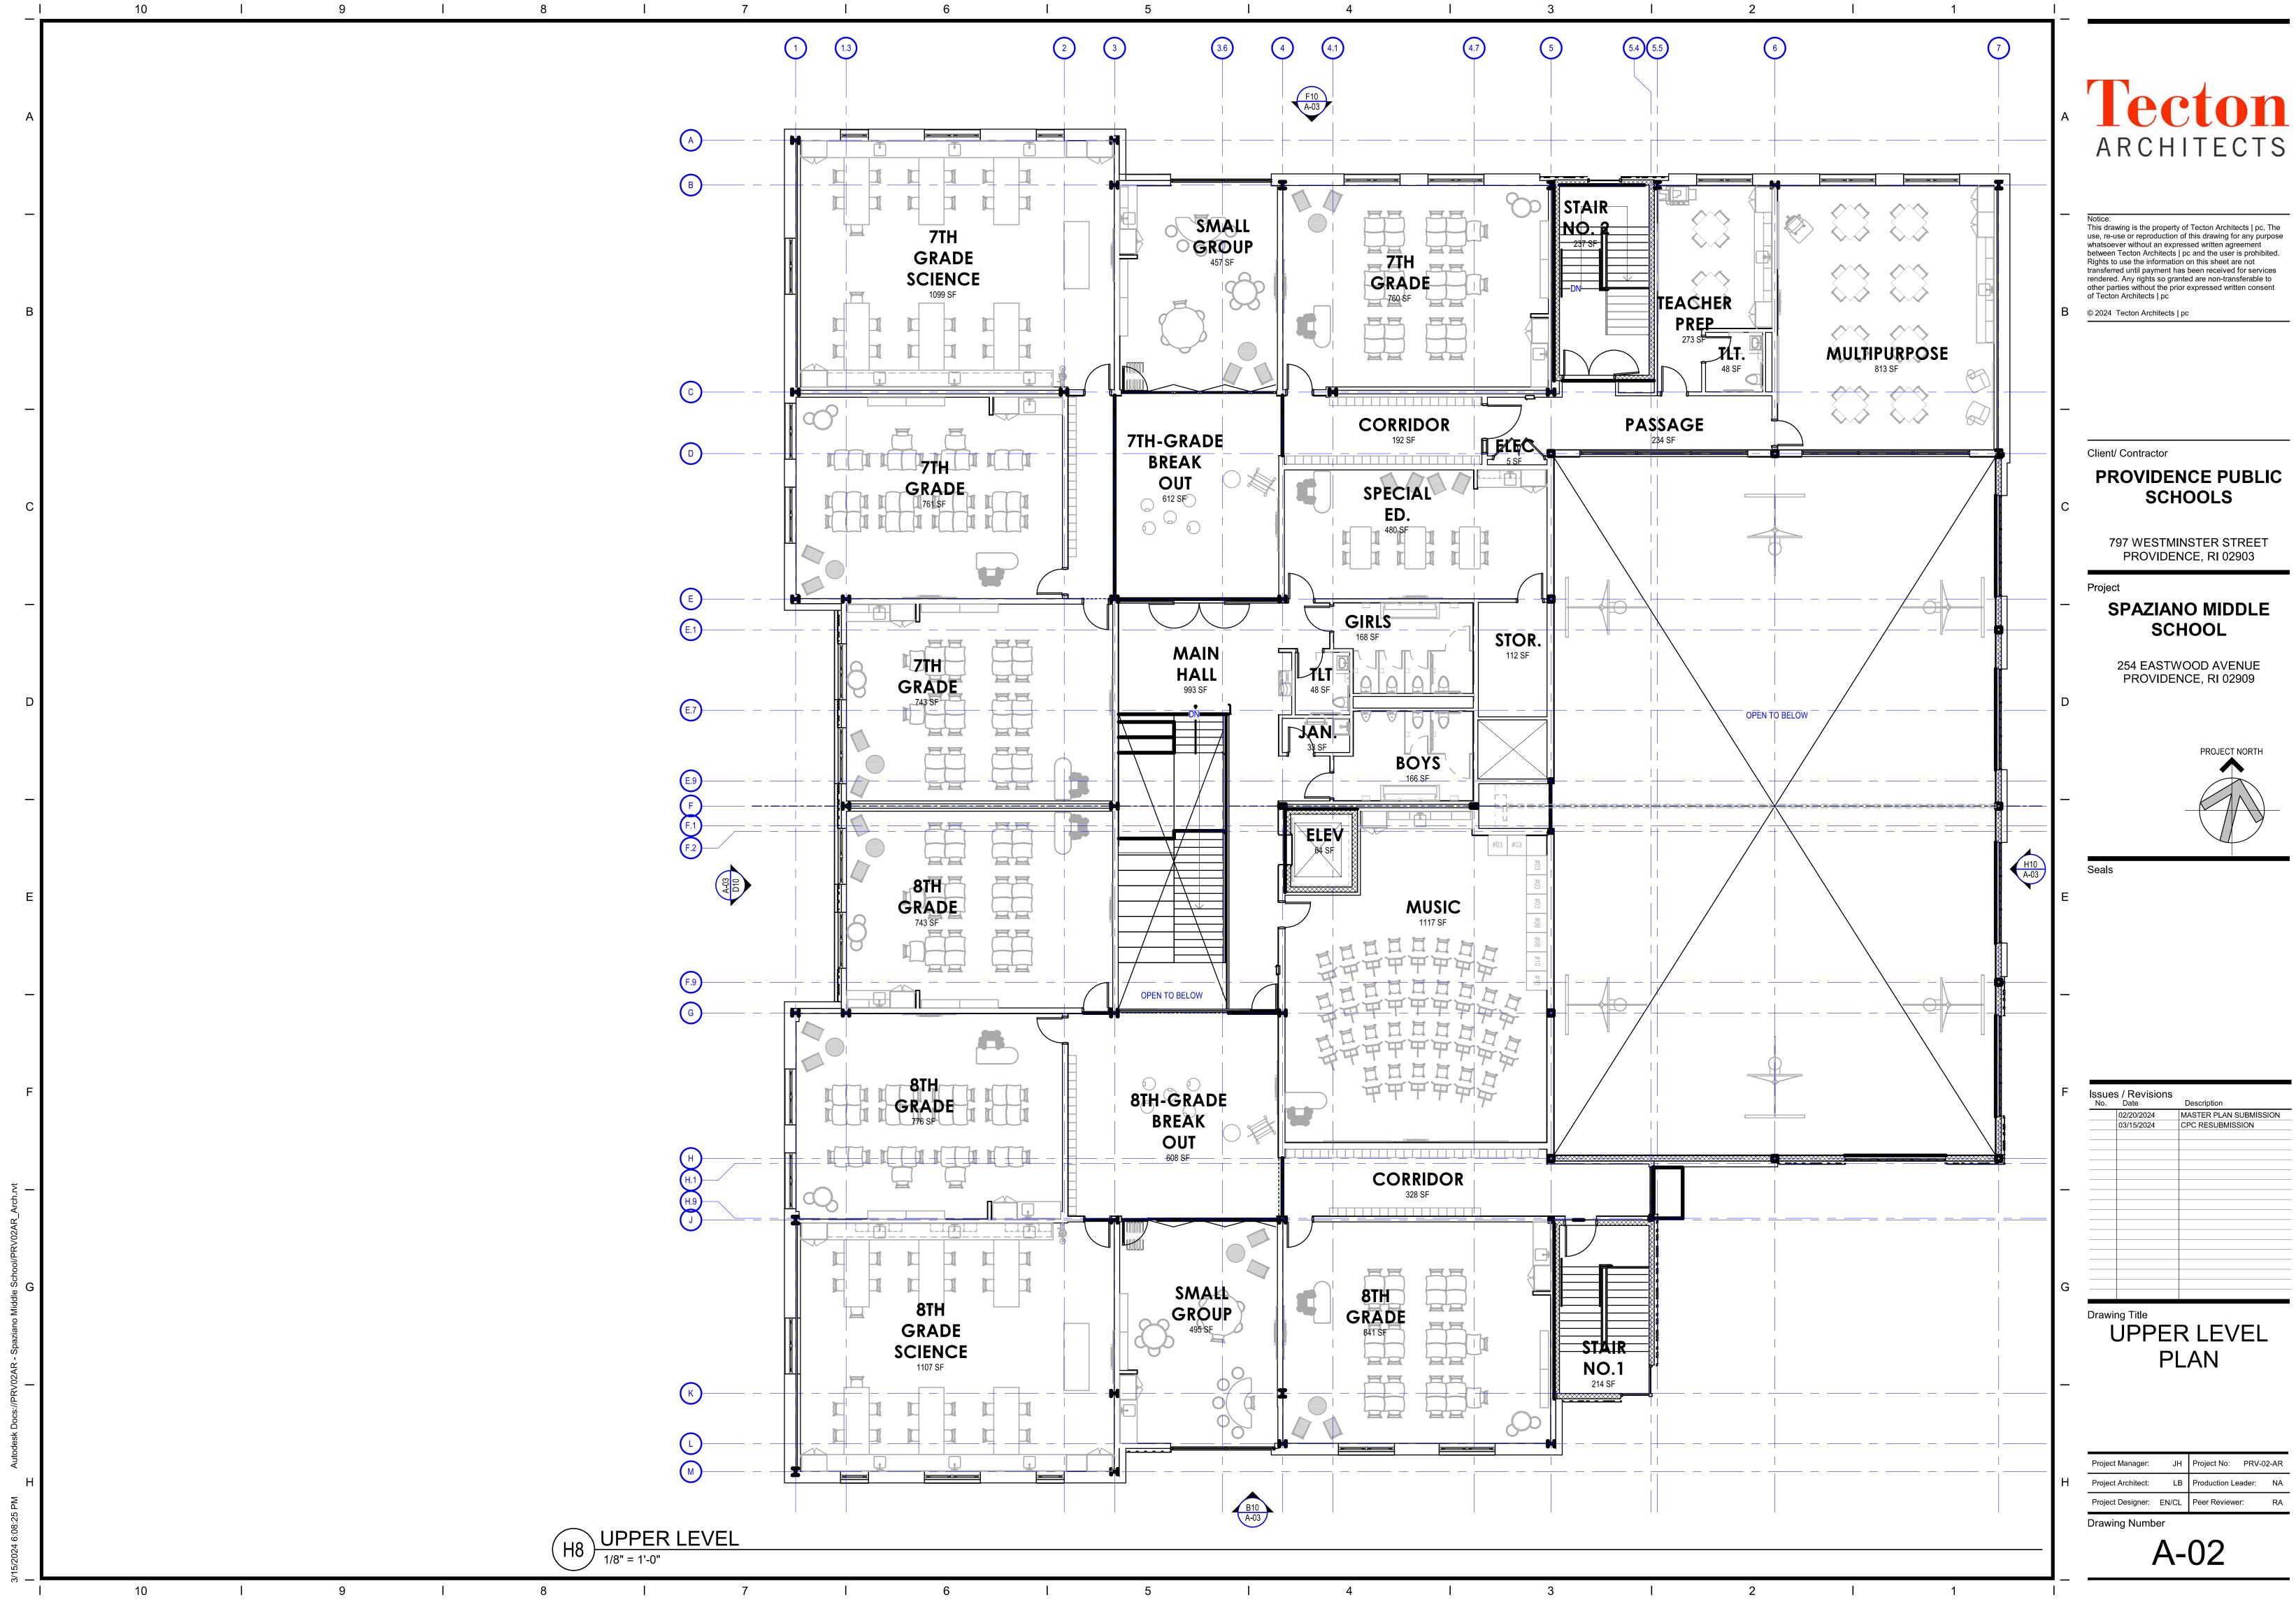
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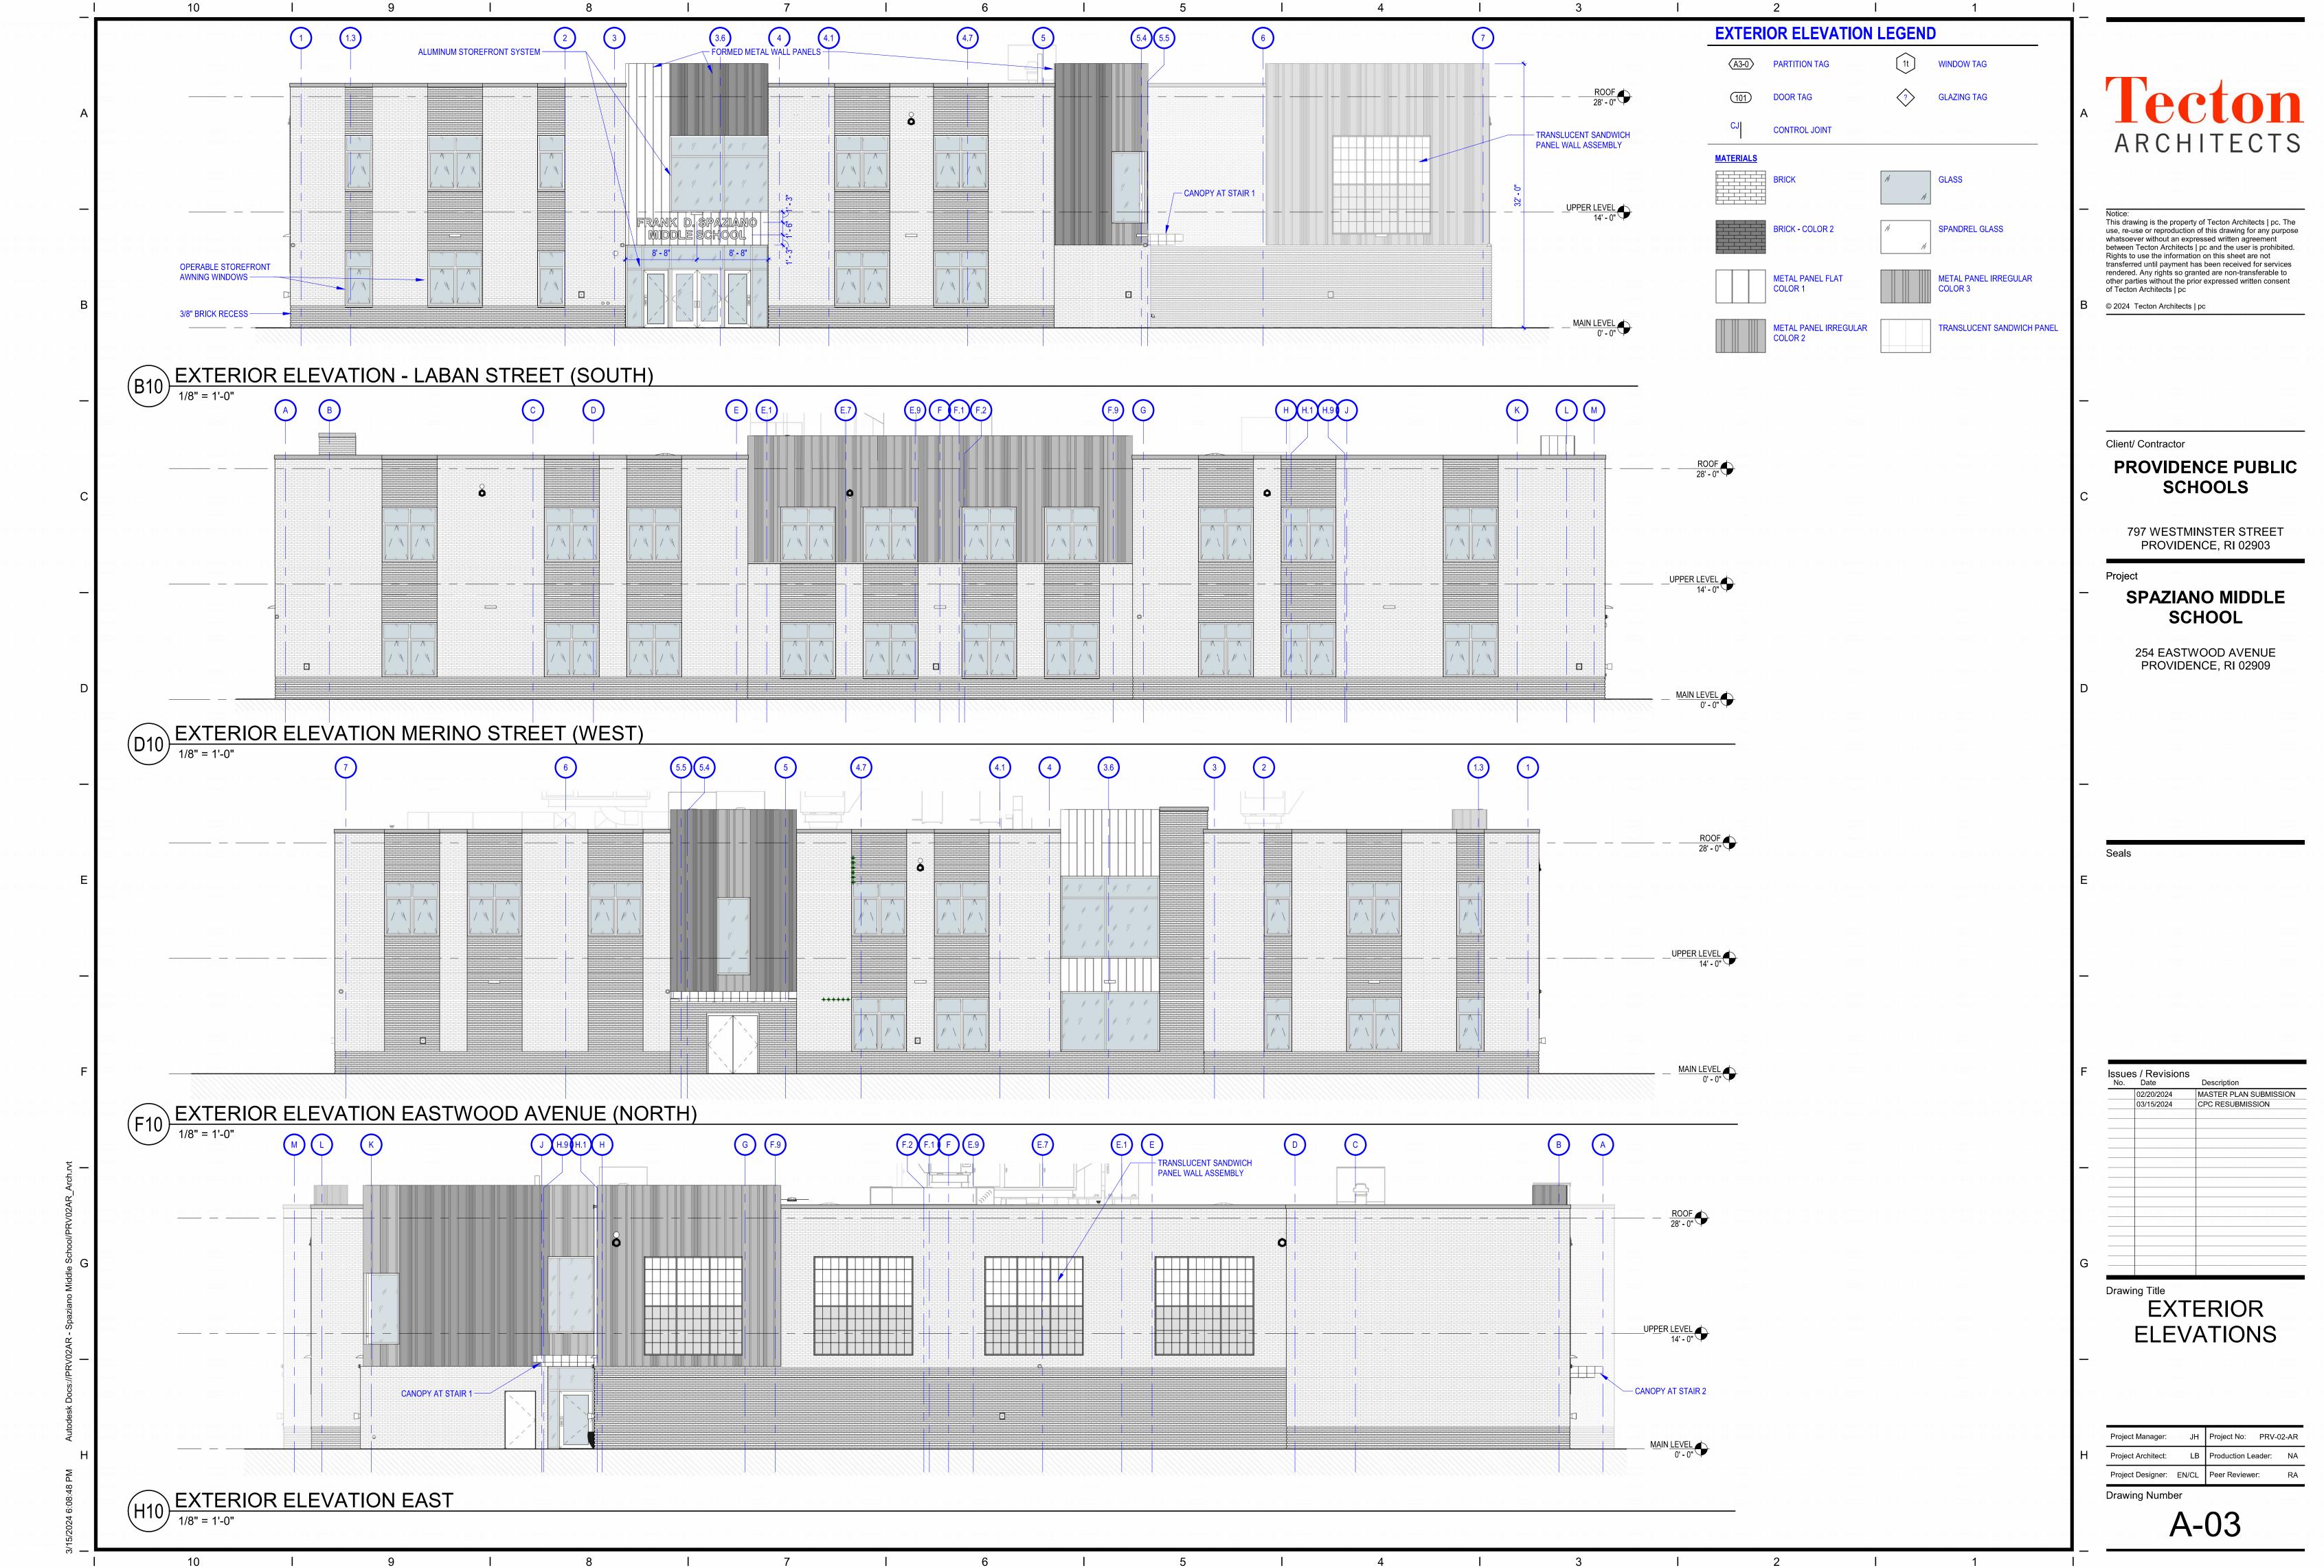



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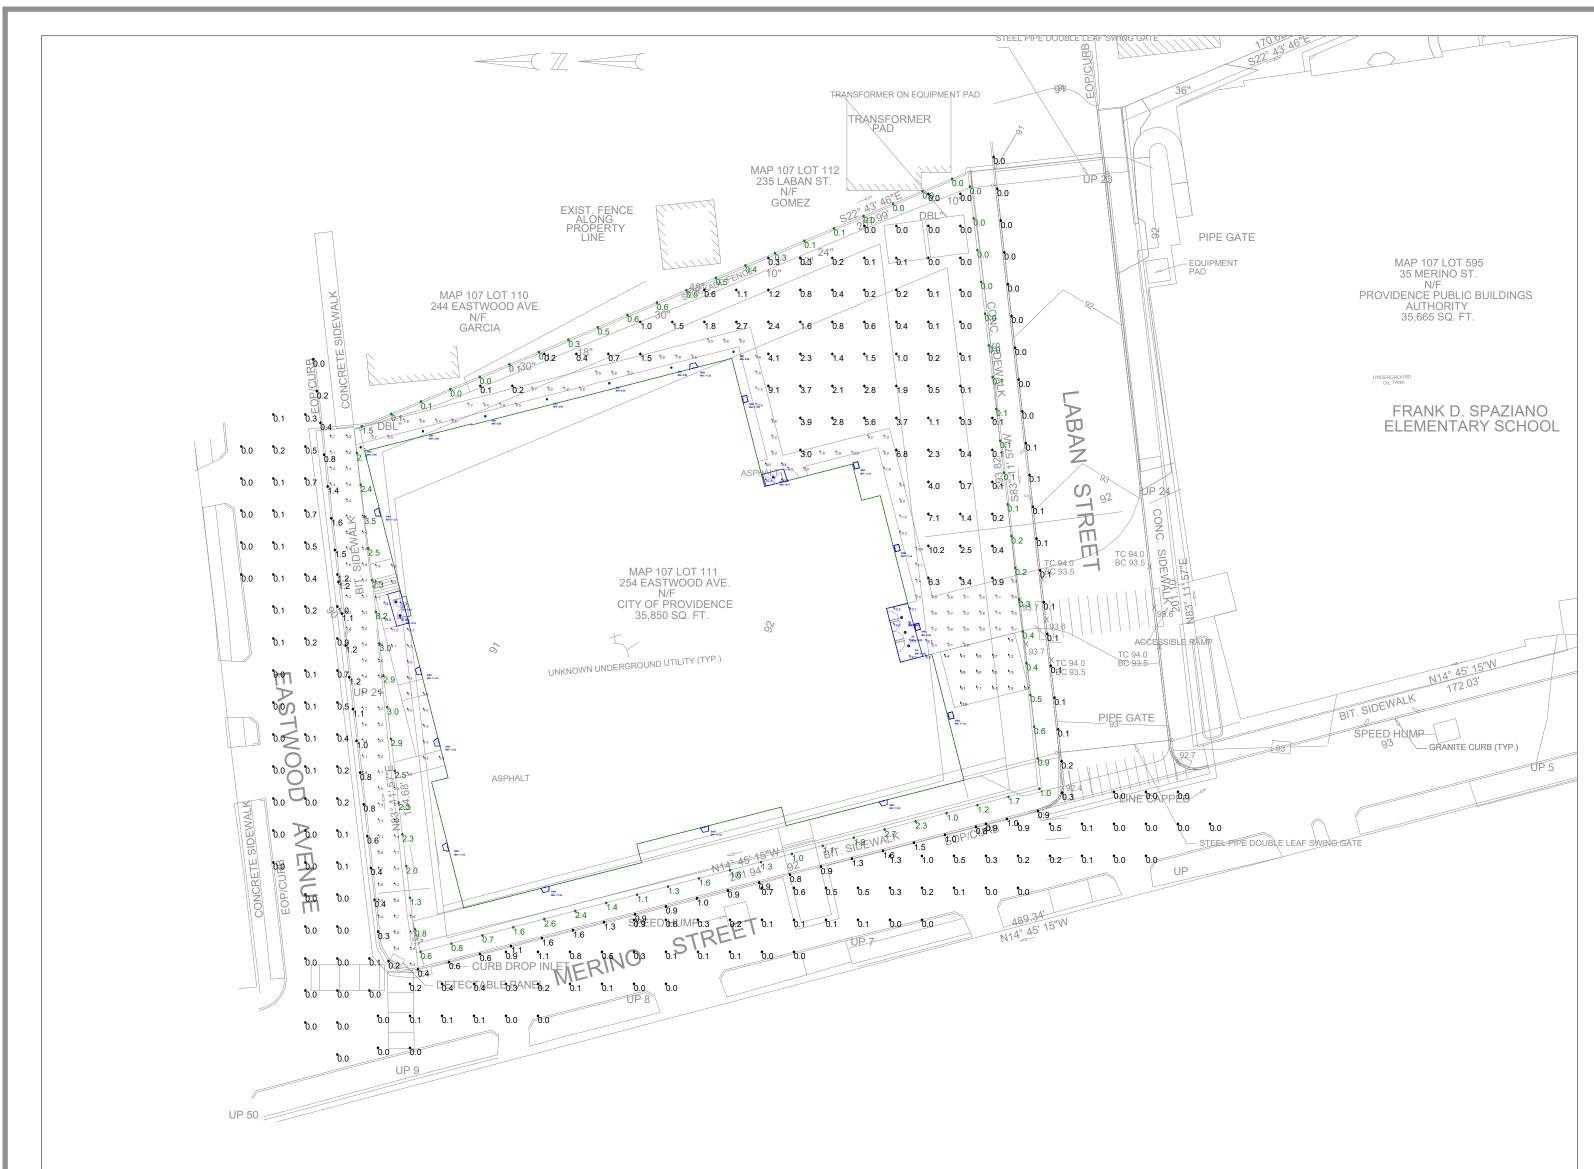


IEW FROM LABAN STREET 8" = 1'-0"

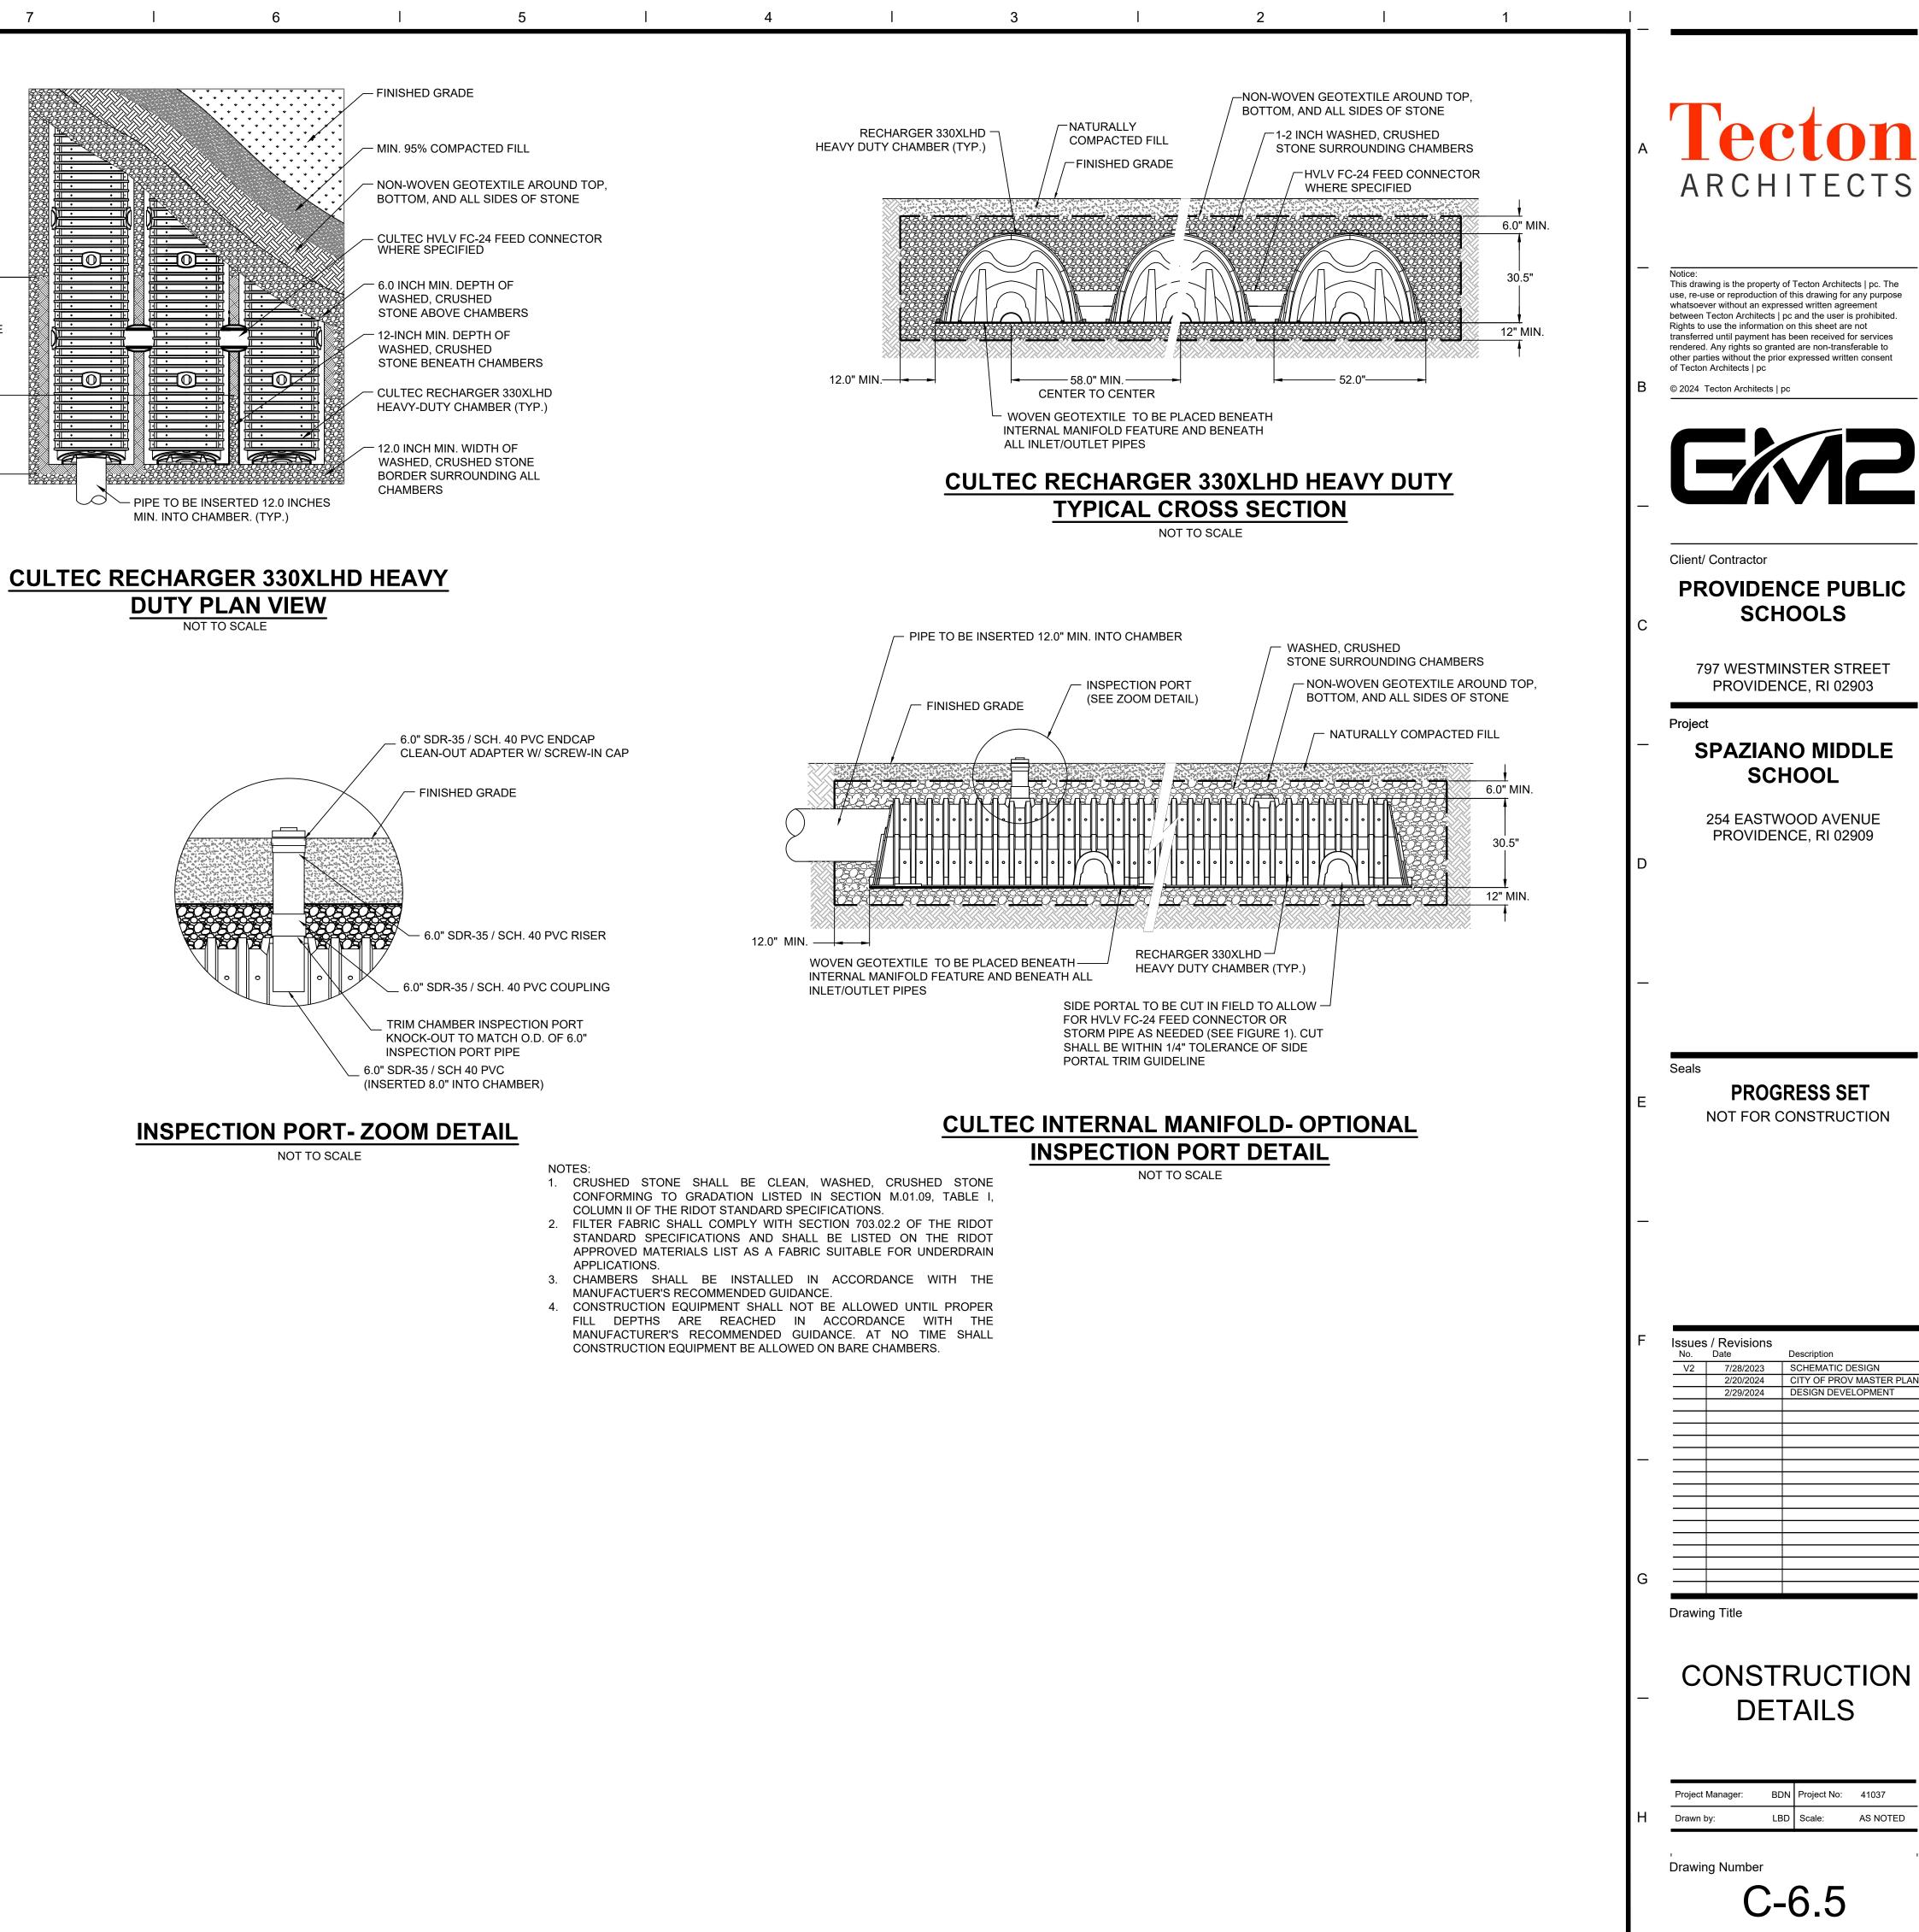

IEW FROM MERINO AND LABAN 8" = 1'-0"

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Scale: 1 inch= 30 Ft.

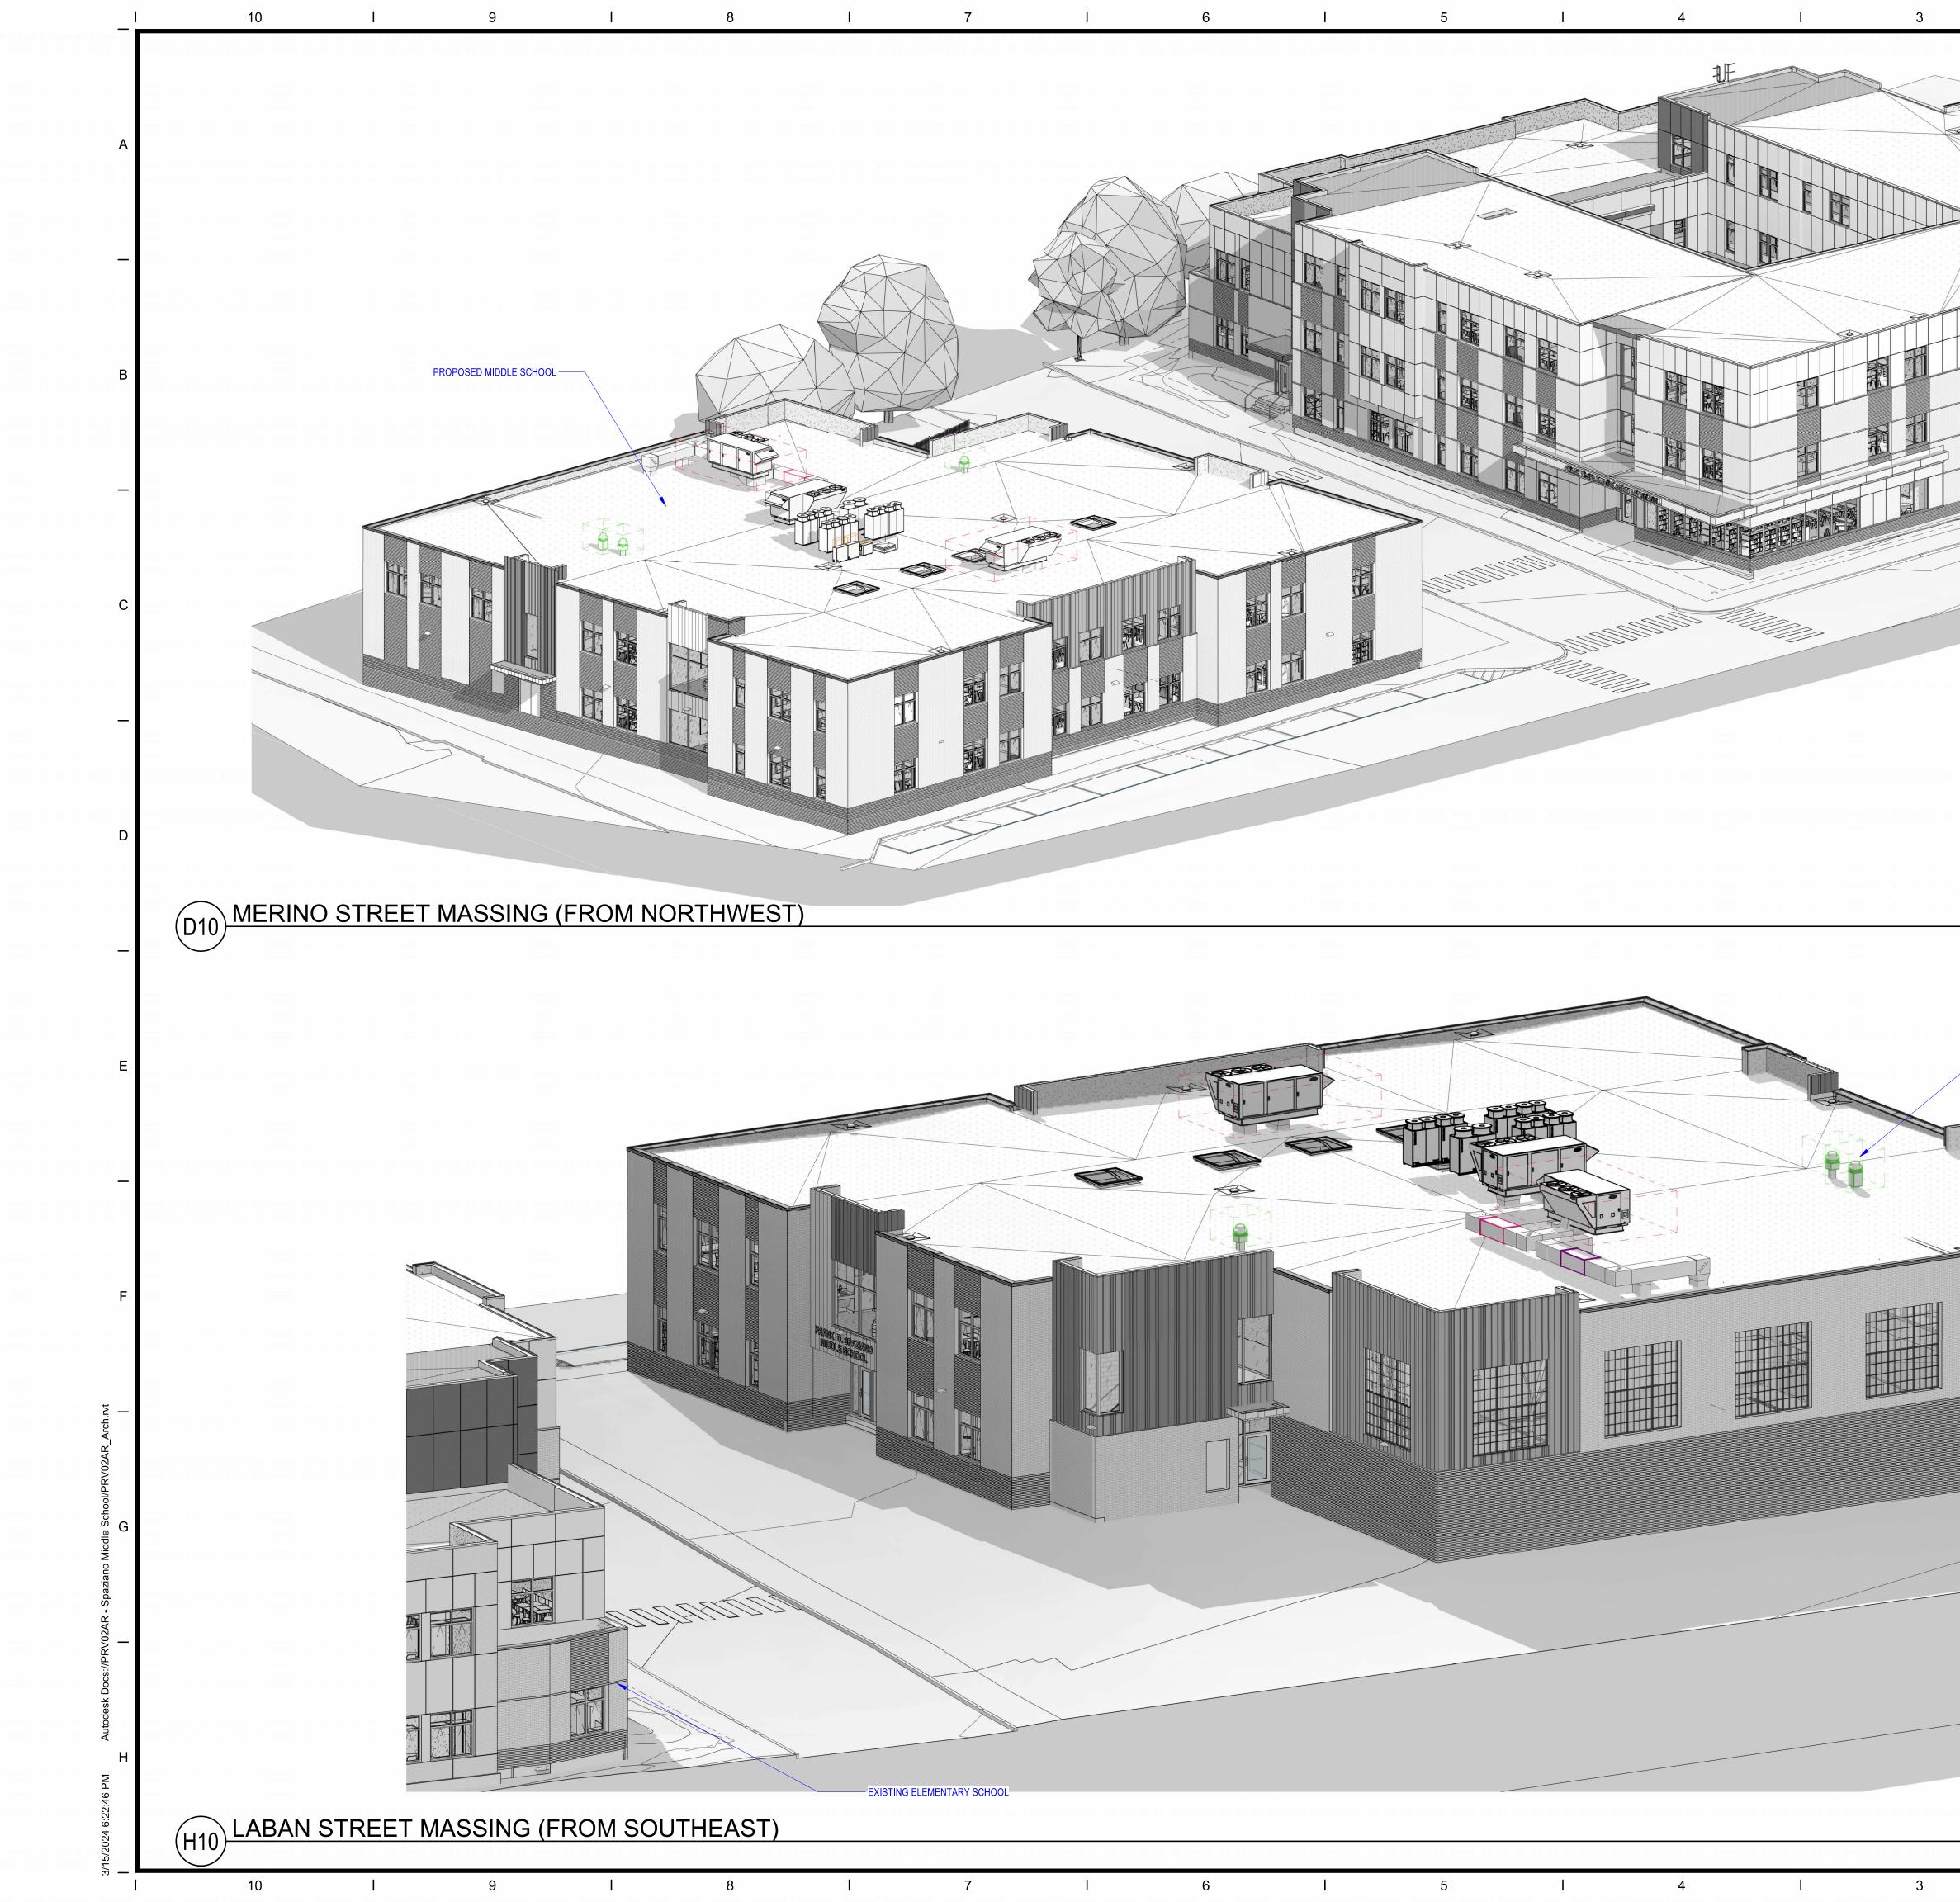DESIGN NOTES: 1. MOUNTING HEIGHTS: SEE FIXTURE LOCATIONS 2. MEASUREMENTS TAKEN 0" AFF 3. SURFACE REFLECTANCE: .5

Note on this Design: This report makes no representations in regard to Lighting Design or Specification, rather it attempts to accurately reflect the photometric results of a design, as approved by others.

Note on these Photometric Calculations:

This analysis is a mathematical model and can be only as accurate as is permitted by the third-party software and the IES standards used. All digital CAD data appear to be accurate, however, this apparent accuracy is an artifact of the techniques used to generate it and is in no way intended to imply accuracy in the real world.


There are many factors that will impact the actual performance of Lighting in the constructed space, including: the accuracy of the original source (.ies) files supplied by the manufacturer, input voltage ballast variances, actual finish values in the constructed environment, manufacturing variations in both the source (lamp) and the luminaire, final luminaire placement, obstructions, and installation quality. Further, field measurement itself is subject to errors arising from measuring methods and/or technology selected, and the knowledge/ability of the measuring party. While the creator of this lighting study makes every effort to ensure accuracy, they cannot be held liable for any errors. The recipient of this lighting study understands and accepts that the likelihood of scaling error increases when no .DWG file or other properly-dimensioned drawing is provided to the designer.

Reflective Values have a significant effect on light levels, the end-user of the document should confirm these values before accepting the results of any photometric report. The managing contractor/ architect/engineer is responsible for ensuring compliance to all relevant lighting ordinance(s) and energy codes required on this project.


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						Lumens	Watts		
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SB1	\bigcirc	7	0.900	SIGNIFY	PBL-36-14L-100-NW-G2-3-UNV-XX	492	6.1		
				GARDCO					
SW1		8	0.900	SIGNIFY GARDCO	101L-16L-400-NW-G2-3-UNV-FAWS-XX	2728	22		
SW2		1	0.900	STONCO	LPW32-70-NW-G3-4-UNV-FAWS-XX	8139	64.6		
SW3		4	0.900	STONCO	LPW32-70-NW-G3-3-UNV-FAWS-XX	8248	64.6		

Calculation Summary								
Label	CalcType	Units	Avg	Max	Min	Avg/Min	Max/Min	Grid Z
BIKE RACKS	Illuminance	Fc	4.37	13.9	0.7	6.24	19.86	0
BIT SIDEWALK	Illuminance	Fc	1.65	3.4	0.4	4.13	8.50	0
EASTWOOD STREET	Illuminance	Fc	0.18	1.2	0.0	N.A.	N.A.	0
ENTRANCE - EASTWOOD STREET	Illuminance	Fc	16.60	19.3	14.0	1.19	1.38	0
ENTRANCE - LABAN STREET	Illuminance	Fc	15.26	21.4	8.6	1.77	2.49	0
ENTRANCE - SOUTHEAST	Illuminance	Fc	9.63	10.4	8.8	1.09	1.18	0
EOP-CRUB	Illuminance	Fc	0.63	1.6	0.0	N.A.	N.A.	N.A.
MERINO STREET	Illuminance	Fc	0.26	1.3	0.0	N.A.	N.A.	0
PLAYGROUND	Illuminance	Fc	1.55	10.2	0.0	N.A.	N.A.	0
PROPERTY BOUNDARY	Illuminance	Fc	1.10	8.2	0.0	N.A.	N.A.	N.A.
SIDEWALK NORTH	Illuminance	Fc	4.68	11.0	1.8	2.60	6.11	0
SIDEWALK SOUTHEAST	Illuminance	Fc	5.04	13.8	0.3	16.80	46.00	0

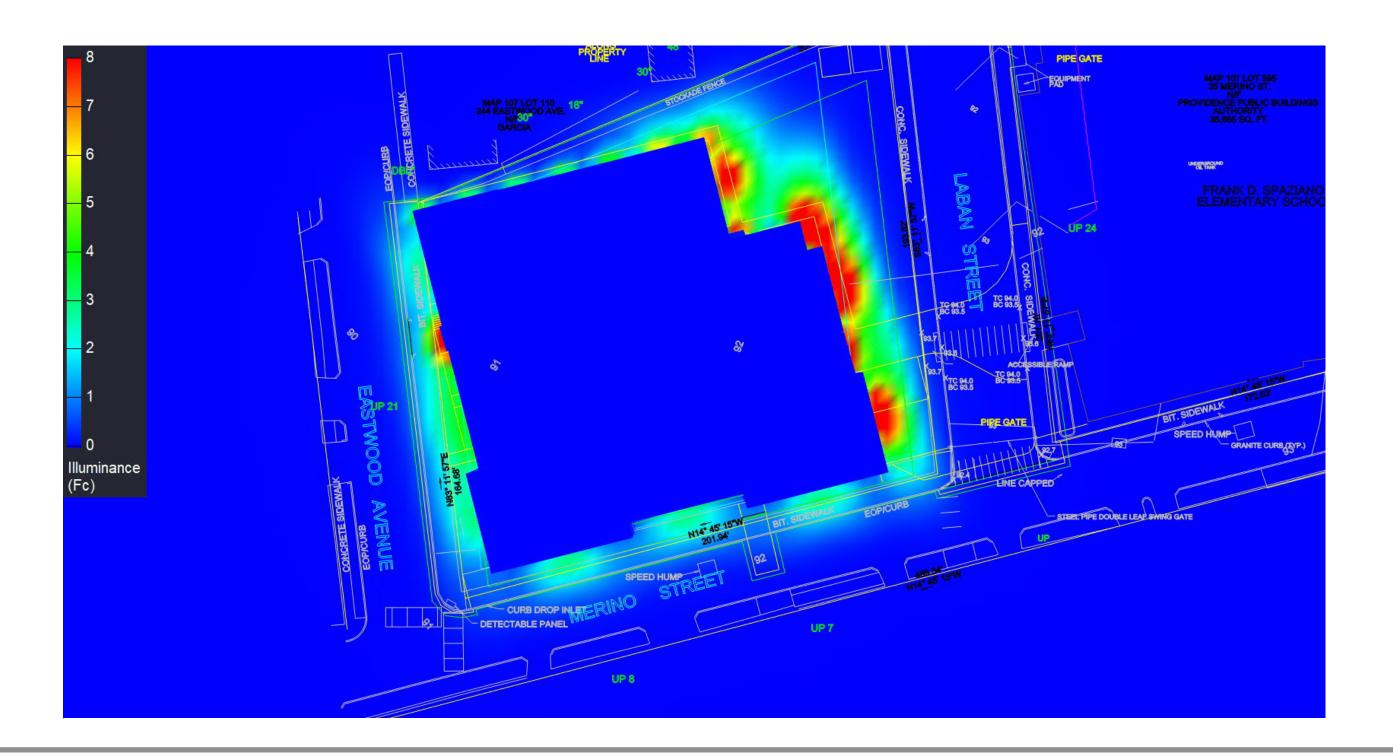

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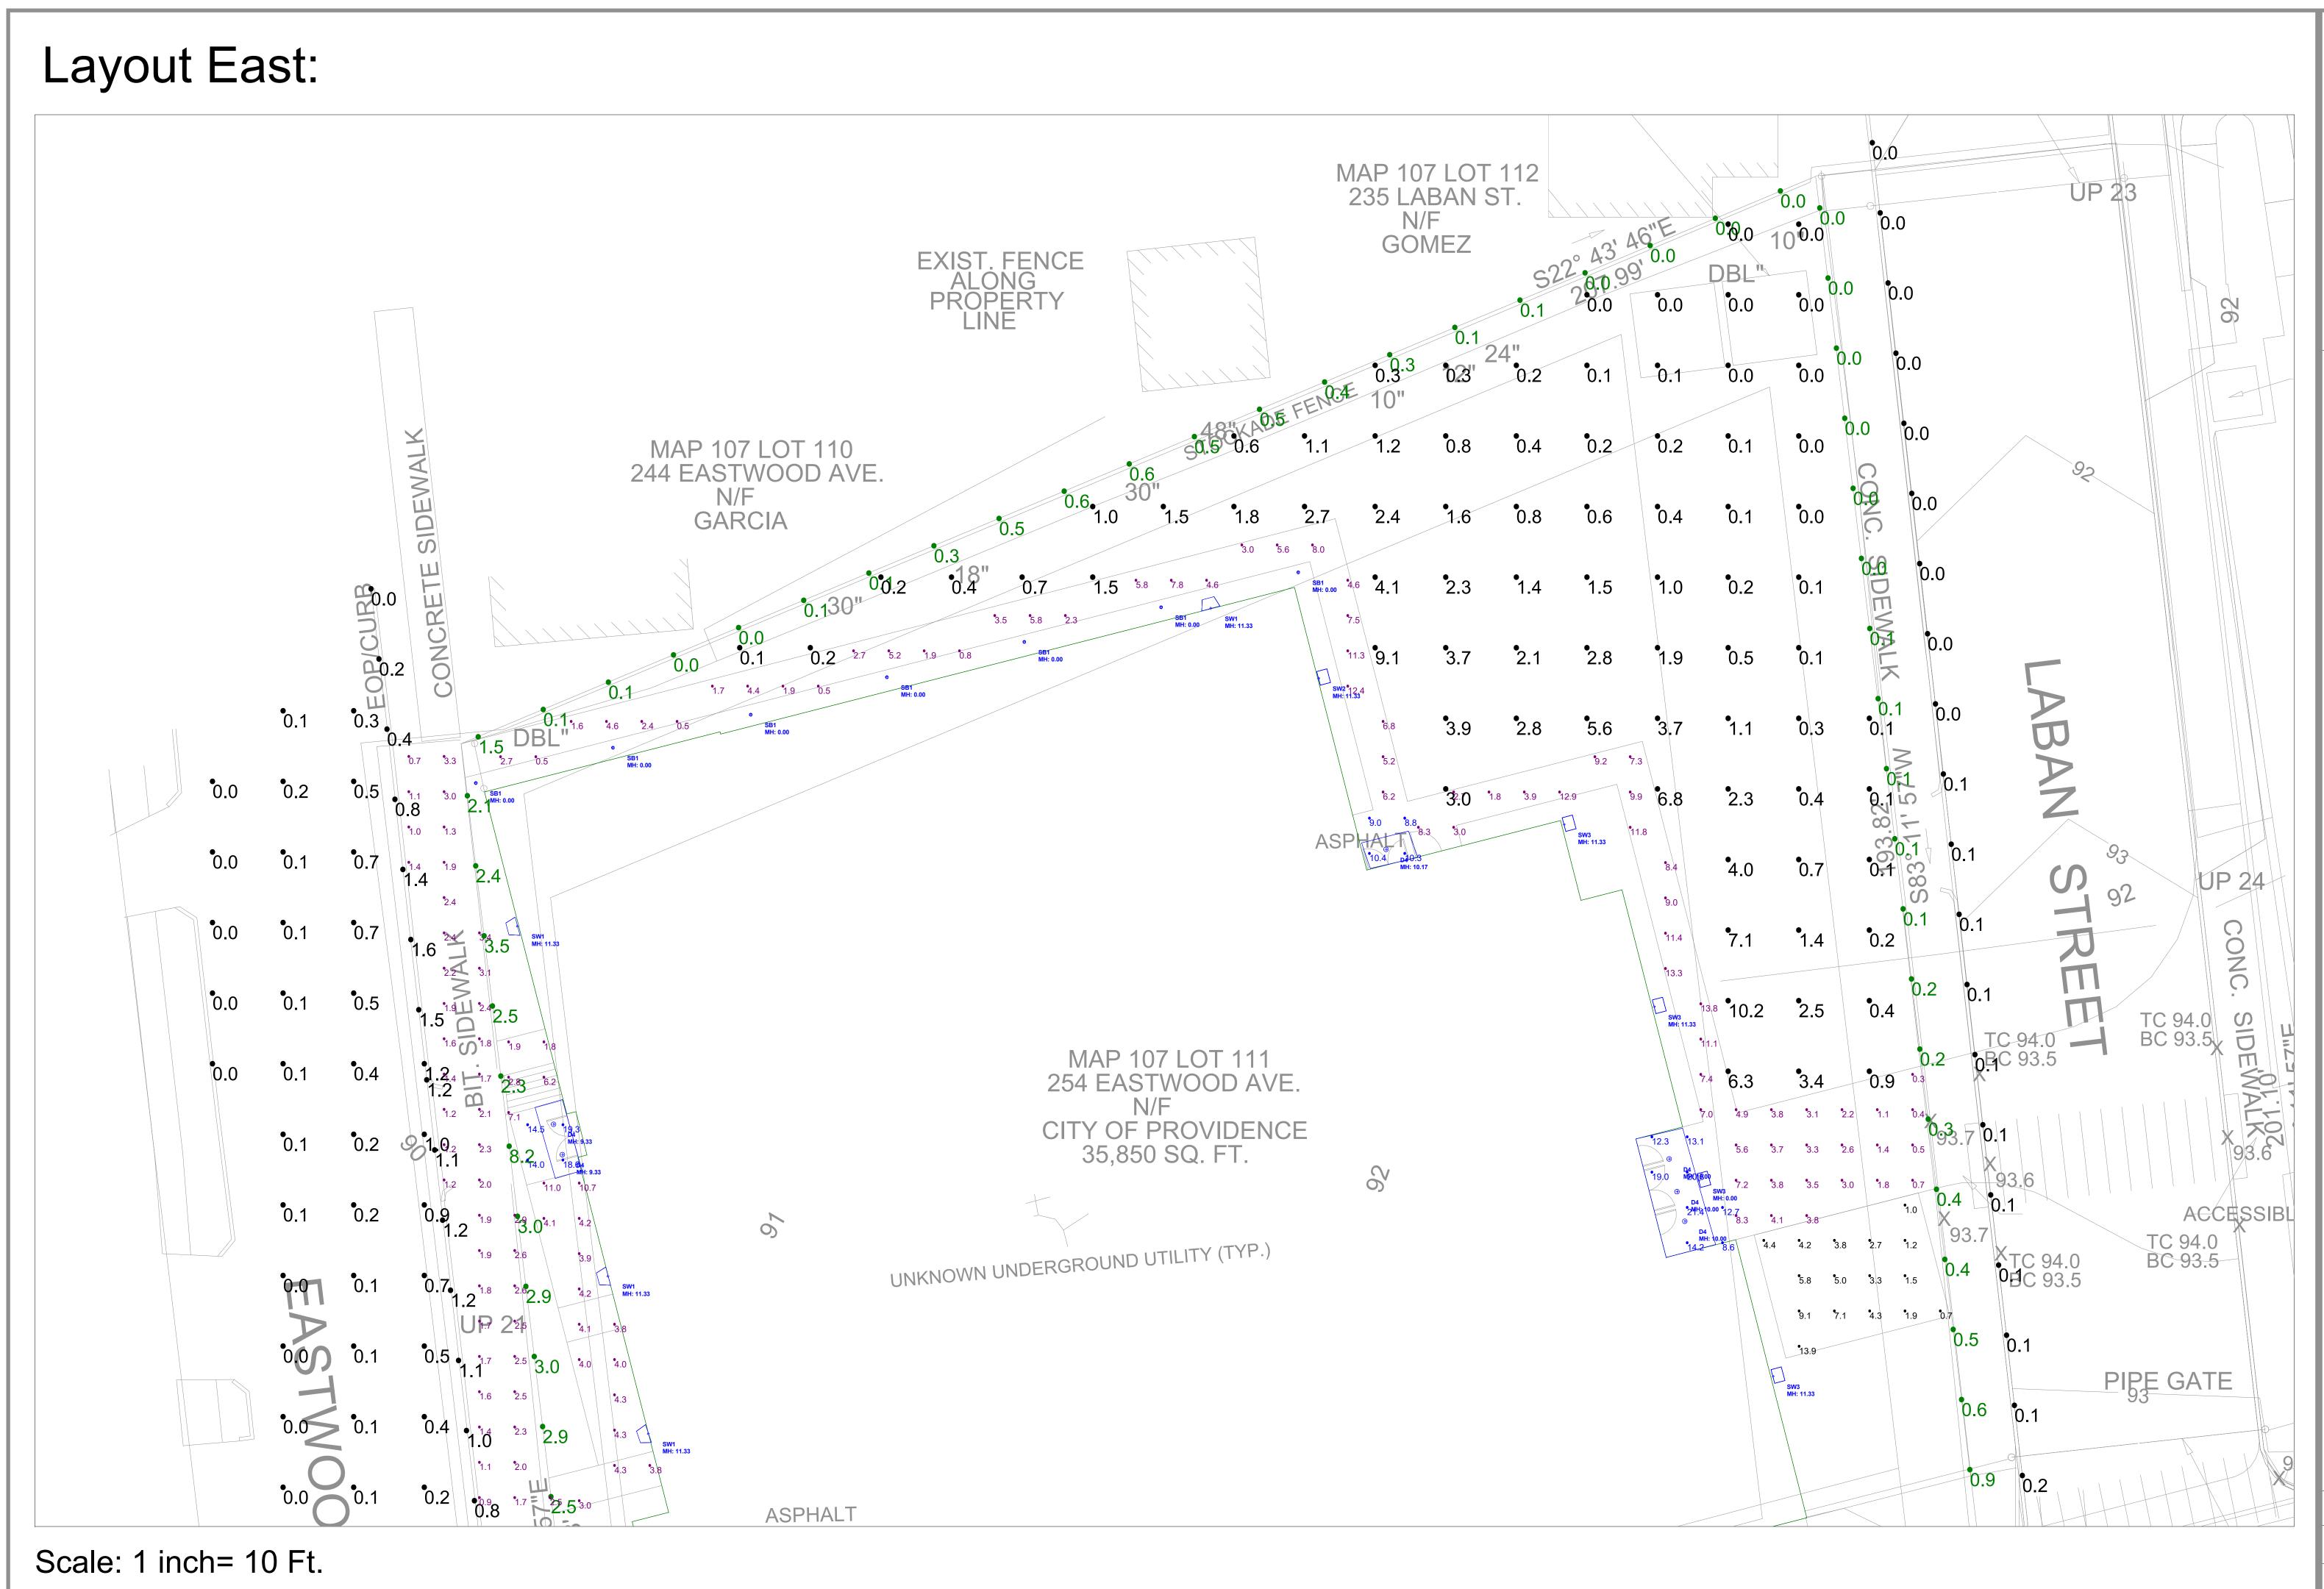
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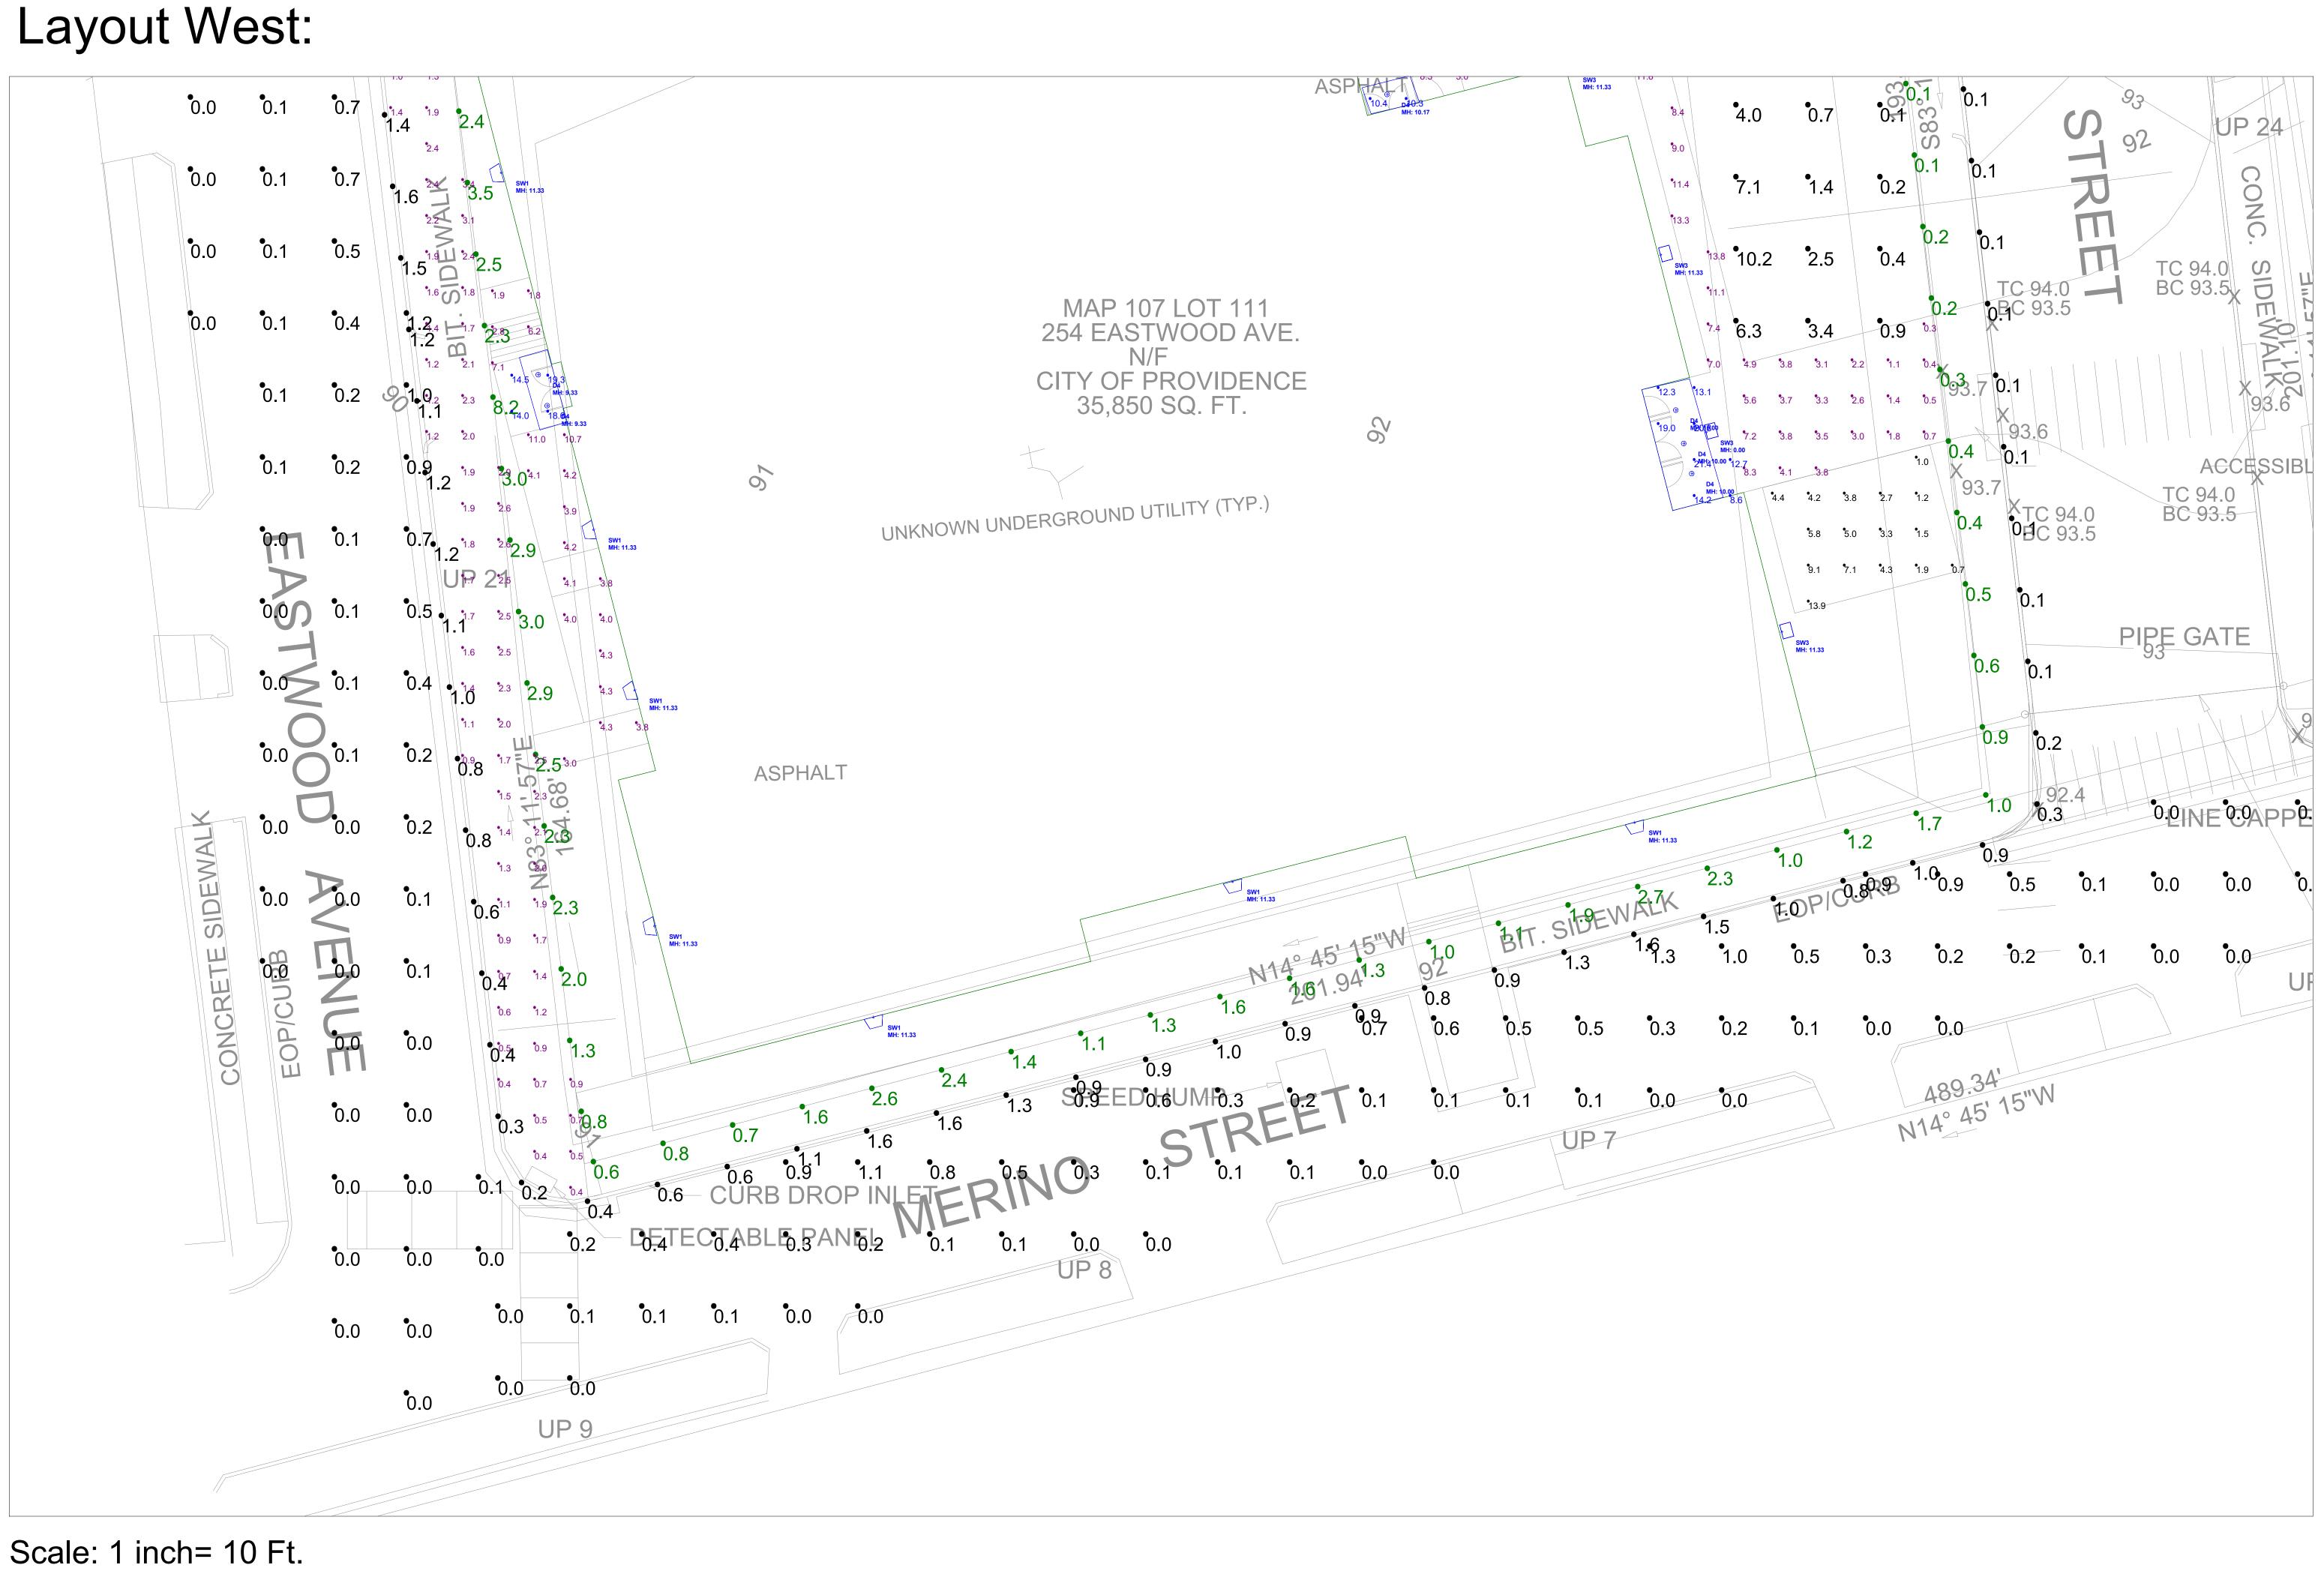
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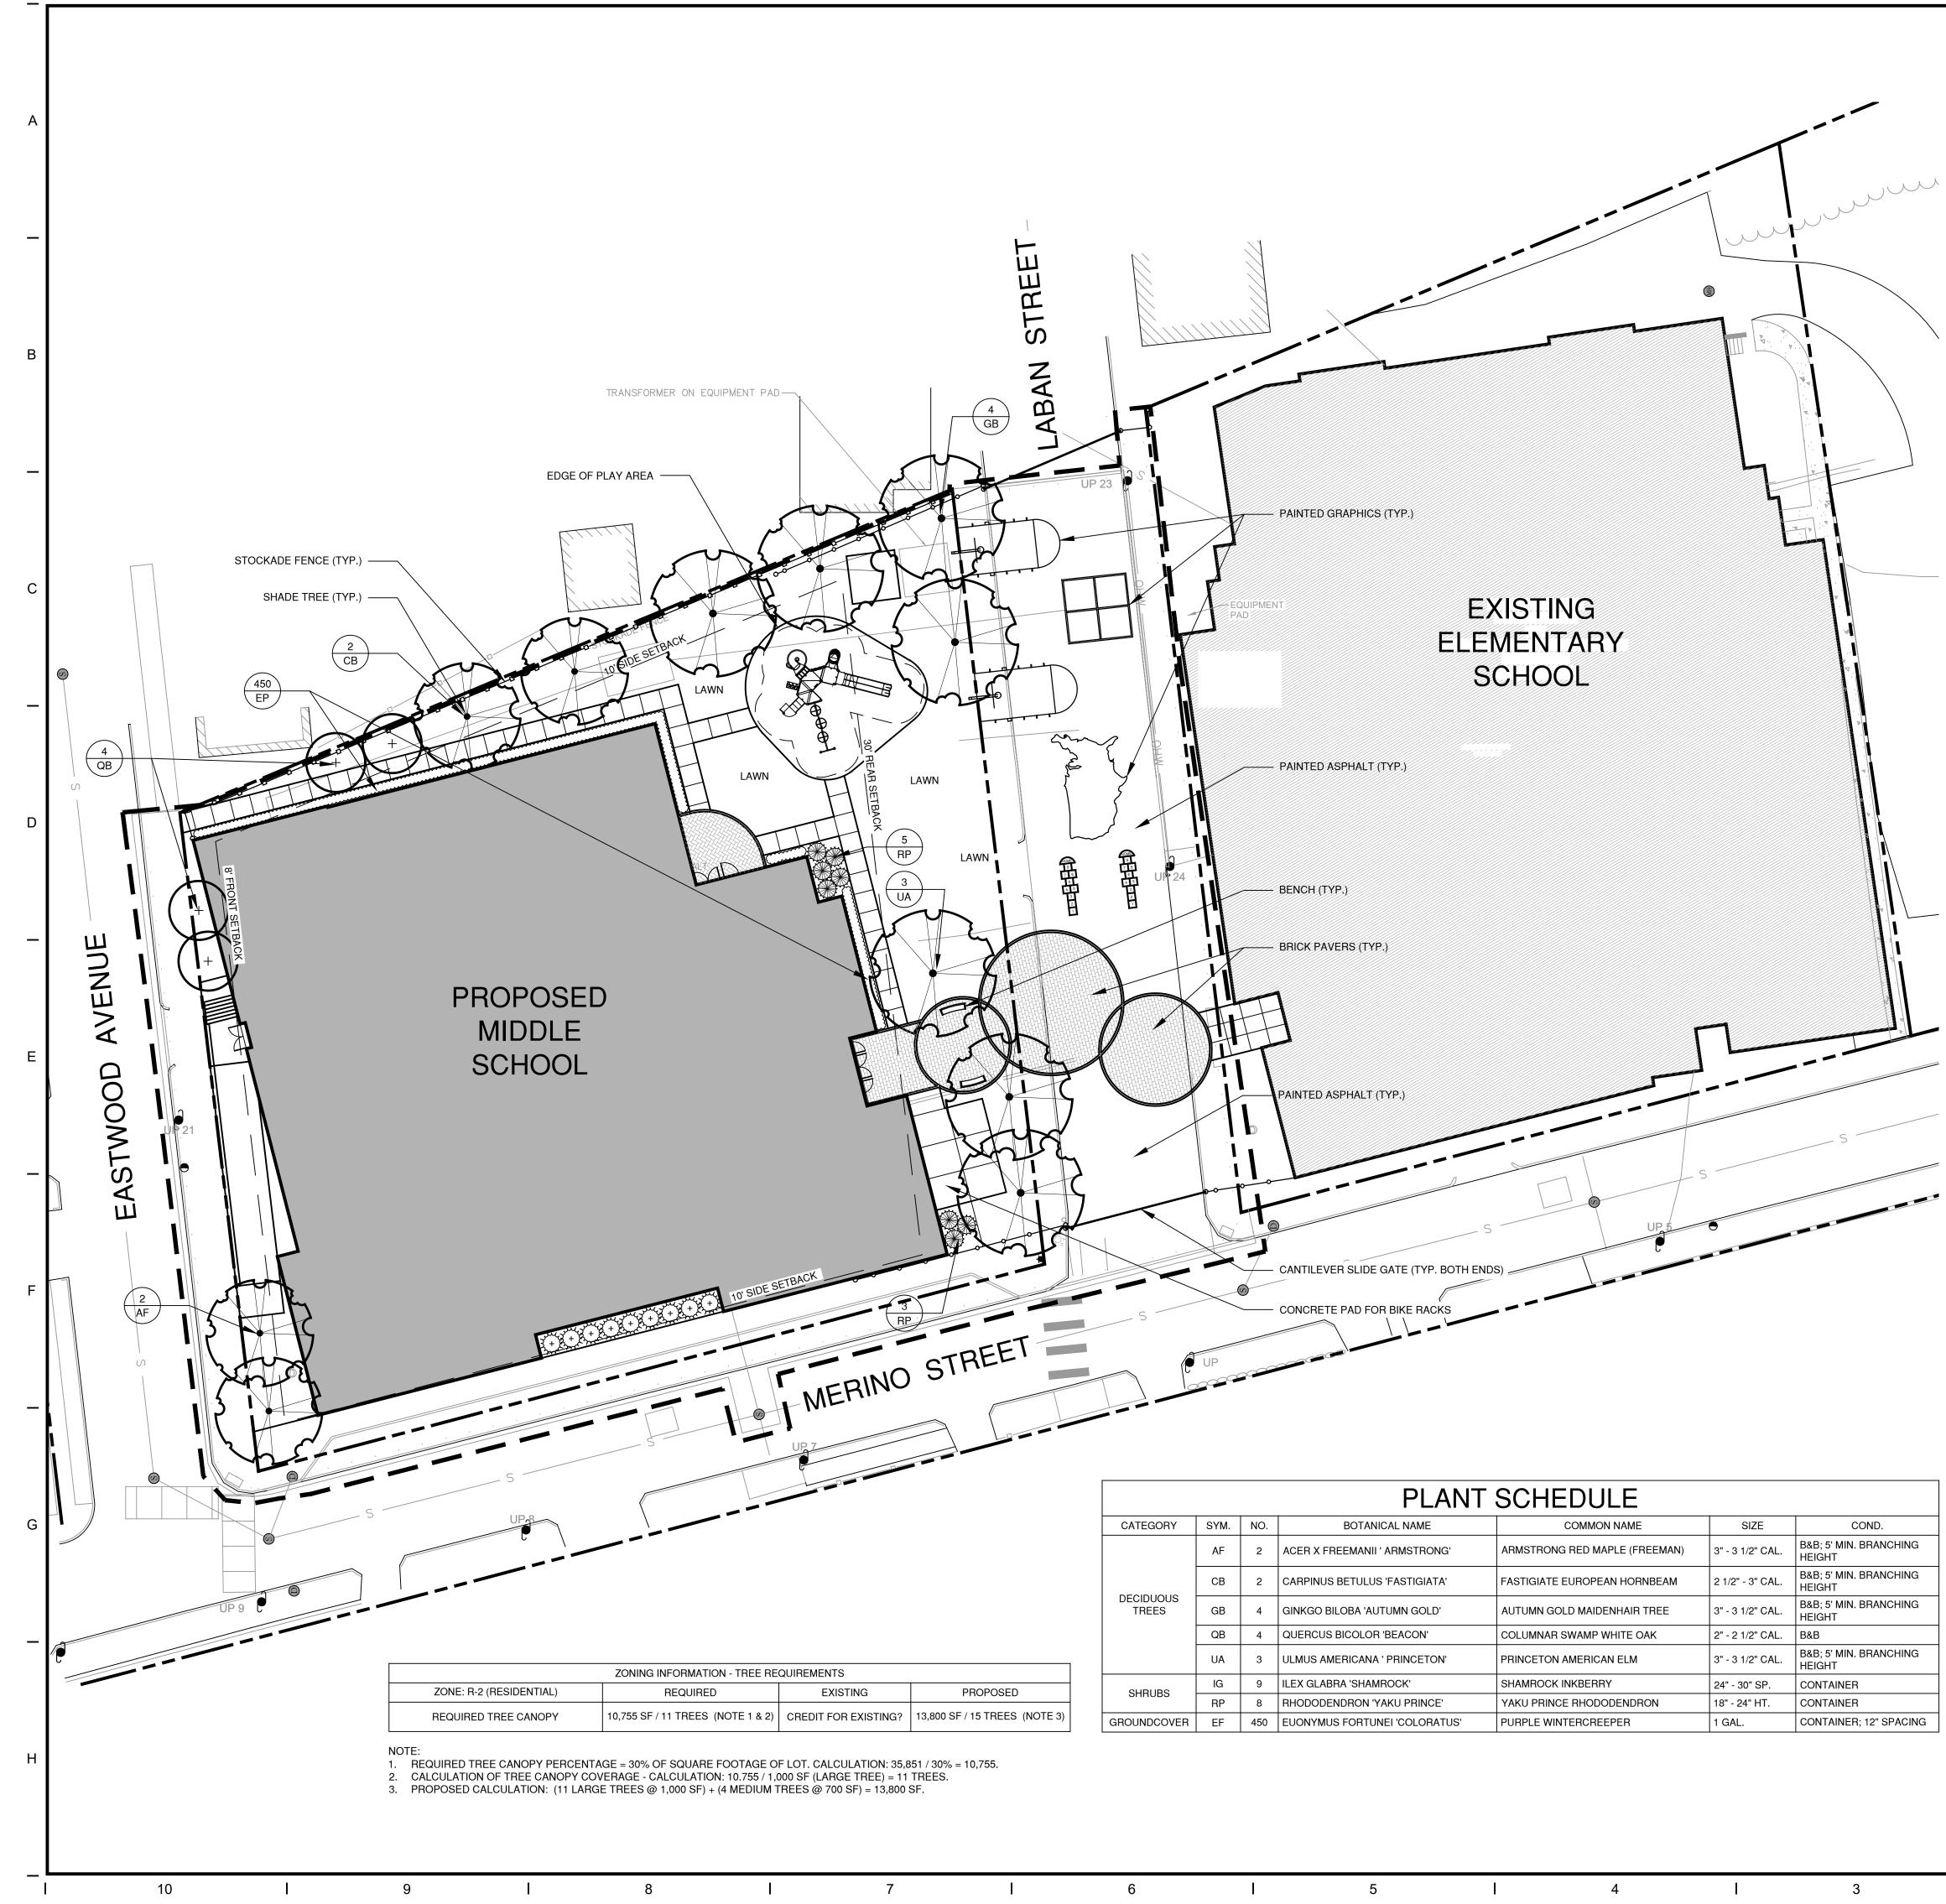
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CATEGORY	SYM.	NO.	BOTANICAL NAME	COMMON NAME	SIZE	COND.
	AF	2	ACER X FREEMANII ' ARMSTRONG'	ARMSTRONG RED MAPLE (FREEMAN)	3" - 3 1/2" CAL.	B&B 5' MIN. BRANCHING HEIGHT
	СВ	2	CARPINUS BETULUS 'FASTIGIATA'	FASTIGIATE EUROPEAN HORNBEAM	2 1/2" - 3" CAL.	B&B 5' MIN. BRANCHING HEIGHT
DECIDUOUS TREES	GB	4	GINKGO BILOBA 'AUTUMN GOLD'	AUTUMN GOLD MAIDENHAIR TREE	3" - 3 1/2" CAL.	B&B 5' MIN. BRANCHING HEIGHT
	QB	4	QUERCUS BICOLOR 'BEACON'	COLUMNAR SWAMP WHITE OAK	2" - 2 1/2" CAL.	B&B
	UA	3	ULMUS AMERICANA ' PRINCETON'	PRINCETON AMERICAN ELM	3" - 3 1/2" CAL.	B&B 5' MIN. BRANCHING HEIGHT
SHRUBS	IG	9	ILEX GLABRA 'SHAMROCK'	SHAMROCK INKBERRY	24" - 30" SP.	CONTAINER
SUUDS	RP	8	RHODODENDRON 'YAKU PRINCE'	YAKU PRINCE RHODODENDRON	18" - 24" HT.	CONTAINER
GROUNDCOVER	EF	450	EUONYMUS FORTUNEI 'COLORATUS'	PURPLE WINTERCREEPER	1 GAL.	CONTAINER; 12" SPACIN

PLANTING NOTES

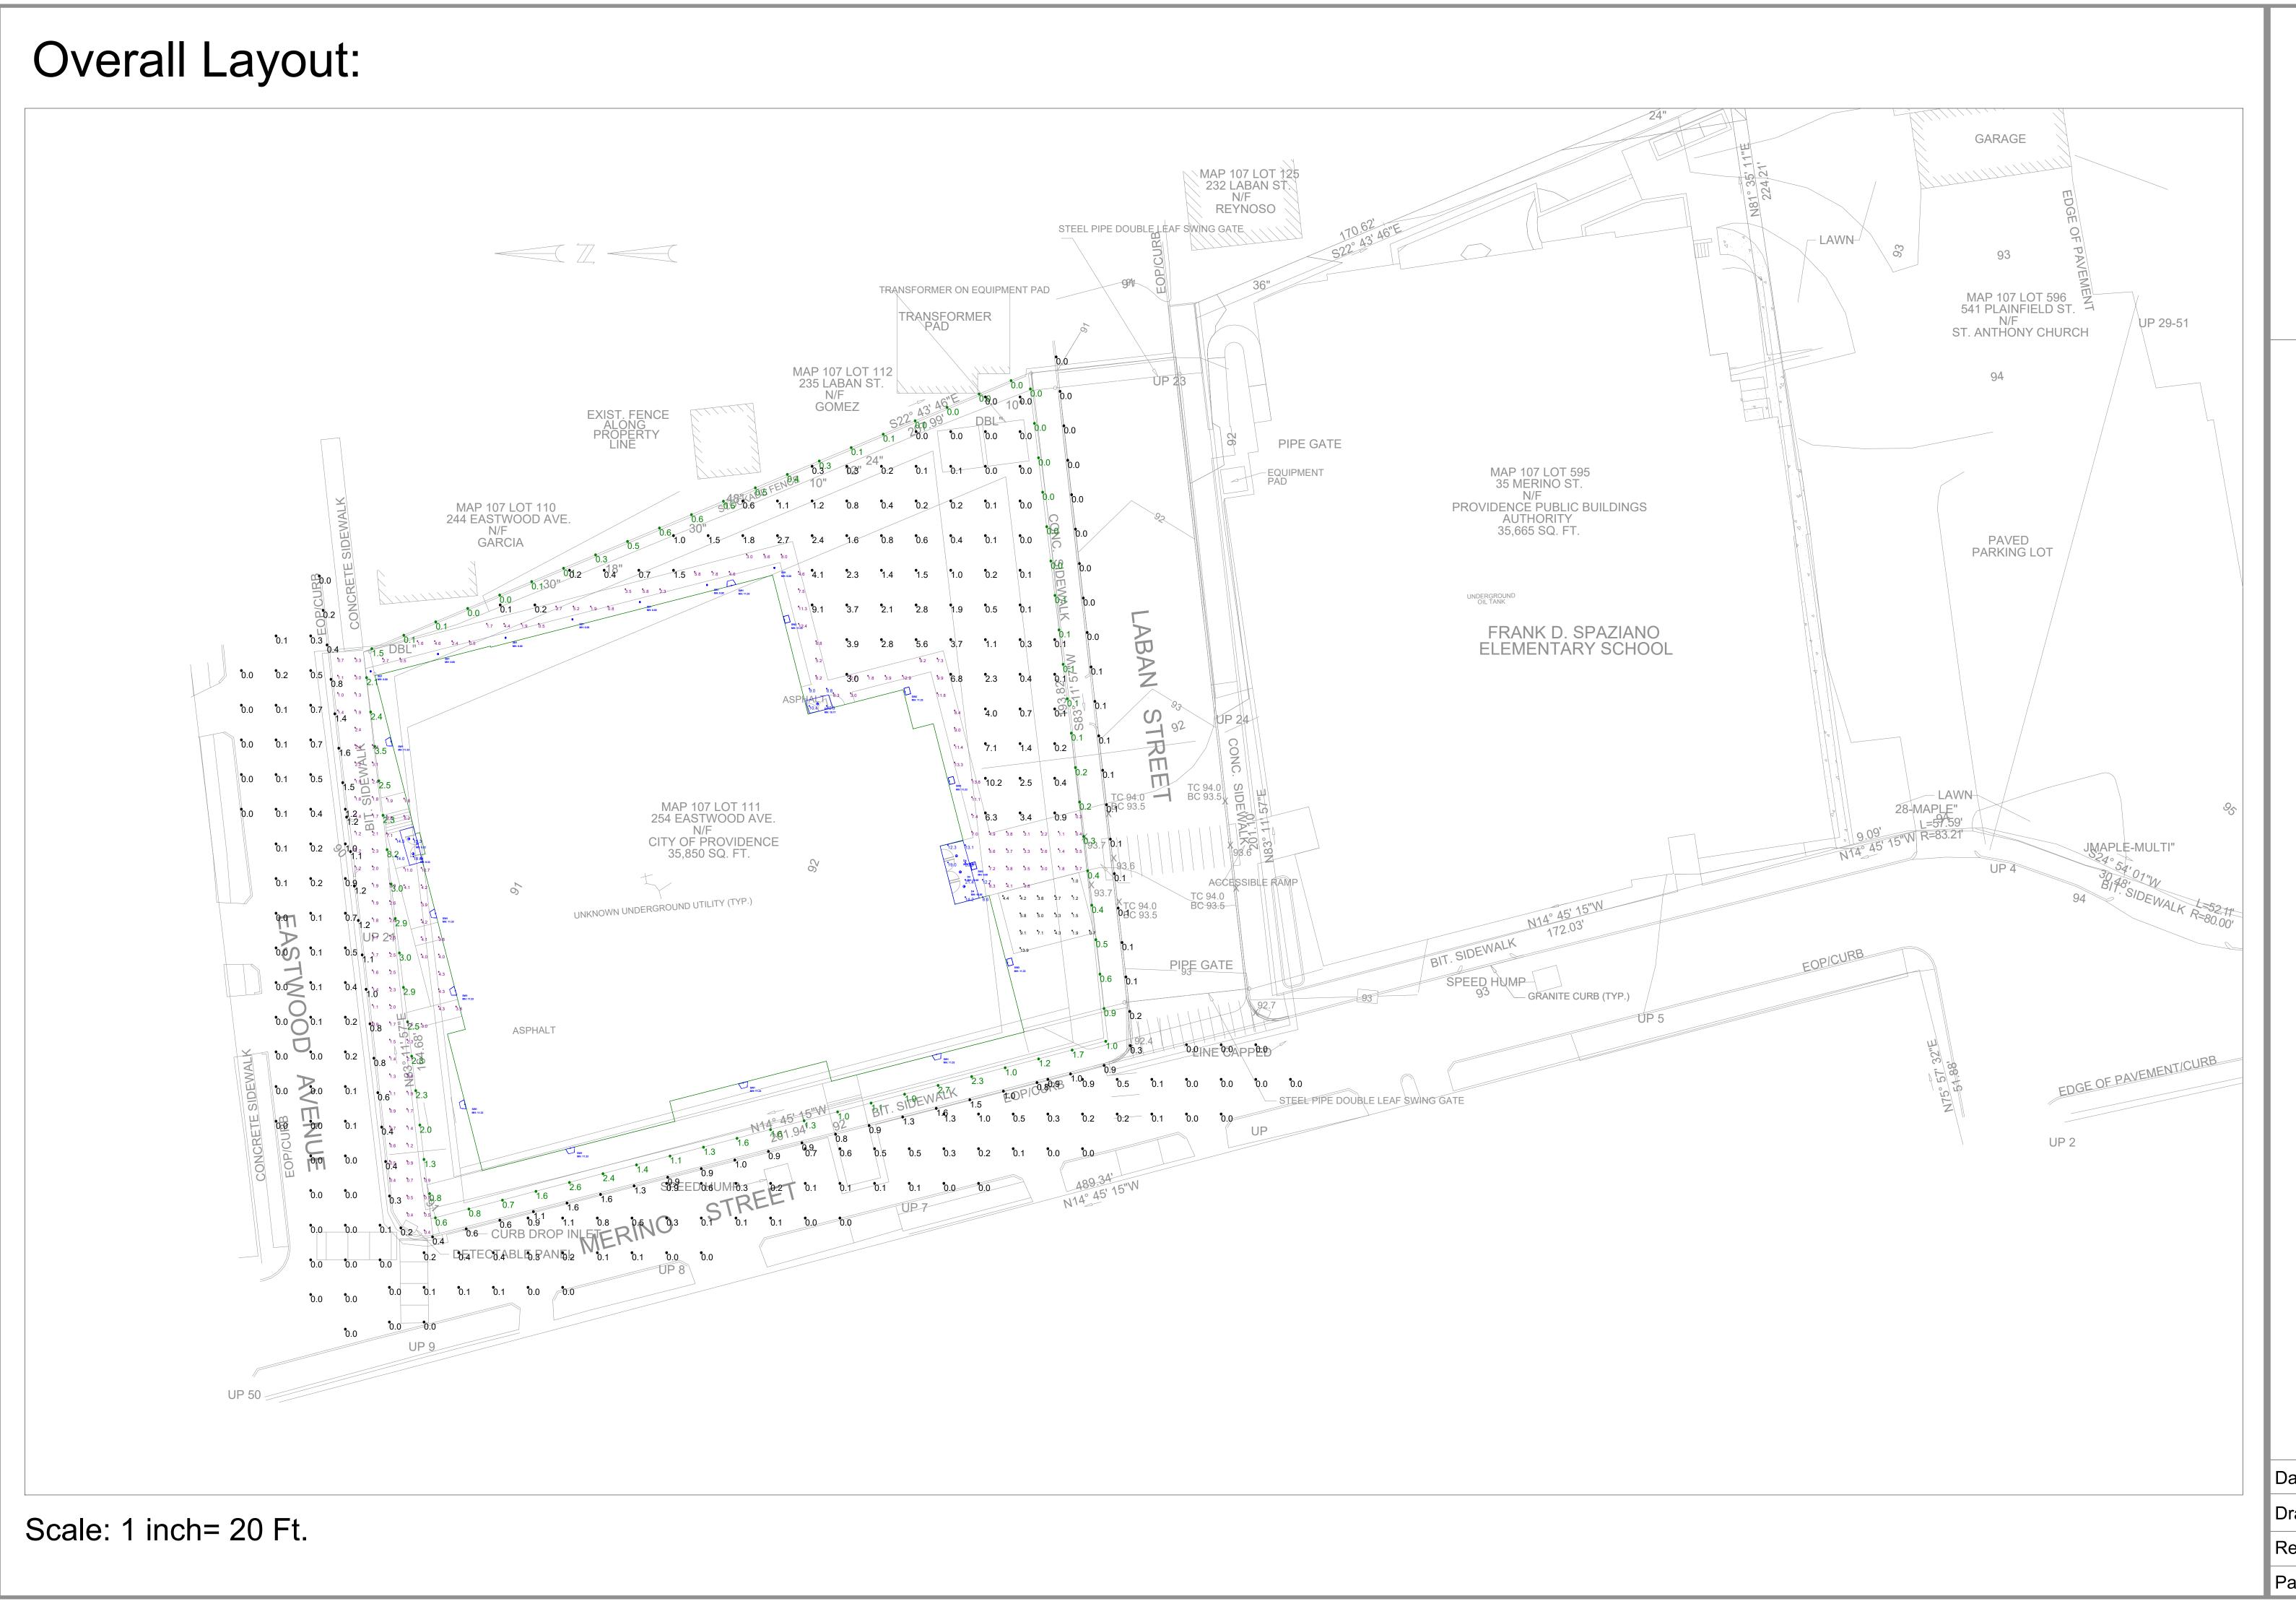- 1. ALL PLANTING MATERIAL TO BE NURSERY GROWN STOCK SUBJECT TO APPLICABLE A.A.N. STANDARDS.
- 2. THE CONTRACTOR SHALL SUPPLY ALL PLANTS IN QUANTITIES SUFFICIENT TO COMPLETE THE WORK SHOWN ON THE DRAWINGS AND LISTED IN THE PLANT LIST. IN THE EVENT OF A DISCREPANCY BETWEEN QUANTITIES SHOWN IN THE PLANT LIST AND THOSE REQUIRED BY THE DRAWINGS, THE LARGER NUMBER SHALL APPLY.
- ALL PLANTS SHALL BE APPROVED BY THE LANDSCAPE ARCHITECT PRIOR TO INSTALLATION AND SHALL BE LOCATED AT THE GROWING SITE BY THE CONTRACTOR, FOR THE APPROVAL OF THE LANDSCAPE ARCHITECT. ANY INSTALLATIONS WHICH WERE NOT APPROVED BY THE LANDSCAPE ARCHITECT AND WHICH ARE SUBSEQUENTLY REQUESTED TO BE REMOVED. WILL BE DONE AT THE CONTRACTORS EXPENSE
- 4. PRECISE LOCATION OF ITEMS NOT DIMENSIONED ON THE PLAN ARE TO BE FIELD STAKED BY THE CONTRACTOR AND SHALL BE SUBJECT TO THE REQUIREMENTS SPECIFIED IN THE PREVIOUS NOTE.
- 5. ALL SHRUB AND TREE PITS SHALL BE MULCHED TO A DEPTH OF 3" WITH SHREDDED PINE BARK MULCH.
- 6. THE CONTRACTOR IS RESPONSIBLE FOR ANY DAMAGED VEGETATION AND SHALL REPLACE OR REPAIR ANY DAMAGE, AT HIS OWN EXPENSE.
- 7. ALL SHRUB AND GROUND COVER PLANTING AREAS SHALL HAVE CONTINUOUS BEDS OF TOPSOIL, 18" DEEP.
- 8. THE CONTRACTOR IS RESPONSIBLE FOR LOCATING ALL UTILITIES IN THE FIELD. WHERE PLANT MATERIAL MAY INTERFERE WITH UTILITIES, THE CONTRACTOR SHALL NOTIFY THE LANDSCAPE ARCHITECT TO COORDINATE THEIR INSTALLATION.
- 9. PLANTINGS INSTALLED IN THE DRY SUMMER MONTHS AND/OR LAWN SEEDED OUT OF SPRING OR FALL PERIODS, IF ALLOWED BY OWNER, WILL REQUIRE AGGRESSIVE IRRIGATION PROGRAMS AT THE CONTRACTOR'S EXPENSE, UNLESS OTHERWISE DIRECTED BY THE OWNER.
- 10. SUBSTITUTIONS PERMITTED ONLY UPON WRITTEN APPROVAL OF THE OWNER'S REPRESENTATIVE.
- 11. PLANT TAGS TO REMAIN ON ALL PLANT MATERIAL UNTIL FINAL ACCEPTANCE. CONTRACTOR TO THEN REMOVE ALL PLANT TAGS.
- 12. WHERE A SIZE RANGE IS GIVEN IN THE PLANT SCHEDULE, AT LEAST 50% OF THE PLANTS PROVIDED SHALL BE OF THE LARGER SIZE.
- 13. CONTRACTOR TO GUARANTEE ALL PLANT MATERIAL FOR ONE YEAR AFTER DATE OF FINAL ACCEPTANCE. 14. CONTRACTOR TO MAINTAIN ALL PLANT MATERIAL UNTIL 60 DAYS AFTER FINAL ACCEPTANCE
- UNLESS NOTED OTHERWISE IN SPECS. 15. TOPSOIL AND SEED ALL AREAS DISTURBED BY CONSTRUCTION ACTIVITIES AND NOT
- COVERED BY OTHER SITE IMPROVEMENTS.

PROPERTY LINE

SETBACK LINE

EDGE OF PAVEMENT

BUILDING

PAVERS



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ENGAGE DESIGN ADVANCE

Client/ Contractor

PROVIDENCE PUBLIC SCHOOLS

797 WESTMINSTER STREET PROVIDENCE, RI 02903

Project

Seals

SPAZIANO MIDDLE SCHOOL

254 EASTWOOD AVENUE PROVIDENCE, RI 02909

PROGRESS SET

NOT FOR CONSTRUCTION


LARGE DECIDUOUS TREE

MEDIUM DECIDUOUS TREE

GROUNDCOVER

LAWN

LIMIT OF DISTURBANCE

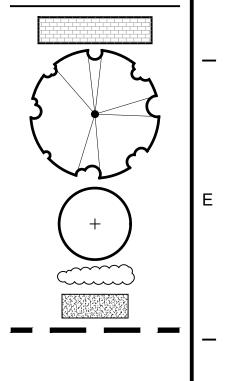

PROPOSED

SEEDING

LEGEND

EXISTING

FERTILIZE ACCORDING TO SOIL TEST OR AT THE RATE OF 1000 LBS. PER ACRE WITH 10-10-10 FERTILIZER. 40% OF THE NITROGEN TO BE A SLOW RELEASE FORM. LIME TO A PH OF 6.5 AT A RATE OF 100 LBS. PER 1000 SF.

HART'S WEAR 'N TEAR MIX (1-860-529-2537) 35% KENTUCKY BLUEGRASS 35% CREEPING RED FESCUE 20% METOLIUS PERENNIAL RYEGRASS


10% DESCHUTES PERENNIAL RYEGRASS

ALL PLANTING BEDS SHALL BE A CONTINUOUS PIT AS FOLLOWS: PERENNIALS - 12" DEPTH Α

2


B. SHRUBS - 18" DEPTH

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Issues / Revisions

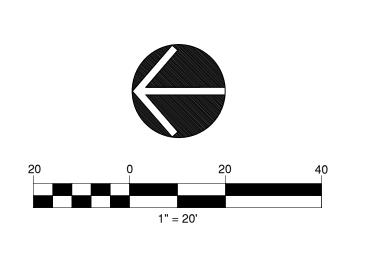

Planting Plan

Project Manager:	PB	Project No:	41037 (P2057)
Drawn by:	AL/MD	Scale:	AS NOTED
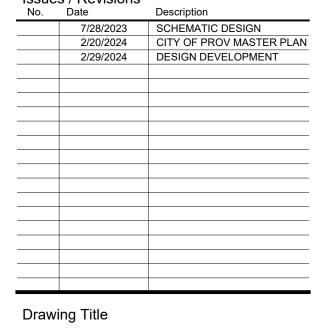
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Drawing Number