



WSP USA
166 VALLEY STREET, BUILDING 5
PROVIDENCE RHODE ISLAND, 02909
WWW.WSP.COM
(401) 415-9442



SITE IMPROVEMENTS AT INDIA POINT PARK

109 INDIA STREET

PLATS 17, AND 18 LOTS 541, 620, 621, 613, AND 14, 334, 338, 72
PROVIDENCE, RHODE ISLAND 02903

ISSUED FOR BID

CLIENT:

PROVIDENCE PARKS

HONORABLE MAYOR BRETT P. SMILEY

SUPERINTENDENT WENDY NILSSON

COUNCILMAN JOHN GONCALVES

LATEST ISSUED: MARCH 25, 2024



SITE

SITE LOCATION
SCALE: 1"=500'



OVERALL SITE PLAN


SCALE: 1"=250'



INDEX TO SHEETS

		LATEST ISSUE
C-1	COVER	3/25/2024
C-2	LEGEND & NOTES	3/25/2024
C-3	PARTIAL SITE PLAN	3/25/2024
C-4	GRADING PLAN 1	3/25/2024
C-5	GRADING PLAN 2	3/25/2024
L1.0	SITE PREPARATION PLAN	3/25/2024
L1.1	SITE PREPARATION PLAN & DETAILS	3/25/2024
L1.2	SITE PREPARATION PLAN	3/25/2024
L1.3	SITE PREPARATION PLAN	3/25/2024
L2.0	LANDSCAPE LAYOUT & MATERIALS PLAN	3/25/2024
L2.1	LANDSCAPE LAYOUT & MATERIALS PLAN	3/25/2024
L2.2	LANDSCAPE LAYOUT & MATERIALS PLAN & DETAILS	3/25/2024
L2.3	LANDSCAPE LAYOUT & MATERIALS PLAN	3/25/2024
L2.4	LANDSCAPE LAYOUT & MATERIALS PLAN & DETAILS	3/25/2024
L2.5	LANDSCAPE LAYOUT & MATERIALS PLAN	3/25/2024
L3.0	LANDSCAPE NOTES	3/25/2024
L3.1	LANDSCAPE DETAILS	3/25/2024
L3.2	LANDSCAPE DETAILS	3/25/2024
L3.3	LANDSCAPE DETAILS	3/25/2024
L3.4	LANDSCAPE DETAILS	3/25/2024

SEAL:

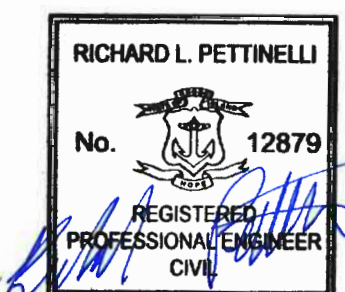

REVISION	DATE	DESCRIPTION

CLIENT:

PROVIDENCE PARKS DEPARTMENT
1000 ELMWOOD AVENUE
PROVIDENCE, RI 02907

PROJECT:

SITE IMPROVEMENTS AT INDIA POINT PARK

109 INDIA STREET
PROVIDENCE, RHODE ISLAND 02903

TITLE:

COVER

ISSUED FOR:	BID
DATE:	MARCH 25, 2024
SCALE:	N/A
DRAWN BY:	AJP
CHECKED BY:	RLP
PROJECT NO:	365220361

C-1

PROPERTY OWNERS			
PLAT - LOT	PROPERTY ADDRESS	PROPERTY OWNER NAME	MAILING ADDRESS
17-541	270 INDIA STREET, PROVIDENCE, RI 02903	CITY OF PROVIDENCE	CITY HALL, PROVIDENCE, RI 02903
17-620	263 INDIA STREET, PROVIDENCE, RI 02903	PROVIDENCE PUBLIC BUILDING AUTHORITY	400 RESERVOIR AVE PROVIDENCE, RI 02907
17-621	235 INDIA STREET, PROVIDENCE, RI 02903	CITY OF PROVIDENCE	CITY HALL, PROVIDENCE, RI 02903
17-613	225 INDIA STREET, PROVIDENCE, RI 02903	STATE OF RI DIVING	STATE OFFICE BUILDING, PROVIDENCE, RI 02903
18-14	203 INDIA STREET, PROVIDENCE, RI 02903	PROVIDENCE PUBLIC BUILDING AUTHORITY	400 RESERVOIR AVE PROVIDENCE, RI 02907
18-334	201 INDIA STREET, PROVIDENCE, RI 02903	STATE OF RI DIVING	STATE OFFICE BUILDING, PROVIDENCE, RI 02903
18-338	195 INDIA STREET, PROVIDENCE, RI 02903	PROVIDENCE PUBLIC BUILDING AUTHORITY	400 RESERVOIR AVE PROVIDENCE, RI 02907
18-72	109 INDIA STREET, PROVIDENCE, RI 02903	PROVIDENCE PUBLIC BUILDING AUTHORITY	400 RESERVOIR AVE PROVIDENCE, RI 02907

GENERAL CONSTRUCTION NOTES

- INFORMATION FOR THE EXISTING CONDITIONS PLAN WAS OBTAINED FROM GIS, AERIAL IMAGERY, FIELD OBSERVATION (AND XYZ SURVEY, IF APPLICABLE). ALL EXISTING CONDITIONS ARE TO BE CONSIDERED APPROXIMATE. THIS IS NOT A REGISTERED SURVEY.
- ANY ERRORS OR DISCREPANCIES ON THE DRAWINGS, SHOP DRAWINGS, AND DETAILS ARE TO BE BROUGHT TO THE ATTENTION OF THE OWNER'S REPRESENTATIVE BEFORE THE WORK HAS COMMENCED.
- THE CONTRACTOR IS RESPONSIBLE FOR FIELD VERIFICATION OF ALL LOCATIONS AND DIMENSIONS. DISCREPANCIES BETWEEN LAYOUT DIMENSIONS ON PLANS AND ACTUAL MEASUREMENTS IN FIELD ARE TO BE REPORTED TO THE OWNER'S REPRESENTATIVE BEFORE CONSTRUCTION BEGINS.
- THE CONTRACTOR SHALL NOTIFY THE OWNER'S REPRESENTATIVE PRIOR TO DEMOLITION OR INSTALLATION OF ANY PORTION OF THE SITE WORK.
- THE CONTRACTOR SHALL STAKE OUT ALL LAYOUTS OF PROPOSED WORK FOR APPROVAL BY THE OWNER'S REPRESENTATIVE PRIOR TO COMMENCING WORK.
- THE CONTRACTOR SHALL BE RESPONSIBLE FOR ESTABLISHING AND MAINTAINING ALL CONTROL POINTS AND BENCHMARKS DURING CONSTRUCTION INCLUDING BENCHMARK LOCATIONS AND ELEVATIONS AT CRITICAL AREAS. THE LOCATION OF ALL CONTROL POINTS AND BENCHMARKS SHALL BE COORDINATED WITH THE OWNER'S REPRESENTATIVE.
- UNLESS OTHERWISE SPECIFIED ON THE PLANS AND DETAILS/SPECIFICATIONS, ALL SITE CONSTRUCTION MATERIALS AND METHODOLOGIES ARE TO CONFORM TO THE MOST RECENT VERSION OF THE RHODE ISLAND DEPARTMENT OF TRANSPORTATION STANDARD SPECIFICATIONS (THE RHODE ISLAND DEPARTMENT OF TRANSPORTATION STANDARD SPECIFICATIONS FOR ROAD AND BRIDGE CONSTRUCTION FEBRUARY 2024 EDITION).
- CONSTRUCTION SHALL BE PERFORMED IN ACCORDANCE WITH APPLICABLE LAWS AND REGULATIONS REGARDING NOISE, VIBRATION, DUST, SEDIMENTATION CONTAINMENT, AND TRENCH WORK.
- THE CONTRACTOR SHALL RESTORE ALL SURFACES EQUAL TO THEIR ORIGINAL CONDITION AFTER CONSTRUCTION IS COMPLETE. AREAS NOT DISTURBED BY CONSTRUCTION SHALL BE LEFT NATURAL. THE CONTRACTOR SHALL TAKE CARE TO PREVENT DAMAGE TO SHRUBS, TREES, AND OTHER LANDSCAPING OR NATURAL FEATURES, WHEREAS THE PLANS DO NOT SHOW ALL LANDSCAPING FEATURES. EXISTING CONDITIONS MUST BE VERIFIED BY THE CONTRACTOR IN ADVANCE OF THE WORK.
- ALL UNPAVED AREAS DISTURBED BY THE WORK SHALL HAVE A MINIMUM OF 4-INCHES OF LOAM INSTALLED AND SEEDED WITH GRASS SEED AS SHOWN ON THE PLAN AND/OR DIRECTED BY THE LANDSCAPE ARCHITECT. THE CONTRACTOR SHALL BE RESPONSIBLE FOR WATERING ANY LOAM AND SEEDED AREAS UNTIL LAWN GROWTH IS ESTABLISHED AND APPROVED BY THE LANDSCAPE ARCHITECT AND/OR OWNER'S REPRESENTATIVE.
- THE CONTRACTOR SHALL REGULARLY INSPECT THE PERIMETER OF THE PROPERTY TO CLEAN UP AND REMOVE ANY LOOSE CONSTRUCTION DEBRIS BEFORE IT LEAVES THE SITE. ALL DEMOLITION DEBRIS SHALL BE PROMPTLY REMOVED FROM THE SITE TO AN APPROVED DUMP SITE. ALL TRUCKS LEAVING THE SITE SHALL BE COVERED.
- CONCRETE TRUCKS SHALL NOT BE WASHED ONSITE. ANY CEMENT OR CONCRETE DEBRIS LEFT IN THE DISTURBED AREA SHALL BE REMOVED BY HAND AT THE CONTRACTOR'S EXPENSE.
- IF ANY DEVIATION OR ALTERATION OF THE WORK PROPOSED ON THESE DRAWINGS IS REQUIRED, THE CONTRACTOR IS TO IMMEDIATELY CONTACT AND COORDINATE WITH THE LANDSCAPE ARCHITECT AND THE OWNER'S REPRESENTATIVE.
- AT THE END OF CONSTRUCTION, THE CONTRACTOR SHALL REMOVE ALL CONSTRUCTION DEBRIS AND SURPLUS MATERIAL FROM THE SITE. A THOROUGH INSPECTION OF THE WORK PERIMETER IS TO BE MADE AND ALL DISCARDED MATERIALS, BLOWN OR WATER CARRIED DEBRIS, SHALL BE COLLECTED AND REMOVED FROM THE SITE.
- THE CONTRACTOR IS RESPONSIBLE FOR SECURING THE SITE FOR THE SAFETY OF THE GENERAL PUBLIC AND TO PROTECT PROPERTY AGAINST VANDALISM AND THEFT.
- THE CONTRACTOR MUST OBTAIN ALL REQUIRED CITY, STATE AND FEDERAL PERMITS.
- THE PROVIDENCE PARKS DEPARTMENT ASSUMES NO RESPONSIBILITY IF THE WORK IS NOT INSTALLED AS PER THE PLANS OR IF FIELD CHANGES ARE MADE WITHOUT THE KNOWLEDGE AND APPROVAL OF THE OWNER'S REPRESENTATIVE.

GENERAL UTILITY NOTES

- THE CONTRACTOR SHALL BE RESPONSIBLE FOR COORDINATING WITH ALL UTILITY COMPANIES AND WORK TRADES ASSOCIATED WITH THE WORK SHOWN ON THESE PLANS.
- THE CONTRACTOR SHALL KEEP ALL LOCAL AGENCIES INFORMED OF SCHEDULE AS NECESSARY.
- EXISTING UTILITIES ARE SHOWN IN THEIR APPROXIMATE LOCATION BASED ON BEST AVAILABLE INFORMATION. THE CONTRACTOR SHALL BE RESPONSIBLE TO VERIFY THE LOCATION, SIZE, MATERIAL(S), AND ELEVATION OF ALL EXISTING UTILITIES WITHIN THE LIMIT OF WORK PRIOR TO ORDERING OR INSTALLING THESE MATERIALS. THE CONTRACTOR SHALL NOTIFY THE ENGINEER IMMEDIATELY OF ANY DISCREPANCIES OR UTILITY CONFLICTS PRIOR TO CONSTRUCTION.
- WHERE AN EXISTING UTILITY IS FOUND TO BE IN CONFLICT WITH THE PROPOSED WORK, OR WHERE EXISTING CONDITIONS DIFFER FROM THE INFORMATION SHOWN ON THESE PLANS, SUCH THAT THE WORK CAN NOT BE COMPLETED AS INTENDED, THE CONTRACTOR SHALL IMMEDIATELY IDENTIFY AND PROVIDE THE ENGINEER WITH THE LOCATION, ELEVATION, AND SIZE OF THE UTILITY IN CONFLICT. THE CONTRACTOR SHALL NOT CONTINUE WORK IN THIS AREA UNTIL THE APPROPRIATE REMEDIAL ACTION IS AGREED UPON BY THE OWNER AND ENGINEER.
- THE CONTRACTOR SHALL ASSUME RESPONSIBILITY FOR ANY DAMAGE TO OVERHEAD AND/OR UNDERGROUND UTILITIES, WHETHER OR NOT SHOWN ON THESE PLANS THROUGHOUT WORK ON THIS PROJECT.
- ALL STRUCTURES UNDER PAVED AREAS SHALL BE DESIGNED TO MEET HS-20 TRUCK LOAD.

LAYOUT AND MATERIALS NOTES

- THE CONTRACTOR SHALL NOT RELY SOLELY ON ELECTRONIC VERSIONS OF PLANS, SPECIFICATIONS, AND DATA FILES THAT ARE OBTAINED FROM THE DESIGNERS, BUT SHALL VERIFY LOCATION OF PROJECT FEATURES IN ACCORDANCE WITH PAPER COPIES OF THE PLANS AND SPECIFICATIONS THAT ARE SUPPLIED AS PART OF THE CONTRACT DOCUMENTS.
- SYMBOLS AND LEGENDS OF PROJECT FEATURES ARE GRAPHIC REPRESENTATIONS AND ARE NOT NECESSARILY SCALED TO THE ACTUAL DIMENSIONS OR LOCATIONS ON THE DRAWINGS. THE CONTRACTOR SHALL REFER TO THE DETAIL SHEET DIMENSIONS, MANUFACTURERS' LITERATURE, SHOP DRAWINGS AND FIELD MEASUREMENTS OF SUPPLIED PRODUCTS FOR LAYOUT OF THE PROJECT FEATURES.
- DIMENSIONS ARE TO/FROM FACE OF CURB, FACE OF BUILDING, FACE OF WALL, AND CENTER LINE OF PAVEMENT MARKINGS, UNLESS OTHERWISE NOTED ON THESE PLANS.
- PROPOSED BOUNDS AND ANY OTHER EXISTING PROPERTY LINE MONUMENTATION DISTURBED DURING CONSTRUCTION SHALL BE SET OR RESET BY A PROFESSIONAL LICENSED SURVEYOR.
- THE CONTRACTOR SHALL PROVIDE TEMPORARY BITUMINOUS PATCH FOR ANY TRENCH WORK WITHIN PAVEMENT OR SIDEWALK AREAS IN PUBLIC RIGHTS-OF-WAY UNTIL PERMANENT PATCHING IS INSTALLED.

DEMOLITION NOTES

- WITHIN THE LIMIT OF WORK/DISTURBANCE, THE CONTRACTOR SHALL CLEAR AND GRUB ALL EXISTING VEGETATION AND STOCKPILE AND SCREEN TOPSOIL FOR RE-USE IN LANDSCAPE AREAS. THE CONTRACTOR SHALL ALSO REMOVE AND DISPOSE OF ALL EXISTING MANMADE FEATURES, INCLUDING BUT NOT LIMITED TO BUILDINGS, STRUCTURES, PAVEMENTS, SLABS, CURBING, WALLS, FENCES, UTILITIES (BOTH OVERHEAD AND UNDERGROUND), SIGNS, ETC., EXCEPT AS OTHERWISE NOTED ON THESE PLANS. THE EXISTING SOIL CAP SHALL NOT BE DISTURBED UNLESS OTHERWISE INDICATED ON THESE PLANS.
- THE CONTRACTOR SHALL DISPOSE OF ALL MATERIALS OFF-SITE IN ACCORDANCE WITH FEDERAL, STATE, AND LOCAL REGULATIONS.
- THE EXTENT OF DEMOLITION DEPICTED ON THESE PLANS IS INTENDED TO AID THE CONTRACTOR IN BIDDING THE PROJECT AND IS NOT NECESSARILY INTENDED TO DEPICT EACH AND EVERY ELEMENT OF DEMOLITION. THE CONTRACTOR SHALL BE RESPONSIBLE FOR DETERMINING THE FULL EXTENTS OF THE DEMOLITION WORK PRIOR TO CONTRACT AWARD AND SHALL NOT BE COMPENSATED FOR UNFORESEEN CONDITIONS ONCE THE WORK HAS COMMENCED.
- UNLESS OTHERWISE SPECIFICALLY PROVIDED ON THESE PLANS, THE ENGINEER HAS NOT PREPARED PLANS FOR THE DISCOVERY, REMOVAL, ABATEMENT, OR DISPOSAL OF ANY HAZARDOUS OR TOXIC MATERIALS FOUND DURING CONSTRUCTION.

EXISTING CONDITIONS

EXISTING CONDITIONS ARE FROM THE FOLLOWING SOURCES:

- FIELD SURVEY BY WSP INC. TOPOGRAPHIC SURVEY PLAN, ASSESSORS PLAT 49, LOT 363, ELMWOOD AVENUE & MELROSE STREET, PROVIDENCE, RHODE ISLAND. DATED 07/31/2023.

EROSION CONTROLS/CONSTRUCTION SEQUENCING

- THE CONTRACTOR SHALL INSTALL ALL EROSION AND SEDIMENTATION (E&S) CONTROL MEASURES SHOWN ON THE PLAN SET IN ACCORDANCE WITH THE PLANS AND THE MOST RECENT EDITION OF THE "RHODE ISLAND SOIL EROSION AND SEDIMENT CONTROL HANDBOOK."
- THE CONTRACTOR SHALL BE RESPONSIBLE TO MAINTAIN AND/OR UPGRADE THESE MEASURES, AS NECESSARY, THROUGHOUT CONSTRUCTION, TO PREVENT MIGRATION OF SEDIMENTS BEYOND THE LIMIT OF DISTURBANCE.
- EROSION CONTROL DEVICES:
 - AT LEAST ONE STABILIZED CONSTRUCTION ENTRANCE/EXIT SHALL BE INSTALLED FOR ACCESS TO THE PROJECT BY CONSTRUCTION VEHICLES. THE CONSTRUCTION ENTRANCE/EXIT SHALL BE INSTALLED BEFORE CONSTRUCTION VEHICLES ARE ALLOWED TO ENTER THE CONSTRUCTION SITE. A WASH OUT PAD MAY ALSO BE INSTALLED TO WASH CONSTRUCTION VEHICLES EXITING THE SITE.
 - ROADS ADJACENT TO THE CONSTRUCTION SITE SHALL BE CLEAN AT THE END OF EACH WORK DAY.
 - STRAW WATTLE AND SILT SACKS SHALL BE INSTALLED AT ALL DOWN-GRADIENT CATCH BASINS WITHIN THE LIMIT OF WORK TO CONTROL EROSION AND SEDIMENTATION AND TO PROTECT OFF-SITE AREAS. THESE DEVICES SHALL BE INSTALLED AS SHOWN ON THE E&S CONTROL PLAN PRIOR TO INITIATION OF MAJOR SITE WORK ACTIVITIES AND SHALL BE MAINTAINED/REPAIRED UNTIL FINAL STABILIZATION OF ALL DISTURBED AREAS.
 - SILT FENCE SHALL BE INSTALLED AROUND ALL EARTH STOCKPILES. STOCKPILES SHALL BE STABILIZED WITH TEMPORARY SEED ACCORDING TO NOTE 11 BELOW. IF TEMPORARY SEED IS NOT FEASIBLE OR NOT PRACTICAL, STOCKPILES SHALL BE COVERED WITH POLYETHYLENE SHEETING OR SIMILAR PRODUCT AT THE END OF EACH DAY TO MINIMIZE DUST.
 - ALL OTHER EROSION CONTROL DEVICES SHOWN ON THESE PLANS SHALL BE IN ACCORDANCE WITH "RHODE ISLAND STORMWATER DESIGN AND INSTALLATION STANDARDS MANUAL" AND THE "RHODE ISLAND SOIL EROSION AND SEDIMENTATION CONTROL HANDBOOK."
- THE EROSION CONTROL MEASURES SHOWN ON THESE PLANS ARE INTENDED TO BE THE MINIMUM NECESSARY AT THE START OF CONSTRUCTION. THE CONTRACTOR SHALL BE RESPONSIBLE TO MAINTAIN AND SUPPLEMENT THESE EROSION CONTROLS, AS NECESSARY THROUGHOUT CONSTRUCTION, TO PREVENT DAMAGE TO WETLANDS AND/OR SURROUNDING PROPERTIES.
- THE CONTRACTOR SHALL PREVENT DUST, DEBRIS, AND SEDIMENTS FROM LEAVING THE SITE DURING CONSTRUCTION AND SHALL BE RESPONSIBLE TO REPAIR, CLEAN UP, AND TAKE OTHER CORRECTIVE ACTION IMMEDIATELY OR NO LATER THAN 24 HOURS AFTER ANY ISSUE ARISES.
- THE CONTRACTOR SHALL CONTROL CONSTRUCTION STORMWATER RUNOFF IN SUCH A MANNER AS TO PREVENT DAMAGE TO DOWN-GRADIENT PROPERTIES; ANY PROPERTIES SO DAMAGED SHALL BE REPAIRED AT THE CONTRACTOR'S EXPENSE.
- THE CONTRACTOR SHALL INSPECT ALL EROSION CONTROL DEVICES ON A WEEKLY BASIS AND WITHIN 12 HOURS AFTER A RAINFALL EVENT. THE CONTRACTOR SHALL IMMEDIATELY REPAIR DAMAGED DEVICES AND SHALL REMOVE ACCUMULATED SEDIMENTS IN ACCORDANCE WITH LOCAL REQUIREMENTS AND THE RPDES PERMIT, WHEN APPLICABLE. ACCUMULATED SEDIMENTS SHALL BE REMOVED FROM THE SITE OR PLACED AWAY FROM WETLANDS AND CLOSED DRAINAGE SYSTEMS.
- THE CONTRACTOR SHALL MAKE EVERY EFFORT TO PERFORM EARTHWORK IN PHASES THAT ALLOW FOR STABILIZATION OF THESE AREAS IN A RELATIVELY SHORT TIME PERIOD AND TO DISCOURAGE EROSION AND SEDIMENTATION. ANY EXPOSED SOILS INTENDED TO REMAIN FOR MORE THAN 14 DAYS SHALL BE STABILIZED WITH MULCH, OR TEMPORARY SEED AND WATERED TO ENCOURAGE VEGETATION.
- THE CONTRACTOR SHALL INSTALL PERMANENT SEEDING BETWEEN APRIL 15TH AND JUNE 15TH AND/OR AUGUST 15TH TO OCTOBER 15TH.
- THE CONTRACTOR SHALL APPLY PERMANENT SOIL STABILIZATION MEASURES TO ALL GRADED AREAS WITHIN SEVEN (7) DAYS OF ESTABLISHING FINAL GRADE.
- THE CONTRACTOR SHALL REMOVE AND DISPOSE OF ALL E&S MEASURES ONLY AFTER FINAL PAVEMENT IS PLACED AND VEGETATION IN LANDSCAPE AREAS IS WELL ESTABLISHED.
- ALL EASEMENTS AND INSTALLATIONS SHALL MEET PROVIDENCE PARKS DEPARTMENT STANDARDS.

LEGEND

	EXIST	PROP		EXIST	PROP
BORING LOCATION			MATCHLINE		
TEST PIT LOCATION			PROPERTY LINE		
MONITORING WELL			RIGHT-OF-WAY/EASEMENT		
BENCH MARK			BUILDING SETBACK		
DRAIN MANHOLE			ZONING BOUNDARY		
CATCH BASIN			TOWN BOUNDARY		
DOUBLE CATCH BASIN			STATE BOUNDARY		
HEADWALL			TREE LINE		
FLARED END SECTION			STREAM/RIVER		
DRAIN LINE			WETLAND EDGE		
UNDER DRAIN			50' WETLAND BUFFER		
ROOF DRAIN			100' WETLAND BUFFER		
FOUNDATION DRAIN			200' WETLAND BUFFER		
SEWER MANHOLE			GRAVEL ROAD		
GRAVITY SEWER LINE			BITUMINOUS CONCRETE PAVEMENT		
SEWER FORCE MAIN			EDGE OF PAVEMENT		
COMBINED SEWER LINE			SAWCUT		
GREASE TRAP			RIPRAP STONE		
PLUG/STUB			CRUSHED STONE		
WATER LINE			EROSION CONTROL FABRIC		
FIRE PROTECTION			BITUMINOUS CURB		
WATER GATE			CAPE COD BERM		
FIRE HYDRANT			PRECAST CONCRETE CURB		
WATER METER			VERTICAL GRANITE CURB		
POST INDICATOR VALVE			SLOPED GRANITE EDGING		
WELL			LIMIT OF CURB TYPE		
GAS LINE			SOLID WHITE LINE		
GAS GATE			SOLID YELLOW LINE		
GAS METER			BROKEN WHITE LINE		
TELECOMMUNICATIONS			BROKEN YELLOW LINE		
TELEPHONE MANHOLE			SOLID WHITE CHANNELIZING LINE		
ELECTRIC MANHOLE			SOLID YELLOW CHANNELIZING LINE		
OVERHEAD ELECTRIC			DOUBLE YELLOW LINE		
UNDERGROUND ELECTRIC			STOP LINE		
ELECTRIC BOX			TOP/BOTTOM CURB ELEVATION		
UTILITY POLE			SPOT GRADE		
HAND HOLE			MINOR CONTOUR		
ELECTRIC METER			MAJOR CONTOUR		
SINGLE LUMINAIRE			TOP OF SLOPE		
DOUBLE LUMINAIRE			BOTTOM OF SLOPE		
TRIPLE LUMINAIRE			BUILDING		
QUAD LUMINAIRE			BUILDING ENTRANCE		
TRAFFIC SIGNAL			BOLLARD		
SIGNAL BOX			DUMPSTER PAD		
TRANSFORMER PAD			SINGLE SIGN		
FIRE ALARM			DOUBLE SIGN		
FIRE ALARM CONTROL PANEL			PARKING COUNT		
FIRE ALARM BOX			COMPACT PARKING COUNT		
CHAIN LINK FENCE			ADA PARKING		
STEEL GUARD RAIL			VAN ACCESSIBLE ADA PARKING		
WOOD GUARD RAIL			ADA RAMP		
STONE WALL			CROSSWALK		
RETAINING WALL			LIMIT OF DISTURBANCE		
TRAIN TRACKS			STRAW WATTLE		
			SILT FENCE		

ABBREVIATIONS


ABANDON	ABAN	MINIMUM	MIN
ADJUST	ADJ	NOT IN CONTRACT	NIC
AMERICAN SOCIETY FOR TESTING & MATERIALS	ASTM	NOT TO SCALE	NTS
AMERICANS WITH DISABILITIES ACT	ADA	OFFICE OF WATER RESOURCES	OWR
APPROXIMATE	APPROX	ON CENTER	OC
BACK OF CURB	BOC	ONSITE WASTEWATER TREATMENT SYSTEM	OWTS
BITUMINOUS CURB	BC	PAVED WATER WAY	PWW
BOTTOM OF CURB	BOC	POLYVINYLCHLORIDE PIPE	PVC
BOTTOM OF SLOPE	BOS	PRECAST CONCRETE CURB	PCC
BOTTOM OF WALL	BOW	PROPOSED	PROP
CAPE COD BERM	CCB	RADIUS	R
CAST IRON PIPE	CIP	REINFORCED CONCRETE PIPE	RCP
CATCH BASIN	CB	REMOVE	REM
COLUMN	COL	REMOVE AND DISPOSE	R&D
CONCRETE TRANSITION CURB	CTC	REMOVE AND RESET	R&R
CONDUIT	COND	REMOVE AND STORE	R&S
DOUBLE CATCH BASIN	DCB	RETAIN	RET
DUCTILE IRON PIPE	DIP	RIGHT OF WAY	ROW
EDGE OF PAVEMENT	EOP	SIDEWALK	S/W
ELEVATION	ELEV	SLOPED GRANITE EDGING	SGE
EXISTING	EXIST	STANDARD DUTY PAVEMENT	SDP
FOUNDATION	FDN	STANDARD	STD
FRAME AND COVER	F&C	TAPPING SLEEVE, VALVE AND BOX	TS&VB
FRAME AND GRATE	F&G	TOP OF CURB	TOC
GALVANIZED	GALV	TOP OF SLOPE	TOS
GRANITE CURB	GC	TOP OF WALL	TOW
HIGH DENSITY POLYETHYLENE	HDPE	TRANSITION	TRANS
HYDRANT	HYD	TYPICAL	TYP
INVERT ELEVATION	INV	UTILITY POLE	UP
LANDSCAPE AREA	LA	VERTICAL GRANITE CURB	VGC
MAXIMUM	MAX	WATER GATE	WG
MONOLITHIC CONCRETE CURB	MCC		

wsp

WSP USA
166 VALLEY STREET, BUILDING 5
PROVIDENCE RHODE ISLAND, 02909
WWW.WSP.COM
(401) 415-9442



SEAL:

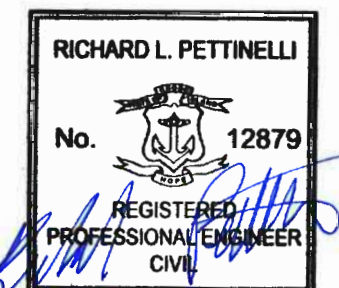

REVISION	DATE	DESCRIPTION
----------	------	-------------

CLIENT:
PROVIDENCE PARKS DEPARTMENT
1000 ELMWOOD AVENUE
PROVIDENCE, RI 02907

PROJECT:
SITE IMPROVEMENTS AT INDIA POINT PARK


109 INDIA STREET
PROVIDENCE, RHODE ISLAND 02903

TITLE:


NOTES & LEGEND

ISSUED FOR: BID
DATE: MARCH 25, 2024
SCALE: N/A
DRAWN BY: AJP
CHECKED BY: RLP
PROJECT NO: 365220361

C-2

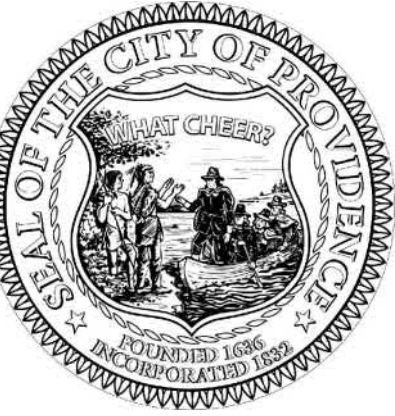

SEAL:

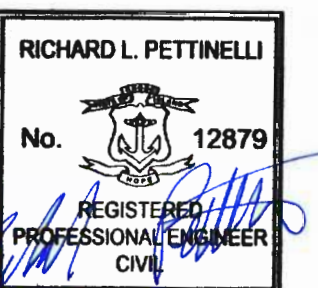

REVISION	DATE	DESCRIPTION

CLIENT:
PROVIDENCE PARKS DEPARTMENT
1000 ELMWOOD AVENUE
PROVIDENCE, RI 02907


PROJECT:
SITE IMPROVEMENTS AT INDIA POINT PARK



109 INDIA STREET
PROVIDENCE, RHODE ISLAND 02903

TITLE:
PARTIAL SITE PLAN

ISSUED FOR: BID
DATE: MARCH 25, 2024
SCALE: 1"=30'
DRAWN BY: AJP
CHECKED BY: RLP
PROJECT NO: 3652220361

C-3

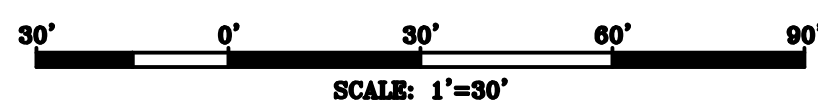

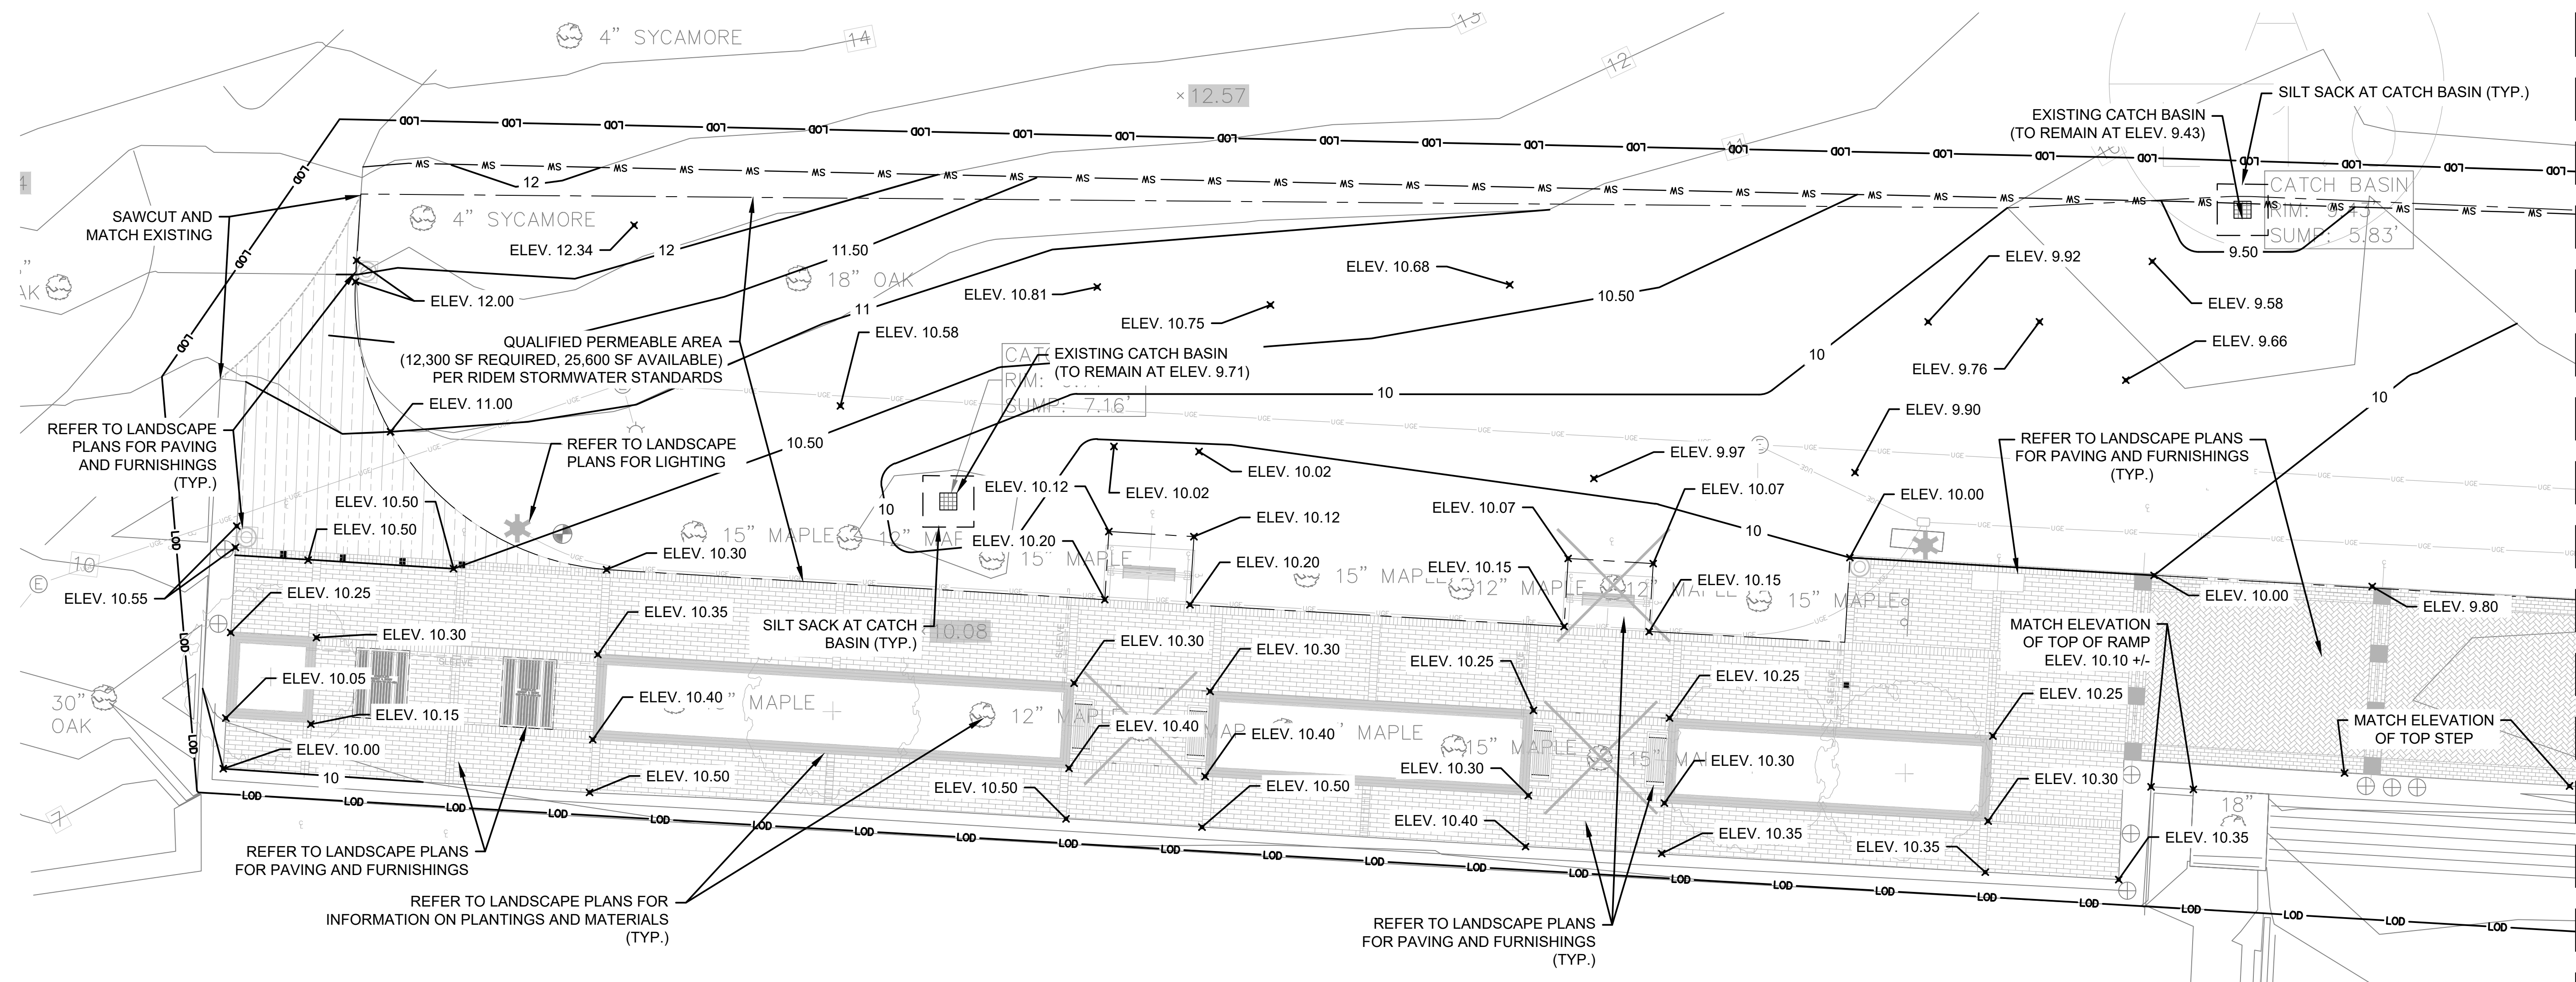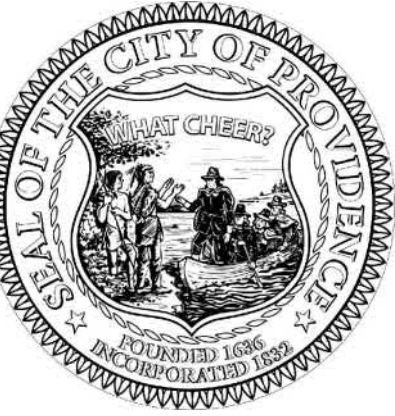

SEAL:

RICHARD L. PETTINELLI
No. 12879
REGISTERED PROFESSIONAL ENGINEER
CIVIL

REVISION	DATE	DESCRIPTION




CLIENT:
PROVIDENCE PARKS DEPARTMENT
1000 ELMWOOD AVENUE
PROVIDENCE, RI 02907

PROJECT:
SITE IMPROVEMENTS AT INDIA POINT PARK
109 INDIA STREET
PROVIDENCE, RHODE ISLAND 02903


TITLE:
SITE GRADING PLAN 1

ISSUED FOR: BID
DATE: MARCH 25, 2024
SCALE: 1"=10'
DRAWN BY: AJP
CHECKED BY: RLP
PROJECT NO: 3652220361



C-4

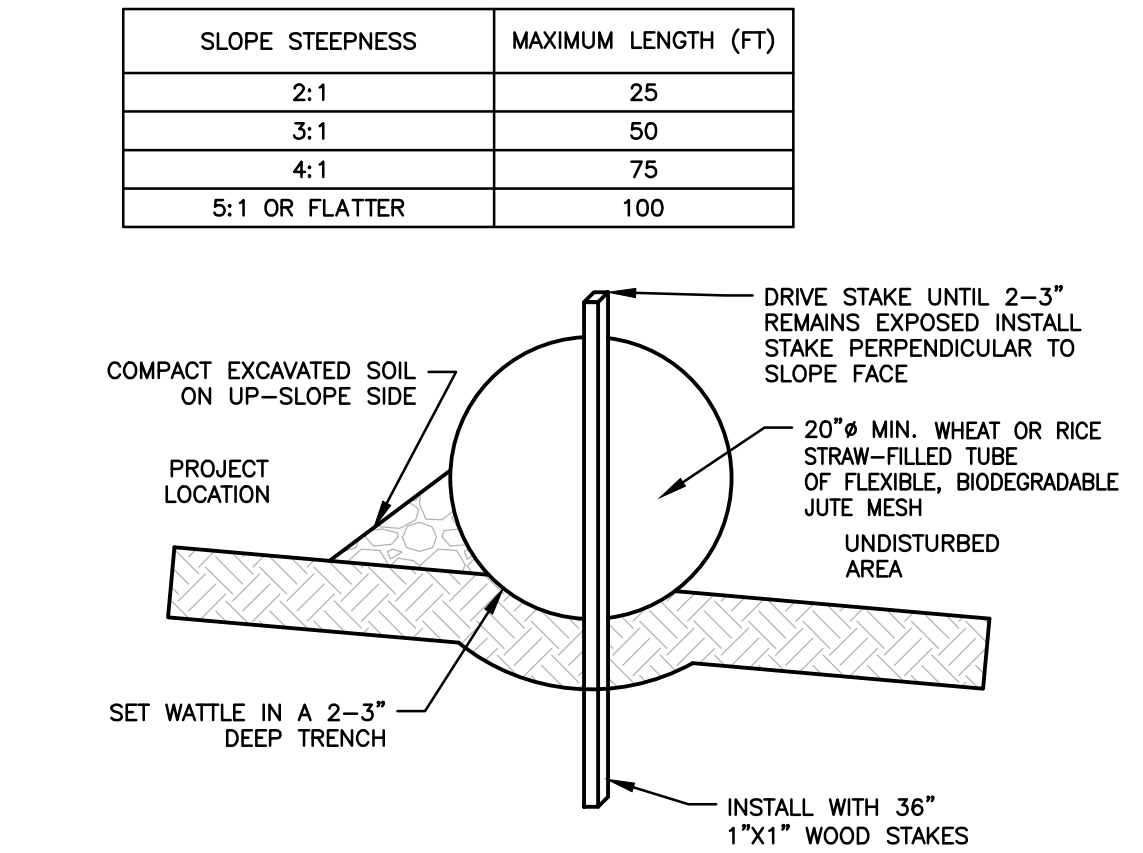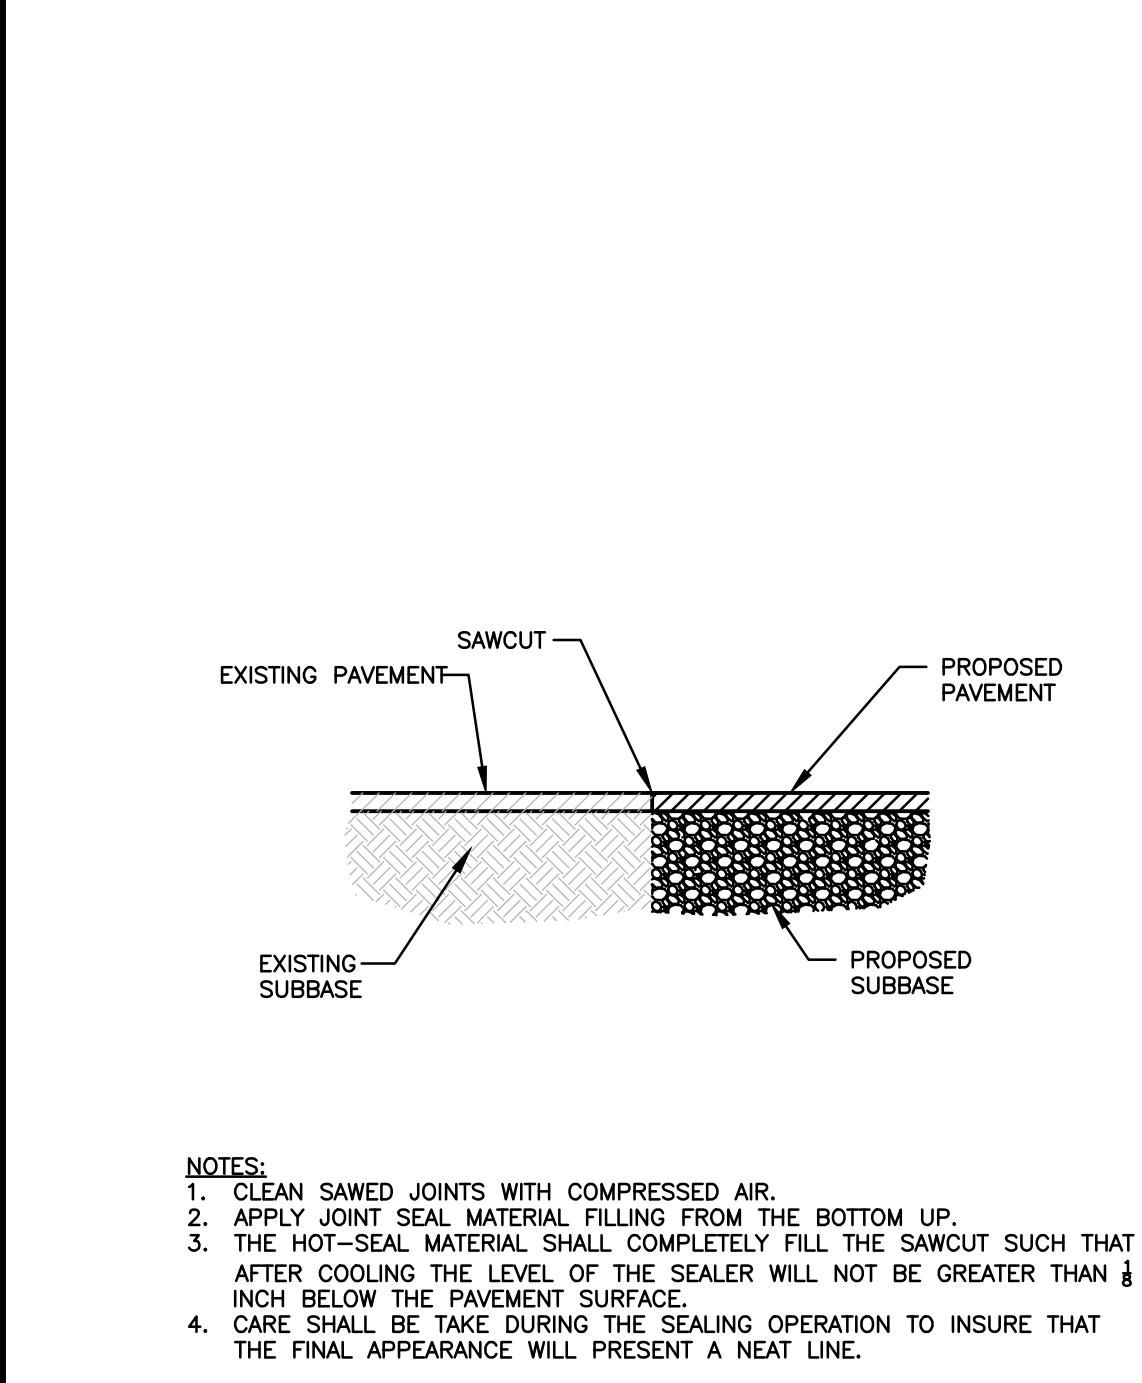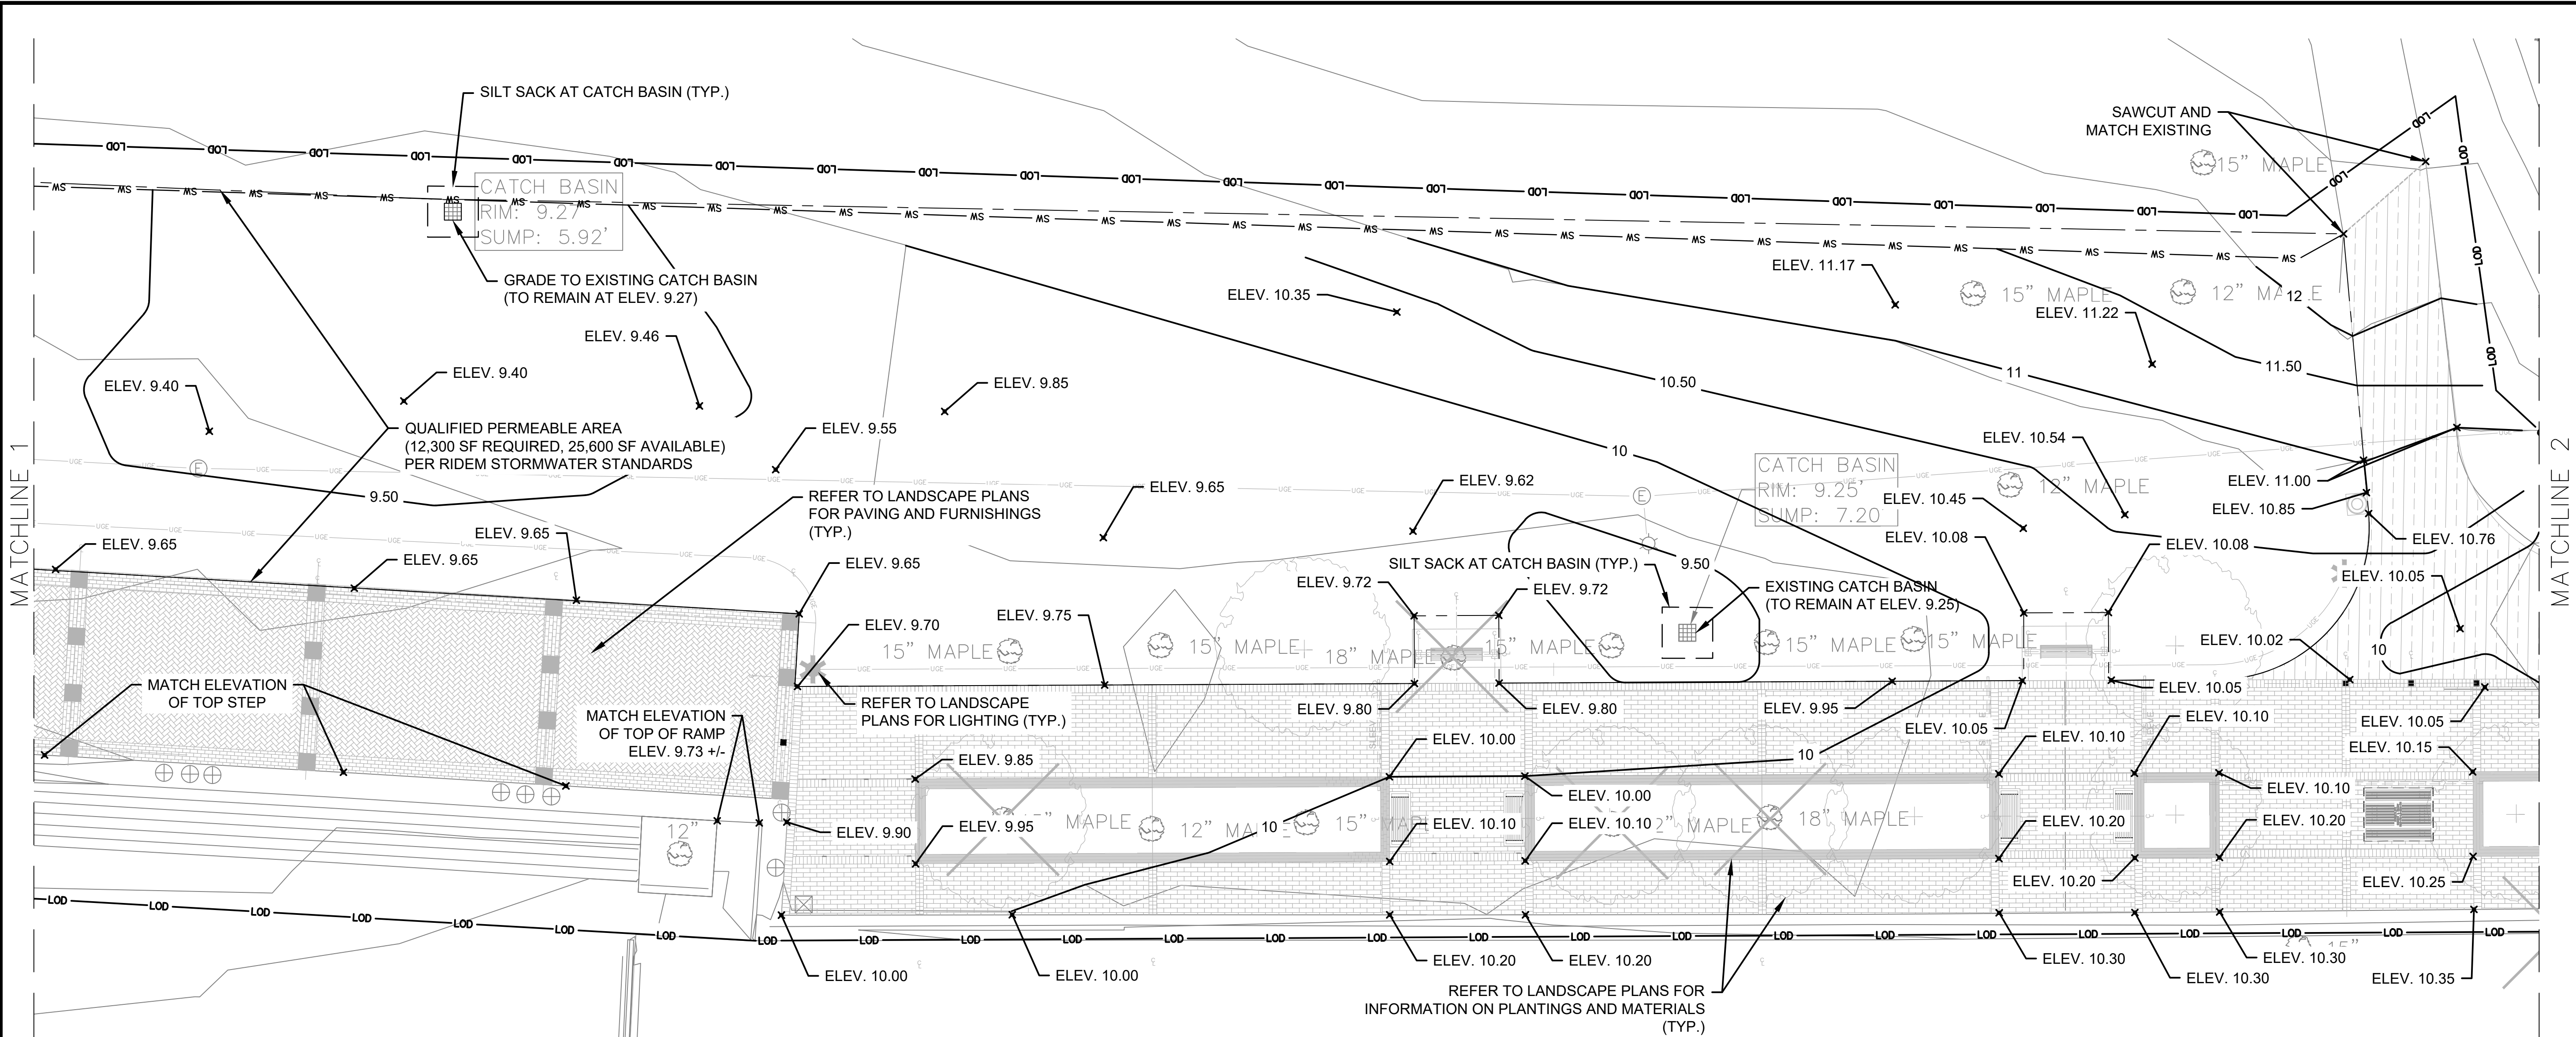

- NOTES:**
- BEGIN AT THE LOCATION WHERE THE WATTLE IS TO BE INSTALLED BY EXCAVATING A 2-3" DEEP X 9" WIDE TRENCH ALONG THE CONTOUR OF THE SLOPE. EXCAVATED SOIL SHALL BE PLACED UP-SLOPE FROM THE ANCHOR TRENCH.
 - PLACE THE SOCK IN THE TRENCH SO THAT IT CONTOURS TO THE SOIL SURFACE. COMPACT THE SOIL FROM THE EXCAVATED TRENCH AGAINST THE SOCK ON THE UP-HILL SIDE. ADJACENT SOCK SHOULD TIGHTLY ABUT.
 - SECURE THE WATTLE WITH 18-24" STAKES EVERY 3-4" WITH A STAKE ON EACH END. STAKES SHALL BE DRIVEN THROUGH THE MIDDLE OF THE SOCK LEAVING AT LEAST 2-3" OF STAKE EXTENDING ABOVE THE SOCK. STAKES SHALL BE DRIVEN PERPENDICULAR TO SLOPE FACE.
 - MAX. DRAINAGE AREA ≤ 0.25 ACRES/100 LINEAR FEET.

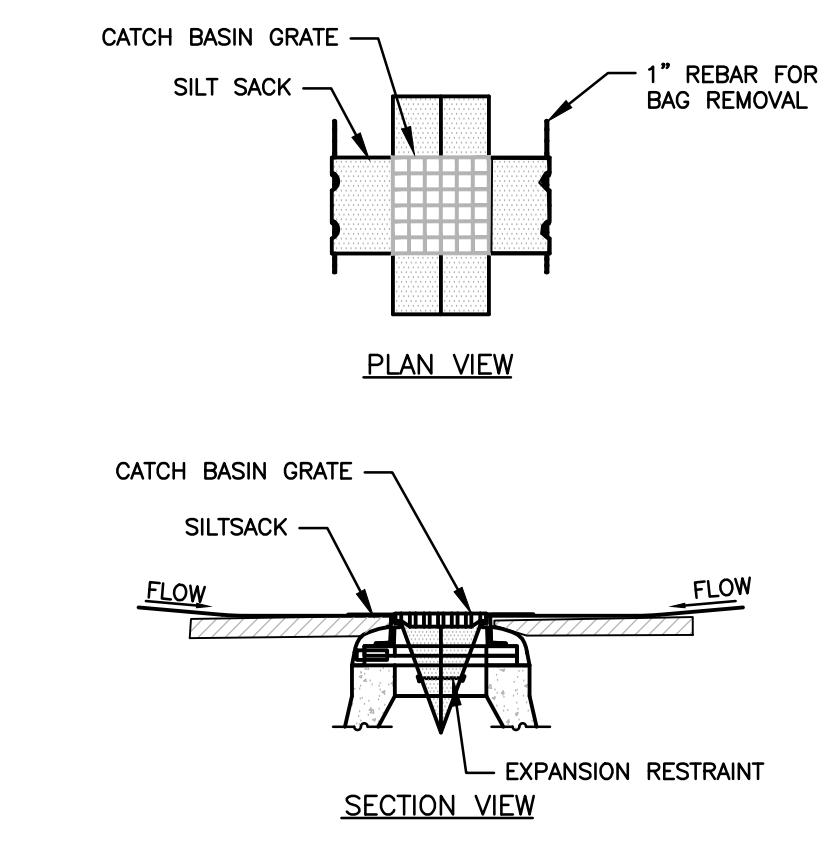

- NOTES:**
- INSTALL SILT SACK IN ALL CATCH BASINS WHERE INDICATED ON THE PLAN BEFORE COMMENCING WORK.
 - GRATE TO BE PLACED OVER SILT SACK.
 - SILT SACK SHALL BE INSPECTED PERIODICALLY AND AFTER ALL STORM EVENTS AND CLEANING OR REPLACEMENT SHALL BE PERFORMED PROMPTLY AS NEEDED.
 - MAINTAIN UNTIL UP-GRADIENT AREAS HAVE BEEN PERMANENTLY STABILIZED.

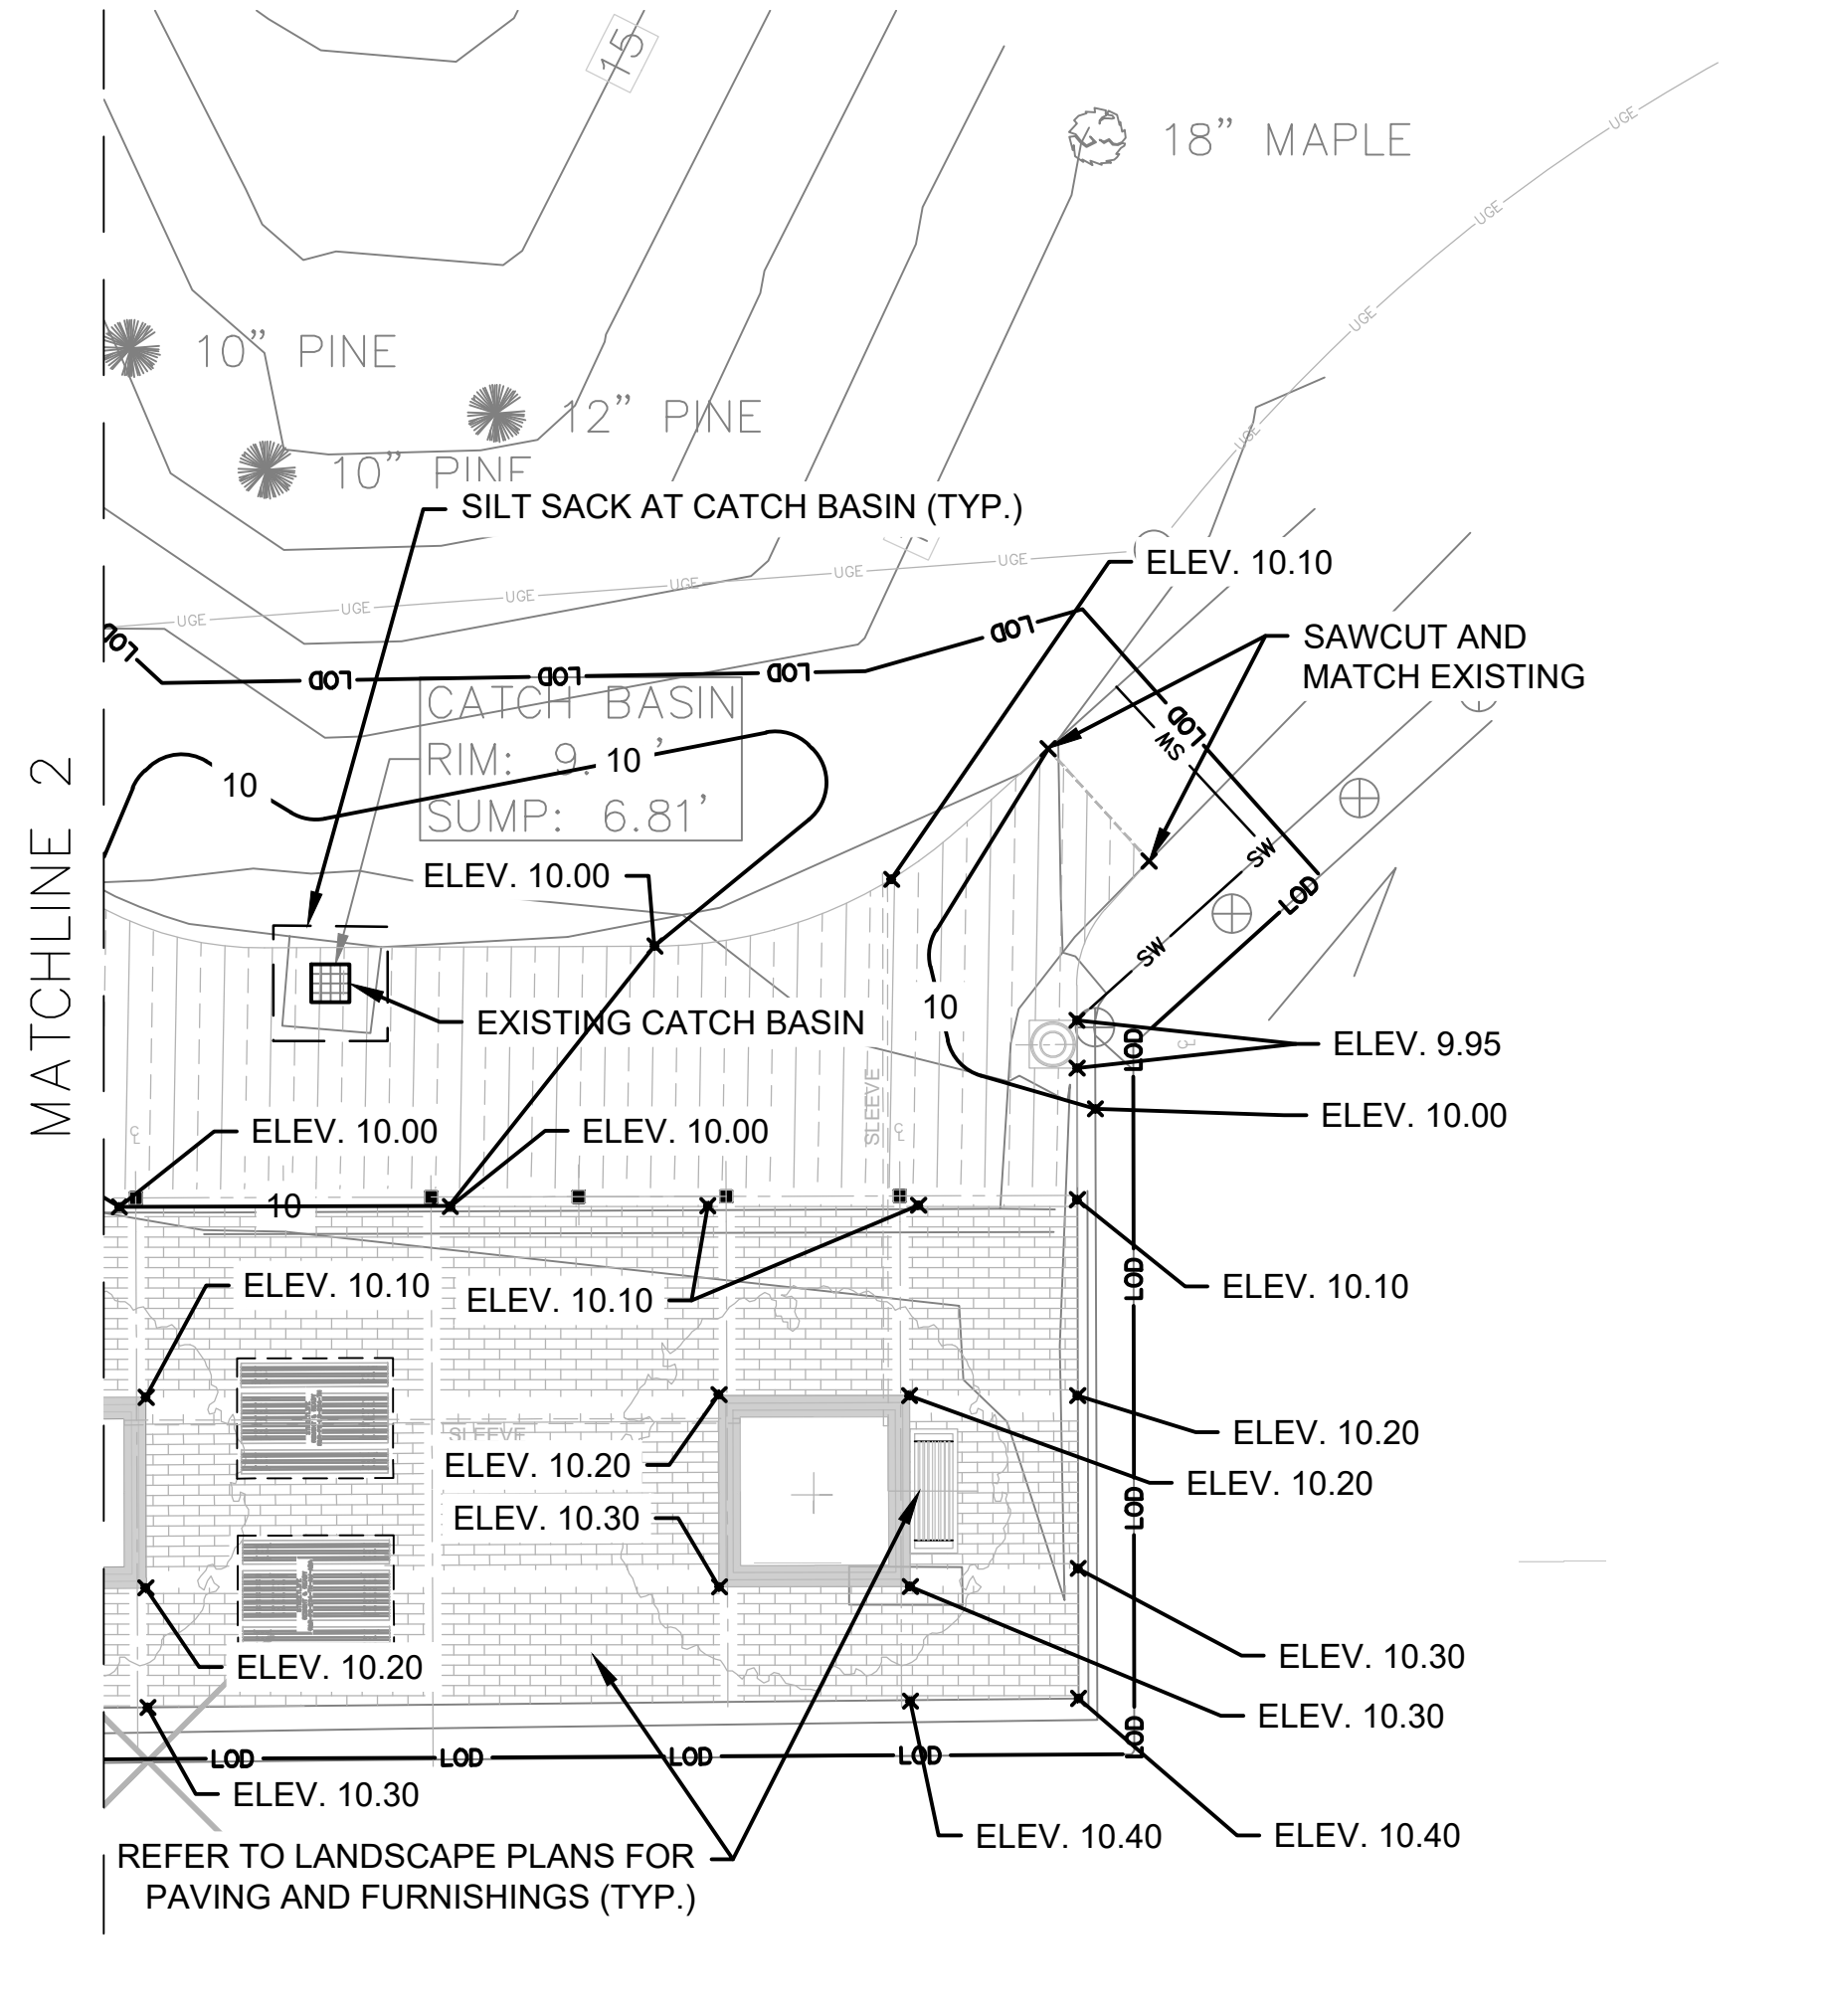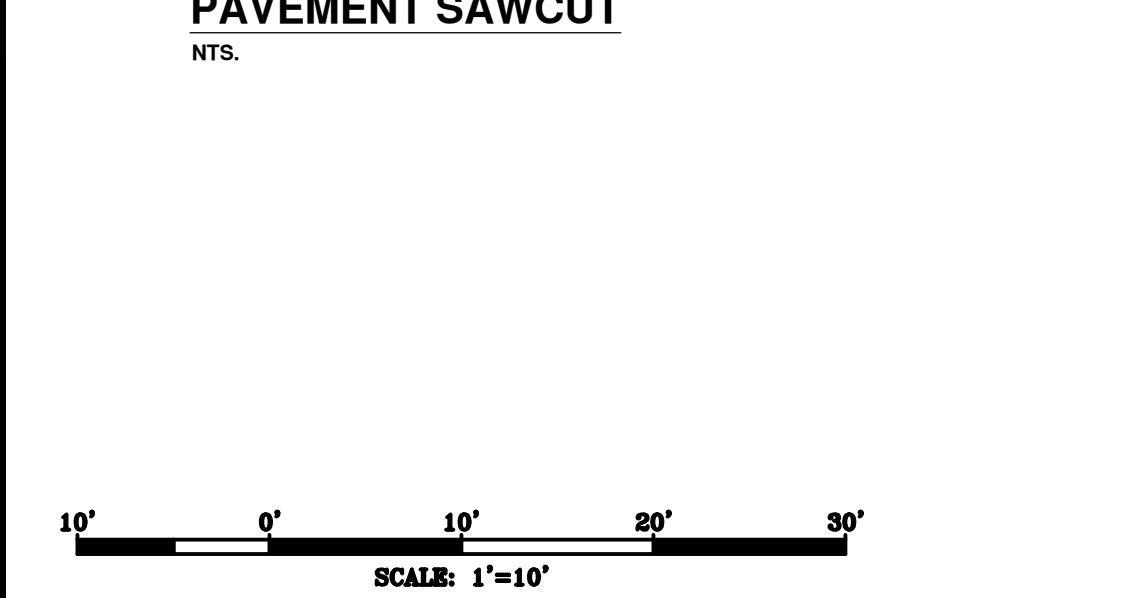

SEAL:

REVISION	DATE	DESCRIPTION

CLIENT:
PROVIDENCE PARKS DEPARTMENT
1000 ELMWOOD AVENUE
PROVIDENCE, RI 02907

PROJECT:
SITE IMPROVEMENTS AT INDIA POINT PARK

109 INDIA STREET
PROVIDENCE, RHODE ISLAND 02903

TITLE:
SITE GRADING PLAN 2 AND DETAILS

ISSUED FOR: BID


DATE: MARCH 25, 2024

SCALE: 1"=10'


DRAWN BY: AJP

CHECKED BY: RLP

PROJECT NO: 365220361

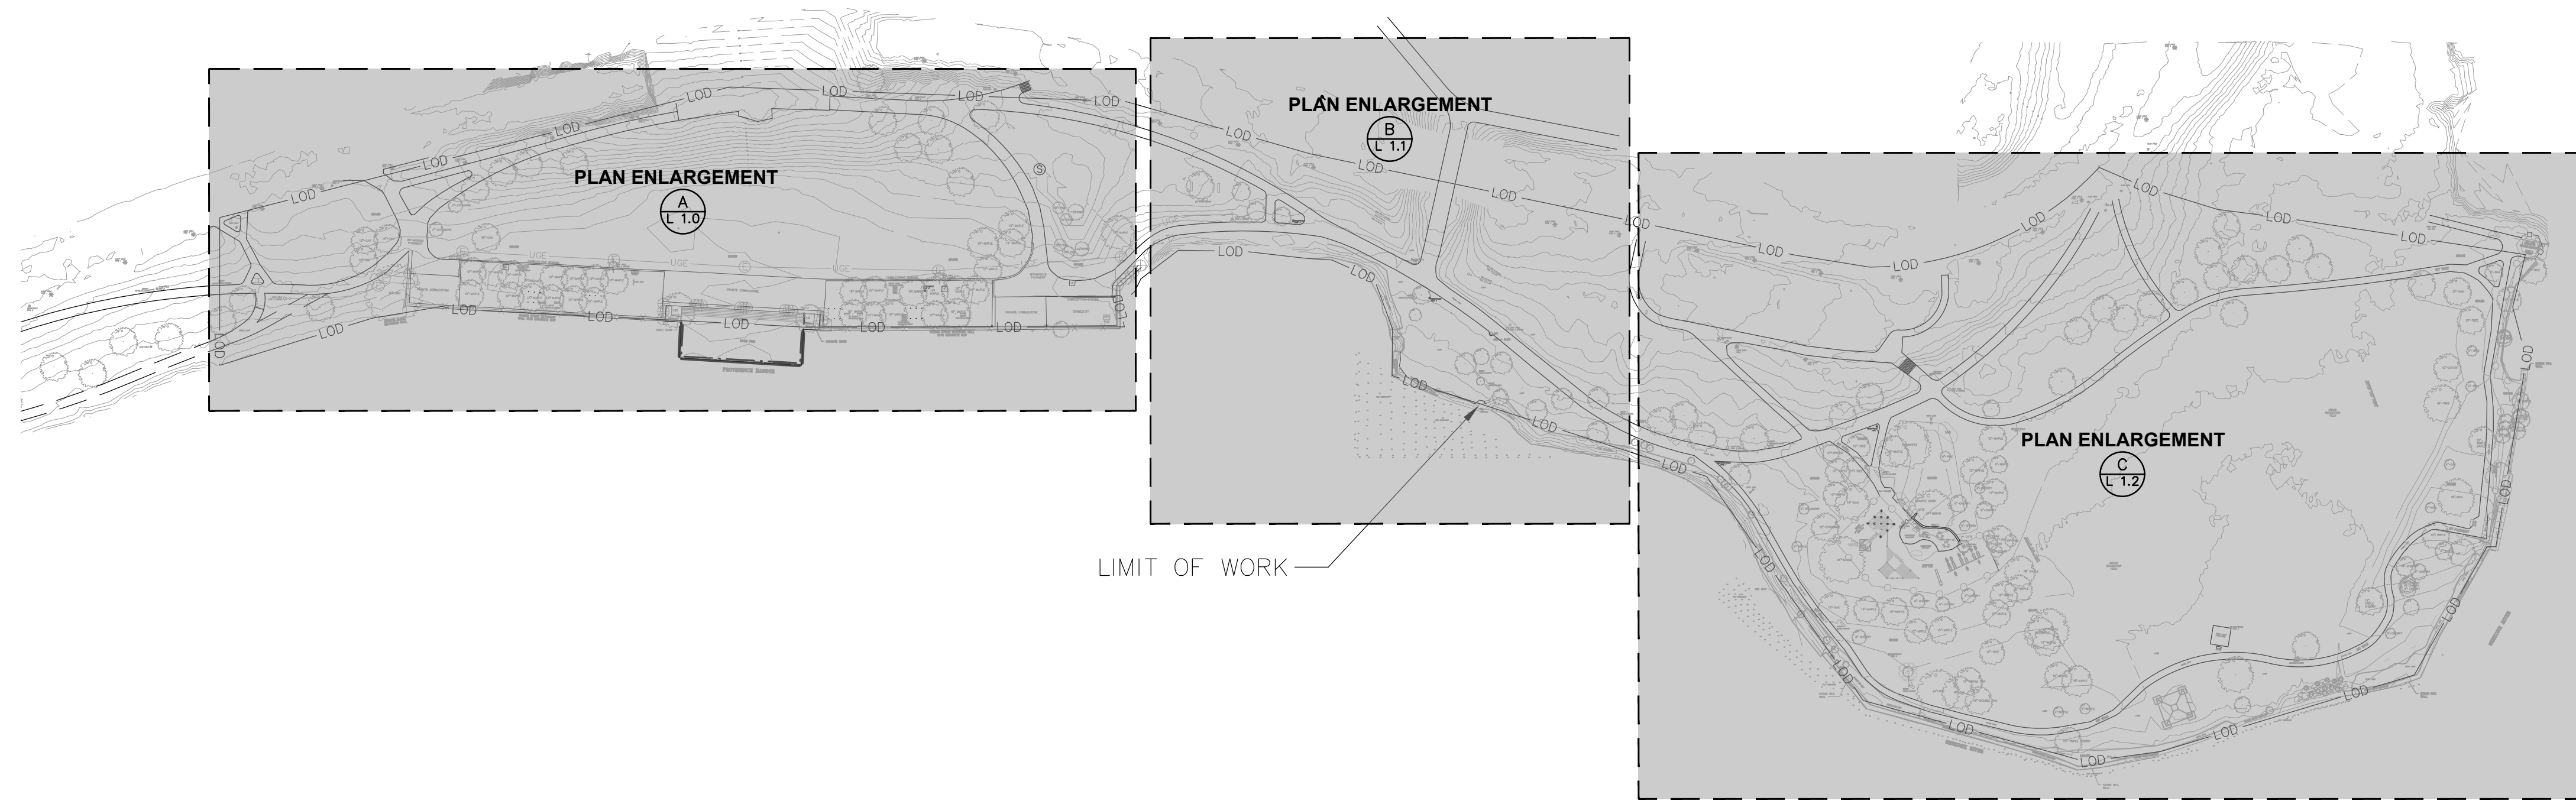


LOCATION PLAN
1"=100'-0"

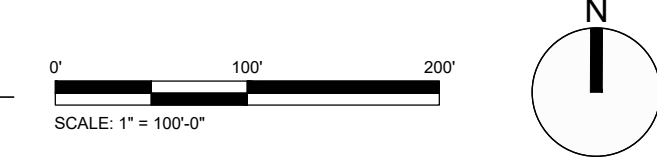



Legend

- EXISTING CONDITIONS
- EXISTING TREE PROTECTION, SEE 1/L1.1 AND NOTES ON L3.0
- REMOVE AND DISPOSE OF PAVEMENT AND SUBGRADE BASE MATERIALS (8" DEPTH MINIMUM)
- REMOVE AND DISPOSE OF PLANT AND STUMP (BY OWNER)
- SAWCUT PAVEMENT

- GENERAL NOTES:**
1. SEE CIVIL DRAWINGS FOR INFORMATION NOT DEPICTED ON THE LANDSCAPE DRAWINGS, INCLUDING EXTENT OF DISTURBANCE / LIMIT OF WORK.
 2. SEE L2.0, L3.0, AND CONSTRUCTION DETAILS FOR ADDITIONAL NOTES.
 3. CONSTRUCTION ACTIVITIES SHALL NOT UNNECESSARILY IMPACT PARK OPERATIONS.
 4. DAILY CONSTRUCTION COORDINATION WITH PARKS DEPARTMENT STAFF IS THE RESPONSIBILITY OF THE CONTRACTOR.
 5. ALL ITEMS SLATED FOR DEMOLITION, REMOVAL, DISPOSAL, OR SALVAGE SHALL BE MARKED OR OTHERWISE IDENTIFIED IN THE FIELD. COORDINATION AND APPROVAL OF THE CITY REPRESENTATIVE SHALL BE OBTAINED PRIOR TO WORK.
 6. ALL SURFACE AND SUBSURFACE MATERIALS (STONEDUST, GRAVEL, LOAM, ETC) TO BE REMOVED, SHALL BE EXCAVATED TO THE MINIMUM DEPTH REQUIRED FOR THE INSTALLATION OF PROPOSED IMPROVEMENTS. EXCAVATION AND REMOVAL DEPTHS VARY BASED ON ITEM TO BE INSTALLED. REFER TO CONSTRUCTION DETAILS.
 7. ALL DISTURBED AREAS NOT IDENTIFIED FOR A SPECIFIC SURFACE TREATMENT SHALL BE LOAMED AND HYDO-SEEDED, SEE 6/L3.3.
 8. ALL PLANT MATERIAL AND STUMPS IDENTIFIED FOR REMOVAL WILL BE DONE BY OTHERS PRIOR TO MOBILIZATION OF THE SELECTED CONTRACTOR FOR THIS PROJECT.
 9. TOTAL QUANTITY OF EXISTING WOOD LIGHT POLES AND LUMINAIRES TO BE REMOVED AND DISPOSED OF: EIGHT (8). TOTAL QUANTITY OF NEW LIGHT POLES AND LUMINAIRES TO BE INSTALLED: NINE (9).
 10. ALL EXISTING ELECTRICAL PULL BOXES (HANDHOLDS) AND CONDUIT SHALL BE REUSED. TWO (2) NEW PULL BOXES WILL BE REQUIRED.
 11. CONTACT DIGSAFE PRIOR TO BEGINNING WORK.
 12. AN ELECTRONIC FILE OF THIS DRAWING WILL BE PROVIDED FOR CONTRACTOR LAYOUT PURPOSES.

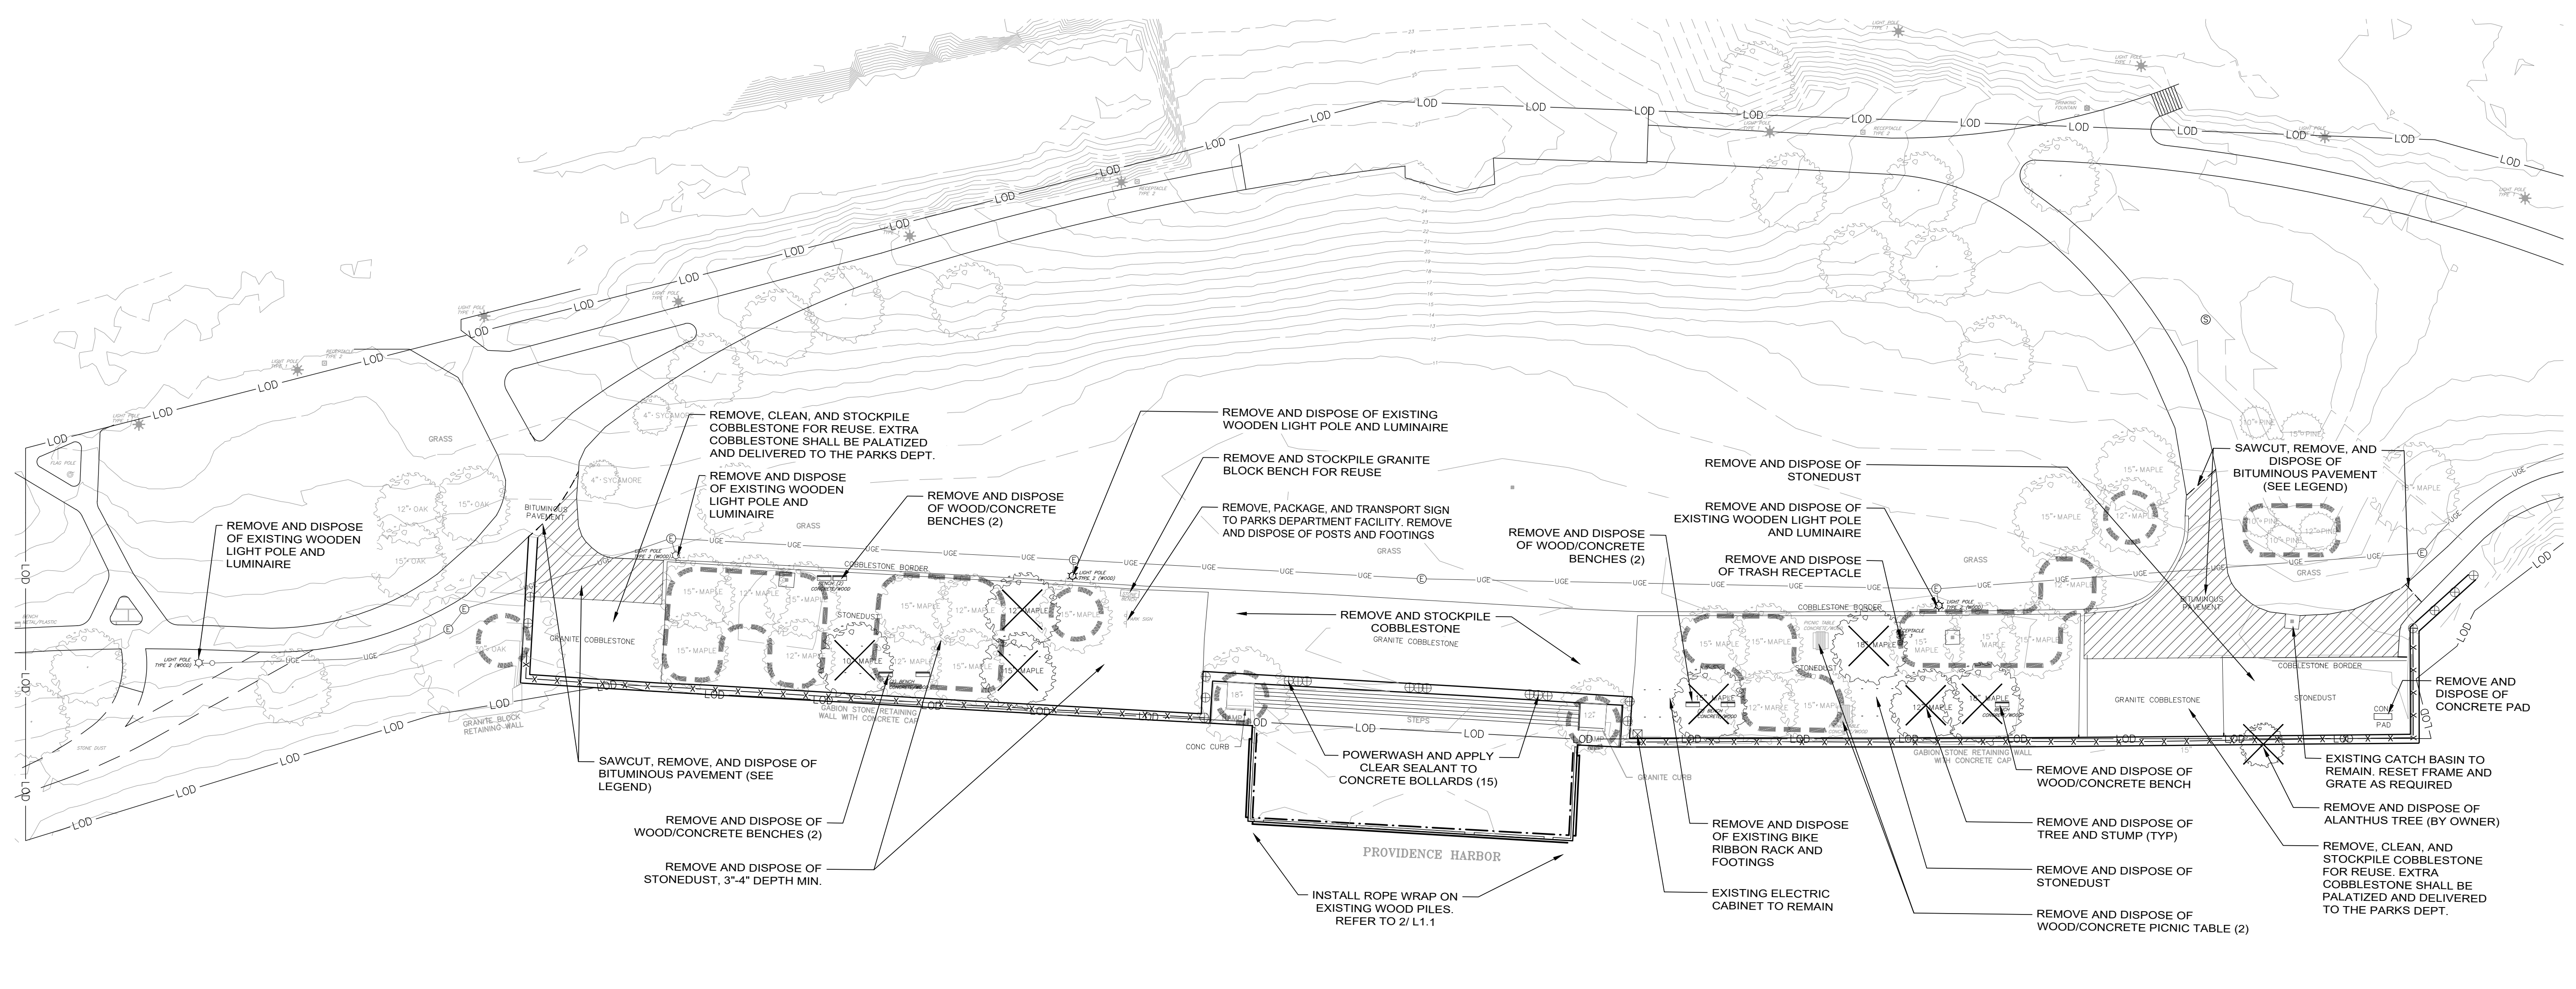

A | PLAN ENLARGEMENT
1"=30'-0"

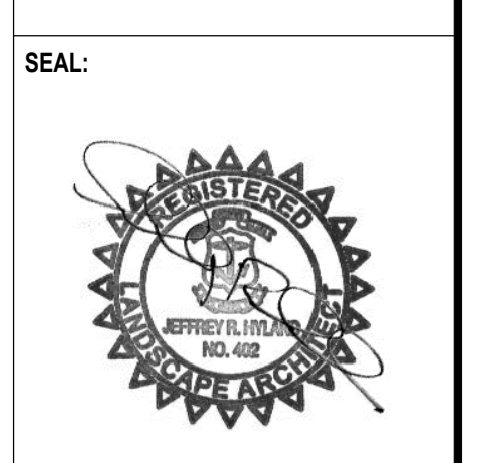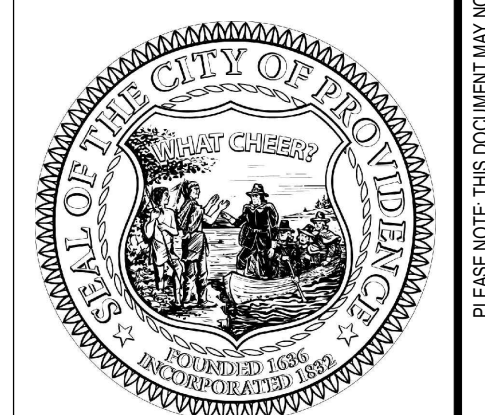

REV	DATE	DESCRIPTION

CLIENT:
PROVIDENCE PARKS DEPARTMENT
DALRYMPLE BOATHOUSE, MAPLE AVE,
PROVIDENCE, RI 02905

PROJECT:
SITE IMPROVEMENTS AT INDIA POINT PARK
109 INDIA STREET
PROVIDENCE, RI 02905

TITLE:
SITE PREPARATION PLAN

ISSUED FOR: BID

DATE: MARCH 25, 2024

SCALE: AS NOTED

DRAWN BY: S WRIGHT, J HYLAND

CHECKED BY: J HYLAND, D JENSEN

WSP PROJECT NO: 3652210316

L 1.0



CLIENT:
PROVIDENCE PARKS DEPARTMENT
 DALRYMPLE BOATHOUSE, MAPLE AVE,
 PROVIDENCE, RI 02905

PROJECT:
SITE IMPROVEMENTS AT INDIA POINT PARK
 109 INDIA STREET
 PROVIDENCE, RI 02905

TITLE:
SITE PREPARATION PLAN & DETAILS

ISSUED FOR: **BID**

DATE: **MARCH 25, 2024**

SCALE: **AS NOTED**

DRAWN BY: **S WRIGHT, J HYLAND**

CHECKED BY: **J HYLAND, D JENSEN**


WSP PROJECT NO: **365210316**

L1.1


Legend

- EXISTING CONDITIONS
- EXISTING TREE PROTECTION, SEE 1/L1.1 AND NOTES ON L3.0
- REMOVE AND DISPOSE OF PAVEMENT AND SUBGRADE BASE MATERIALS (8" DEPTH MINIMUM)
- REMOVE AND DISPOSE OF PLANT AND STUMP (BY OWNER)
- SAWCUT PAVEMENT

- GENERAL NOTES:**
- SEE CIVIL DRAWINGS FOR INFORMATION NOT DEPICTED ON THE LANDSCAPE DRAWINGS, INCLUDING EXTENT OF DISTURBANCE / LIMIT OF WORK.
 - SEE L2.0, L3.0, AND CONSTRUCTION DETAILS FOR ADDITIONAL NOTES.
 - CONSTRUCTION ACTIVITIES SHALL NOT UNNECESSARILY IMPACT PARK OPERATIONS.
 - DAILY CONSTRUCTION COORDINATION WITH PARKS DEPARTMENT STAFF IS THE RESPONSIBILITY OF THE CONTRACTOR.
 - ALL ITEMS SLATED FOR DEMOLITION, REMOVAL, DISPOSAL, OR SALVAGE SHALL BE MARKED OR OTHERWISE IDENTIFIED IN THE FIELD. COORDINATION AND APPROVAL OF THE CITY REPRESENTATIVE SHALL BE OBTAINED PRIOR TO WORK.
 - ALL SURFACE AND SUBSURFACE MATERIALS (STONEDUST, GRAVEL, LOAM, ETC) TO BE REMOVED, SHALL BE EXCAVATED TO THE MINIMUM DEPTH REQUIRED FOR THE INSTALLATION OF PROPOSED IMPROVEMENTS. EXCAVATION AND REMOVAL DEPTHS VARY BASED ON ITEM TO BE INSTALLED. REFER TO CONSTRUCTION DETAILS.
 - ALL DISTURBED AREAS NOT IDENTIFIED FOR A SPECIFIC SURFACE TREATMENT SHALL BE LOAMED AND HYDO-SEEDED. SEE 6/L3.3.
 - ALL PLANT MATERIAL AND STUMPS IDENTIFIED FOR REMOVAL WILL BE DONE BY OTHERS PRIOR TO MOBILIZATION OF THE SELECTED CONTRACTOR FOR THIS PROJECT.
 - TOTAL QUANTITY OF EXISTING WOOD LIGHT POLES AND LUMINAIRES TO BE REMOVED AND DISPOSED OF: EIGHT (8). TOTAL QUANTITY OF NEW LIGHT POLES AND LUMINAIRES TO BE INSTALLED: NINE (9).
 - ALL EXISTING ELECTRICAL PULL BOXES (HANDHOLDS) AND CONDUIT SHALL BE REUSED. TWO (2) NEW PULL BOXES WILL BE REQUIRED.
 - CONTACT DIGSAFE PRIOR TO BEGINNING WORK.
 - AN ELECTRONIC FILE OF THIS DRAWING WILL BE PROVIDED FOR CONTRACTOR LAYOUT PURPOSES.

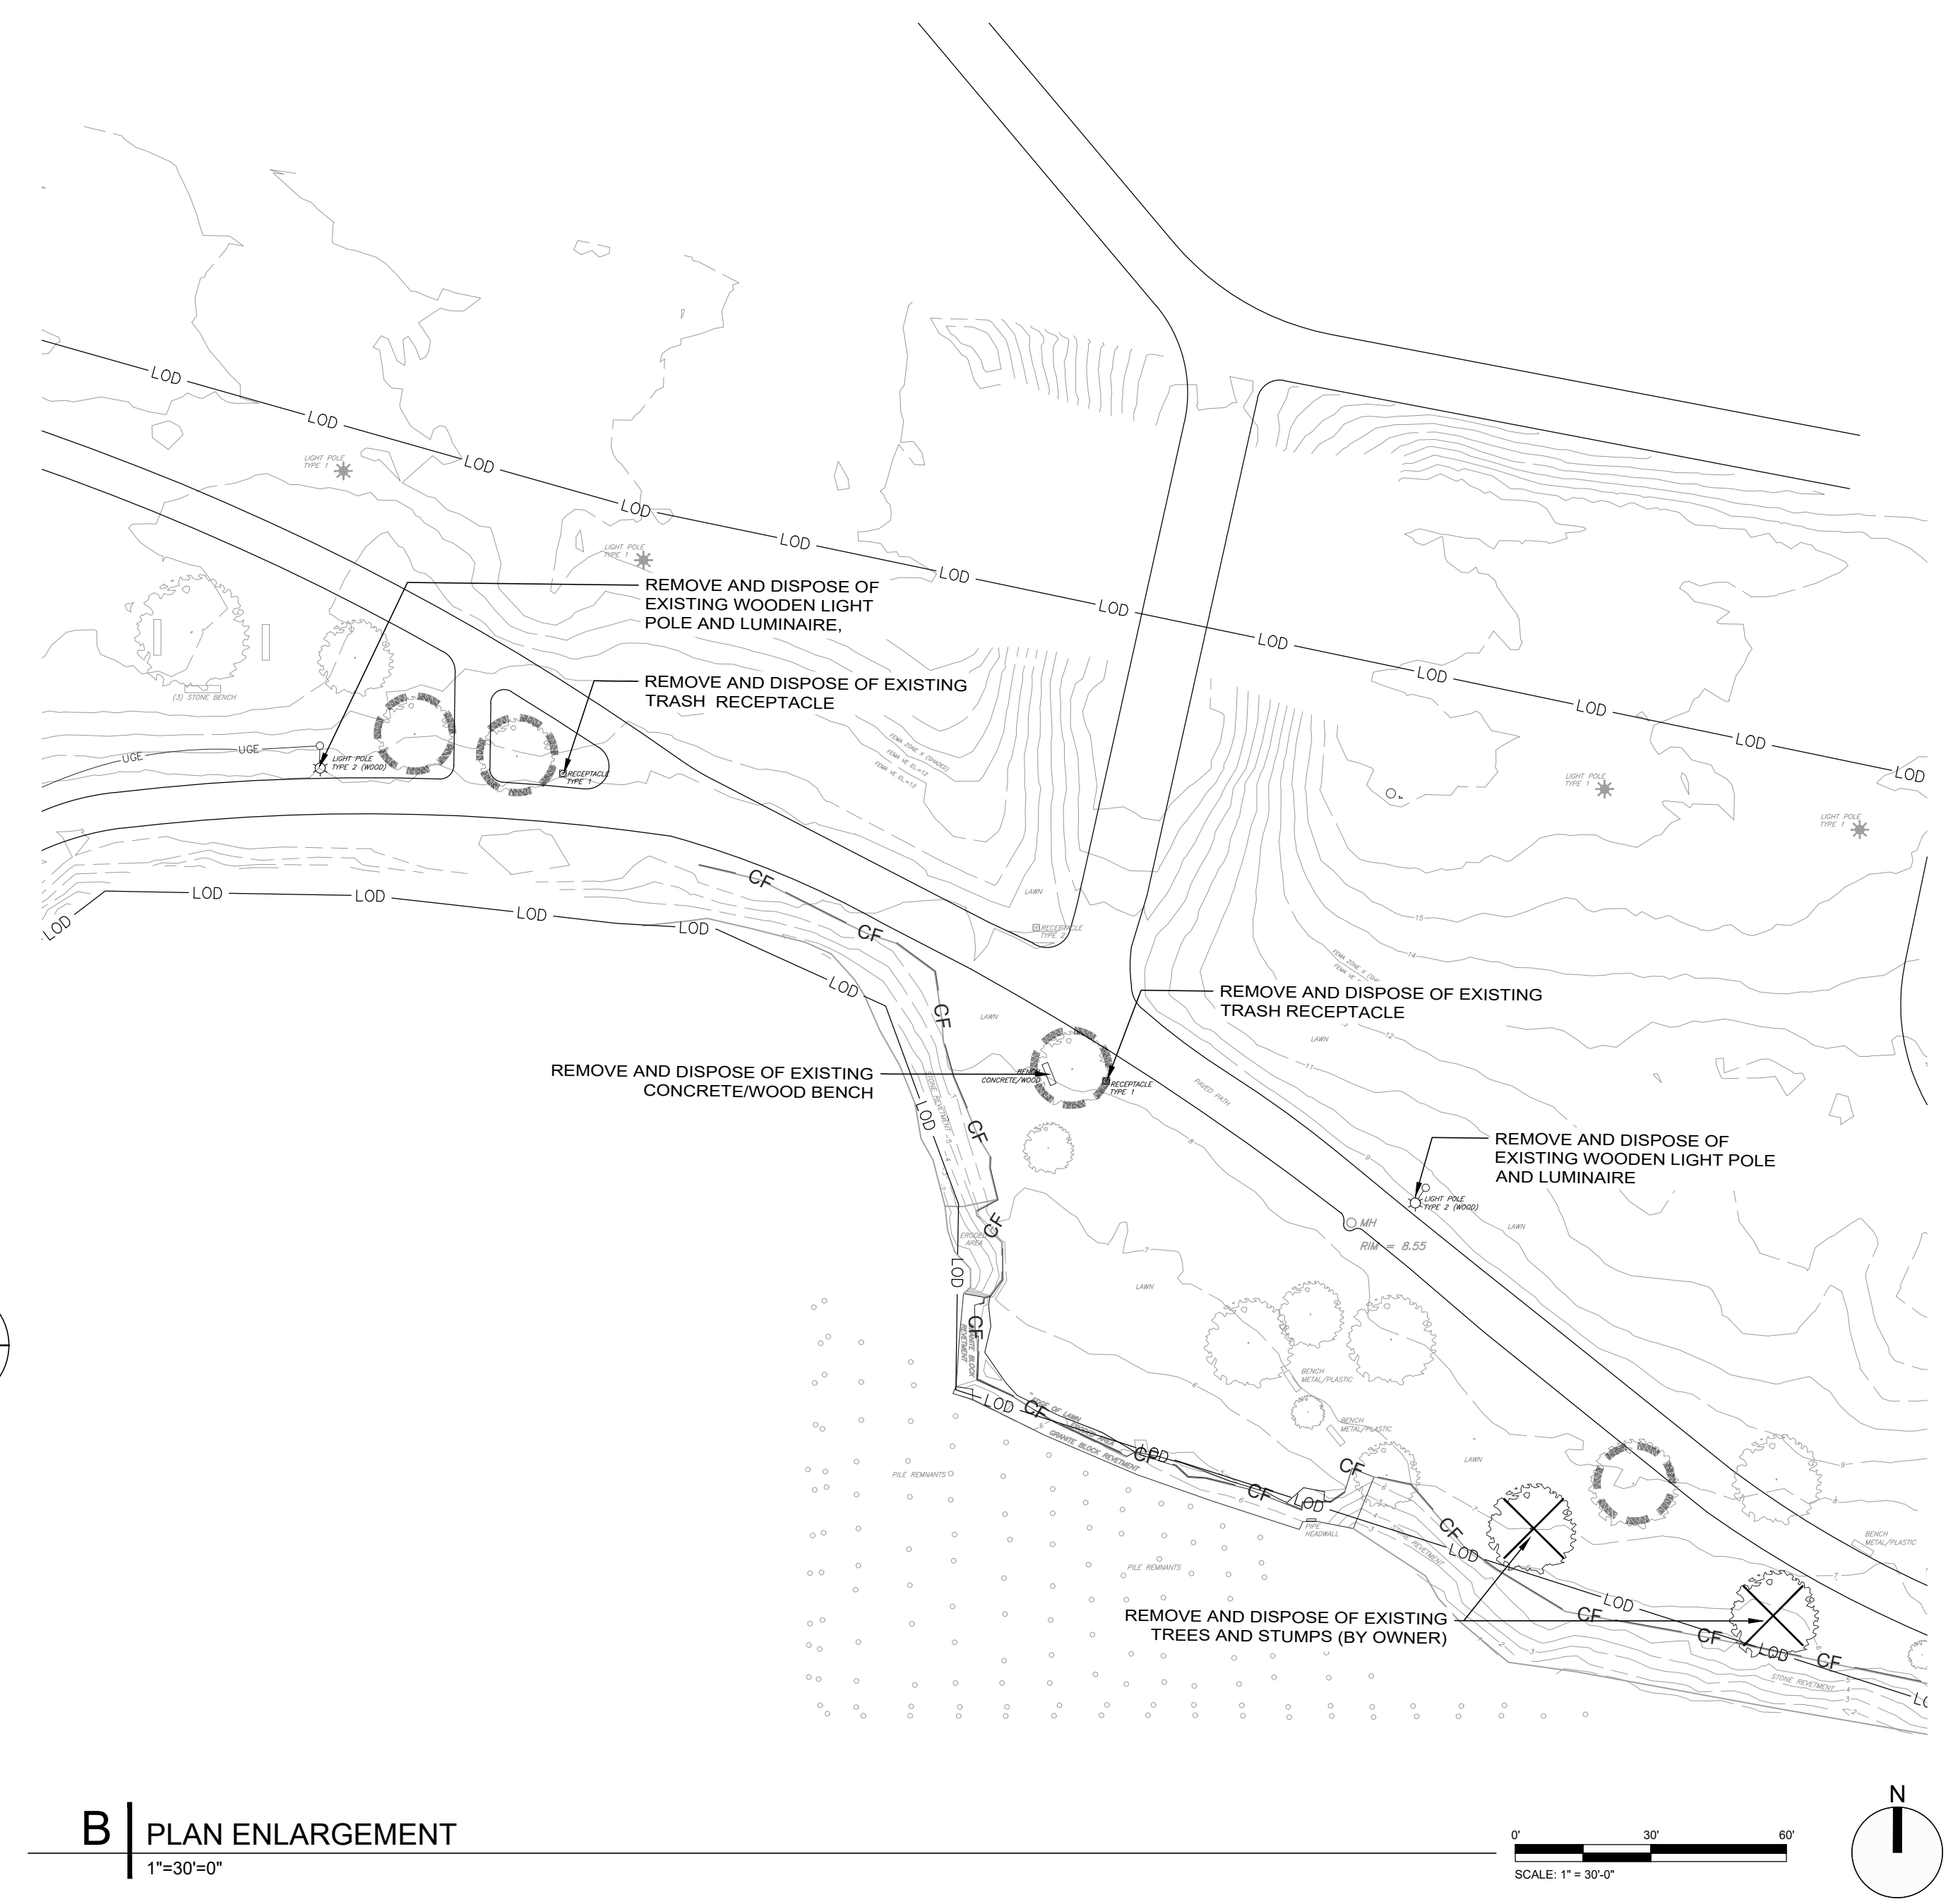



B | PLAN ENLARGEMENT
 1"=30'-0"

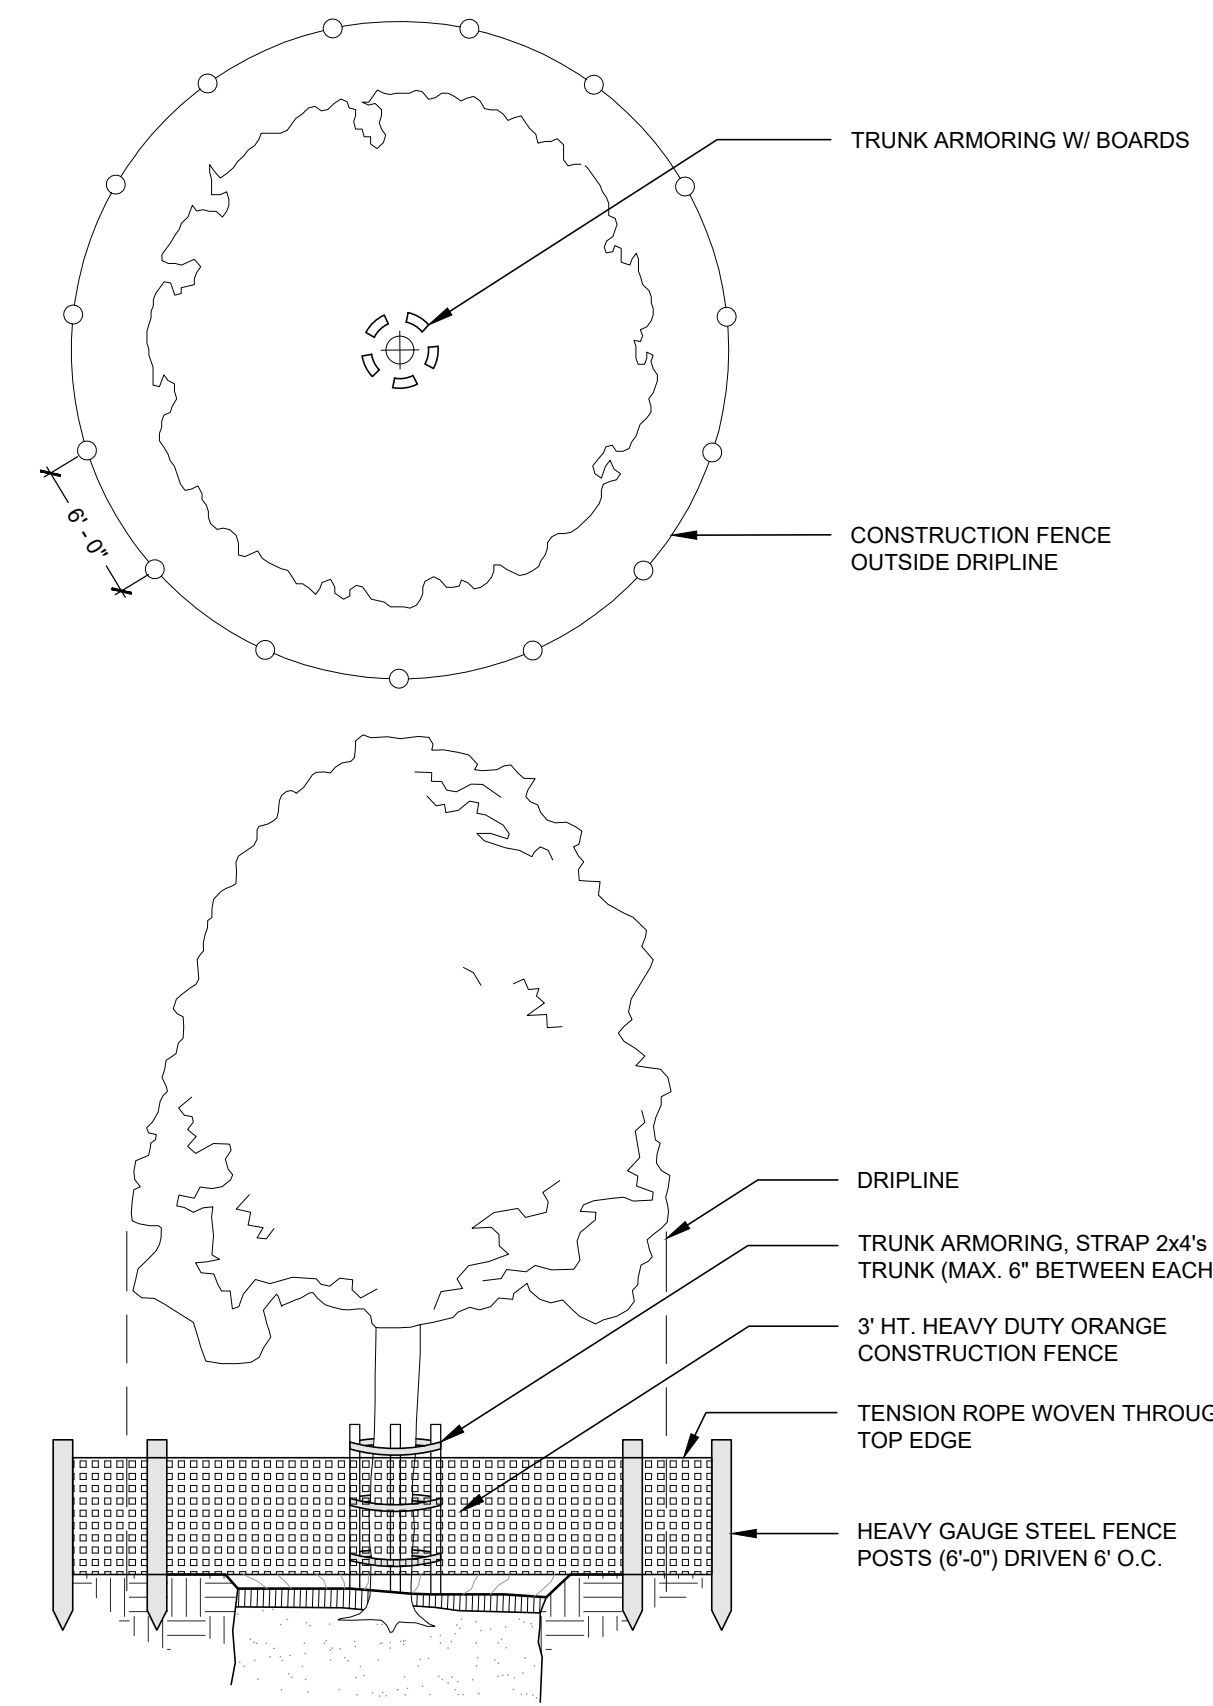

Tree Protection

Not to Scale

©IRONWOOD 2024 **1**
L1.1

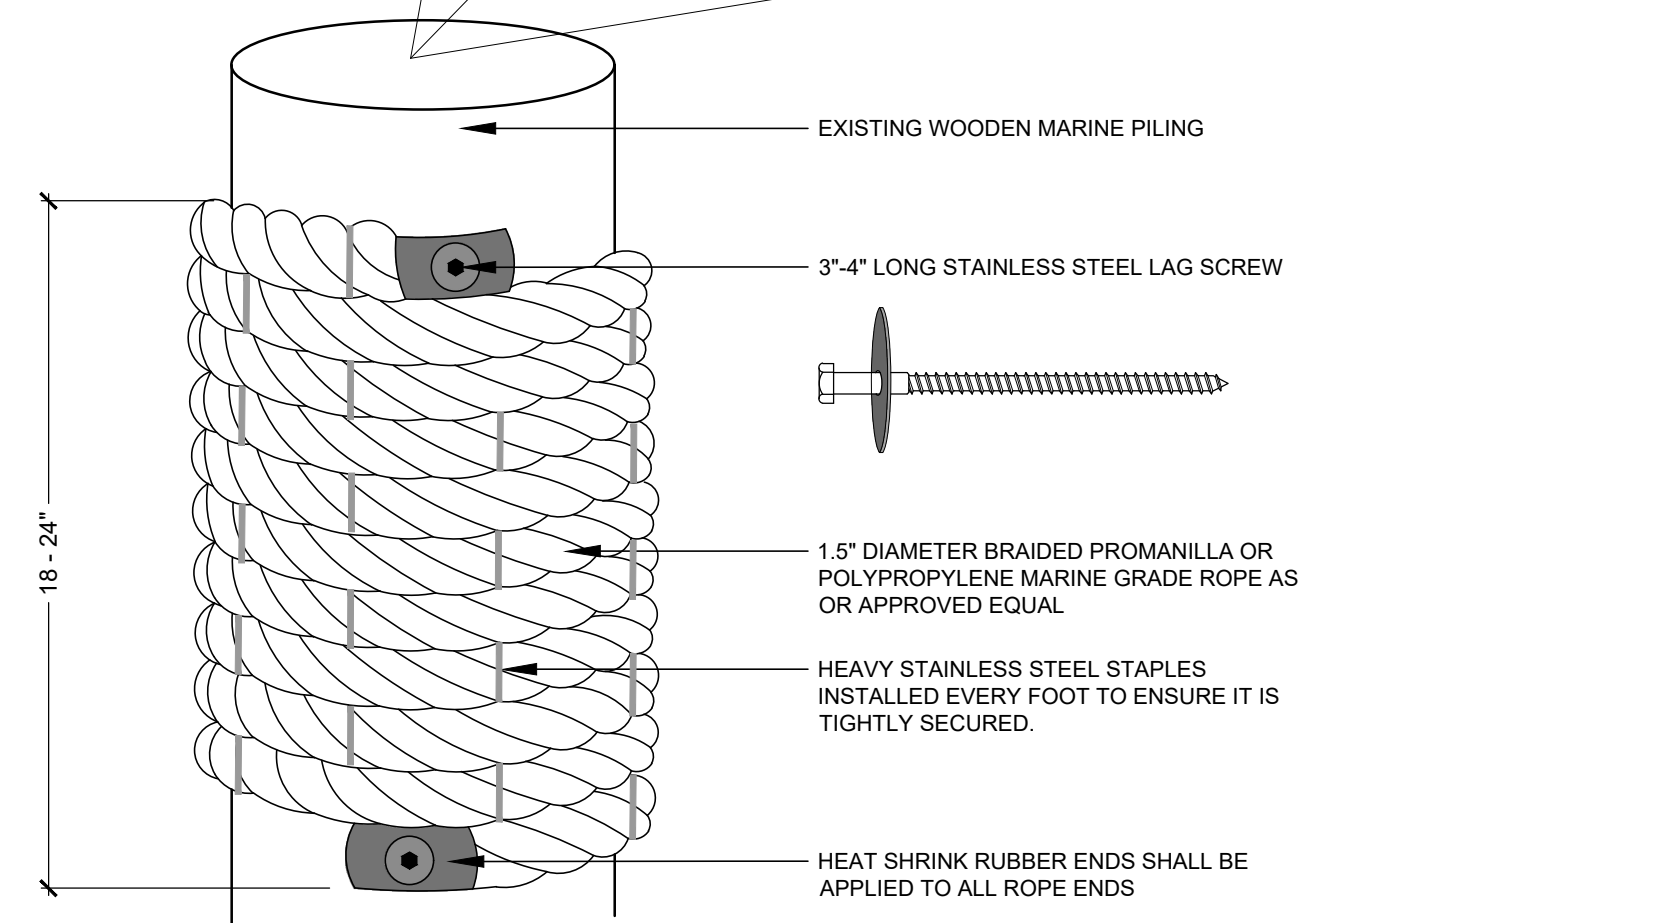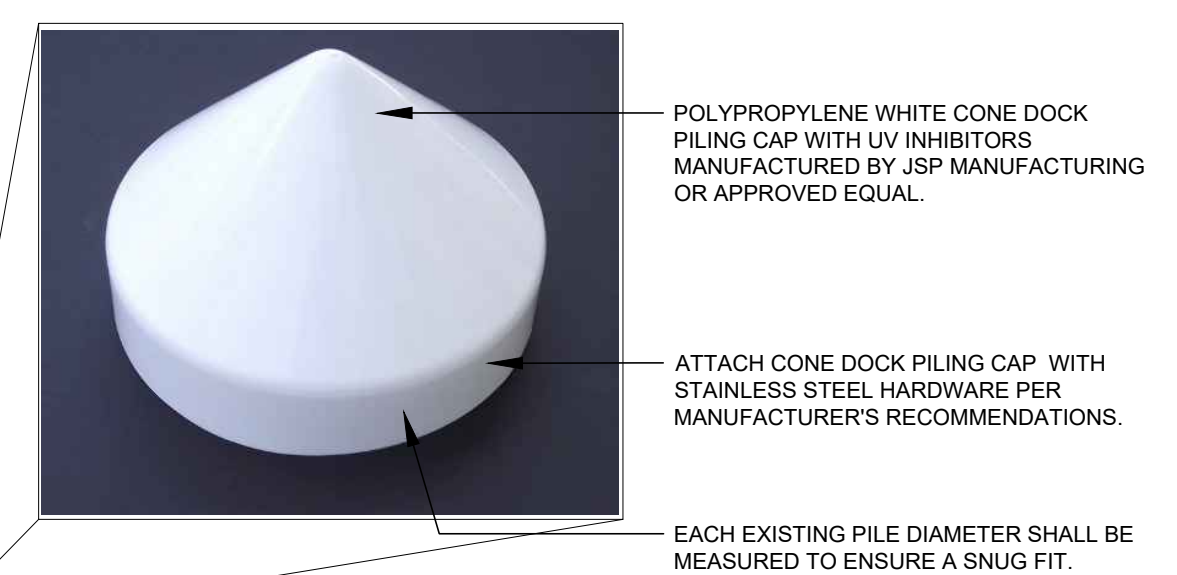

- NOTES:**
- FOURTEEN (14) SINGLE WOOD PILES ARE SLATED FOR ROPE INSTALLATION. THE CONTRACTOR SHALL CONFIRM WHICH PILES SHALL BE WRAPPED.
 - TWENTY (20) WOOD PILES SHALL BE CAPPED WITH CONE PILE CAPS.
 - EXISTING GROUPED PILES ALREADY WRAPPED, SHALL NOT RECEIVE NEW ROPE WRAPPING.
 - ASSUME APPROXIMATELY 50 LINEAR FEET OF ROPE PER PILE TO ACHIEVE 18-24" VERTICAL WRAPPING HEIGHT. CALCULATION BASED ON A 12" DIAMETER PILE WITH 24" OF VERTICAL WRAPPING.
 - VERTICAL COVERAGE OF WRAPPING WILL VARY DEPENDING ON DIAMETER OF THE PILE. ROPE SHALL BE CUT AT THE APPROPRIATE LENGTH WHERE THE VERTICAL WRAPPING HEIGHT REACHES BETWEEN 18-24" AND BOTH ENDS OF CUT ROPE SHALL BE RUBBERIZED.
 - ALL BOLTS, WASHERS, SCREWS, STAPLES, OR ANY OTHER ATTACHMENT HARDWARE SHALL BE STAINLESS STEEL. FASTENERS SHALL HAVE HEADS OF A TAMPER PROOF NATURE.

Rope Wrap on Existing Wood Pile (Add Alternate #5)






Not to Scale



©IRONWOOD 2024 **2**
L1.1

GENERAL NOTES:

1. SEE CIVIL DRAWINGS FOR INFORMATION NOT DEPICTED ON THE LANDSCAPE DRAWINGS, INCLUDING EXTENT OF DISTURBANCE / LIMIT OF WORK.
2. SEE L2.0, L3.0, AND CONSTRUCTION DETAILS FOR ADDITIONAL NOTES.
3. CONSTRUCTION ACTIVITIES SHALL NOT UNNECESSARILY IMPACT PARK OPERATIONS.
4. DAILY CONSTRUCTION COORDINATION WITH PARKS DEPARTMENT STAFF IS THE RESPONSIBILITY OF THE CONTRACTOR.
5. ALL ITEMS SLATED FOR DEMOLITION, REMOVAL, DISPOSAL, OR SALVAGE SHALL BE MARKED OR OTHERWISE IDENTIFIED IN THE FIELD. COORDINATION AND APPROVAL OF THE CITY REPRESENTATIVE SHALL BE OBTAINED PRIOR TO WORK.
6. ALL SURFACE AND SUBSURFACE MATERIALS (STONEDUST, GRAVEL, LOAM, ETC) TO BE REMOVED, SHALL BE EXCAVATED TO THE MINIMUM DEPTH REQUIRED FOR THE INSTALLATION OF PROPOSED IMPROVEMENTS. EXCAVATION AND REMOVAL DEPTHS VARY BASED ON ITEM TO BE INSTALLED. REFER TO CONSTRUCTION DETAILS.
7. ALL DISTURBED AREAS NOT IDENTIFIED FOR A SPECIFIC SURFACE TREATMENT SHALL BE LOAMED AND HYDO-SEEDED. SEE 6I.3.3.
8. ALL PLANT MATERIAL AND STUMPS IDENTIFIED FOR REMOVAL WILL BE DONE BY OTHERS PRIOR TO MOBILIZATION OF THE SELECTED CONTRACTOR FOR THIS PROJECT.
9. TOTAL QUANTITY OF EXISTING WOOD LIGHT POLES AND LUMINAIRES TO BE REMOVED AND DISPOSED OF: EIGHT (8). TOTAL QUANTITY OF NEW LIGHT POLES AND LUMINAIRES TO BE INSTALLED: NINE (9).
10. ALL EXISTING ELECTRICAL PULL BOXES (HANDHOLDS) AND CONDUIT SHALL BE REUSED. TWO (2) NEW PULL BOXES WILL BE REQUIRED.
11. CONTACT DIGSAFE PRIOR TO BEGINNING WORK.
12. AN ELECTRONIC FILE OF THIS DRAWING WILL BE PROVIDED FOR CONTRACTOR LAYOUT PURPOSES.

Legend

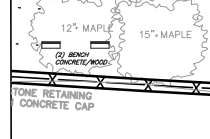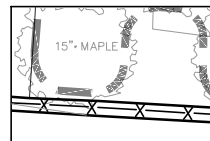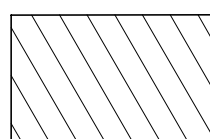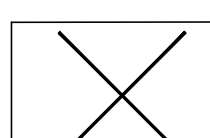-  EXISTING CONDITIONS
-  EXISTING TREE PROTECTION, SEE 1/L1.1 AND NOTES ON L3.0
-  REMOVE AND DISPOSE OF PAVEMENT AND SUBGRADE BASE MATERIALS (8" DEPTH MINIMUM)
-  REMOVE AND DISPOSE OF PLANT AND STUMP (BY OWNER)
-  SAWCUT PAVEMENT

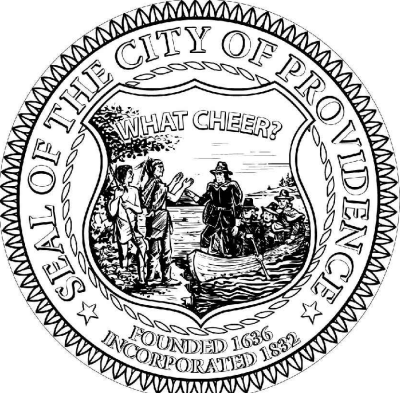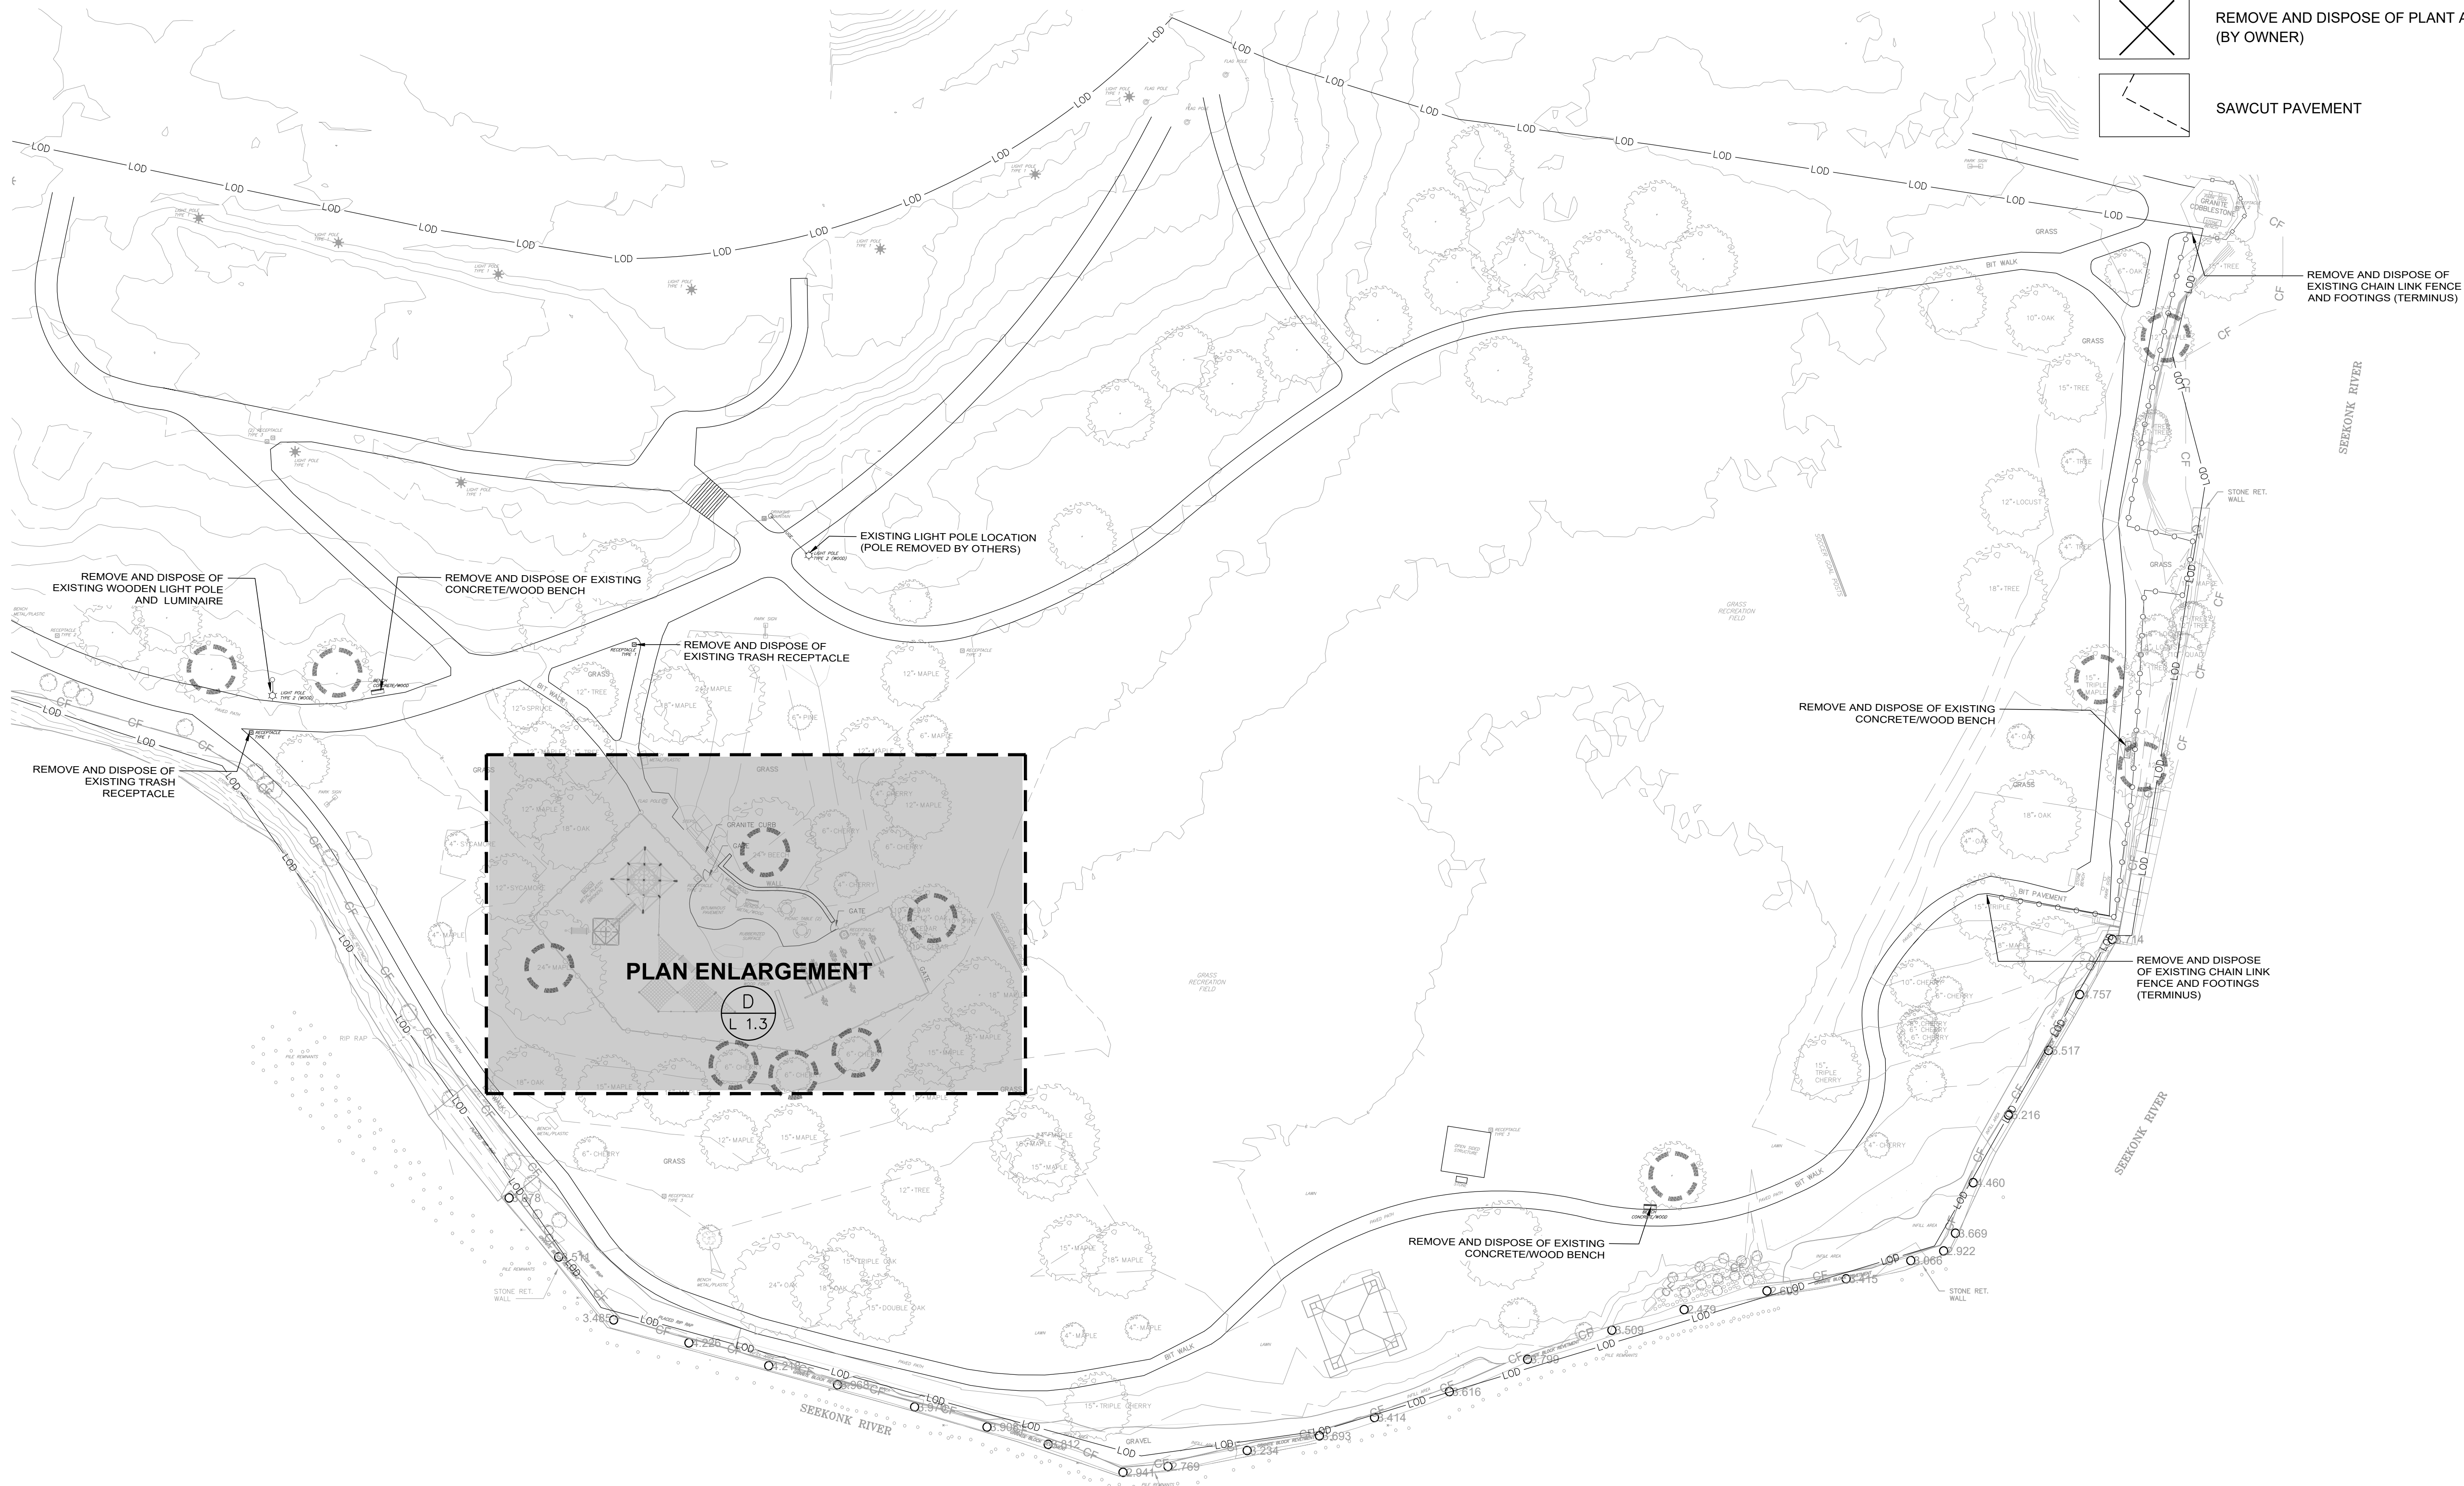

REV	DATE	DESCRIPTION

CLIENT:
PROVIDENCE PARKS DEPARTMENT
 DALRYMPLE BOATHOUSE, MAPLE AVE,
 PROVIDENCE, RI 02905


PROJECT:
SITE IMPROVEMENTS AT INDIA POINT PARK
 109 INDIA STREET
 PROVIDENCE, RI 02905

TITLE:
SITE PREPARATION PLAN

ISSUED FOR: BID
DATE: MARCH 25, 2024
SCALE: AS NOTED
DRAWN BY: SWRIGHT, JHYLAND
CHECKED BY: JHYLAND, DJENSEN
WSP PROJECT NO.: 365221616

L 1.2

C | PLAN ENLARGEMENT
 1"=30'-0"

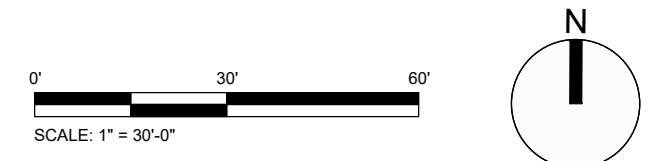



REV	DATE	DESCRIPTION

CLIENT:
PROVIDENCE PARKS DEPARTMENT
 DALRYMPLE BOATHOUSE, MAPLE AVE,
 PROVIDENCE, RI 02905


PROJECT:
SITE IMPROVEMENTS AT INDIA POINT PARK
 103 INDIA STREET
 PROVIDENCE, RI 02905

TITLE:
LANDSCAPE LAYOUT & MATERIALS PLAN

ISSUED FOR: BID
 DATE: MARCH 25, 2024
 SCALE: AS NOTED
 DRAWN BY: SWRIGHT, JHYLAND
 CHECKED BY: JHYLAND, DJENSEN
 WSP PROJECT NO: 3652210316

Legend

	BITUMINOUS PAVEMENT
	CONCRETE PAVER • BORDER SOLDIER COURSE - IDEAL ANDOVER 5511 • RUNNING BOND FIELD - IDEAL STRAIGHTLINE
	GRANITE PAVER (2'x2'x4" CAPE NEDDICK) BORDERED BY CONCRETE PAVERS • RUNNING BOND BAND - IDEAL ANDOVER 5511 • HERRINGBONE FIELD - IDEAL ANDOVER 5511
	COBBLESTONE BORDER (SALVAGED COBBLESTONE)
	4" SCH40 PVC SLEEVE (CAP ENDS AND DRIVE REBAR TO AID IN LOCATING)
	GRANITE BOLLARD
	HEAVY TIMBER PICNIC TABLE (ON CONCRETE PAVEMENT PAD)
	6' PICNIC TABLE (ON CONCRETE PAVEMENT PAD)
	WOOD AND GRANITE BENCH (ON CONCRETE PAVEMENT PAD) (ADD ALTERNATE #3)
	6' BENCH (ON CONCRETE PAVEMENT PAD)
	TRASH RECEPTACLE WITH DOME LID (ON 30"x30" CONCRETE PAVEMENT PAD)
	WELDED WIRE FENCE
	WOOD GUARDRAIL
	AREA LIGHT
	BOULDERS
	DECIDUOUS TREE

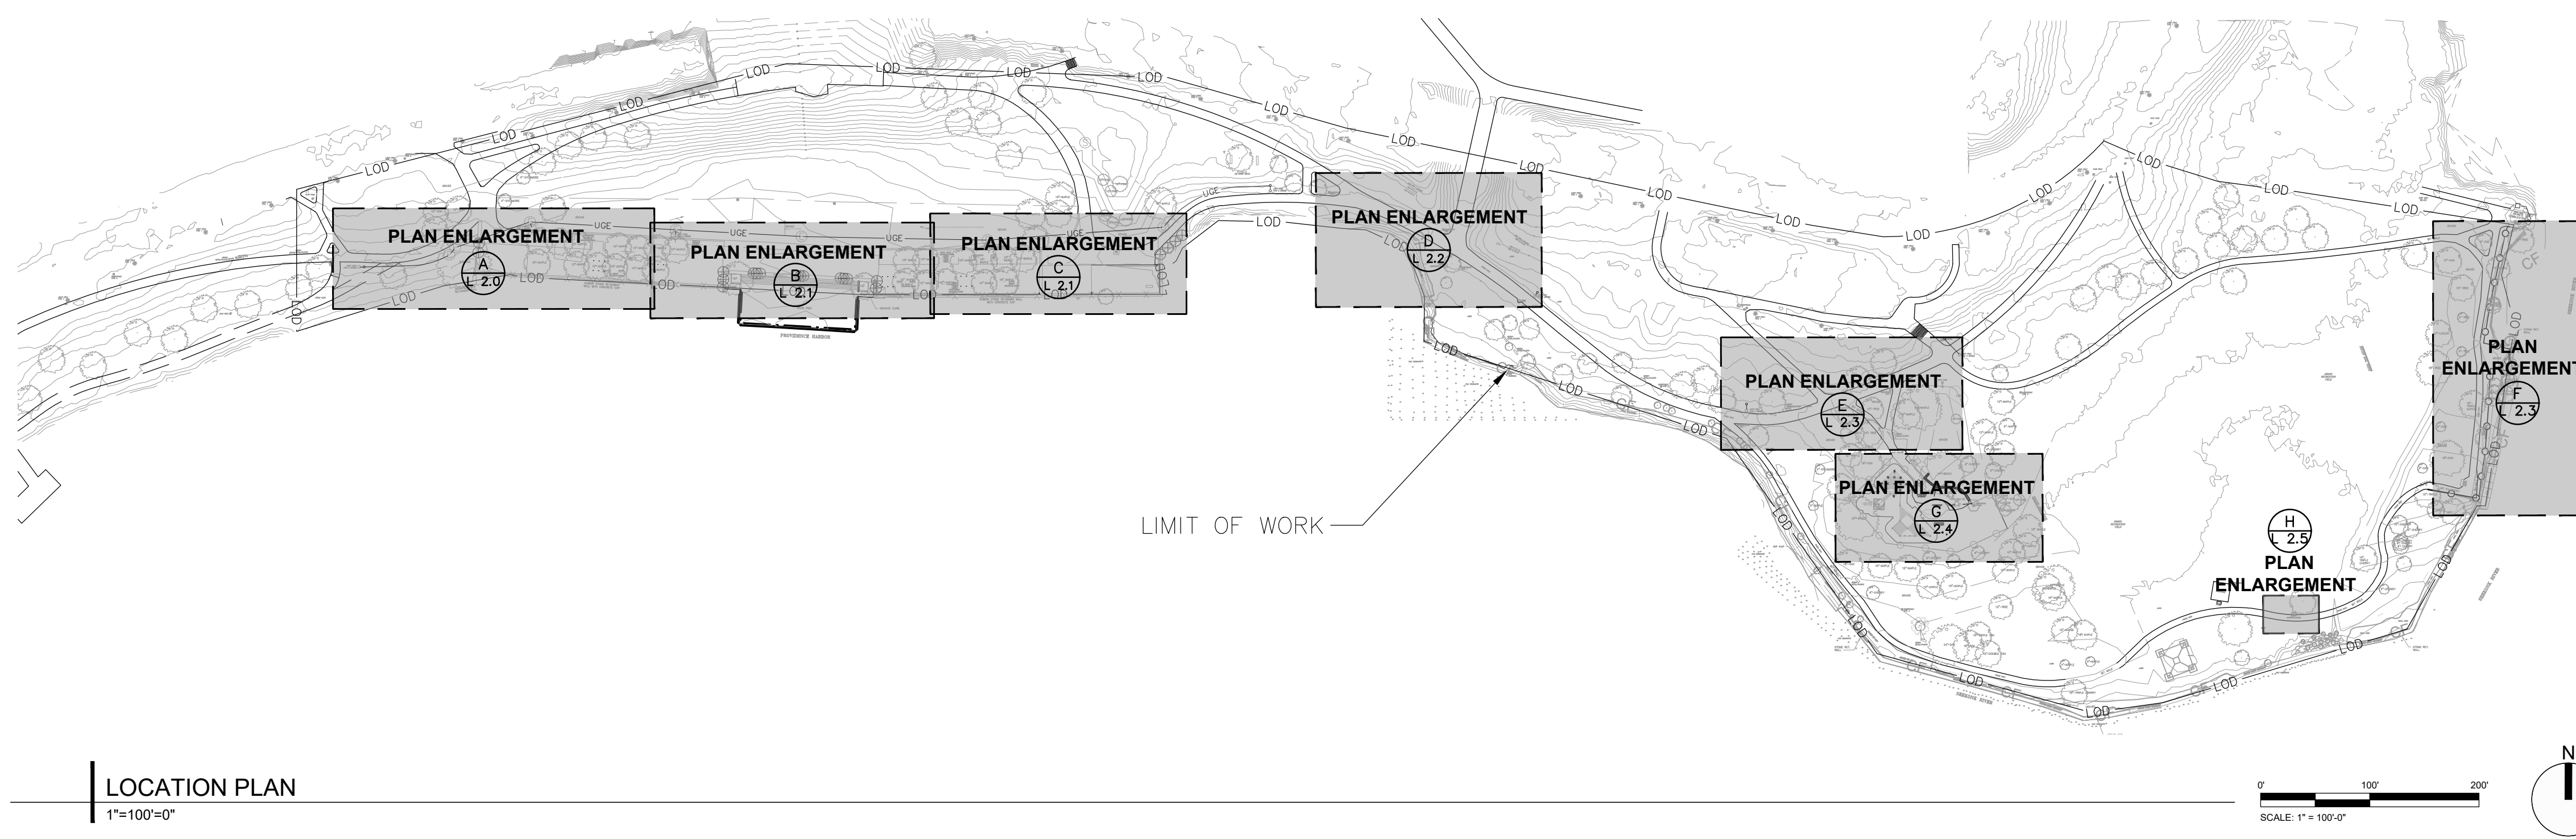

LOCATION PLAN
 1"=100'-0"

Plant Schedule


DECIDUOUS SHADE TREES						
QTY.	ABRV.	SCIENTIFIC NAME	COMMON NAME	SIZE	APPROX. SIZE AT MATURITY	REMARKS
3	GTH	GLEDITSIA TRICANTHOS 'INERMIS 'HALKA'	HALKA HONEYLOCUST	2 1/2"-3" CAL	30' HT x 30' SPD	B&B
5	NSG	NYSSA SYLVATICA 'GREEN GABLE'	GREEN GABLE TUPELO	2 1/2"-3" CAL	50' HT x 30' SPD	B&B
5	TCG	TILIA CORDATA 'GREENSPIRE'	GREENSPIRE LITTLELEAF LINDEN	2 1/2"-3" CAL	40' HT x 30' SPD	B&B
13						

ADD ALTERNATES LIST

- THE BASE BID WILL CONSIST OF NO WORK ASSOCIATED WITH THE ADD ALTERNATES LISTED.
- ADD ALTERNATE #1 - FURNISH AND INSTALL TWO (2) SWING BENCHES COMPLETE, IN PLACE AS DETAILED AND SPECIFIED. CONCRETE PAVEMENT BELOW AND SURROUNDING THE SWING BENCHES (BUMP-OUT) SHALL BE INCLUDED IN THIS ADD ALTERNATE (SUBSIDIARY).
- ADD ALTERNATE #2 - FURNISH AND INSTALL PLAYGROUND IMPROVEMENTS COMPLETE, IN PLACE AS DETAILED AND SPECIFIED.
- ADD ALTERNATE #3 - FURNISH AND INSTALL NINE (9) WOOD AND GRANITE BENCHES COMPLETE, IN PLACE AS DETAILED AND SPECIFIED.
- ADD ALTERNATE #4 - FURNISH AND INSTALL CONCRETE UNIT PAVERS AS A POROUS PAVEMENT IN THE WATERFRONT PROMENADE AREA COMPLETE. IN PLACE AS DETAILED AND SPECIFIED. REFER TO LANDSCAPE PLANS. CONCRETE PAVERS SHALL BE SET WITH SPACERS, POROUS POLYMERIC SAND, AND POROUS PAVEMENT RESERVOIR COURSE AS DETAILED. THE PAVER TYPE AND PATTERN SHALL REMAIN UNCHANGED.
- ADD ALTERNATE #5 - PILE CAPS AND ROPE WRAP ON EXISTING WOOD PILES COMPLETE, IN PLACE AS DETAILED. REFER TO 2/L1.1


GENERAL NOTES:


- F+I - ALL ITEMS IDENTIFIED ON THE PLANS ARE TO BE FURNISHED AND INSTALLED, COMPLETE IN PLACE BY THE CONTRACTOR UNLESS OTHERWISE STATED.
- ALL ITEMS IDENTIFIED ON THE PLANS AND IN THE SPECIFICATIONS TO BE FURNISHED BY THE CONTRACTOR SHALL BE APPROVED BY THE CITY REPRESENTATIVE PRIOR TO INSTALLATION.
- THE LAYOUT OF ALL PROPOSED ITEMS SHALL BE STAKED AND/OR MARKED-OUT IN THE FIELD FOR APPROVAL BY THE CITY REPRESENTATIVE PRIOR TO INSTALLATION.
- SEE CIVIL DRAWINGS FOR INFORMATION NOT DEPICTED ON THE LANDSCAPE DRAWINGS, INCLUDING EXTENT OF DISTURBANCE / LIMIT OF WORK.
- SEE L3.0 FOR ADDITIONAL NOTES.
- CONSTRUCTION ACTIVITIES SHALL NOT NECESSARILY IMPACT PARK OPERATIONS.
- ALL MATERIALS AND EQUIPMENT SHALL BE STORED WITHIN THE PROJECT LIMIT OF WORK IN A LOCATION APPROVED BY THE CITY REPRESENTATIVE.
- DAILY CONSTRUCTION COORDINATION WITH PARKS DEPARTMENT STAFF IS THE RESPONSIBILITY OF THE CONTRACTOR.
- ALL DISTURBED AREAS NOT IDENTIFIED FOR A SPECIFIC SURFACE TREATMENT SHALL BE LOAMED AND SEEDED, SEE 6/L3.3
- CONTACT DIGSAFE PRIOR TO BEGINNING WORK.
- AN ELECTRONIC FILE OF THIS DRAWING WILL BE PROVIDED FOR CONTRACTOR LAYOUT PURPOSES.

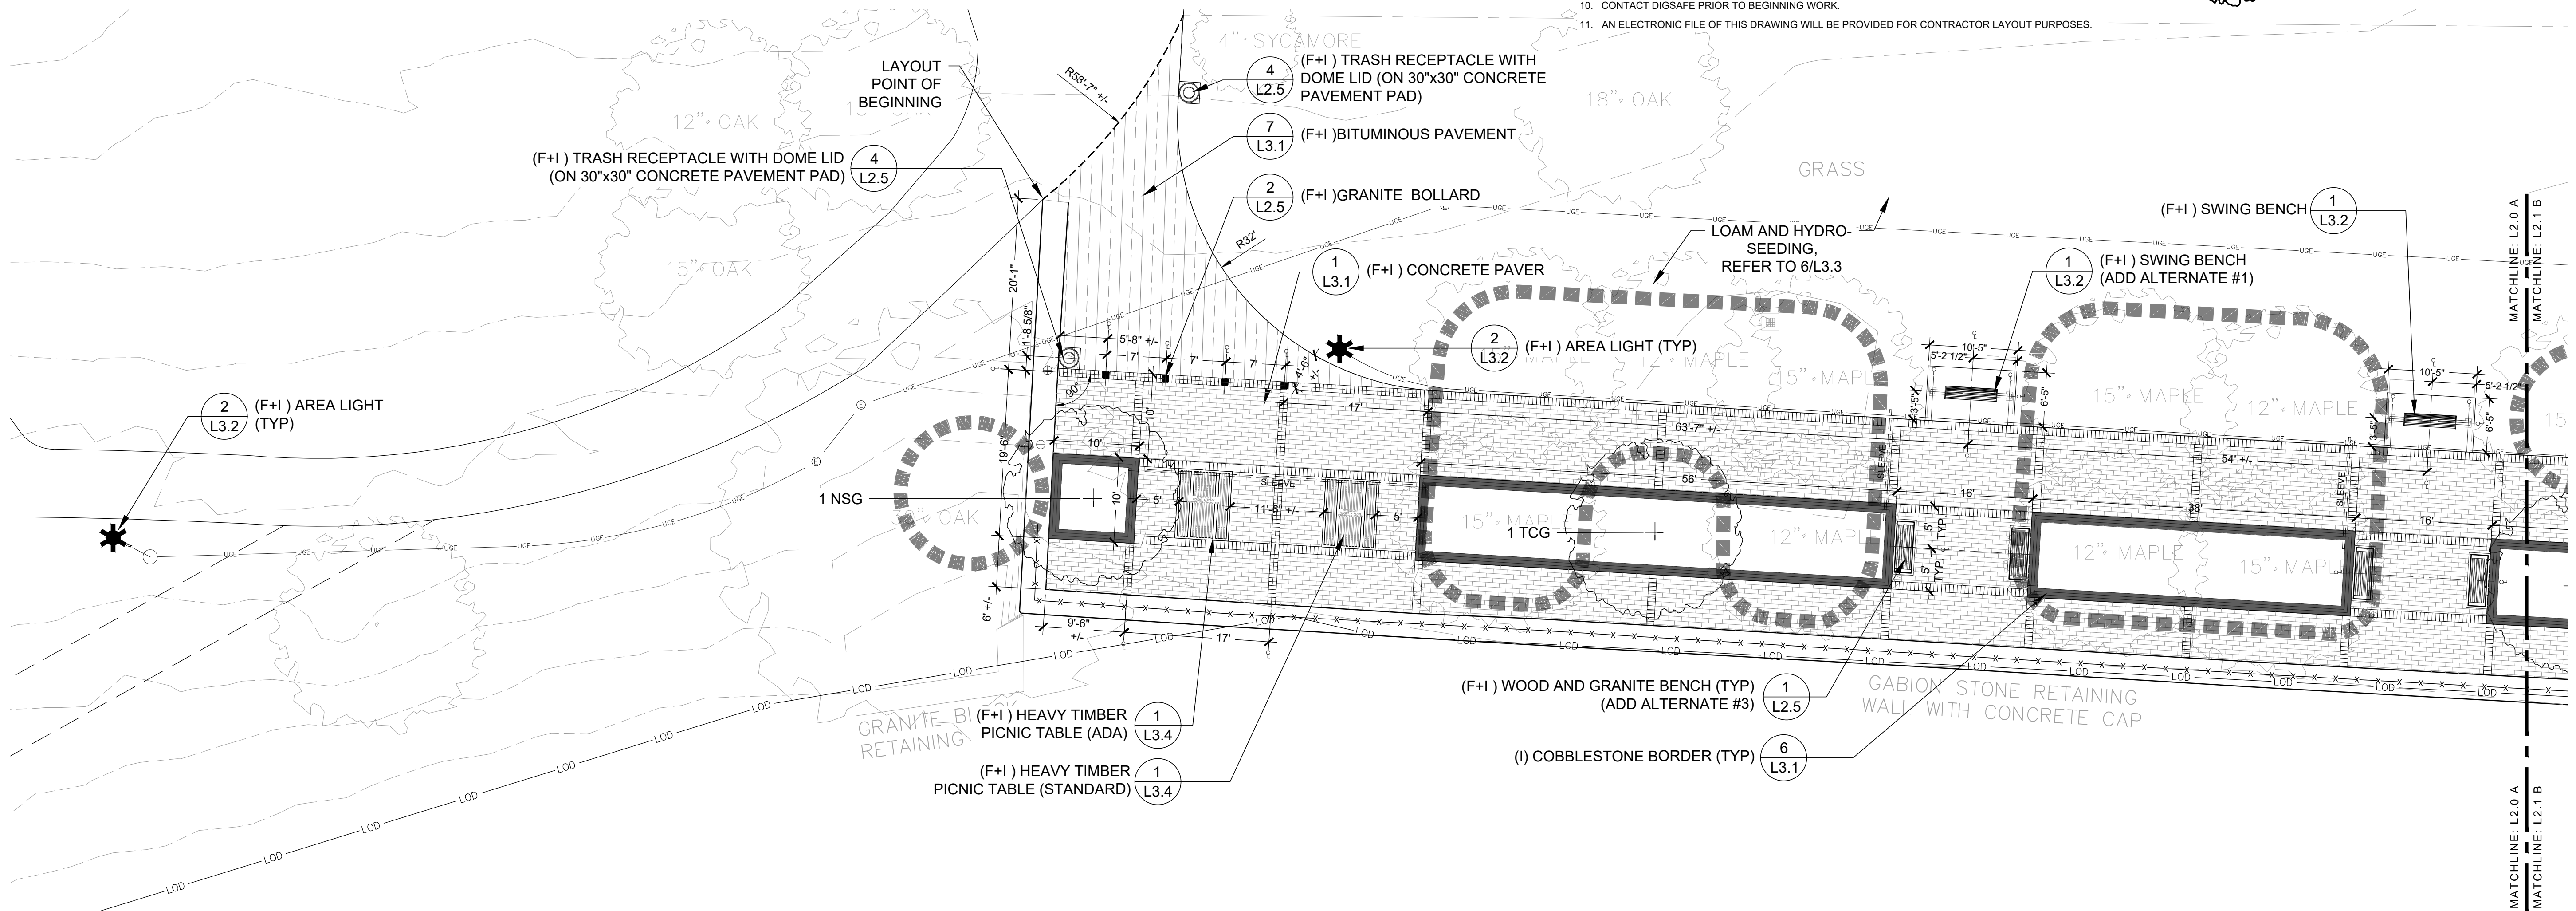

A | PLAN ENLARGEMENT
 1"=10'-0"

SCALE: 1"=10'-0"

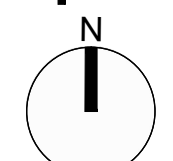



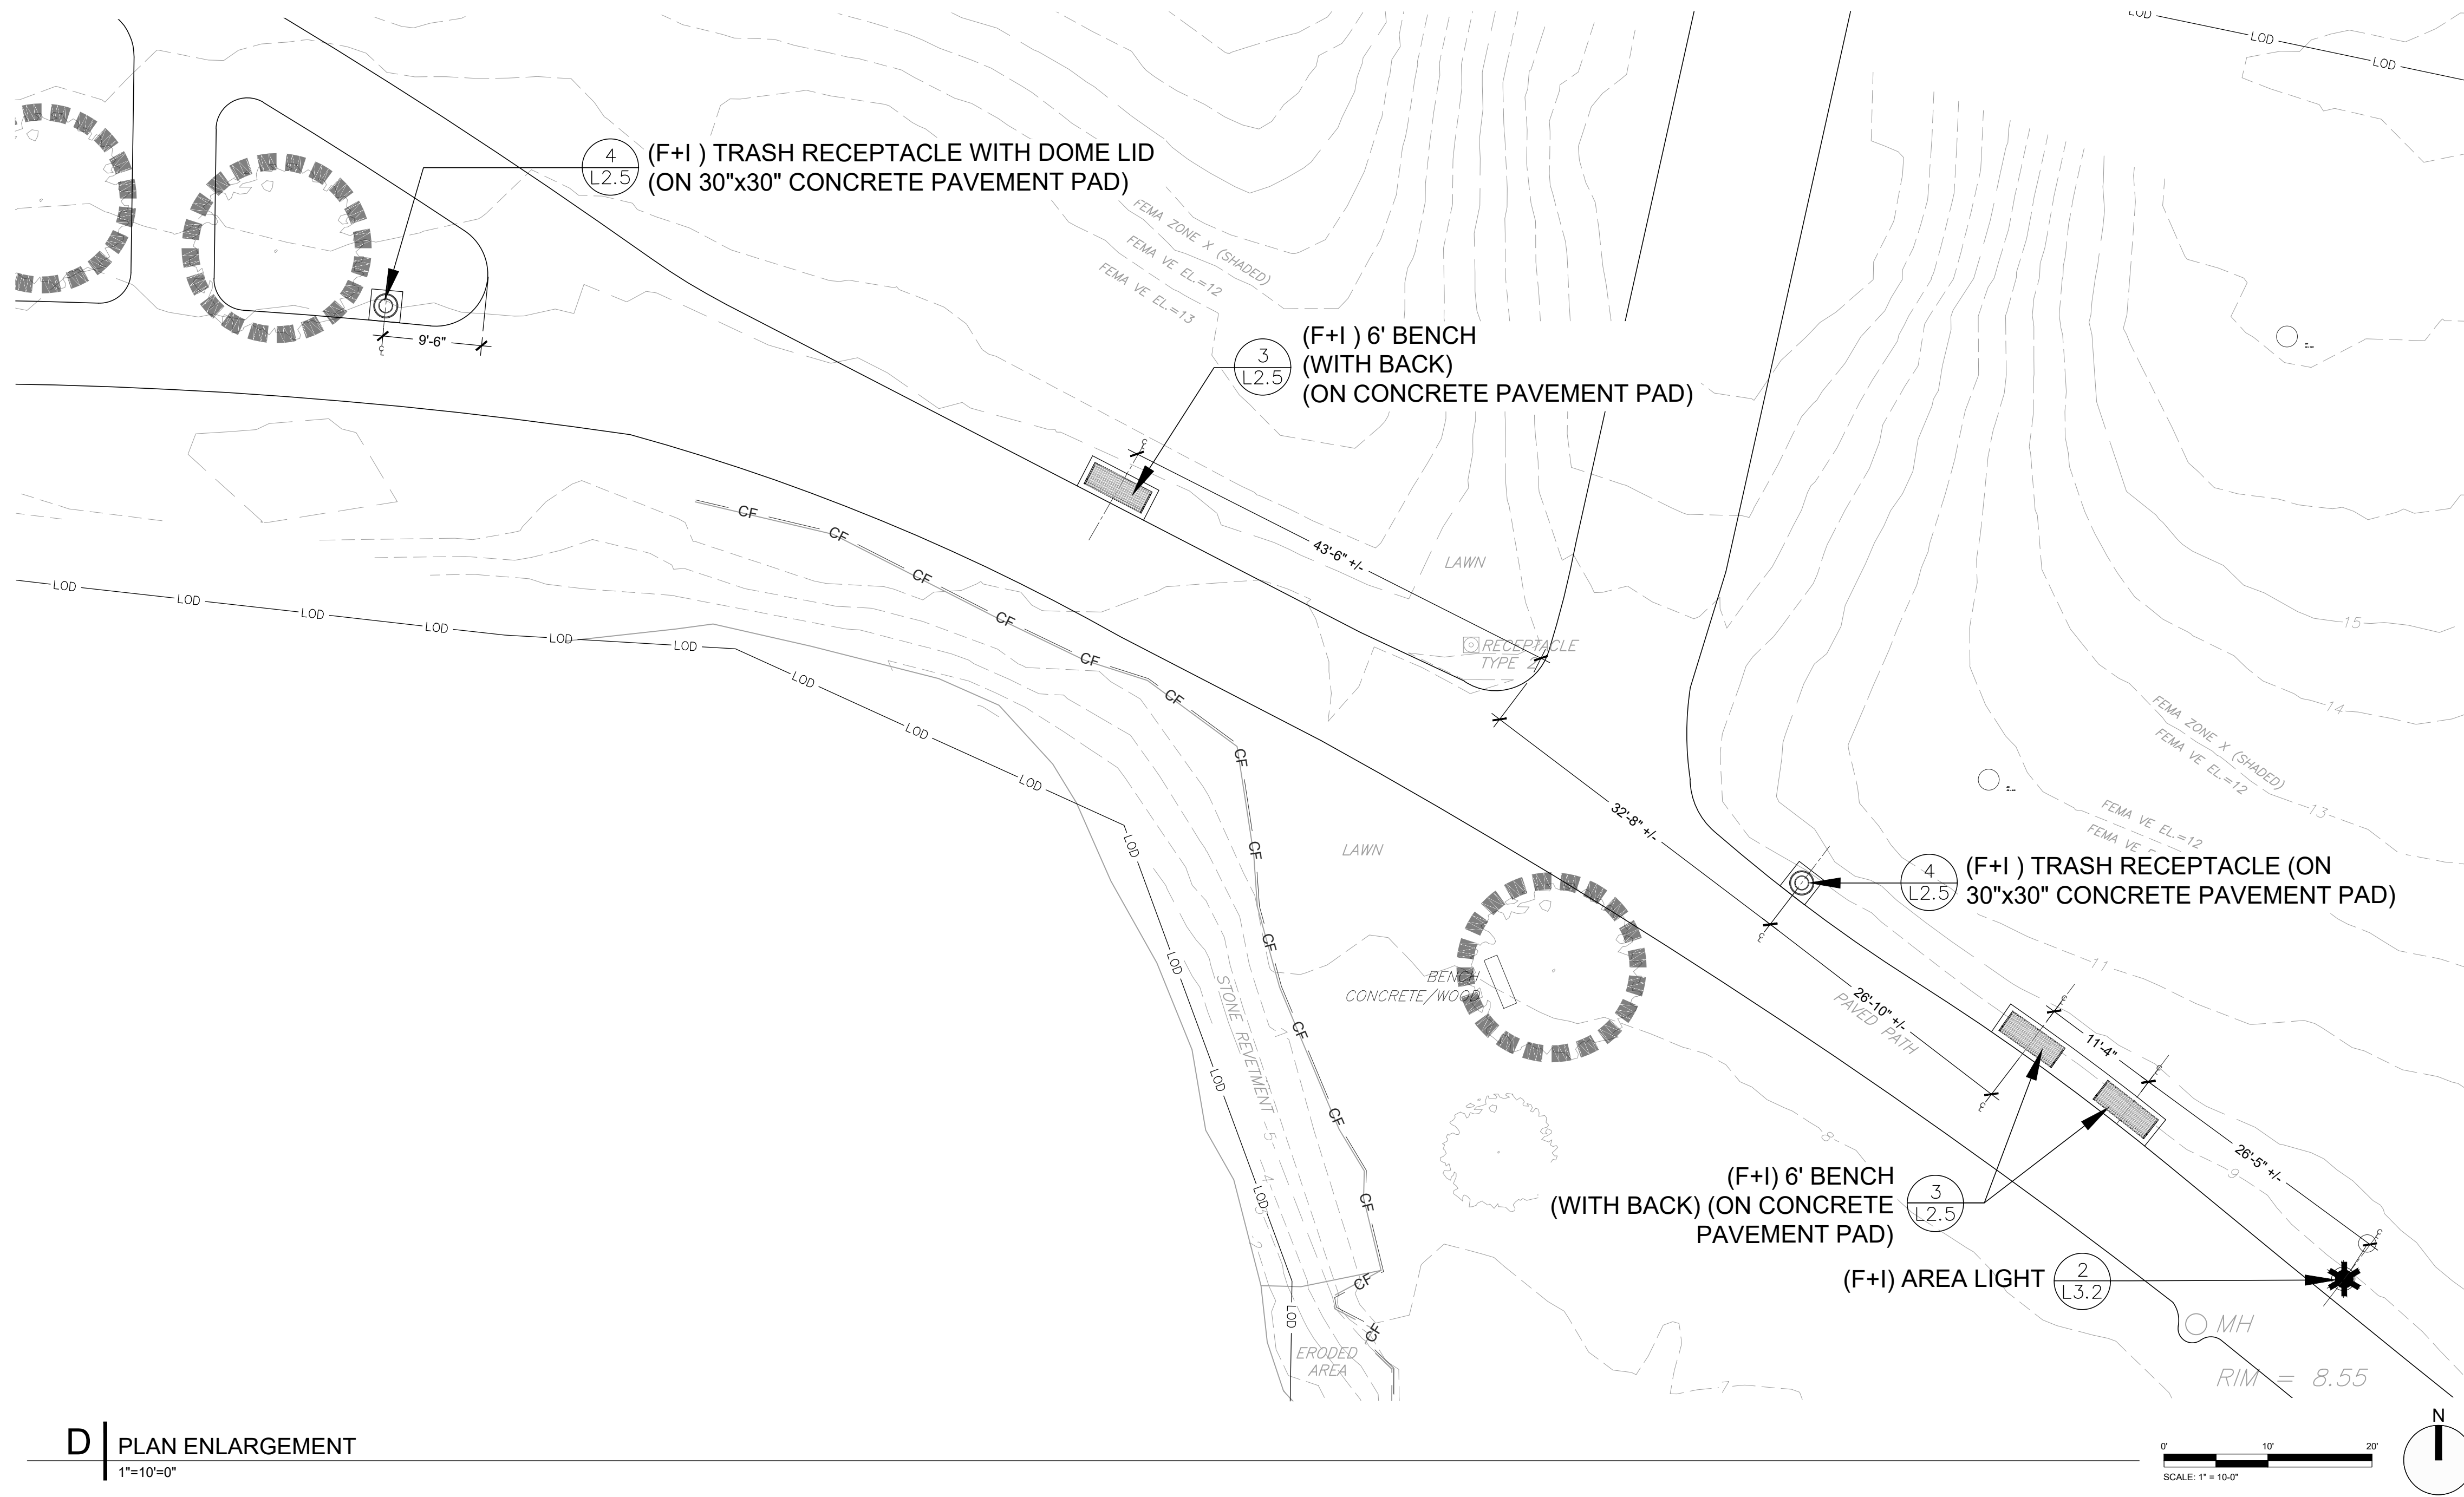


Legend

- 7 L3.1 BITUMINOUS PAVEMENT
- 1 L3.1 CONCRETE PAVER
 - BORDER SOLDIER COURSE - IDEAL ANDOVER 5511
 - RUNNING BOND FIELD - IDEAL STRAIGHTLINE
- 4 L3.1 GRANITE PAVER (2'x2'x4" CAPE NEDDICK)
 - BORDERED BY CONCRETE PAVERS
 - RUNNING BOND BAND - IDEAL ANDOVER 5511
 - HERRINGBONE FIELD - IDEAL ANDOVER 5511
- 6 L3.1 COBBLESTONE BORDER (SALVAGED COBBLESTONE)
- SLEEVE 4" SCH40 PVC SLEEVE (CAP ENDS AND DRIVE REBAR TO AID IN LOCATING)
- 2 L2.5 GRANITE BOLLARD
- 1 L3.4 HEAVY TIMBER PICNIC TABLE (ON CONCRETE PAVEMENT PAD)
- 1 L2.2 6' PICNIC TABLE (ON CONCRETE PAVEMENT PAD)
- 1 L2.5 WOOD AND GRANITE BENCH (ON CONCRETE PAVEMENT PAD) (ADD ALTERNATE #3)
- 3 L2.5 6' BENCH (ON CONCRETE PAVEMENT PAD)
- 4 L2.5 TRASH RECEPTACLE WITH DOME LID (ON 30"x30" CONCRETE PAVEMENT PAD)
- 2 L3.3 WELDED WIRE FENCE
- 3 L3.3 WOOD GUARDRAIL
- 2 L3.2 AREA LIGHT
- 4 L3.3 BOULDERS

- GENERAL NOTES:**
- F+I - ALL ITEMS IDENTIFIED ON THE PLANS ARE TO BE FURNISHED AND INSTALLED. COMPLETE IN PLACE BY THE CONTRACTOR UNLESS OTHERWISE STATED.
 - ALL ITEMS IDENTIFIED ON THE PLANS AND IN THE SPECIFICATIONS TO BE FURNISHED BY THE CONTRACTOR SHALL BE APPROVED BY THE CITY REPRESENTATIVE PRIOR TO INSTALLATION.
 - THE LAYOUT OF ALL PROPOSED ITEMS SHALL BE STAKED AND/OR MARKED-OUT IN THE FIELD FOR APPROVAL BY THE CITY REPRESENTATIVE PRIOR TO INSTALLATION.
 - SEE CIVIL DRAWINGS FOR INFORMATION NOT DEPICTED ON THE LANDSCAPE DRAWINGS, INCLUDING EXTENT OF DISTURBANCE / LIMIT OF WORK.
 - SEE L3.0 FOR ADDITIONAL NOTES.
 - CONSTRUCTION ACTIVITIES SHALL NOT NECESSARILY IMPACT PARK OPERATIONS.
 - ALL MATERIALS AND EQUIPMENT SHALL BE STORED WITHIN THE PROJECT LIMIT OF WORK IN A LOCATION APPROVED BY THE CITY REPRESENTATIVE.
 - DAILY CONSTRUCTION COORDINATION WITH PARKS DEPARTMENT STAFF IS THE RESPONSIBILITY OF THE CONTRACTOR.
 - ALL DISTURBED AREAS NOT IDENTIFIED FOR A SPECIFIC SURFACE TREATMENT SHALL BE LOAMED AND SEED. SEE 613.3
 - CONTACT DIGSAFE PRIOR TO BEGINNING WORK.
 - AN ELECTRONIC FILE OF THIS DRAWING WILL BE PROVIDED FOR CONTRACTOR LAYOUT PURPOSES.

D PLAN ENLARGEMENT
1"=10'=0"

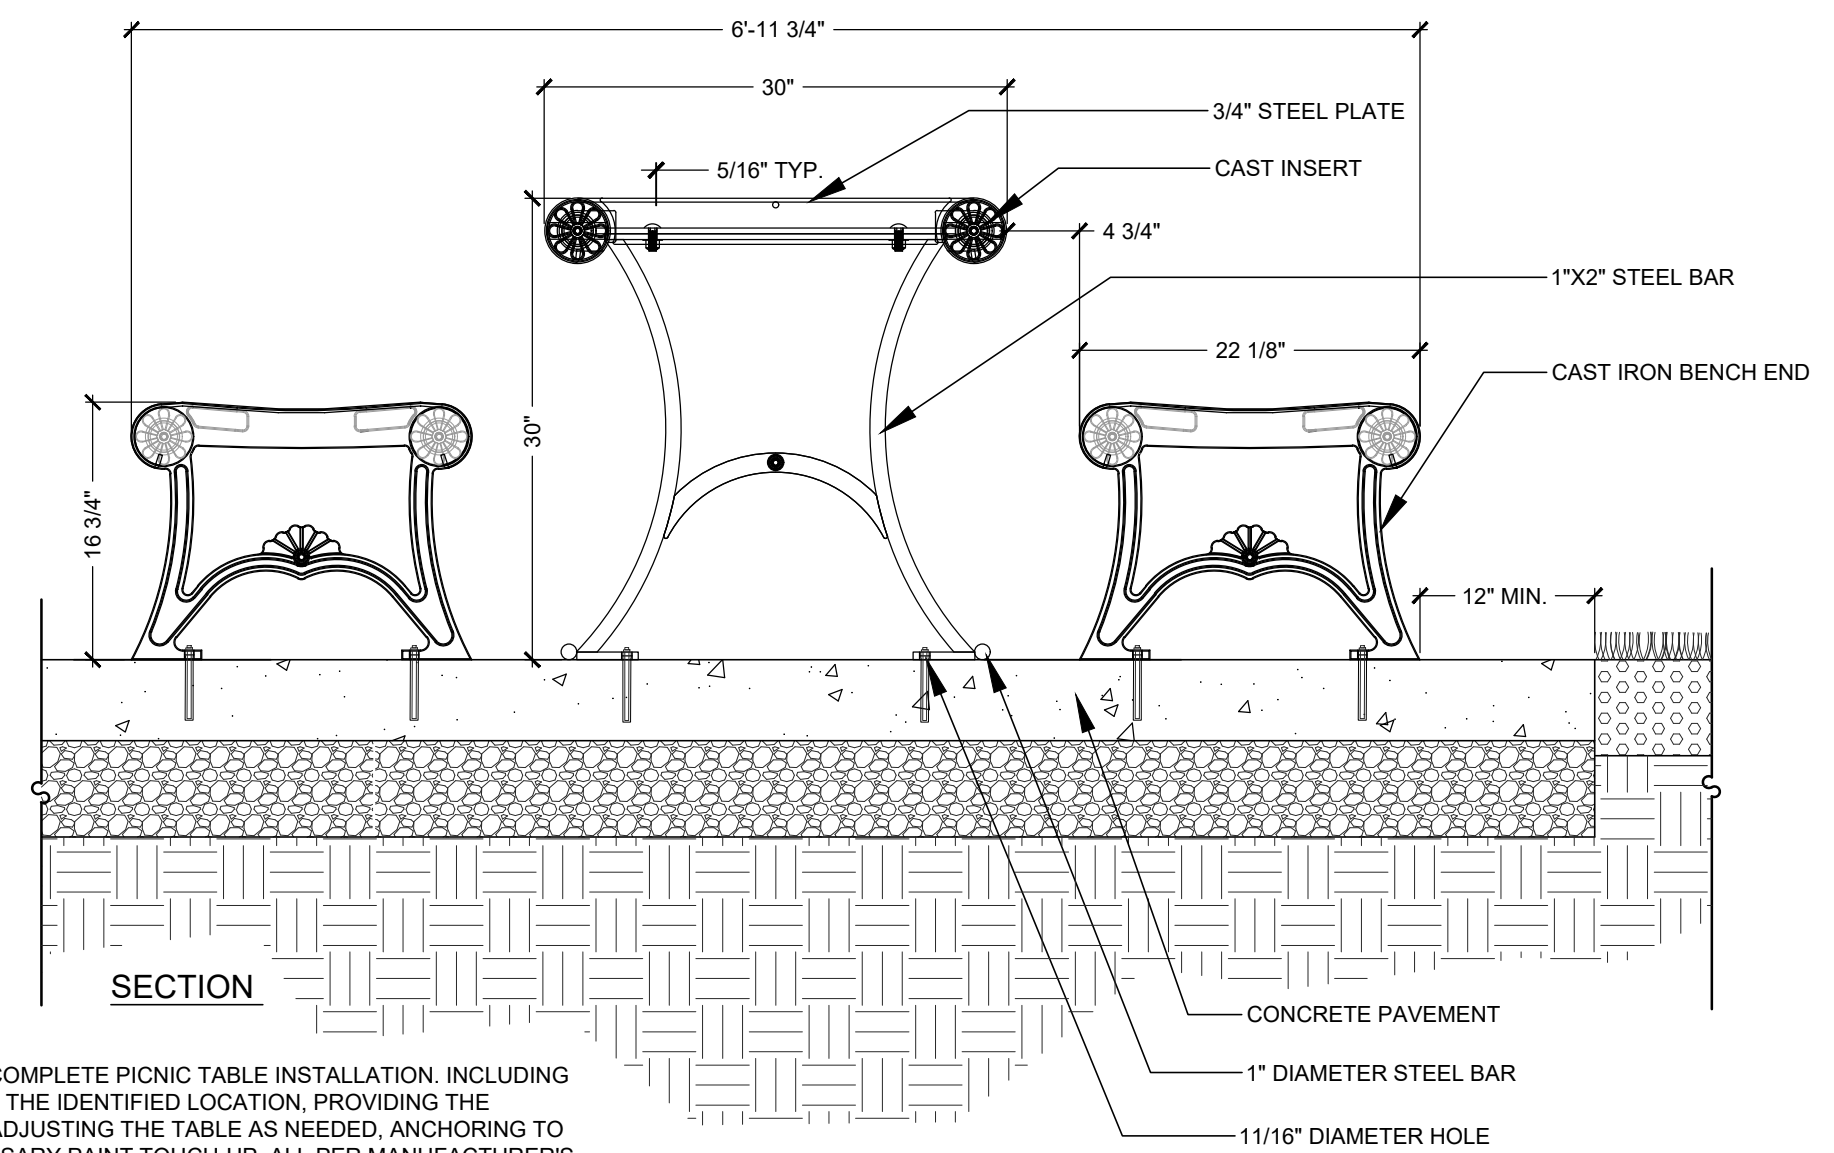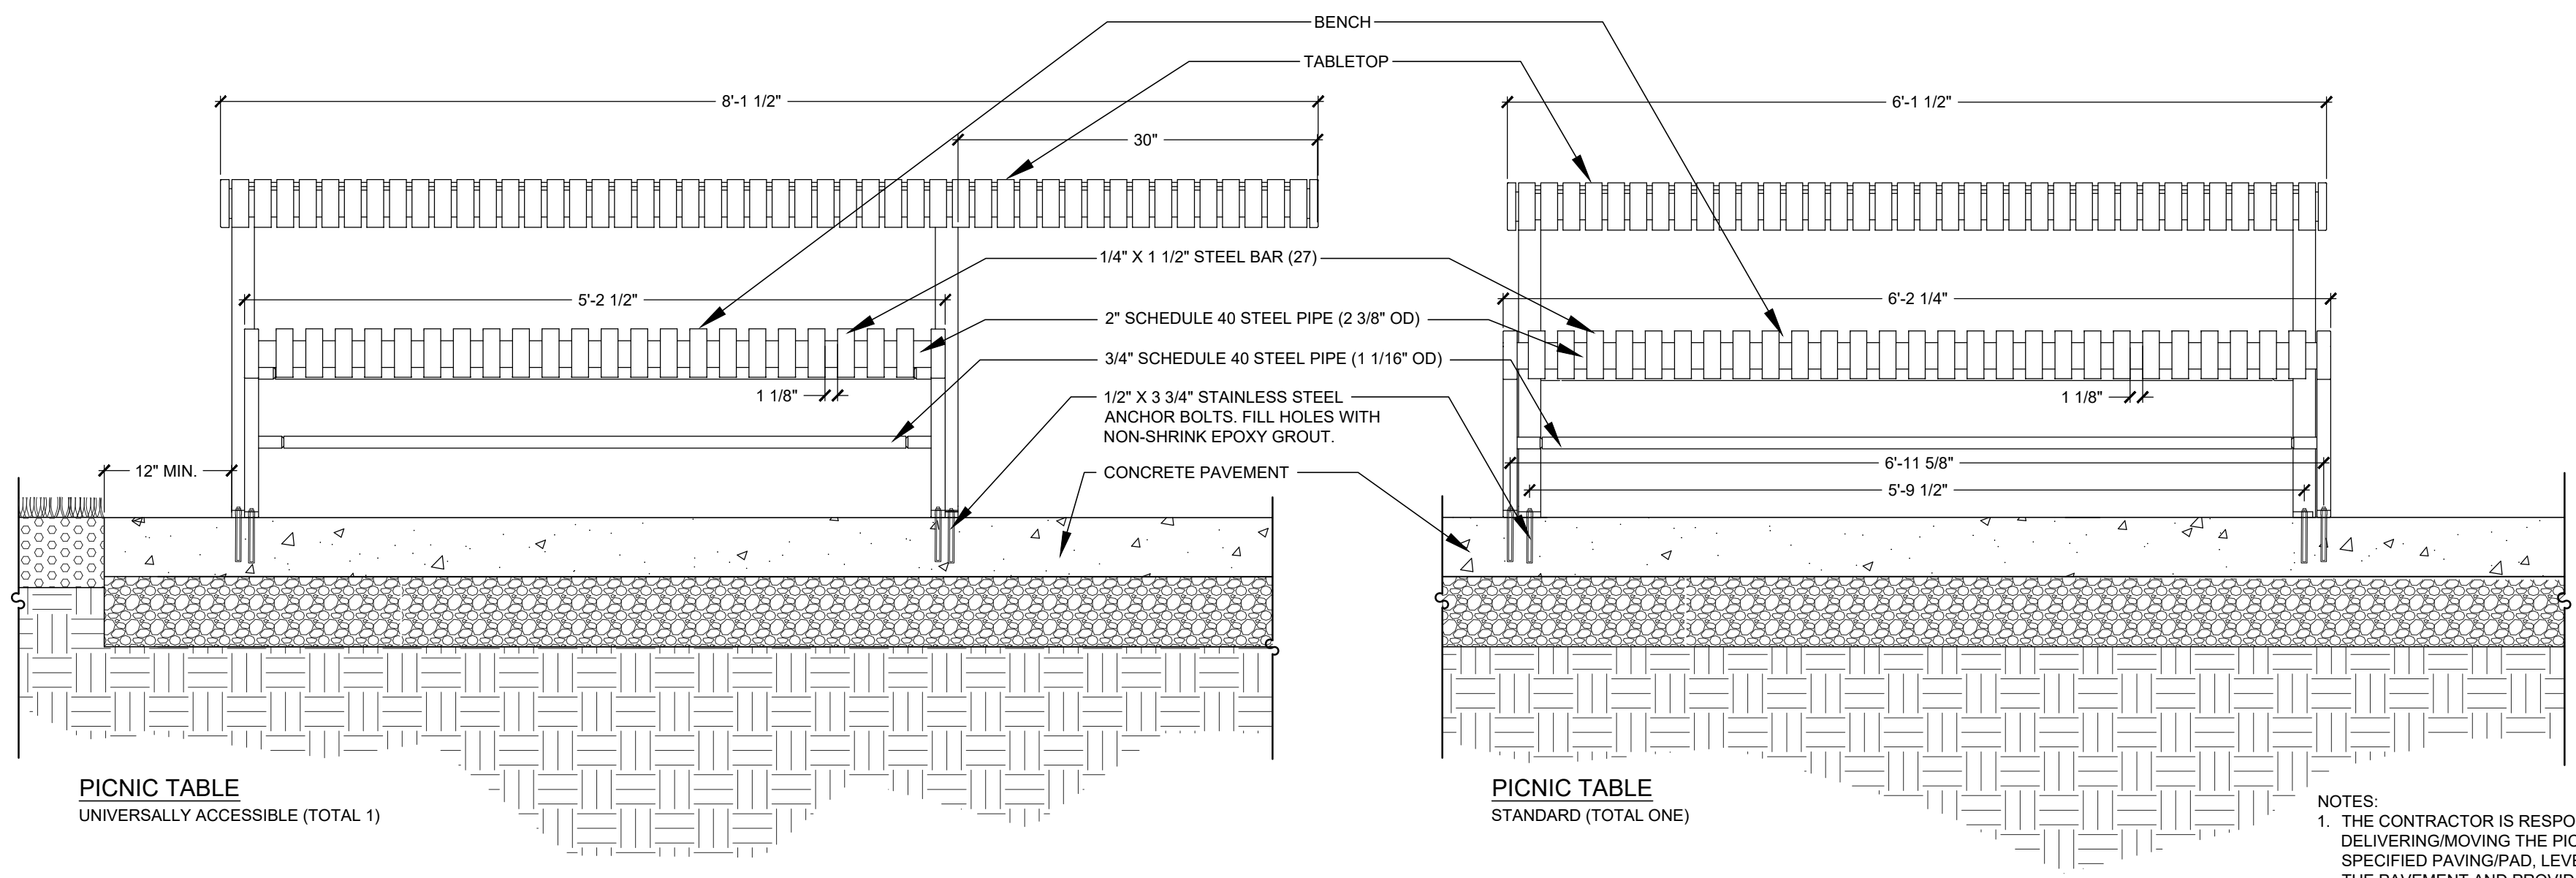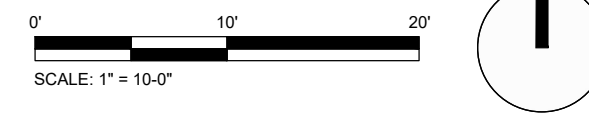

- NOTES:**
- THE CONTRACTOR IS RESPONSIBLE FOR A COMPLETE PICNIC TABLE INSTALLATION, INCLUDING DELIVERING/MOVING THE PICNIC TABLES TO THE IDENTIFIED LOCATION, PROVIDING THE SPECIFIED PAVING PAD, LEVELING AND/OR ADJUSTING THE TABLE AS NEEDED, ANCHORING TO THE PAVEMENT AND PROVIDING ANY NECESSARY PAINT TOUCH-UP. ALL PER MANUFACTURER'S SPECIFICATIONS OR AS DETAILED.
 - ALL STEEL TO BE COATED WITH ZINC RICH EPOXY THEN FINISHED WITH A POLYESTER POWDER COAT, COLOR BLACK.
 - PICNIC TABLE SHALL BE MANUFACTURED BY DUMOR, INC. MODEL 443-558-1/S-2 (ADA) & 443-62/S-2 (STANDARD 6').

Picnic Table (Part of Add Alternate #2)
Not to Scale

ISSUED FOR: BID
DATE: MARCH 25, 2024
SCALE: AS NOTED
DRAWN BY: S WRIGHT, J HYLAND
CHECKED BY: J HYLAND, D JENSEN
WSP PROJECT NO: 3652216316



REV	DATE	DESCRIPTION






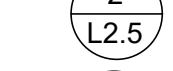
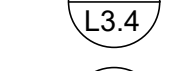
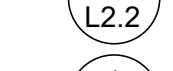
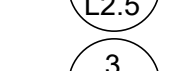
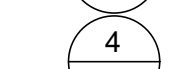
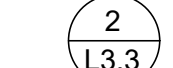
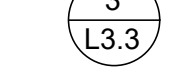
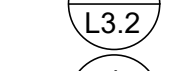


CLIENT: PROVIDENCE PARKS DEPARTMENT
DALRYMPLE BOATHOUSE, MAPLE AVE, PROVIDENCE, RI 02905


PROJECT: SITE IMPROVEMENTS AT INDIA POINT PARK
109 INDIA STREET
PROVIDENCE, RI 02905

TITLE: LANDSCAPE LAYOUT & MATERIALS PLAN & DETAILS

1 L2.2

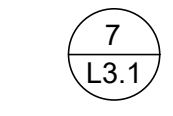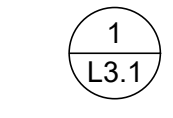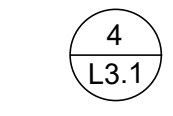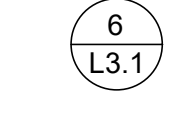Legend

-  BITUMINOUS PAVEMENT
-  CONCRETE PAVER
 - BORDER SOLDIER COURSE - IDEAL ANDOVER 5511
 - RUNNING BOND FIELD - IDEAL STRAIGHTLINE
-  GRANITE PAVER (2'x2'x4" CAPE NEDDICK)
 - BORDERED BY CONCRETE PAVERS
 - RUNNING BOND BAND - IDEAL ANDOVER 5511
 - HERRINGBONE FIELD - IDEAL ANDOVER 5511
-  COBBLESTONE BORDER (SALVAGED COBBLESTONE)
-  4" SCH40 PVC SLEEVE (CAP ENDS AND DRIVE REBAR TO AID IN LOCATING)
-  GRANITE BOLLARD
-  HEAVY TIMBER PICNIC TABLE (ON CONCRETE PAVEMENT PAD)
-  6" PICNIC TABLE (ON CONCRETE PAVEMENT PAD)
-  WOOD AND GRANITE BENCH (ON CONCRETE PAVEMENT PAD) (ADD ALTERNATE #3)
-  6" BENCH (ON CONCRETE PAVEMENT PAD)
-  TRASH RECEPTACLE WITH DOME LID (ON 30"x30" CONCRETE PAVEMENT PAD)
-  WELDED WIRE FENCE
-  WOOD GUARDRAIL
-  AREA LIGHT
-  BOULDERS

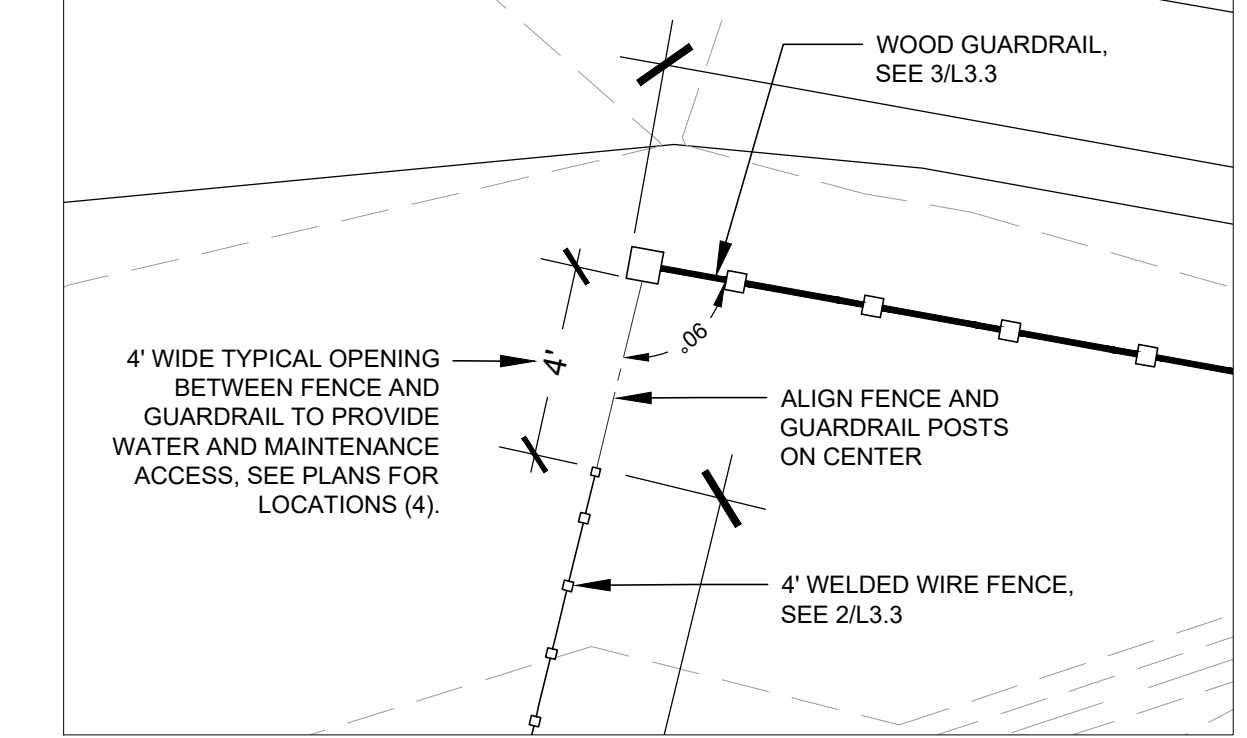


Access Point Enlargement

3"=1'-0"

©IRONWOOD 2024



1
L2.3

- GENERAL NOTES:**
1. F+I - ALL ITEMS IDENTIFIED ON THE PLANS ARE TO BE FURNISHED AND INSTALLED, COMPLETE IN PLACE BY THE CONTRACTOR UNLESS OTHERWISE STATED.
 2. ALL ITEMS IDENTIFIED ON THE PLANS AND IN THE SPECIFICATIONS TO BE FURNISHED BY THE CONTRACTOR SHALL BE APPROVED BY THE CITY REPRESENTATIVE PRIOR TO INSTALLATION.
 3. THE LAYOUT OF ALL PROPOSED ITEMS SHALL BE STAKED AND/OR MARKED-OUT IN THE FIELD FOR APPROVAL BY THE CITY REPRESENTATIVE PRIOR TO INSTALLATION.
 4. SEE CIVIL DRAWINGS FOR INFORMATION NOT DEPICTED ON THE LANDSCAPE DRAWINGS, INCLUDING EXTENT OF DISTURBANCE /LIMIT OF WORK.
 5. SEE L3.0 FOR ADDITIONAL NOTES.
 6. CONSTRUCTION ACTIVITIES SHALL NOT NECESSARILY IMPACT PARK OPERATIONS.
 7. ALL MATERIALS AND EQUIPMENT SHALL BE STORED WITHIN THE PROJECT LIMIT OF WORK IN A LOCATION APPROVED BY THE CITY REPRESENTATIVE.
 8. DAILY CONSTRUCTION COORDINATION WITH PARKS DEPARTMENT STAFF IS THE RESPONSIBILITY OF THE CONTRACTOR.
 9. ALL DISTURBED AREAS NOT IDENTIFIED FOR A SPECIFIC SURFACE TREATMENT SHALL BE LOAMED AND SEEDED, SEE 6/L3.3
 10. CONTACT DIGSAFE PRIOR TO BEGINNING WORK.
 11. AN ELECTRONIC FILE OF THIS DRAWING WILL BE PROVIDED FOR CONTRACTOR LAYOUT PURPOSES.

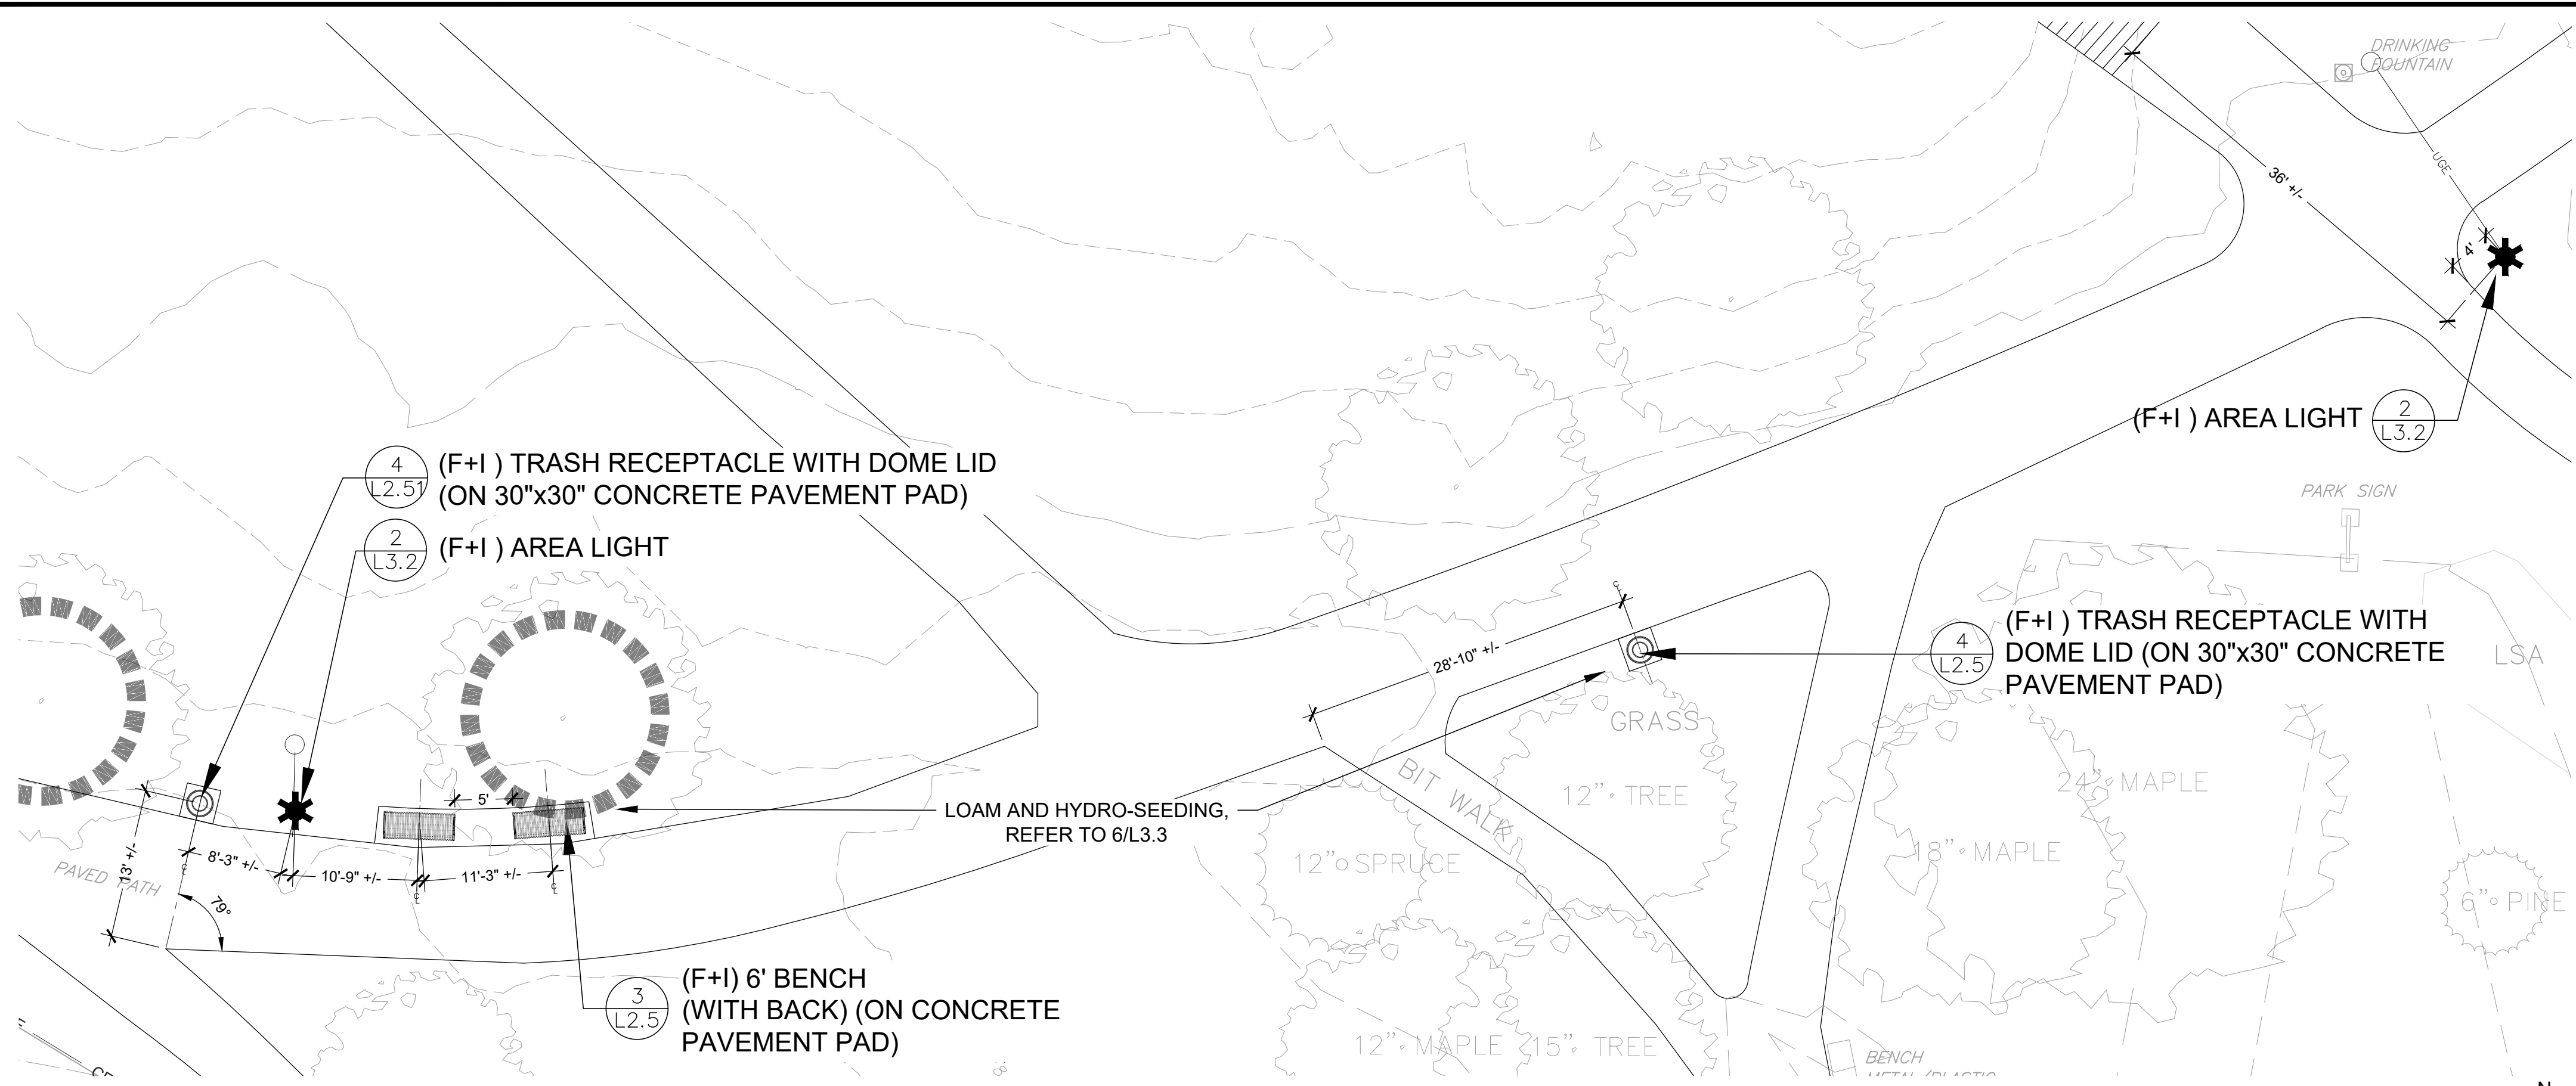



E PLAN ENLARGEMENT

1"=10'-0"

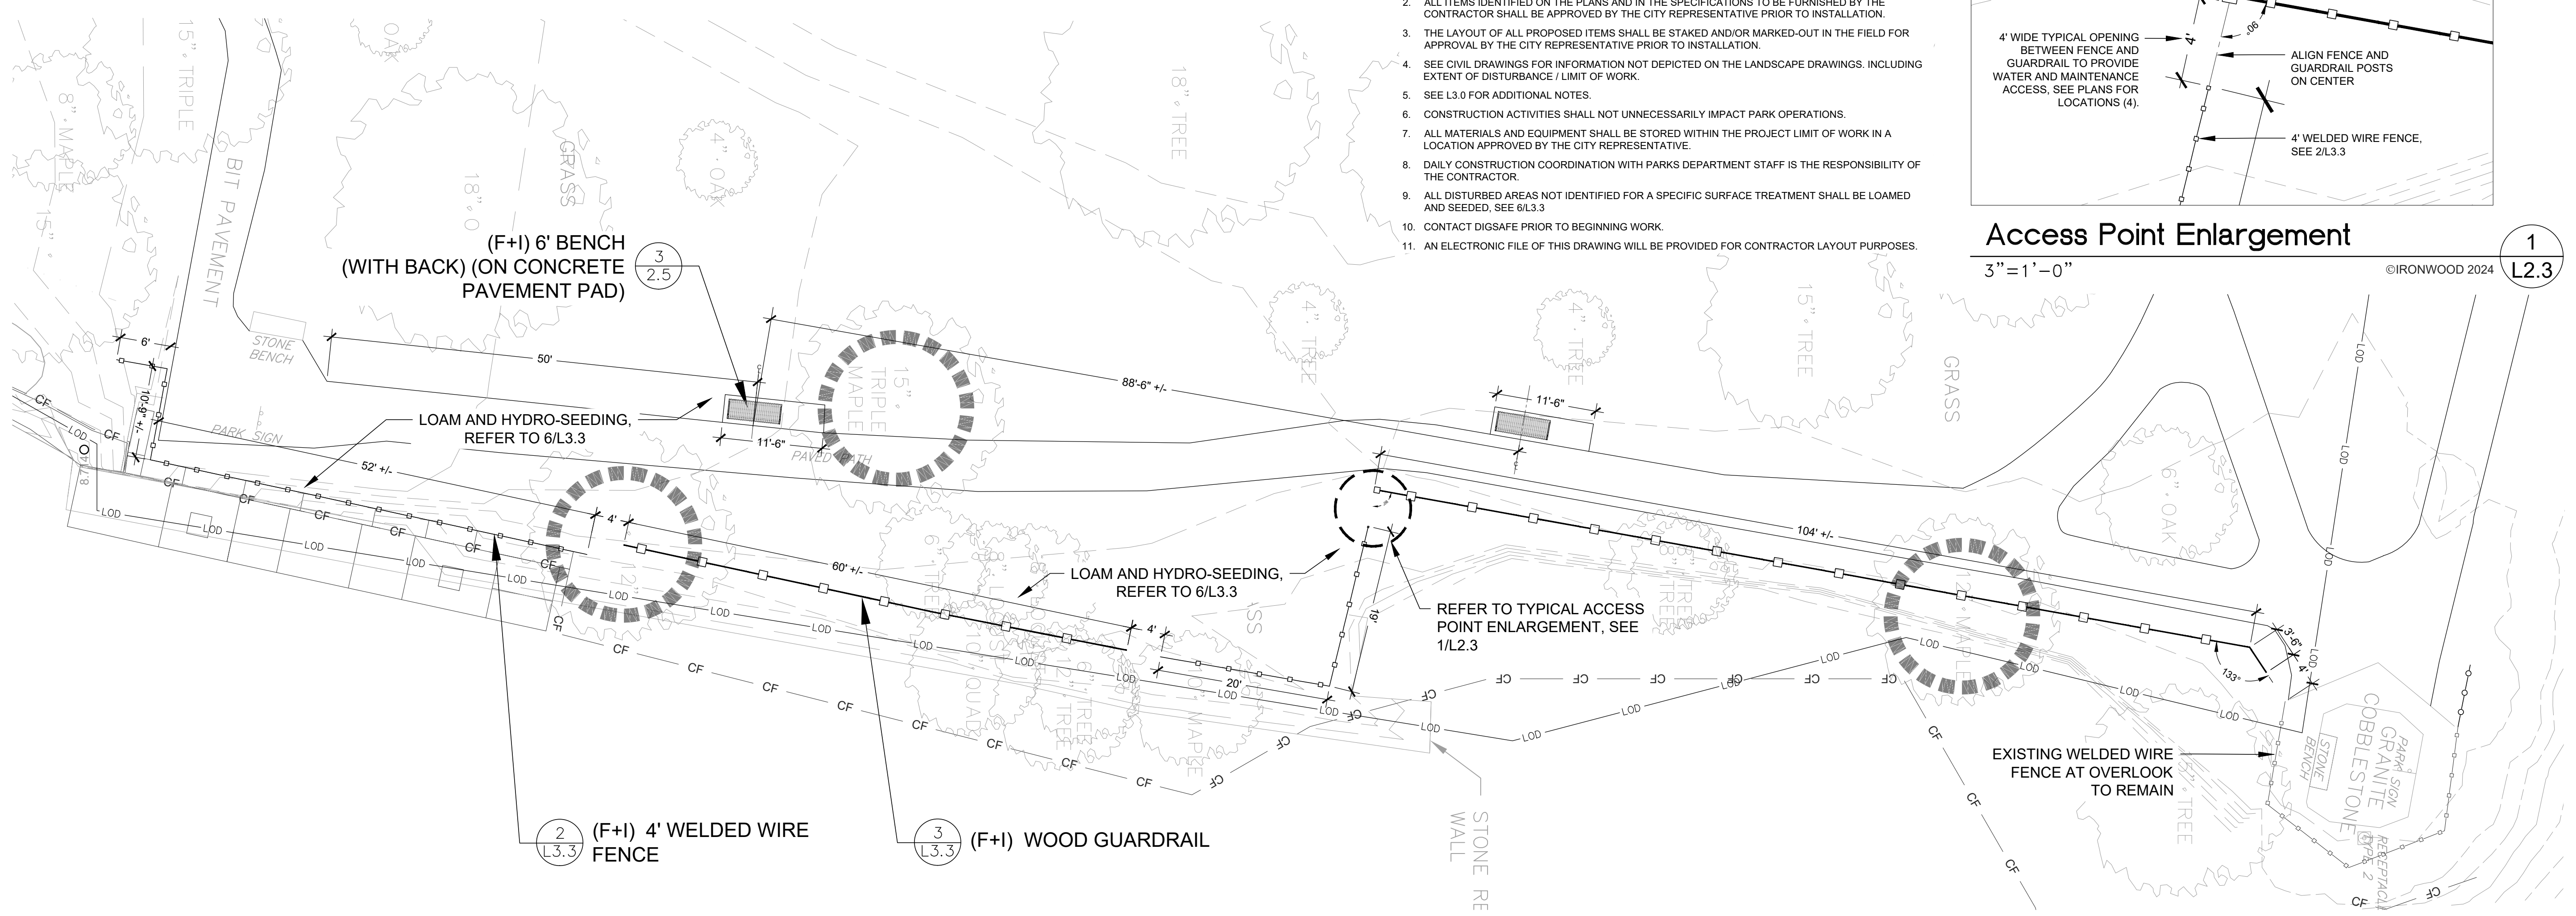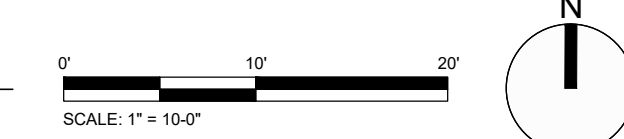

F PLAN ENLARGEMENT

1"=10'-0"

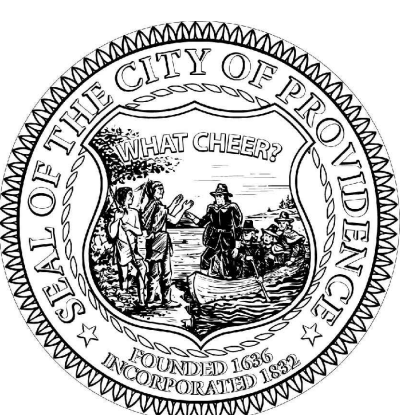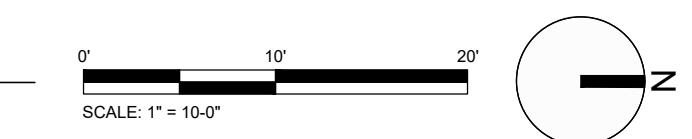

REV	DATE	DESCRIPTION

CLIENT:
PROVIDENCE PARKS DEPARTMENT
DALRYMPLE BOATHOUSE, MAPLE AVE,
PROVIDENCE, RI 02905

PROJECT:
SITE IMPROVEMENTS AT INDIA POINT PARK
109 INDIA STREET
PROVIDENCE, RI 02905

TITLE:
LANDSCAPE LAYOUT AND MATERIALS PLAN

ISSUED FOR: BID

DATE: MARCH 25, 2024

SCALE: AS NOTED

DRAWN BY: SWRIGHT, JHYLAND

CHECKED BY: JHYLAND, DJENSEN

WSP PROJECT NO: 3652216316

L 2.3


KOMPAN!
PCM722280
20190605FJKG

Item no. COR669201-1101

Installation Information	
Max. fall height	8'2"
Safety surfacing area	521ft²
Total installation time	9.5
Excavation volume	6.06yd³
Concrete volume	3.88yd³
Footing depth (standard)	37"

©IRONWOOD 2024

Freestanding Slide, 8'
(Part of Add Alternate #2)
Not to Scale

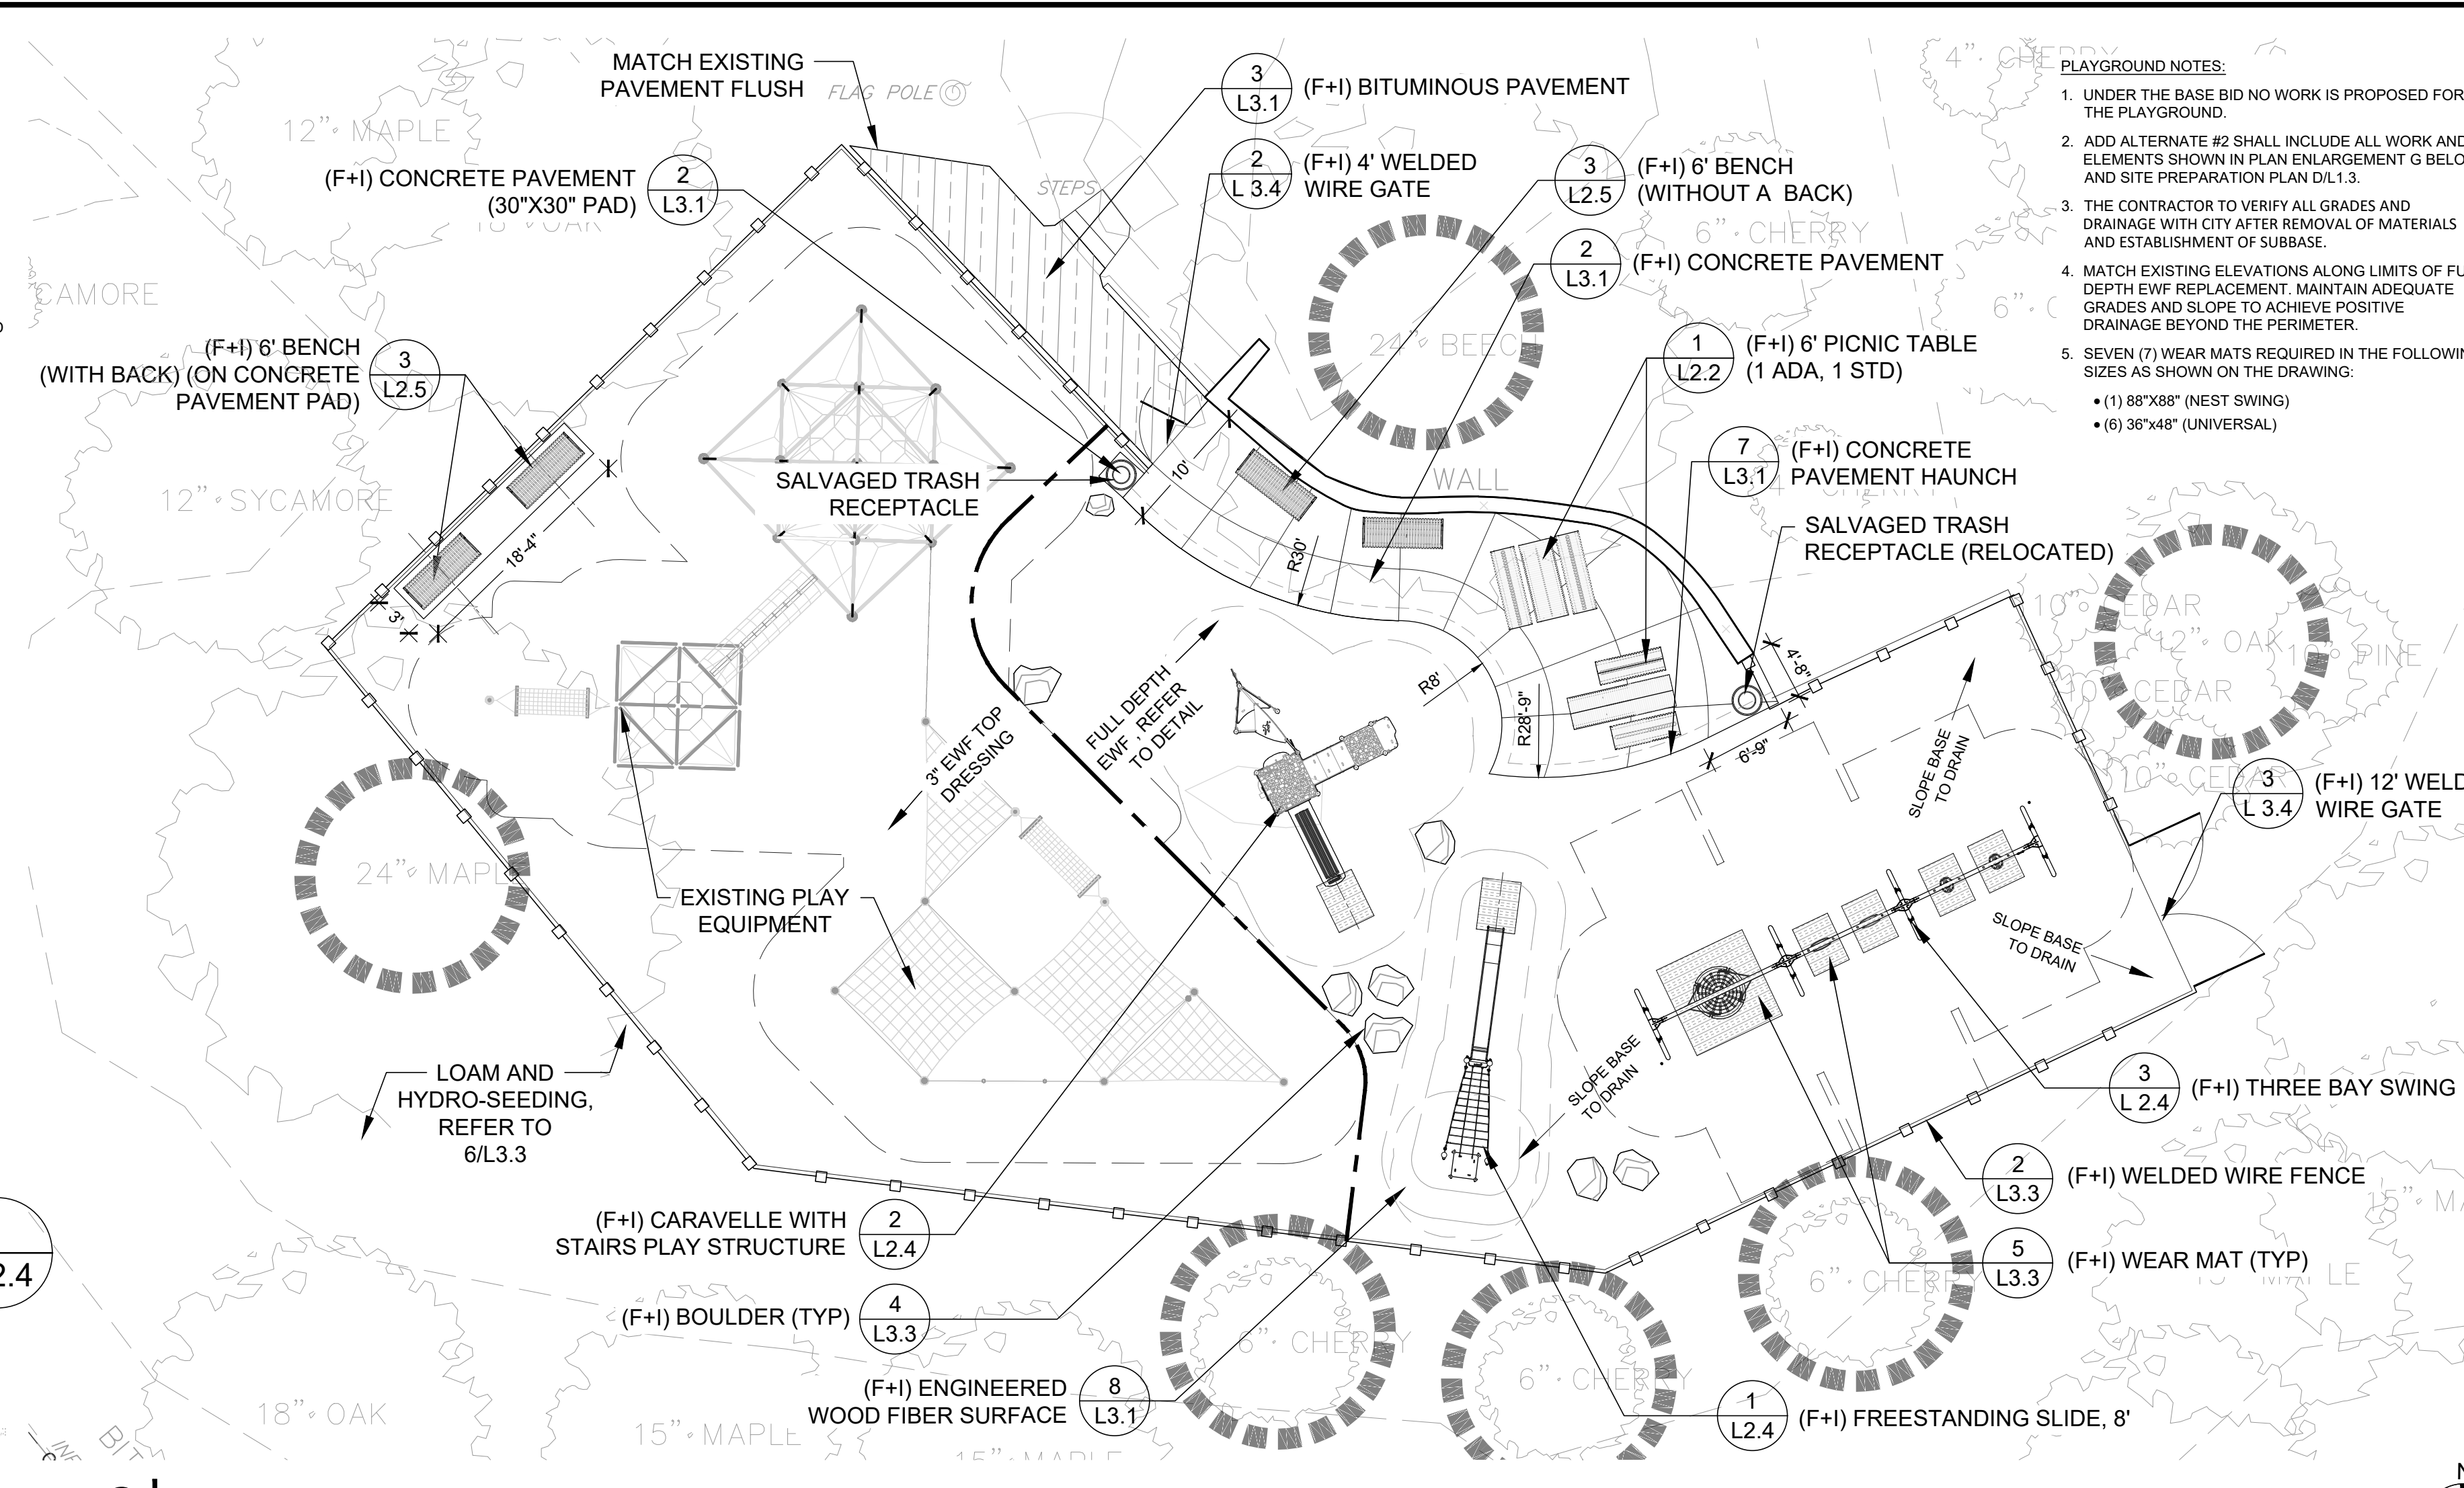

Legend

- 7 L3.1 BITUMINOUS PAVEMENT
- 1 L3.1 CONCRETE PAVER
 - BORDER SOLDIER COURSE - IDEAL ANDOVER 5511
 - RUNNING BOND FIELD - IDEAL STRAIGHTLINE
- 4 L3.1 GRANITE PAVER (2"x2"x4" CAPE NEDDICK) BORDERED BY CONCRETE PAVERS
 - RUNNING BOND BAND - IDEAL ANDOVER 5511
 - HERRINGBONE FIELD - IDEAL ANDOVER 5511
- 6 L3.1 COBBLESTONE BORDER (SALVAGED COBBLESTONE)
- 2 L2.5 GRANITE BOLLARD
- 1 L3.4 HEAVY TIMBER PICNIC TABLE (ON CONCRETE PAVEMENT PAD)
- 1 L2.2 6' PICNIC TABLE (ON CONCRETE PAVEMENT PAD)
- 1 L2.5 WOOD AND GRANITE BENCH (ON CONCRETE PAVEMENT PAD) (ADD ALTERNATE #3)
- 3 L2.5 6' BENCH (ON CONCRETE PAVEMENT PAD)
- 4 L2.5 TRASH RECEPTACLE WITH DOME LID (ON 30"x30" CONCRETE PAVEMENT PAD)
- 2 L3.3 WELDED WIRE FENCE
- 3 L3.3 WOOD GUARDRAIL
- 2 L3.2 AREA LIGHT
- 4 L3.3 BOULDERS
- 1 L3.3 DECIDUOUS TREE

KOMPAN!
PCMS-CUSTOM
726177
20230824

Copyright © KOMPAN A/S 2023

Variant of: PCM102631-0901

©IRONWOOD 2024

Caravelle with Stairs Play Structure (Part of Add Alternate #2)
Not to Scale

KOMPAN!
KSW926
ID 20266051
JEFHOC
2024-02-02

Colorline: Anthracite
Foundation: 90 cm
Norm: ASTM
Units: inch
Post Material: Anthracite_Matt

NOTES:

- PLAYGROUND EQUIPMENT FALL/SAFETY ZONES DELINEATED ON THE PLAN SHALL BE CONFIRMED AND APPROVED BY THE CITY PRIOR TO EQUIPMENT INSTALLATION.
- THE CONTRACTOR IS RESPONSIBLE FOR FURNISHING AND INSTALLING ALL ASPECTS OF THE PLAYGROUND EQUIPMENT PER MANUFACTURER'S INSTRUCTIONS AND SPECIFICATIONS.
- PLAY EQUIPMENT MANUFACTURED BY KOMPAN, INC. REFER ABOVE FOR SPECIFIC MODEL NUMBER ASSOCIATED WITH THIS PROJECT.
- COLORS TO BE SELECTED BY THE CITY AS PART OF SUBMITTAL APPROVAL.

©IRONWOOD 2024

Three Bay Swing (Part of Add Alternate #2)
Not to Scale

WSP
WSP USA ENVIRONMENT & INFRASTRUCTURE, INC.
275 PROMENADE STREET, SUITE 100
PROVIDENCE RHODE ISLAND, 02908
WEB: WWW.WSP.COM
(401) 648-9240

Ironwood
Landscape Architecture • Planning
Providence, RI | Portland, ME | 1-888-772-9991 | www.Ironwood.com

PROVIDENCE PARKS
play · relax · explore

SEAL:

REGISTERED PROFESSIONAL LANDSCAPE ARCHITECT
APPROVED FOR CONSTRUCTION
NO. 402

REV	DATE	DESCRIPTION

CLIENT:
PROVIDENCE PARKS DEPARTMENT
DALRYMPLE BOATHOUSE, MAPLE AVE,
PROVIDENCE, RI 02905

PROJECT:
SITE IMPROVEMENTS AT INDIA POINT PARK
109 INDIA STREET
PROVIDENCE, RI 02905

TITLE:
LANDSCAPE LAYOUT & MATERIALS PLAN & DETAILS

ISSUED FOR: BID

DATE: MARCH 25, 2024


SCALE: AS NOTED

DRAWN BY: SWRIGHT, JHYLAND

CHECKED BY: JHYLAND, DJENSEN

WSP PROJECT NO: 365221616

L 2.4

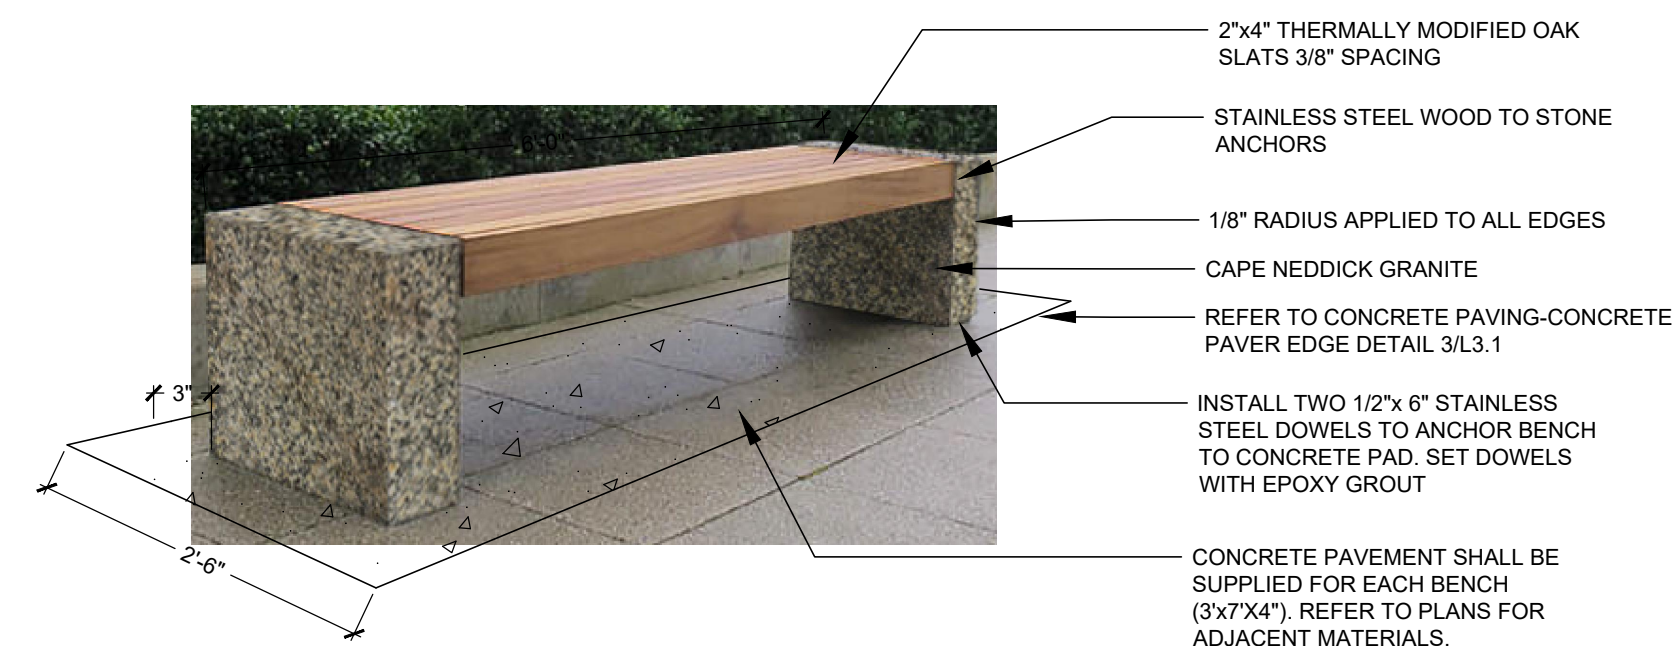


- NOTES:
1. ALL WOOD SHALL BE SUSTAINABLE HARVESTED, FSC CERTIFIED THERMALLY MODIFIED OAK.
 2. ALL REQUIRED MECHANICAL FASTENERS SHALL BE STAINLESS STEEL.
 3. GRANITE SHALL BE CAPE NEDDICK SOURCED FROM ROCKPORT GRANITE OR APPROVED EQUAL.

Wood and Granite Bench (Add Alternate #3)

Not to Scale

©IRONWOOD 2024

1
L 2.5

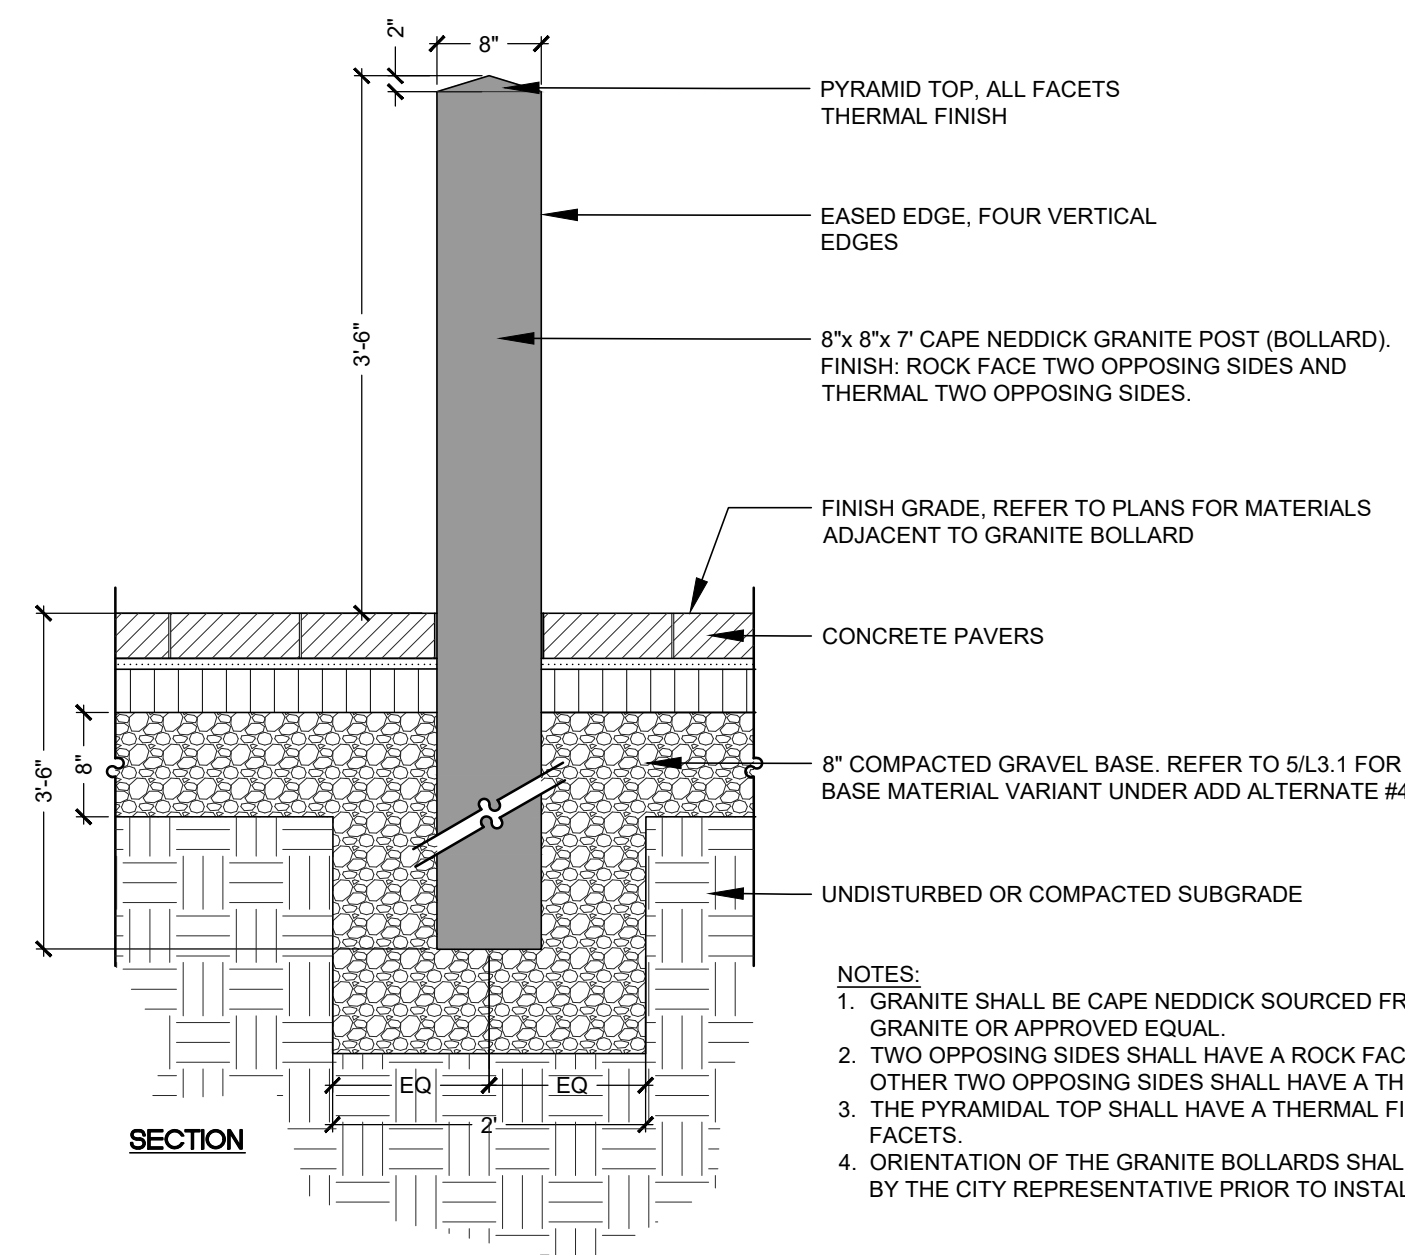


- NOTES:
1. GRANITE SHALL BE CAPE NEDDICK SOURCED FROM ROCKPORT GRANITE OR APPROVED EQUAL.
 2. TWO OPPOSING SIDES SHALL HAVE A ROCK FACE FINISH AND THE OTHER TWO OPPOSING SIDES SHALL HAVE A THERMAL FINISH.
 3. THE PYRAMIDAL TOP SHALL HAVE A THERMAL FINISH ON ALL FACETS.
 4. ORIENTATION OF THE GRANITE BOLLARDS SHALL BE APPROVED BY THE CITY REPRESENTATIVE PRIOR TO INSTALLATION.

Granite Bollard

Not to Scale

©IRONWOOD 2024

2
L 2.5

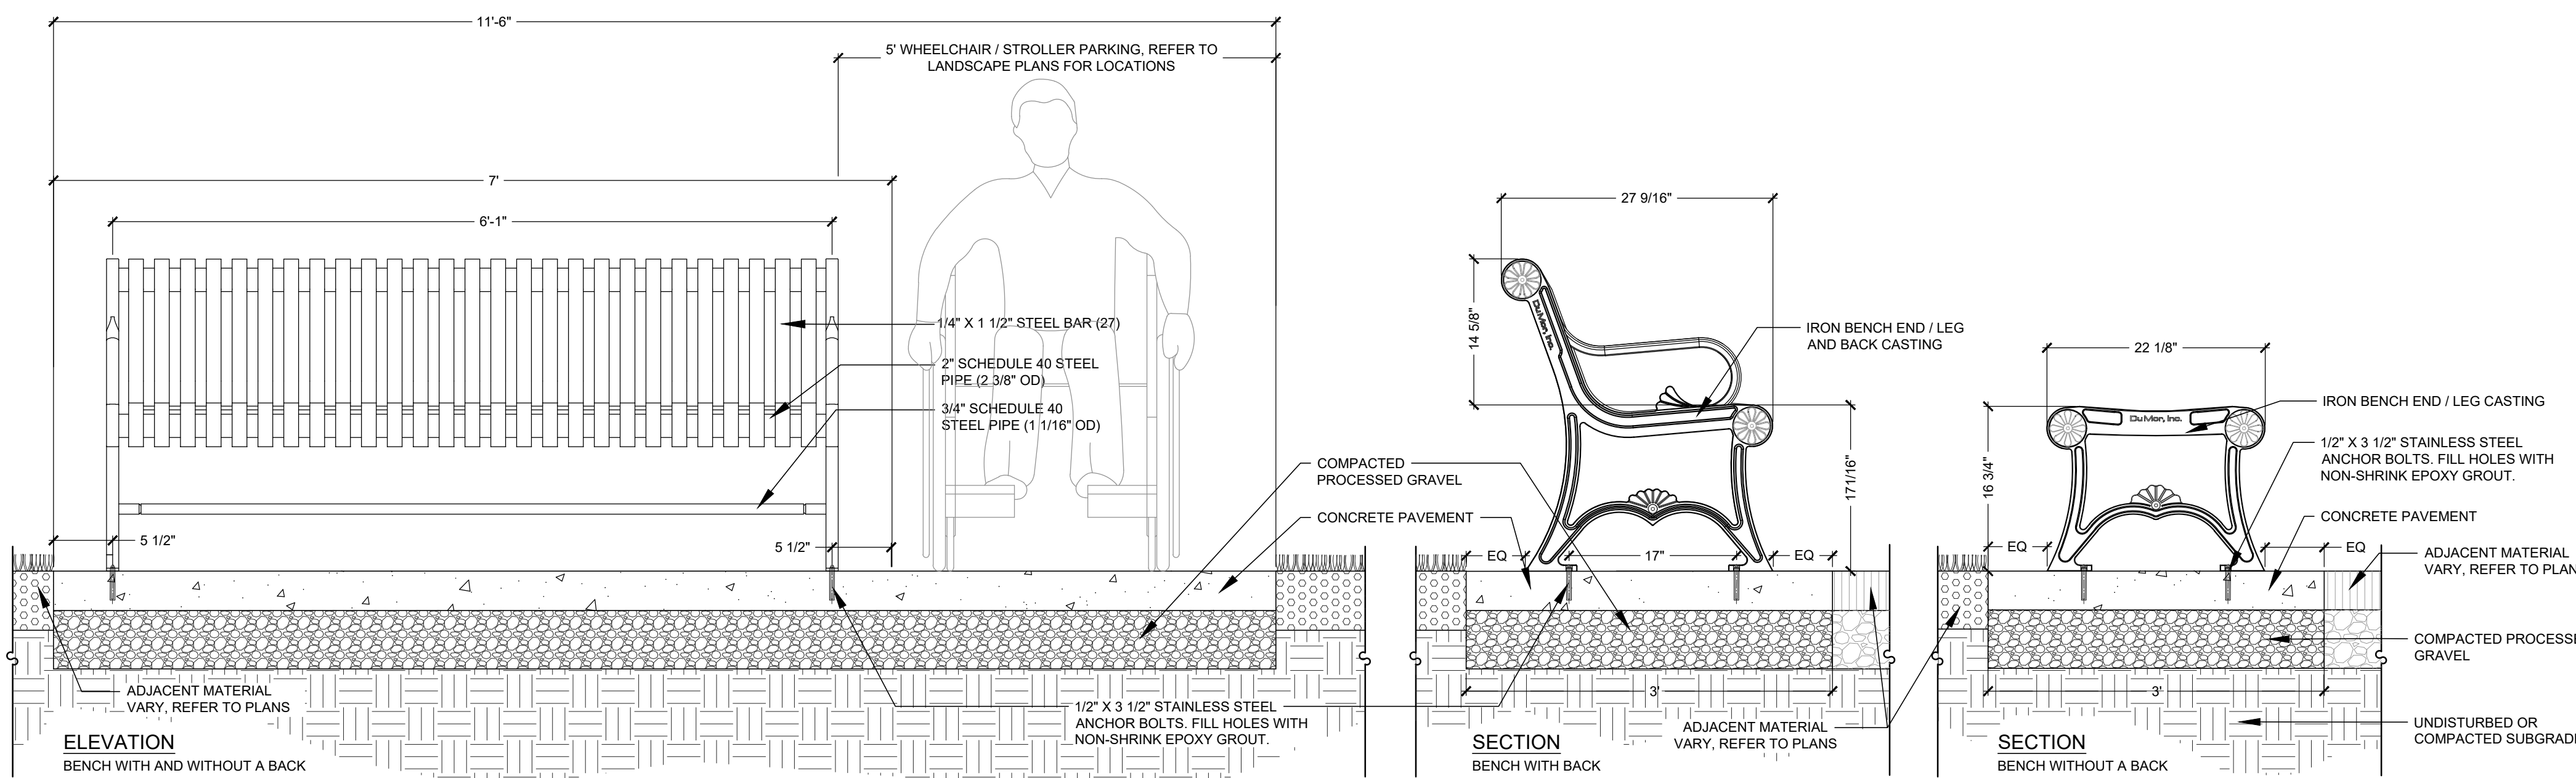


- NOTES:
1. THE CONTRACTOR IS RESPONSIBLE FOR INSTALLING PAVING/PAD, MOVING BENCHES TO THE IDENTIFIED LOCATION, LEVELING OR ADJUSTING THE BENCHES AS NEEDED, AND ANCHORING TO THE PAVEMENT.
 2. CONCRETE PAVING/PADS FOR BENCHES MEASURE 7' X 3' OR 12' X 3' REFER TO PLANS FOR CONFIGURATION.
 3. BENCHES SHALL BE MANUFACTURED BY DUMOR, INC. MODEL 58-60 (6' BENCH WITH BACK), 92-60 (6' BENCH WITHOUT BACK).
 4. ALL METAL TO BE FINISHED WITH A POLYESTER POWDER COAT - BLACK.

6' Bench

Not to Scale

©IRONWOOD 2024

3
L 2.5

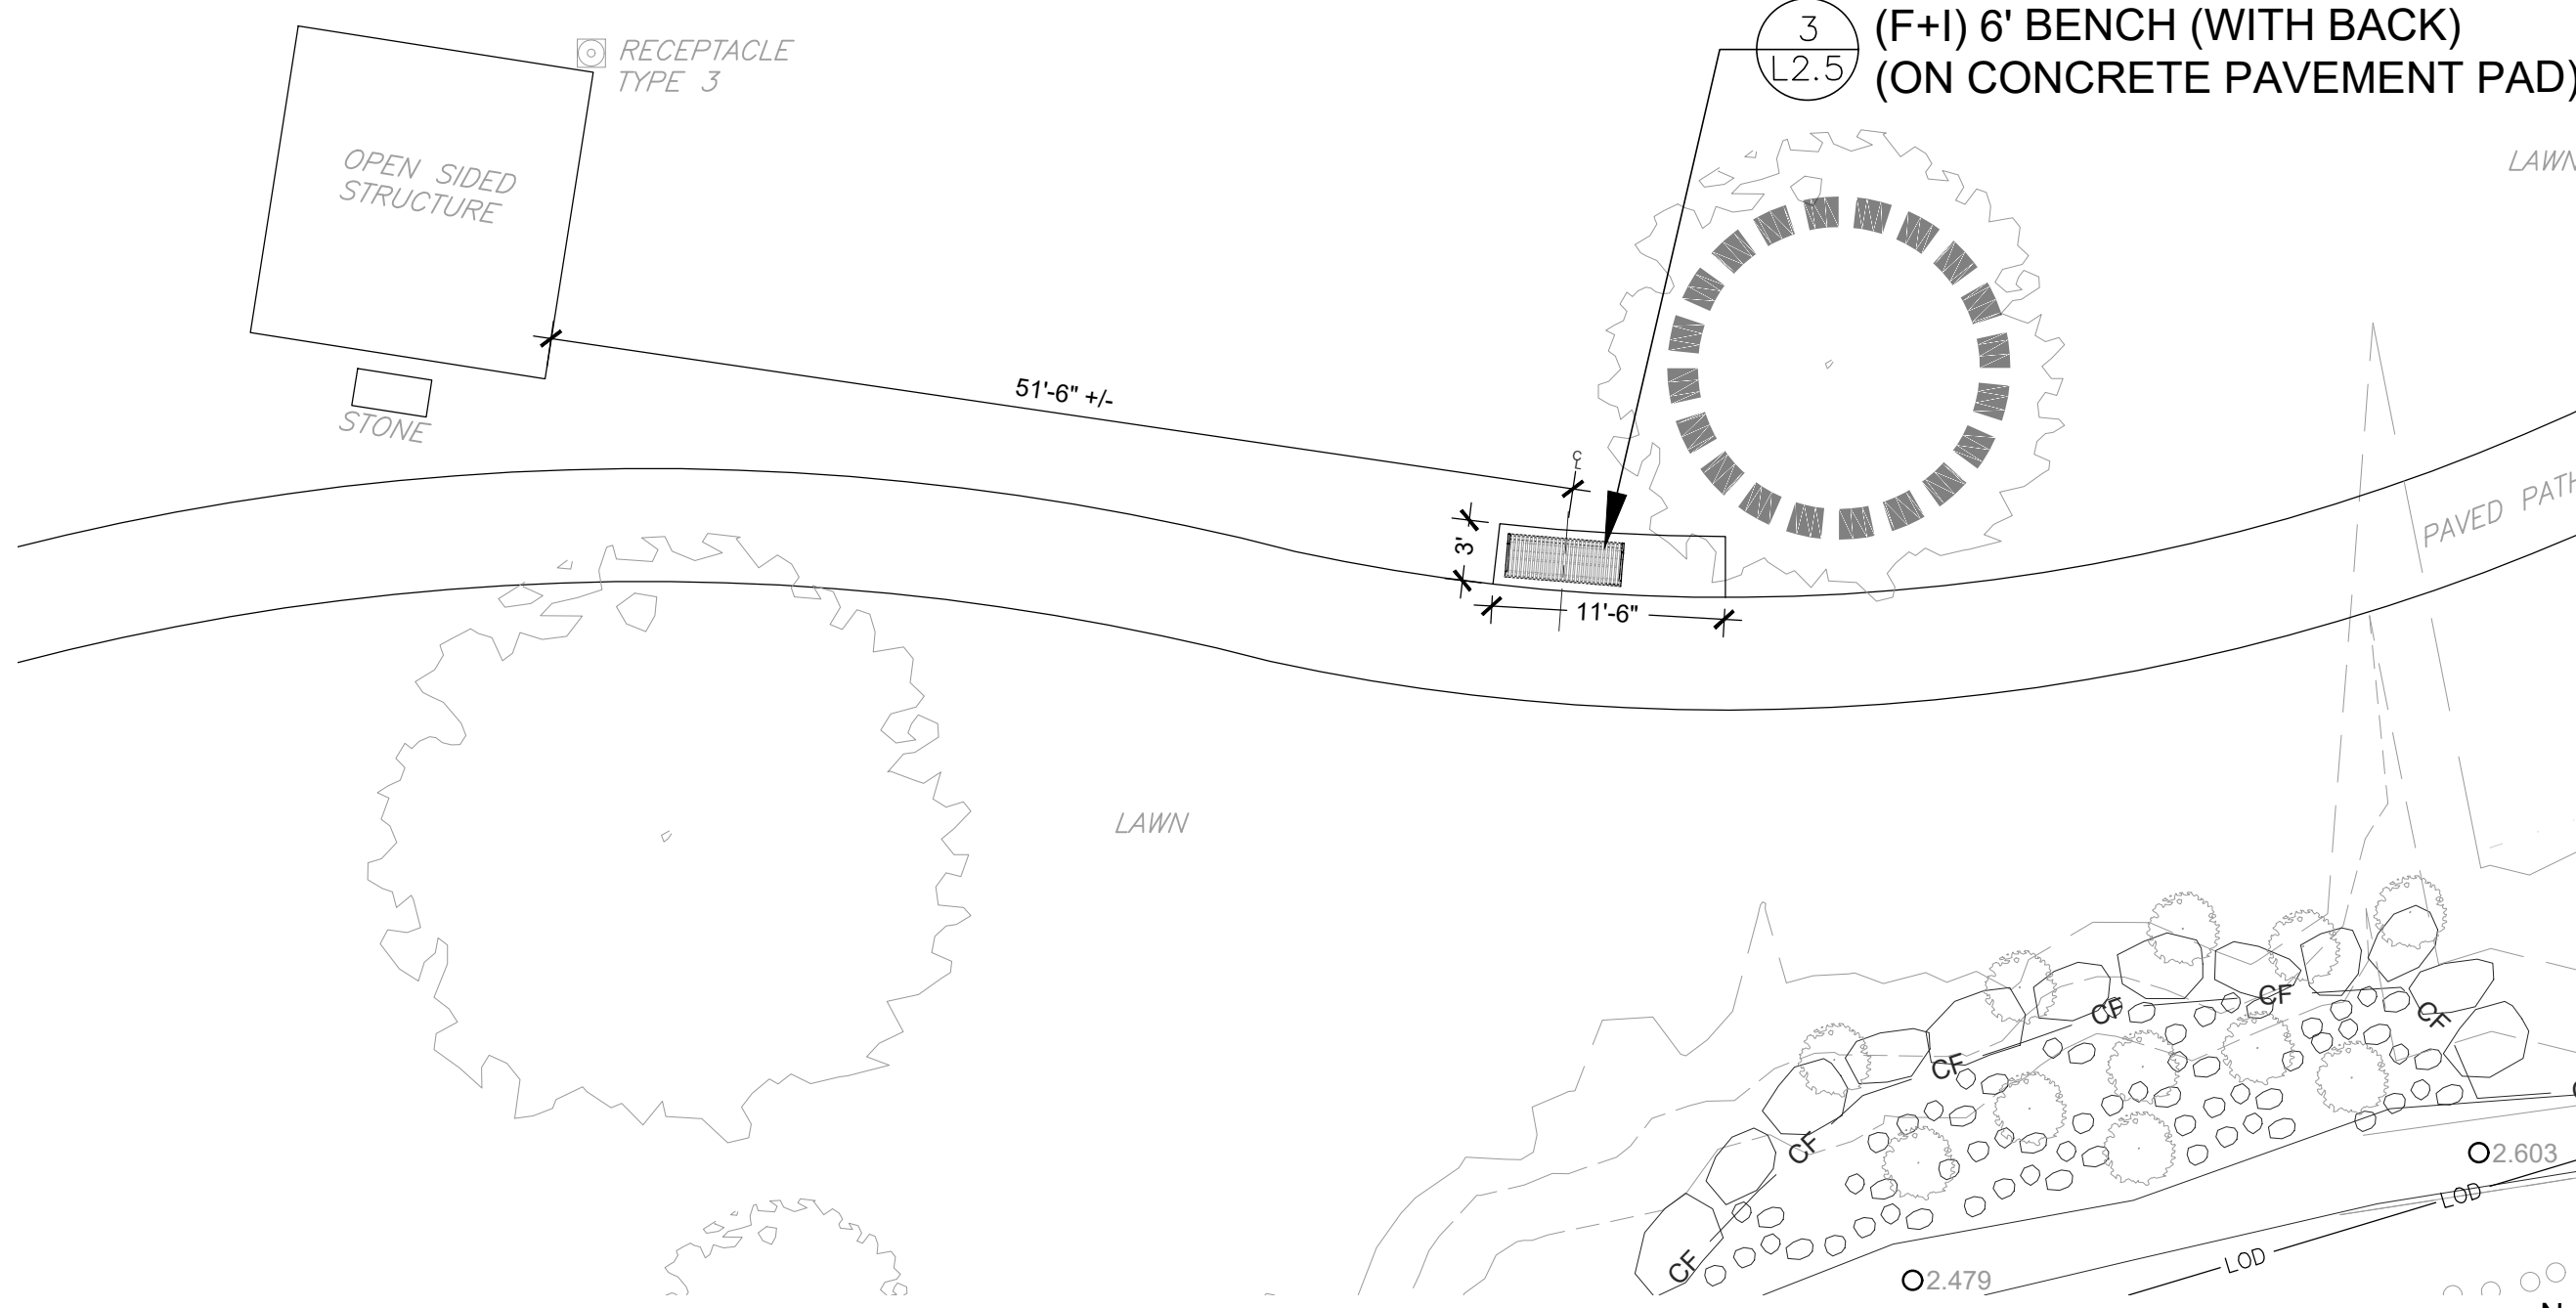

PLAN ENLARGEMENT


1"=10'-0"

GENERAL NOTES:

1. F+I - ALL ITEMS IDENTIFIED ON THE PLANS ARE TO BE FURNISHED AND INSTALLED, COMPLETE IN PLACE BY THE CONTRACTOR UNLESS OTHERWISE STATED.
2. ALL ITEMS IDENTIFIED ON THE PLANS AND IN THE SPECIFICATIONS TO BE FURNISHED BY THE CONTRACTOR SHALL BE APPROVED BY THE CITY REPRESENTATIVE PRIOR TO INSTALLATION.
3. THE LAYOUT OF ALL PROPOSED ITEMS SHALL BE STAKED AND/OR MARKED-OUT IN THE FIELD FOR APPROVAL BY THE CITY REPRESENTATIVE PRIOR TO INSTALLATION.
4. SEE CIVIL DRAWINGS FOR INFORMATION NOT DEPICTED ON THE LANDSCAPE DRAWINGS, INCLUDING EXTENT OF DISTURBANCE / LIMIT OF WORK.
5. SEE L3.0 FOR ADDITIONAL NOTES.
6. CONSTRUCTION ACTIVITIES SHALL NOT UNNECESSARILY IMPACT PARK OPERATIONS.
7. ALL MATERIALS AND EQUIPMENT SHALL BE STORED WITHIN THE PROJECT LIMIT OF WORK IN A LOCATION APPROVED BY THE CITY REPRESENTATIVE.
8. DAILY CONSTRUCTION COORDINATION WITH PARKS DEPARTMENT STAFF IS THE RESPONSIBILITY OF THE CONTRACTOR.
9. ALL DISTURBED AREAS NOT IDENTIFIED FOR A SPECIFIC SURFACE TREATMENT SHALL BE LOAMED AND SEEDED, SEE 6/L3.3.
10. CONTACT DIGSAFE PRIOR TO BEGINNING WORK.
11. AN ELECTRONIC FILE OF THIS DRAWING WILL BE PROVIDED FOR CONTRACTOR LAYOUT PURPOSES.

Legend

- 7 L3.1 BITUMINOUS PAVEMENT
- 1 L3.1 CONCRETE PAVER
 - BORDER SOLDIER COURSE - IDEAL ANDOVER 5511
 - RUNNING BOND FIELD - IDEAL STRAIGHTLINE
- 4 L3.1 GRANITE PAVER (2'x2'x4" CAPE NEDDICK) BORDERED BY CONCRETE PAVERS
 - RUNNING BOND BAND - IDEAL ANDOVER 5511
 - HERRINGBONE FIELD - IDEAL ANDOVER 5511
- 6 L3.1 COBBLESTONE BORDER (SALVAGED COBBLESTONE)
- 4" SCH40 PVC SLEEVE (CAP ENDS AND DRIVE REBAR TO AID IN LOCATING)
- 2 L2.5 GRANITE BOLLARD
- 1 L3.4 HEAVY TIMBER PICNIC TABLE (ON CONCRETE PAVEMENT PAD)
- 1 L2.2 6' PICNIC TABLE (ON CONCRETE PAVEMENT PAD)
- 1 L2.5 WOOD AND GRANITE BENCH (ON CONCRETE PAVEMENT PAD) (ADD ALTERNATE #3)
- 3 L2.5 6' BENCH (ON CONCRETE PAVEMENT PAD)
- 4 L2.5 TRASH RECEPTACLE WITH DOME LID (ON 30"x30" CONCRETE PAVEMENT PAD)
- 2 L3.3 WELDED WIRE FENCE
- 3 L3.3 WOOD GUARDRAIL
- 2 L3.2 AREA LIGHT
- 4 L3.3 BOULDERS

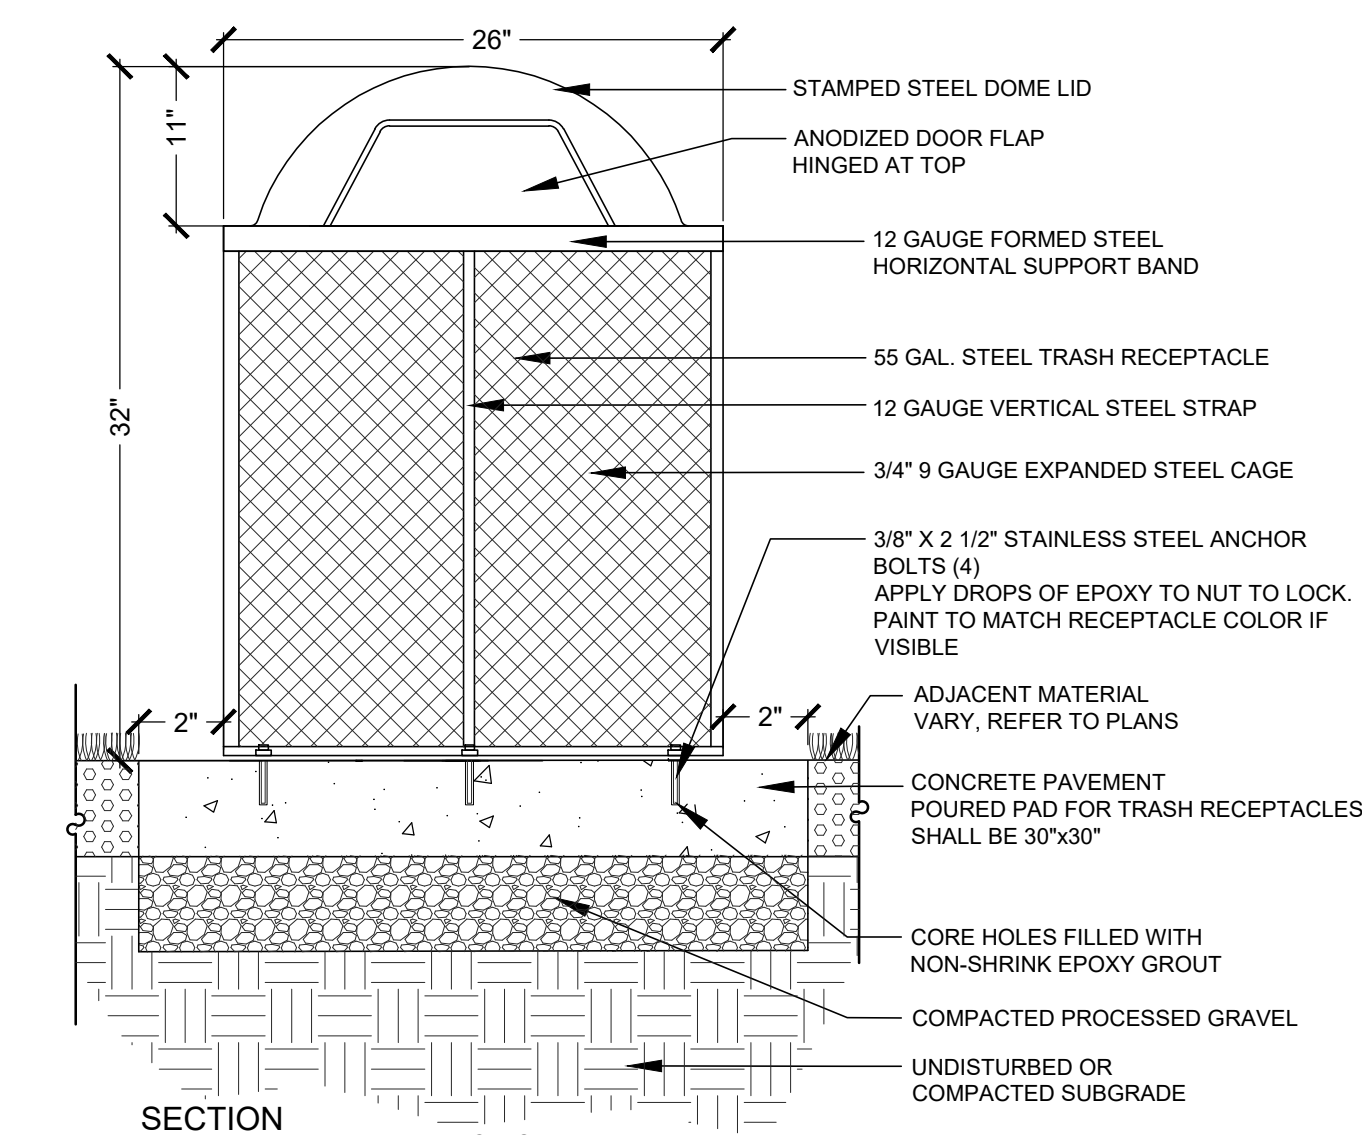



- NOTES:
1. 55 GALLON TRASH RECEPTACLE MANUFACTURED BY PILOT ROCK OR EQUAL.
 2. PROVIDE 55 GAL. DRUM LINER.
 3. ALL METAL TO BE FINISHED WITH A POLYESTER POWDER COAT IN BLACK.
 4. CONCRETE PAVING / PADS FOR RECEPTACLES SHALL BE 30" X 30". POURED CONCRETE PADS SHALL BE FLUSH TO SURROUNDING GRADE.
 5. RECEPTACLES SHALL BE ANCHORED PER MANUFACTURER'S SPECIFICATIONS.

Trash Receptacle with Dome Lid (55 Gallon)

Not to Scale

©IRONWOOD 2024

4
L 2.5

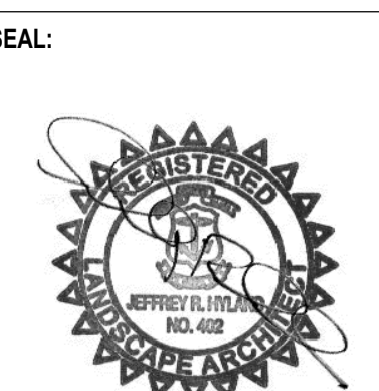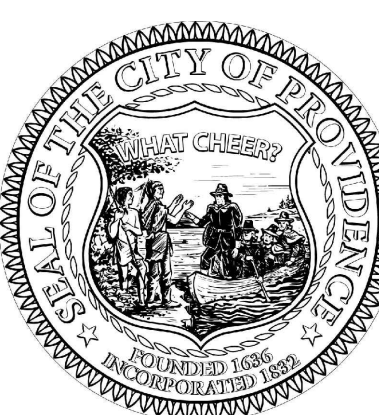

REV	DATE	DESCRIPTION

CLIENT:
PROVIDENCE PARKS DEPARTMENT
DALRYMPLE BOATHOUSE, MAPLE AVE,
PROVIDENCE, RI 02905

PROJECT:
SITE IMPROVEMENTS AT INDIA POINT PARK
109 INDIA STREET
PROVIDENCE, RI 02905

TITLE:
LANDSCAPE LAYOUT & MATERIALS PLAN & DETAILS

ISSUED FOR: BID
DATE: MARCH 25, 2024
SCALE: AS NOTED
DRAWN BY: S WRIGHT, JHYLAND
CHECKED BY: JHYLAND, DJENSEN
WSP PROJECT NO: 3652210316

L 2.5

SITE PREPARATION NOTES:

- ALL SITE PREPARATION NECESSARY TO COMPLETE THIS PROJECT IS THE SOLE RESPONSIBILITY OF THE CONTRACTOR.
- IT IS THE CONTRACTOR'S RESPONSIBILITY TO COORDINATE WITH PROVIDENCE PARKS DEPARTMENT STAFF TO DEVELOP A SUITABLE DEMOLITION PLAN, WHICH WILL MINIMIZE PARK DISTURBANCE AND ALLOW ALL FACILITIES TO REMAIN IN OPERATION DURING THE ENTIRETY OF CONSTRUCTION.
- UNLESS OTHERWISE NOTED, THE CONTRACTOR IS RESPONSIBLE FOR THE RELOCATION, DEMOLITION, REMOVAL AND DISPOSAL, IN A LOCATION APPROVED BY ALL GOVERNING AUTHORITIES, OF ALL EXISTING SITE ELEMENTS AND STRUCTURES INCLUDING BUT NOT LIMITED TO BITUMINOUS CONCRETE, CEMENT CONCRETE, GRAVEL, CURBS, WALKWAYS, SIDEWALKS, BERMS, FENCES, BOLLARDS, POSTS, PLANTING BEDS, TREES, SHRUBS, UTILITIES, DRAINAGE STRUCTURES AND ALL OTHER STRUCTURES SHOWN WITHIN THE LIMITS, AND WHERE NEEDED, TO ALLOW FOR NEW CONSTRUCTION. ALL ELEMENTS TO BE REMOVED SHALL BE UNDERCUT TO SUITABLE MATERIAL AND BROUGHT TO GRADE WITH SUITABLE COMPACTED FILL MATERIAL PER SPECIFICATIONS.
- THE CONTRACTOR IS RESPONSIBLE FOR REMOVING ALL DEBRIS FROM THE SITE AND DISPOSING OF THE DEBRIS IN A PROPER AND LEGAL MANNER.
- THE CONTRACTOR IS SPECIFICALLY CAUTIONED THAT THE LOCATION AND/OR ELEVATION OF EXISTING UTILITIES AND STRUCTURES AS SHOWN ON THESE PLANS ARE BASED ON RECORDS OF VARIOUS UTILITY COMPANIES, AND WHEREVER POSSIBLE, MEASUREMENTS TAKEN IN THE FIELD. THIS INFORMATION IS NOT TO BE RELIED UPON AS BEING EXACT OR COMPLETE. THE LOCATION OF ALL UNDERGROUND UTILITIES AND STRUCTURES SHALL BE VERIFIED IN THE FIELD BY THE CONTRACTOR PRIOR TO THE START OF CONSTRUCTION. THE CONTRACTOR MUST CONTACT THE APPROPRIATE UTILITY COMPANY, ANY GOVERNING PERMITTING AUTHORITY IN THE CITY, AND "DIGSAFE" (1-800-344-7233) AT LEAST 72 HOURS PRIOR TO ANY EXCAVATION WORK IN PREVIOUSLY UNALTERED AREAS TO REQUEST EXACT FIELD LOCATION OF UTILITIES. IT SHALL BE THE RESPONSIBILITY OF THE CONTRACTOR TO RESOLVE CONFLICTS BETWEEN THE PROPOSED UTILITIES AND FIELD-LOCATED UTILITIES AND SHALL REPORT ANY DISCREPANCIES TO THE LANDSCAPE ARCHITECT IMMEDIATELY. THE OWNER ASSUMES NO RESPONSIBILITY FOR DAMAGES INCURRED AS A RESULT OF UTILITIES OMITTED, INCOMPLETELY OR INACCURATELY SHOWN. THE CONTRACTOR SHALL BE RESPONSIBLE FOR MAINTAINING ACCURATE RECORDS OF THE LOCATION AND ELEVATION OF ALL WORK INSTALLED AND EXISTING UTILITIES FOUND DURING CONSTRUCTION FOR THE PREPARATION OF THE AS-BUILT PLAN.
- THE CONTRACTOR IS RESPONSIBLE FOR MAINTAINING ALL EXISTING UTILITIES IN WORKING ORDER AND FREE FROM DAMAGE DURING THE ENTIRE DURATION OF THE PROJECT. ALL COST RELATED TO THE REPAIR OF UTILITIES SHALL BE THE RESPONSIBILITY OF THE CONTRACTOR. EXCAVATION REQUIRED WITHIN THE PROXIMITY OF EXISTING UTILITY LINES SHALL BE DONE BY HAND. CONTRACTOR SHALL REPAIR ANY DAMAGE TO EXISTING UTILITY LINE OR STRUCTURES INCURRED DURING CONSTRUCTION OPERATIONS AT NO COST TO THE OWNER.
- THE CONTRACTOR SHALL MAINTAIN CONTINUOUS ACCESS AND OPERATION FOR SURROUNDING FACILITIES, AS DEEMED BY THE OWNER, AT ALL TIMES DURING DEMOLITION OF THE EXISTING FACILITIES. PRIOR TO DEMOLITION OCCURRING, ALL EROSION CONTROL DEVICES AND TREE PROTECTIVE MEASURES ARE TO BE INSTALLED.
- EVERY EFFORT SHALL BE TAKEN TO PRESERVE THE HEALTH OF EXISTING VEGETATION TO BE PROTECTED ON SITE. PRIOR TO BEGINNING ANY WORK THE CONTRACTOR ON SITE SHALL TAKE EFFECTIVE ACTION TO PROTECT ALL EXISTING LANDSCAPING INDICATED TO REMAIN.
- ALL ELEMENTS IDENTIFIED TO BE PROTECTED SHOULD BE ENCIRCLED WITH AN ORANGE PLASTIC, 4' - HIGH BARRICADE FENCE THAT IS SECURELY STAKED AND MAINTAINED FOR THE DURATION OF THE PROJECT.
- PROTECT TREE TRUNKS FROM SCRAPING AND GOUGING BY VERTICALLY PLACING A SERIES OF EIGHT FOOT, TWO BY FOUR LUMBER AROUND THE TRUNK SPACED 8" APART (MAX) TO ENCIRCLE THE TRUNK. SECURE THE LUMBER WITH AT LEAST THREE 1 1/2" WEBBING RATCHET STRAPS.
- THE ROOT ZONE OF TREES TO BE PROTECTED REQUIRES ALL EXCAVATION WORK BE DONE WITH AN AIR SPADE AND/OR BY HAND DIGGING. WHEN ROOTS ARE ENCOUNTERED THAT MUST BE CUT TO INSTALL UTILITIES, PAVEMENT, ETC. THEY ARE TO BE PRUNED USING A HAND SAW, LOPPERS, OR HAND PRUNERS. PRUNE AWAY JAGGED ROOTS BACK TO THE TRENCH WALL CLOSEST TO THE TREE.
 - KEEP EQUIPMENT AND EXCAVATED BACKFILL ON THE SIDE FURTHEST FROM THE TREE.
 - REPLACE THE BACKFILL ON THE SAME DAY. IF THIS IS NOT POSSIBLE, COVER THE EXPOSED ROOTS WITH WET BURLAP TO PREVENT THEM FROM DRY OUT.
 - DO NOT ALLOW CHEMICALS OR FOREIGN DEBRIS TO BECOME MIXED WITH THE BACKFILL.
 - PACK THE BACKFILL TO THE SAME FIRMNNESS AS THE SURROUNDING SOIL.
 - WATER THE BACKFILL IF THE OPERATION OCCURS DURING HOT, DRY WEATHER TO REDUCE DUST.
- AVOID THE FOLLOWING ACTIVITIES WITHIN THE ROOT PROTECTION ZONE:
 - STORAGE OF CONSTRUCTION MATERIALS.
 - CONCRETE WASH-OUT OPERATIONS.
 - STOCKPILING OF DEMOLITION DEBRIS.
 - PARKING OF ANY VEHICLES.
 - STOCKPILING OF ANY MATERIALS.

LAYOUT AND MATERIALS NOTES:

- ALL GENERAL NOTES SHALL BE INCLUDED AS PART OF THE LAYOUT & MATERIALS NOTES.
- WHEN PROVIDED, USE DIMENSIONAL INFORMATION GIVEN ON THE DRAWING.
- ALL DIMENSIONS SHOWN ARE TAKEN TO THE FACE OR CENTERLINE OF ELEMENTS UNLESS OTHERWISE INDICATED.
- THE CONTRACTOR SHALL VERIFY DIMENSIONS SHOWN ON THE DRAWINGS AND SHALL NOTIFY THE LANDSCAPE ARCHITECT IN WRITING OF ANY DISCREPANCIES PRIOR TO THE START OF CONSTRUCTION. THE CONTRACTOR SHALL REVIEW AND OBTAIN THE APPROVAL OF THE FINAL LAYOUT WITH THE LANDSCAPE ARCHITECT OR CITY REPRESENTATIVE PRIOR TO STARTING CONSTRUCTION. IF DEEMED NECESSARY BY THE LANDSCAPE ARCHITECT OR CITY REPRESENTATIVE, THE CONTRACTOR SHALL STAKE OUT PROPOSED TREE LOCATIONS TO AID IN THE REVIEW OF THE FINAL LAYOUT.
- THE CONTRACTOR SHALL LAYOUT AND DETERMINE THE ELEVATIONS OF ALL SITE ELEMENTS FOR APPROVAL BY THE LANDSCAPE ARCHITECT OR CITY REPRESENTATIVE PRIOR TO THE START OF CONSTRUCTION. THE CONTRACTOR SHALL REPORT ANY CONFLICTS BETWEEN UTILITY STRUCTURES AND PROPOSED IMPROVEMENTS TO THE LANDSCAPE ARCHITECT OR CITY REPRESENTATIVE.
- THE CONTRACTOR SHALL REFER ANY QUESTIONS ON MATERIALS, FINISHES, AND/OR PRODUCTS NOT SPECIFIED HEREIN TO THE LANDSCAPE ARCHITECT OR CITY REPRESENTATIVE PRIOR TO ORDERING MATERIALS OR STARTING WORK.
- ALL LINES AND DIMENSIONS ARE PARALLEL OR PERPENDICULAR TO THE LINES FROM WHICH THEY ARE MEASURED UNLESS OTHERWISE SHOWN.
- WHEN NEW PAVEMENT IS PLACED AGAINST EXISTING PAVEMENT, SAWCUT EXISTING PAVEMENT, AND GRADE SMOOTH AND FLUSH.



PLANTING NOTES:

- ALL NEW PLANT MATERIALS SHALL CONFORM TO THE MINIMUM GUIDELINES ESTABLISHED FOR NURSERY STOCK PUBLISHED BY THE AMERICAN ASSOCIATION OF NURSERYMEN, INC. IN ADDITION, ALL NEW PLANT MATERIAL FOR THE PROJECT SHALL BE OF SPECIMEN QUALITY.
- ALL NEW PLANTS TO BE BALLED AND BURLAPPED OR CONTAINER GROWN, UNLESS OTHERWISE NOTED ON THE PLANT LIST.
- THE CONTRACTOR SHALL SUPPLY ALL NEW PLANT MATERIAL IN QUANTITIES SUFFICIENT TO COMPLETE THE PLANTING SHOWN ON THE DRAWINGS.
- ANY PROPOSED SUBSTITUTIONS OF PLANT SPECIES SHALL BE MADE WITH PLANTS OF EQUIVALENT OVERALL FORM, HEIGHT, BRANCHING HABIT, FLOWER, LEAF, COLOR, FRUIT AND CULTURE, AND ONLY AFTER WRITTEN APPROVAL OF THE LANDSCAPE ARCHITECT.
- ALL NEW PLANTS SHALL BE TAGGED AND APPROVED BY THE LANDSCAPE ARCHITECT AT THE NURSERY PRIOR TO DIGGING OR DELIVERY TO THE SITE.
- CONTRACTOR SHALL LOCATE AND VERIFY ALL EXISTING UTILITY LINES PRIOR TO PLANTING AND SHALL REPORT ANY CONFLICTS TO THE LANDSCAPE ARCHITECT.
- STAKE LOCATIONS OF ALL PROPOSED PLANTING FOR APPROVAL BY THE LANDSCAPE ARCHITECT PRIOR TO THE COMMENCEMENT OF PLANTING. INDIVIDUAL STAKES SHALL BE PLACED FOR TREES AND SHRUBS. EDGE OF PLANTING BEDS SHALL BE PAINTED. NOTIFY LANDSCAPE ARCHITECT 24 HOURS PRIOR TO DESIRED APPROVAL.
- ALL NEW PLANTS SHALL BE SUPPLIED AND INSTALLED DURING THE PERIODS OF APRIL 1 - JUNE 15 AND/OR SEPTEMBER 1 - NOVEMBER 15 PER SPECIFICATIONS.
- PREPARE ALL INDIVIDUAL TREE PITS AND SHRUB PLANTING BEDS TO A MINIMUM DEPTH OF EIGHTEEN INCHES (18") WITH SPECIFIED PLANTING MIX: 50% SCREENED TOPSOIL, 40% EXISTING SOIL AND 10% COMPOST. BLEND COMPOST INTO TOP 4" OF SOIL. PLANTING MIX SHALL BE FREE OF LUMPS, STONES, PLANTS, ROOTS, AND OTHER FOREIGN MATTER.
- ALL SHRUB BEDS AND INDIVIDUAL TREE PITS SHALL RECEIVE THREE (3) INCHES OF BARK MULCH PER SPECIFICATIONS. PERENNIAL AND GROUNDCOVER BEDS SHALL RECEIVE TWO INCHES (2"). PROVIDE LANDSCAPE ARCHITECT WITH SAMPLE FOR APPROVAL.
- ALL BURLAP, TWINE AND WIRE SHALL BE COMPLETELY REMOVED OR CUT AWAY AT TIME OF INSTALLATION.
- PRUNE TREES IN ACCORDANCE WITH THE SPECIFICATIONS.
- PLANT WARRANTY SHALL BE FOR ONE FULL GROWING SEASON FROM THE TIME OF SUBSTANTIAL COMPLETION.
- LANDSCAPE CONTRACTOR SHALL BE RESPONSIBLE FOR REPLACING ALL DAMAGED, STOLEN, DEAD, DECLINING OR LOST MATERIAL UNTIL COMPLETION OF MAINTENANCE PERIODS OR GUARANTEE PERIODS.
- IF NO IRRIGATION SYSTEM IS PLANNED, AN APPROPRIATE WATERING SCHEDULE SHALL BE ESTABLISHED BY THE LANDSCAPE CONTRACTOR FOR ALL PLANT MATERIAL BASED UPON PLANT SPECIES REQUIREMENTS AND PROVIDED IN WRITING TO THE LANDSCAPE ARCHITECT AND OWNER FOR REVIEW AND APPROVAL. THE APPROVED SCHEDULE SHOULD BE FOLLOWED UNTIL COMPLETION OF PLANT MAINTENANCE PERIODS OR WARRANTY PERIODS.
- ALL VEGETATION AND DEBRIS SHALL BE REMOVED FROM PROPOSED PLANTING AREAS PRIOR TO PLANTING AND BACKFILLING. CONTRACTOR SHALL REMOVE ALL WEEDS AND DEBRIS FROM SITE AS WORK PROGRESSES AND UNTIL COMPLETION OF PLANT MAINTENANCE PERIODS OR WARRANTY PERIODS.
- ALL AREAS TO BE HYDRO-SEEDED SHALL RECEIVE SIX INCHES (6") OF LOAM, MEASURED AFTER INSTALLATION, PRIOR TO SEEDING.
- ALL EXISTING LAWN AREAS DESIGNED TO REMAIN SHALL BE AERATED, FERTILIZED AND OVERSEEDDED, AS DIRECTED BY THE LANDSCAPE ARCHITECT.
- IN ADDITION TO LOCATIONS DEFINED FOR HYDRO-SEEDING ON THE PLANTING PLAN, THE CONTRACTOR SHALL BE RESPONSIBLE FOR RESTORING ANY DISTURBED LAWN AREAS AS DIRECTED.
- A DETAILED PLANT MAINTENANCE MANUAL SHALL BE ESTABLISHED BY THE LANDSCAPE CONTRACTOR FOR ALL PLANT MATERIAL BASED UPON PLANT SPECIES REQUIREMENTS AND PROVIDED IN WRITING TO THE LANDSCAPE ARCHITECT AND OWNER FOR REVIEW AND APPROVAL. INFORMATION THEREIN SHALL INCLUDE REQUIRED PRUNING SCHEDULE, FERTILIZING AND PROPOSED INTEGRATED PEST MANAGEMENT (IPM) AS NECESSARY. THE APPROVED MAINTENANCE SHOULD BE FOLLOWED UNTIL COMPLETION OF PLANT MAINTENANCE PERIODS OR WARRANTY PERIODS.
- LANDSCAPE CONTRACTOR IS RESPONSIBLE FOR MAINTAINING CLOSE COORDINATION WITH OWNER, GENERAL CONTRACTOR, RELATED SUBCONTRACTORS, LANDSCAPE ARCHITECT, AND ALL SITE WORK RELATED ITEMS.

ELECTRICAL NOTES:

- FURNISH AND INSTALL ALL LABOR, MATERIALS, APPLIANCES, EQUIPMENT TOOLS, TRANSPORTATION, SUPERVISION, AND SERVICES REQUIRED. COMPLETELY TEST AND MAKE OPERATIVE, ALL ELECTRICAL WORK AS OUTLINED IN THE DRAWINGS AND SPECIFICATIONS.
- THE ELECTRICAL WORK MAY INCLUDE, BUT NOT BE LIMITED TO, THE FURNISHING OF MATERIALS AND INSTALLATION OF THE FOLLOWING IN ACCORDANCE WITH ALL APPLICABLE STATE AND LOCAL CODES.
 - WIRING DEVICES
 - LIGHTING SYSTEM
 - CONDUIT, RACEWAYS, ETC.
 - BRANCH CIRCUIT WIRING
 - PANELBOARD CIRCUIT BREAKER
 - GROUNDING, WIRE, AND CABLE
- ALL WORK SHALL BE IN ACCORDANCE WITH THE LATEST REQUIREMENTS OF THE NEC, STATE OF RHODE ISLAND BUILDING CODE, OSHA, ADA, AND THE CITY OF PROVIDENCE, RI CODES AND STANDARDS AND SPECIFICATIONS.
- PAY FOR ALL INSPECTION FEES, LICENSES, AND PERMITS.
- SUBMIT SHOP DRAWINGS FOR ALL EQUIPMENT FOR APPROVAL BEFORE PURCHASING. ALL EQUIPMENT SHALL BEAR THE LABEL OF A NATIONALLY RECOGNIZED TESTING LABORATORY.
- PHOTOCELL (IF ONE DOES NOT EXIST)
 - PHOTOCELL SHALL BE MANUFACTURED BY TORK OR EQUAL.
 - FURNISH AND INSTALL A PHOTOCELL AS DIRECTED FOR THE CONTROL OF ALL LIGHTS.
- LIGHTING
 - FURNISH AND INSTALL ALL LIGHTING FIXTURES AS INDICATED ON THE DRAWINGS.
- GROUNDING
 - PROVIDE COMPLIANT GROUNDING FOR ALL ELECTRICAL EQUIPMENT AND DEVICES.
 - BONDING JUMPERS SHALL BE INSTALLED AT ALL LOCATIONS REQUIRED BY NEC.
 - GREEN GROUNDING CONDUCTOR OF PROPER SIZE SHALL BE INSTALLED AND CONNECTED WITH THE BRANCH CIRCUIT CONDUCTORS FROM THE PANELBOARD TO THE LIGHTING FIXTURE. CONNECTIONS TO THE EQUIPMENT SHALL BE BOLTED OR SCREWED USING CORROSION RESISTING BOLTS OR SCREWS. A GREEN GROUNDING CONDUCTOR SHALL BE INSTALLED IN ALL BRANCH AND FEEDER CIRCUITS.
- RACEWAYS
 - ALL EXPOSED EXTERIOR CONDUIT THAT RUNS OUTSIDE SHALL BE HOT DIPPED GALVANIZED STEEL CONDUIT.
- HANGERS AND SUPPORTS
 - PROVIDE ALL REQUIRED HANGERS, SUPPORTS, SLEEVES, CLAMPS, ETC., AS REQUIRED AND/OR AS INDICATED ON THE DRAWINGS.

- PULL AND JUNCTION BOXES
 - BOXES FOR EXTERIOR WORK SHALL MEET ANSI-SCTE TIER 15 MEDIUM DUTY RATING. SUCH AS OLDCASTLE SYNERTECH1212-18 MADE OF DUOMOLD COMPOSITE OR APPROVED EQUAL. STEEL OR ANY CONDUCTIVE BOXES WILL NOT BE PERMITTED.
- FEEDER AND BRANCH CIRCUIT CONDUCTORS
 - ALL FEEDER, BRANCH CIRCUIT, REMOTE CONTROL, SIGNAL CIRCUIT, AND INTERLOCK WIRING SHALL BE MANUFACTURED OF COPPER AND RATED 600 VOLTS.
 - MINIMUM SIZE WIRE FOR BRANCH CIRCUIT AND POWER WIRING SHALL BE #12 AWG.
 - INSULATION SHALL BE TYPE THHN/THWN FOR LIGHTING.
 - ALL WIRING SHALL CONFORM TO THE NEC FOR CONSTRUCTION AND USE.
- WIRING DEVICES
 - FURNISH AND INSTALL WIRING DEVICES AND SPECIFICATION GRADE, COMPLETE WITH ALL ACCESSORIES AS INDICATED ON THE DRAWINGS AND AS SPECIFIED HEREUNDER. ALL WIRING DEVICES SHALL BE THE PRODUCT OF A SINGLE MANUFACTURER EXCEPT WHERE SPECIFICALLY STATED OTHERWISE.
- FURNISH AND INSTALL NAME PLATES ON ALL ELECTRICAL EQUIPMENT.
- ALL EQUIPMENT EXPOSED TO MOISTURE SHALL BE OF THE APPROPRIATE (NEMA) WEATHERPROOF TYPE. SEAL ALL CONDUITS THAT PENETRATE.
- PERFORM ALL TESTS REQUIRED AND VERIFY PHASE BALANCE OF THE PANELBOARD.
 - COMPLETE TEST AND INSPECTION RECORDS SHALL BE MADE AND INCORPORATED INTO A REPORT FOR EACH PIECE OF EQUIPMENT TESTED. ALL READINGS TAKEN SHALL BE RECORDED. TEST REPORTS SHALL BE SUBMITTED TO THE CITY'S REPRESENTATIVE FOR APPROVAL.
 - FURNISH NECESSARY METERS, INSTRUMENTS, TEMPORARY WIRING, AND LABOR TO PERFORM ALL REQUIRED TESTS AND ADJUSTMENTS OF EQUIPMENT AND WIRING INSTALLED AND/OR CONNECTED UNDER THIS CONTRACT, INCLUDING ELECTRICAL EQUIPMENT FURNISHED BY OTHERS, TO DETERMINE PROPER POLARITY, PHASING, FREEDOM FROM GROUND AND SHORTS AND OPERATION OF EQUIPMENT. ALL MEASURING INSTRUMENTS SHALL BE PROPERLY CALIBRATED.
 - ALL MATERIALS AND MANNER OF INSTALLATION SHALL BE IN STRICT ACCORDANCE WITH THE APPLICABLE REQUIREMENTS OF STATE AND LOCAL AUTHORITIES, THE UTILITY COMPANY, AND THE CODES OF THE NATIONAL BOARD OF UNDERWRITERS.
 - WHENEVER ANY OF THE AFOREMENTIONED CODES, LAWS, ETC. REQUIRE THAT ANY WORK BE TESTED OF APPROVED, THE CONTRACTOR SHALL PROVIDE PROPER FACILITIES FOR ACCESS AND FOR INSPECTION, ALL AT THEIR OWN EXPENSE.
 - WIRING
 - THE CONTRACTOR SHALL CORRECT OR REPLACE ANY NOMINAL CURRENT-CARRYING CIRCUIT WHICH IS DEFECTIVE OR GROUNDED AND HE SHALL ALSO CORRECT ALL OTHER TROUBLES ENCOUNTERED BY THESE TESTS. ALL DEFECTS WHETHER THROUGH FAULTY WORKMANSHIP OF MATERIAL FURNISHED SHALL BE CORRECTED UNDER THIS SECTION AT THE CONTRACTOR'S EXPENSE.
- ALL ELECTRICAL WORK SHALL BE GUARANTEED FOR A PERIOD OF ONE YEAR FROM DATE OF FINAL ACCEPTANCE. DEFECTS SHALL BE CORRECTED WITHOUT CHARGE, INCLUDING ALL PATCHING, PAINTING, AND OTHER INCIDENTAL REPAIRS AND REPLACEMENTS. COORDINATE ALL WORK WITH OTHER TRADES. FURNISH AND INSTALL ALL POWER AND CONTROL WIRING FOR A COMPLETE INSTALLATION.
- ALL ELECTRICAL EQUIPMENT, MATERIALS, ETC. STORED ON SITE SHALL BE STORED IN SUCH A MANNER THAT IT IS SAFE FROM DAMAGE BY MOISTURE, IMPACT, ETC.
- ELECTRICAL CONTRACTOR SHALL PERFORM THEIR WORK IN A NEAT AND ORDERLY, PROFESSIONAL MANNER. ALL REFUSE, DIRT, AND DEBRIS RESULTANT FROM THE WORK SHALL BE REMOVED AND PROPERLY DISPOSED OF AT THE END OF THE DAY.
 - ALL WORK ALL WORK SHALL BE EXECUTED BY A STATE OF RHODE ISLAND LICENSED ELECTRICIAN AND SHALL BE EXECUTED IN A PROFESSIONAL MANNER.
- ELECTRICAL CONTRACTOR IS REQUIRED TO COORDINATE THEIR WORK WITH ALL UTILITIES INVOLVED.
- ELECTRICAL CONTRACTOR IS RESPONSIBLE FOR FOLLOWING THE MANUFACTURER'S INSTALLATION RECOMMENDATIONS AND DIRECTIONS FOR ALL EQUIPMENT AND MATERIALS USED.
- UPON COMPLETION OF THE WORK, THE ELECTRICAL CONTRACTOR SHALL BE REQUIRED TO DEMONSTRATE PROPER OPERATION OF THE LIGHTING SYSTEM.
- ALL MATERIALS SHALL BE NEW AND SHALL CONFORM TO THE NEMA NATIONAL ELECTRIC CODE (NEC) AND UNDERWRITERS LABORATORIES, INC. STANDARDS IN EVERY CASE WHERE SUCH A STANDARD HAS BEEN ESTABLISHED FOR THE PARTICULAR TYPE OF MATERIAL IN QUESTION.
- ANY MATERIAL ITEM OR WORK NOT SHOWN ON THE DRAWINGS BUT MENTIONED ON THE SPECIFICATIONS OR VICE-VERSA, OR ANY ACCESSORIES NECESSARY TO MAKE THE WORK COMPLETE IN ALL RESPECTS AND READY FOR OPERATION SHALL BE INCLUDED IN THE CONTRACTOR'S BID, AND SUCH ITEMS SHALL NOT BE A CAUSE FOR EXTRA WORK OR EXTRA COST TO THE CITY.
- THE ELECTRICAL CONTRACTOR SHALL VISIT THE SITE TO MAKE THEMSELF AWARE OF THE EXISTING CONDITIONS AND EXISTING EQUIPMENT.
- RECORD DRAWINGS
 - CONTRACTOR SHALL PREPARE A COMPLETE SET OF RECORD CONSTRUCTION DRAWINGS AND SUBMIT THEM TO THE CITY'S REPRESENTATIVE FOR APPROVAL.
- SUBMIT SHOP DRAWINGS AND PRODUCT DATA WITHIN 10 DAYS AFTER AWARD OF CONTRACT. CHECK, STAMP, AND MARK SUBMITTALS WITH PROJECT NAME BEFORE TRANSMITTING TO THE CITY'S REPRESENTATIVE.
- WHERE MATERIAL IS CALLED OUT IN THE LEGEND, FIXTURE SCHEDULE, NOTES, SPECIFICATIONS, OR ELSEWHERE BY THE MANUFACTURER, TYPE OR CATALOG NUMBER, SUCH DESIGNATIONS ARE TO ESTABLISH STANDARDS OF DESIRED QUALITY. ACCEPTANCE OR REJECTIONS OF PROPOSED SUBSTITUTIONS SHALL BE SUBJECT TO THE APPROVAL OF THE CITY'S REPRESENTATIVE.
- FINAL INSPECTION
 - WHEN THE WORK ON THIS PROJECT HAS BEEN COMPLETED AND IS READY FOR FINAL INSPECTION, SUCH INSPECTION WILL BE MADE. AT THIS TIME, THE CONTRACTOR FOR THE WORK OF THIS SECTION, SHALL DEMONSTRATE THAT THE REQUIREMENTS OF THESE SPECIFICATIONS HAVE BEEN MET. WRITTEN RESULTS FOR ALL TESTS SHALL BE SUBMITTED TO THE CITY'S REPRESENTATIVE.

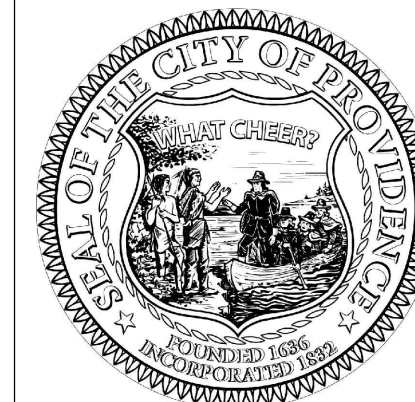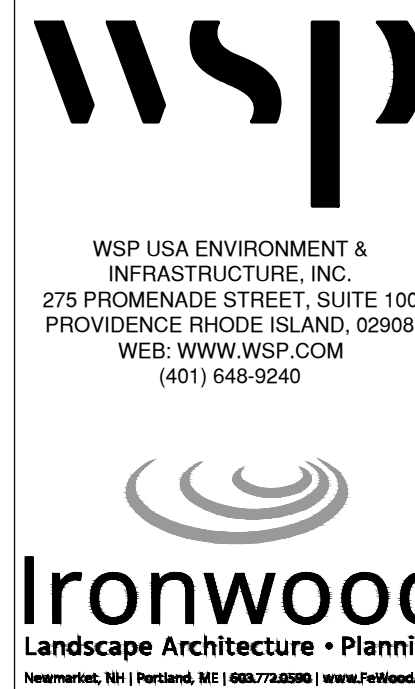

SEAL:



REV	DATE	DESCRIPTION

CLIENT:
PROVIDENCE PARKS DEPARTMENT
 DALRYMPLE BOATHOUSE, MAPLE AVE,
 PROVIDENCE, RI 02905


PROJECT:
SITE IMPROVEMENTS AT INDIA POINT PARK
 103 INDIA STREET
 PROVIDENCE, RI 02905

TITLE:
LANDSCAPE NOTES

ISSUED FOR: BID
 DATE: MARCH 25, 2024
 SCALE: AS NOTED
 DRAWN BY: S.WRIGHT, J.HYLAND
 CHECKED BY: J.HYLAND, D.JENSEN
 WSP PROJECT NO: 362210316

L3.0

PLEASE NOTE: THIS DOCUMENT MAY NOT ACCURATELY REPRESENT THE FINAL DOCUMENT. ONLY AN ENGINEER, ARCHITECT OR SURVEYOR
 SEEN, SEALED AND DATED PAPER COPY PROVIDED BY THIS OFFICE MAY BE UTILIZED FOR BIDDING OR CONSTRUCTION PURPOSES.

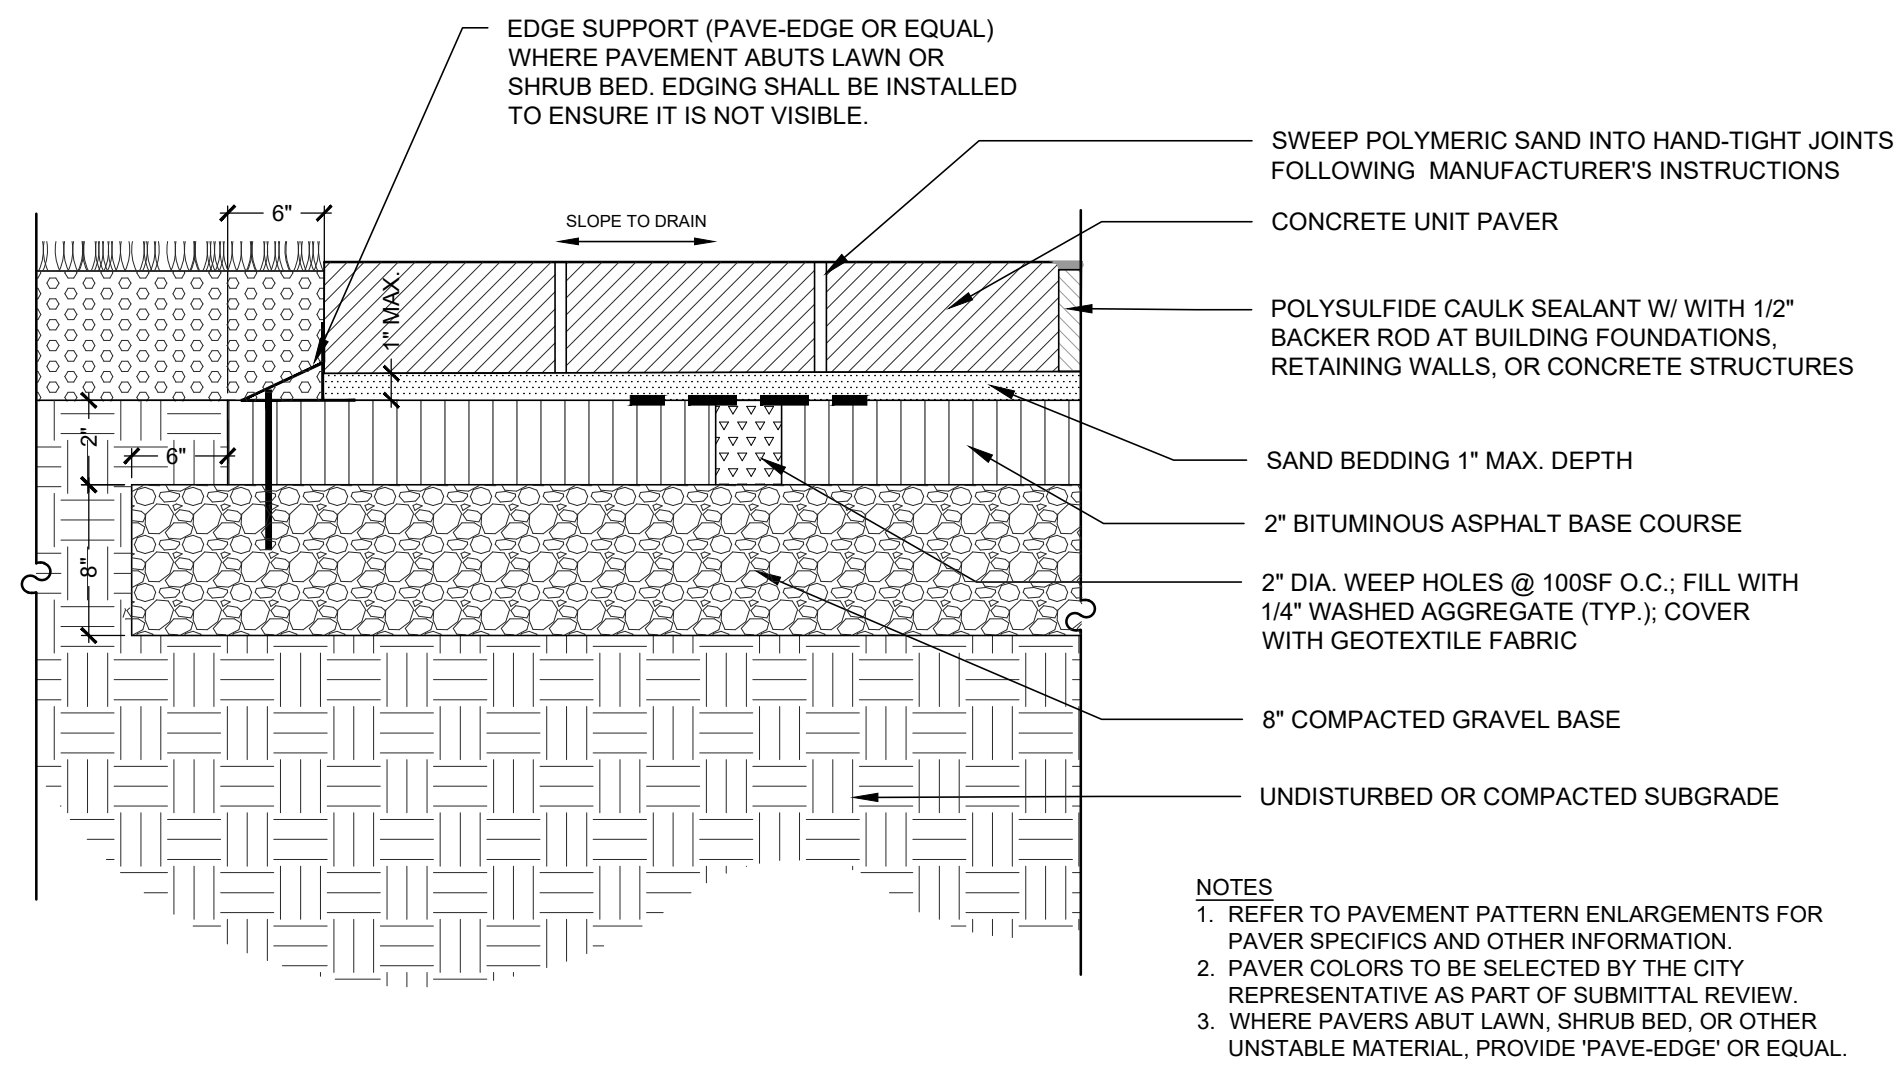


Concrete Paver

Not to Scale

©IRONWOOD 2024

1
L 3.1

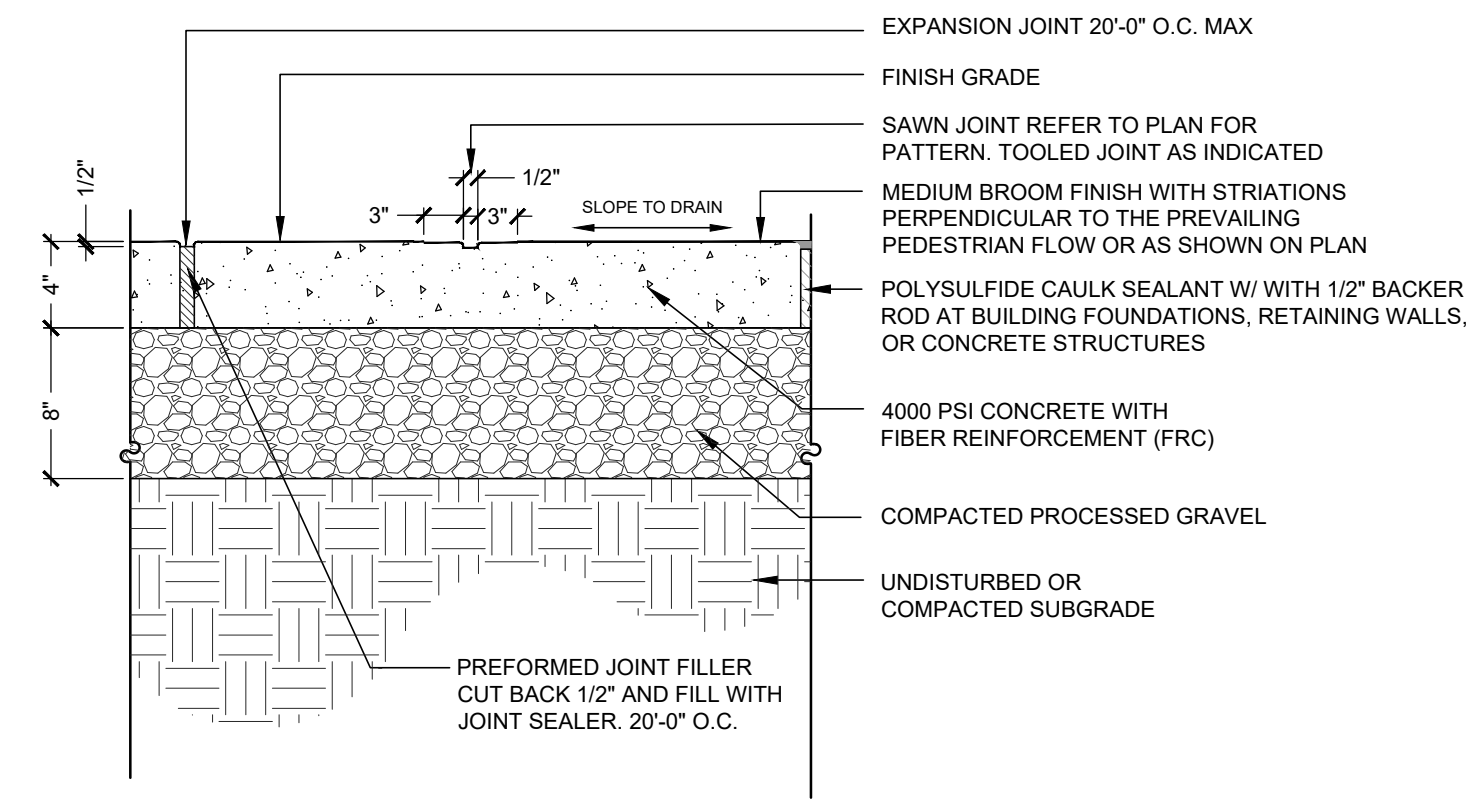


Concrete Pavement

Not to Scale

©IRONWOOD 2023

2
L 3.1

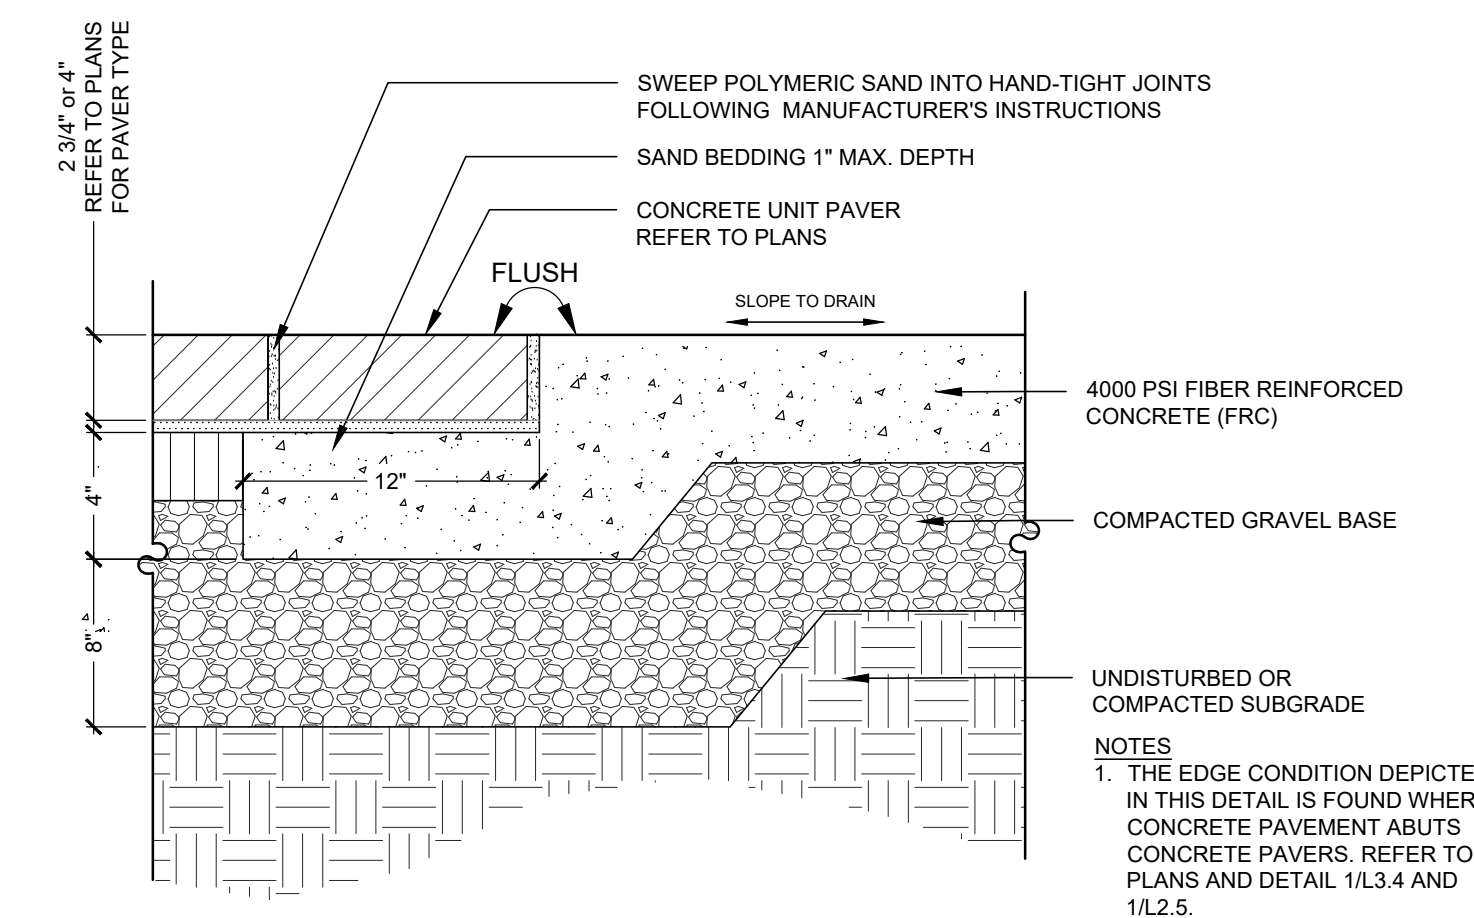


Concrete Pavement - Concrete Paver Edge

Not to Scale

©IRONWOOD 2024

3
L 3.1

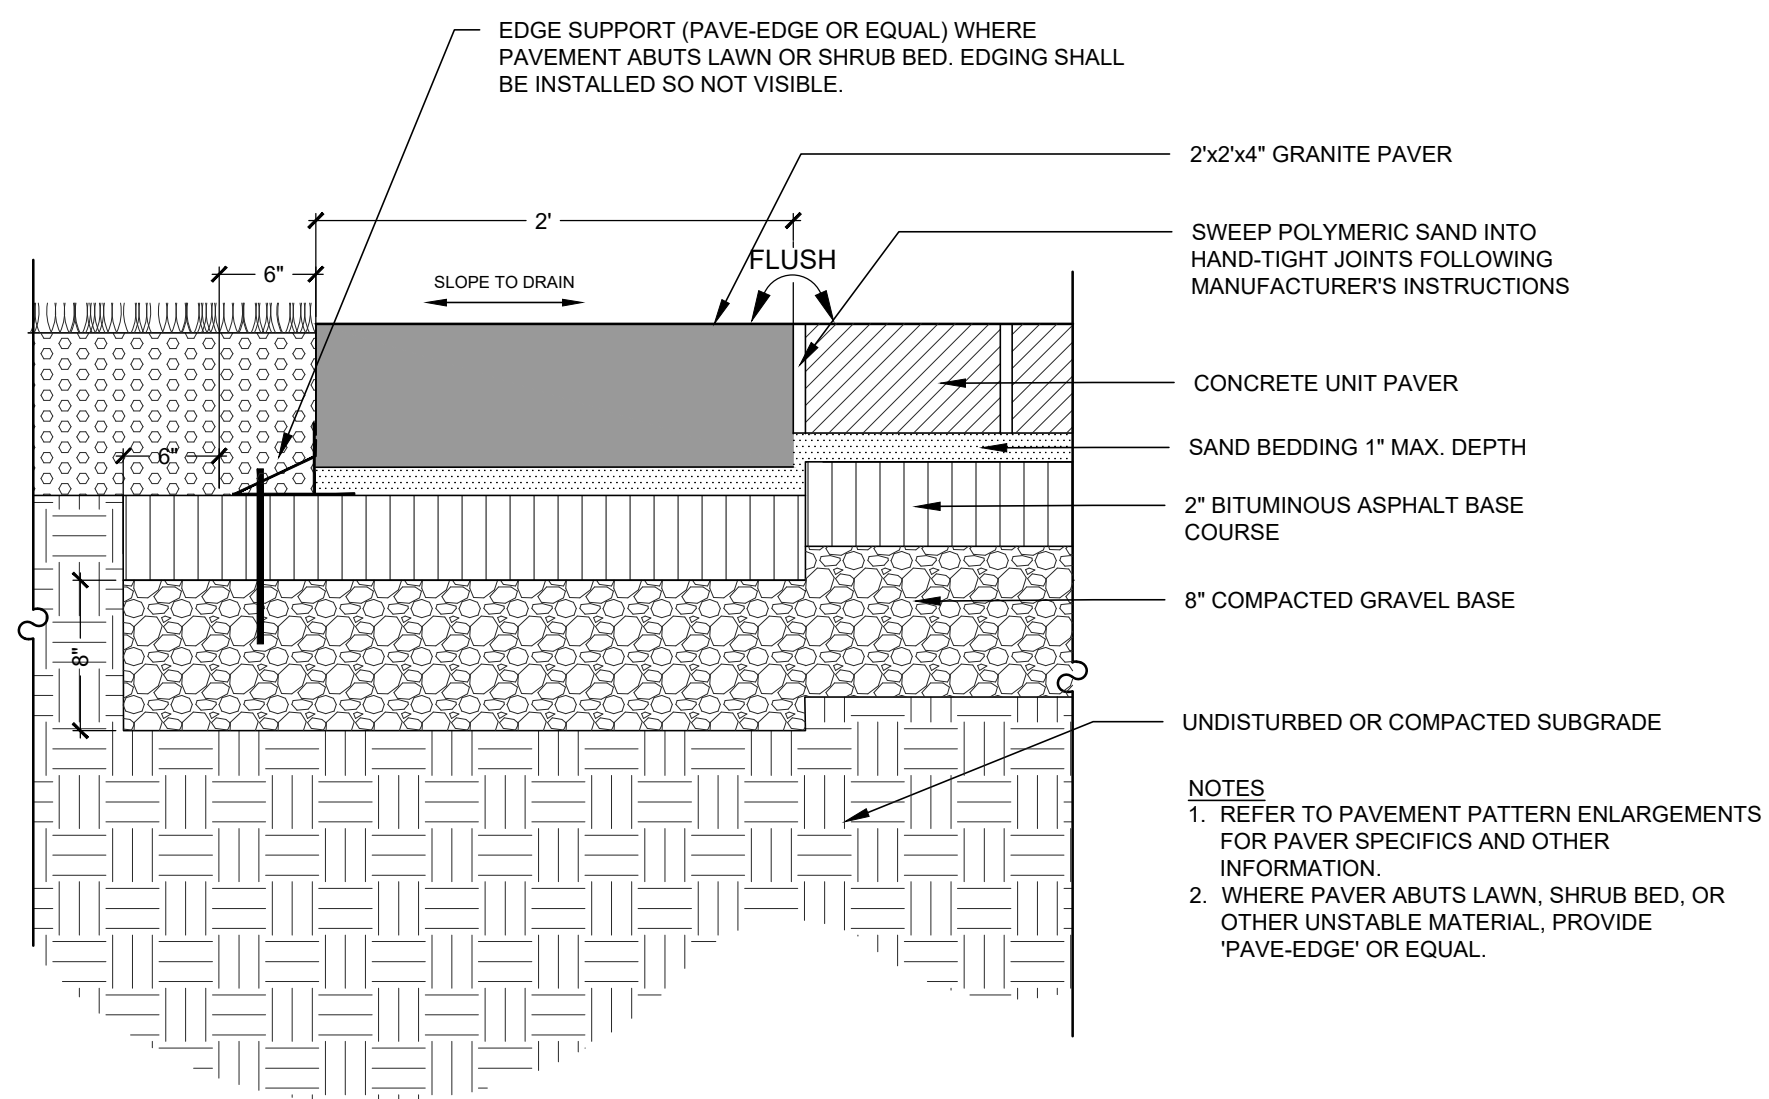


Granite Paver

Not to Scale

©IRONWOOD 2024

4
L 3.1

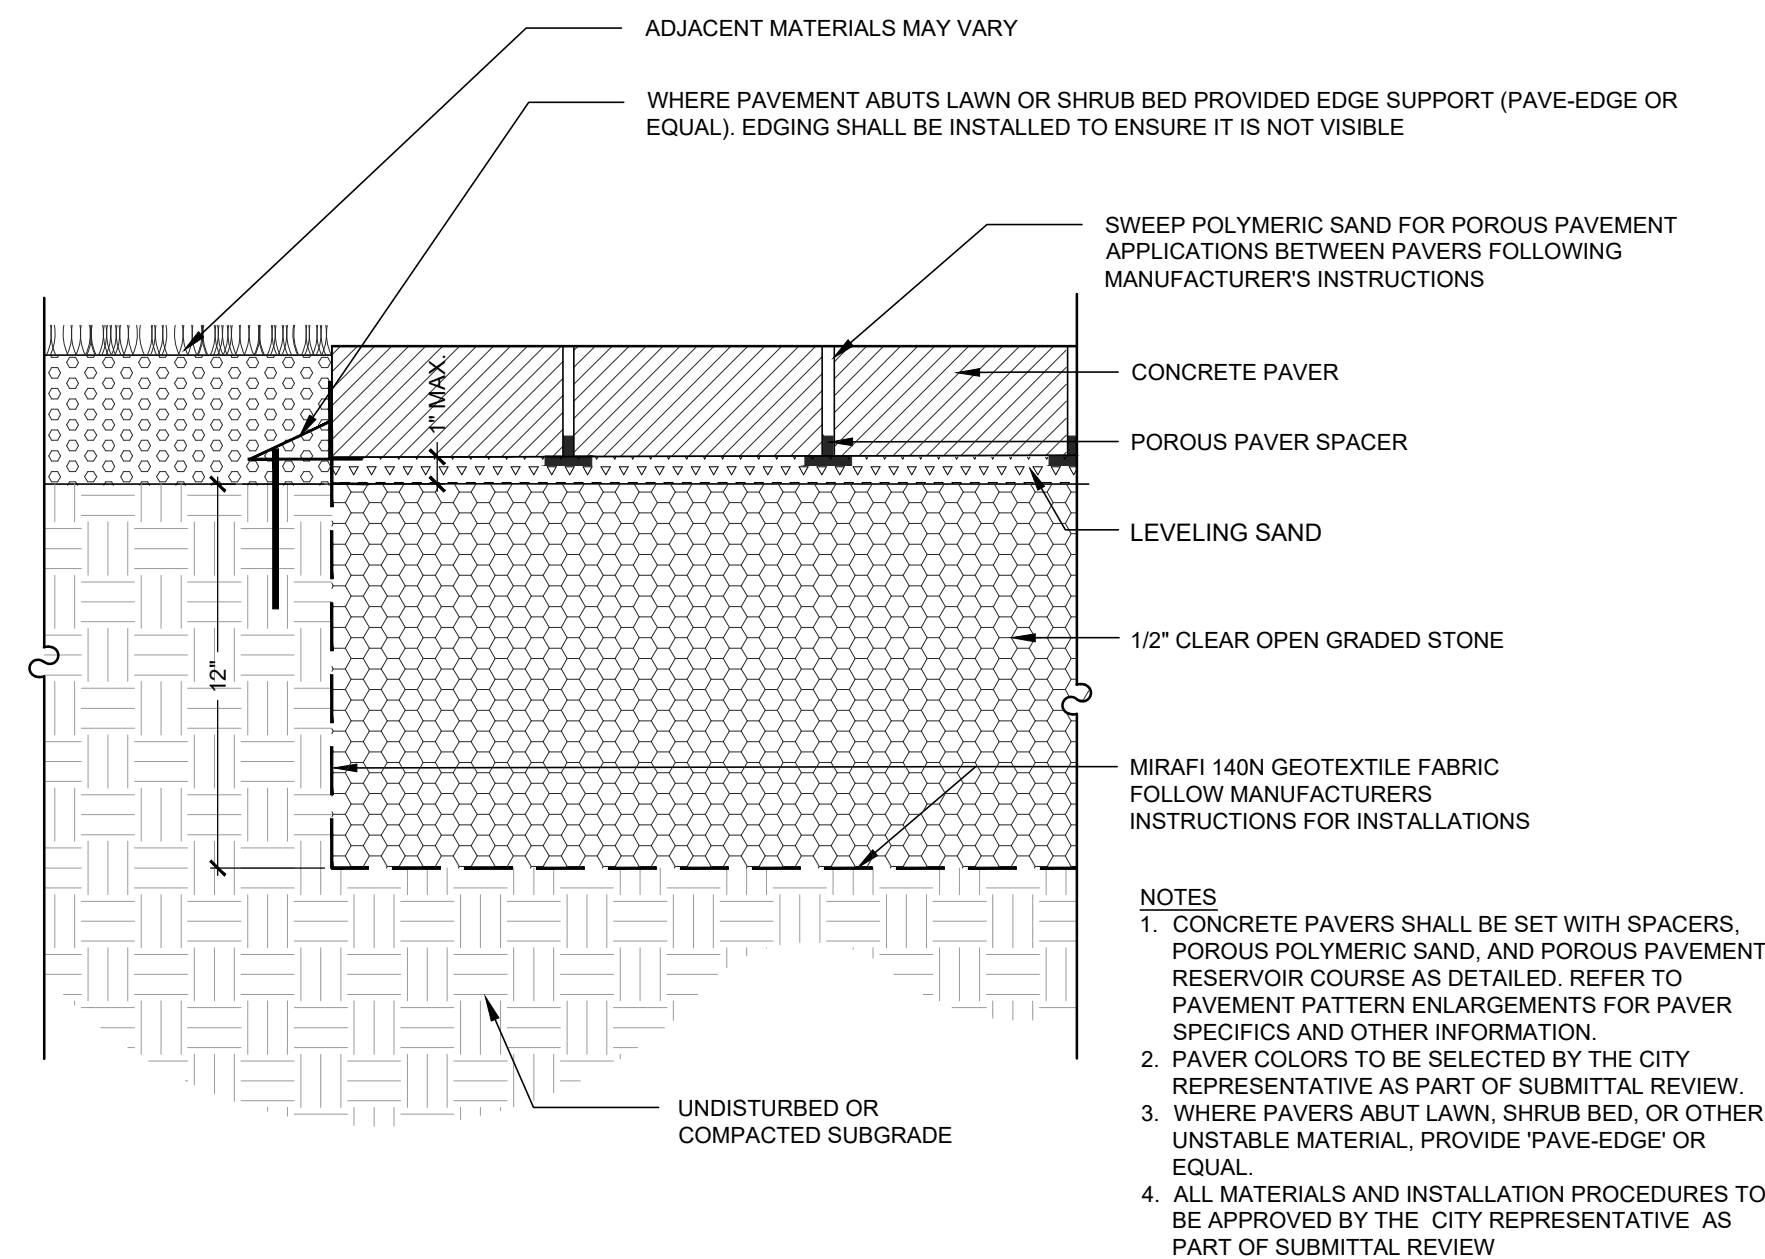


Porous Pavers (Add Alternate #4)

Not to Scale

©IRONWOOD 2024

5
L 3.1

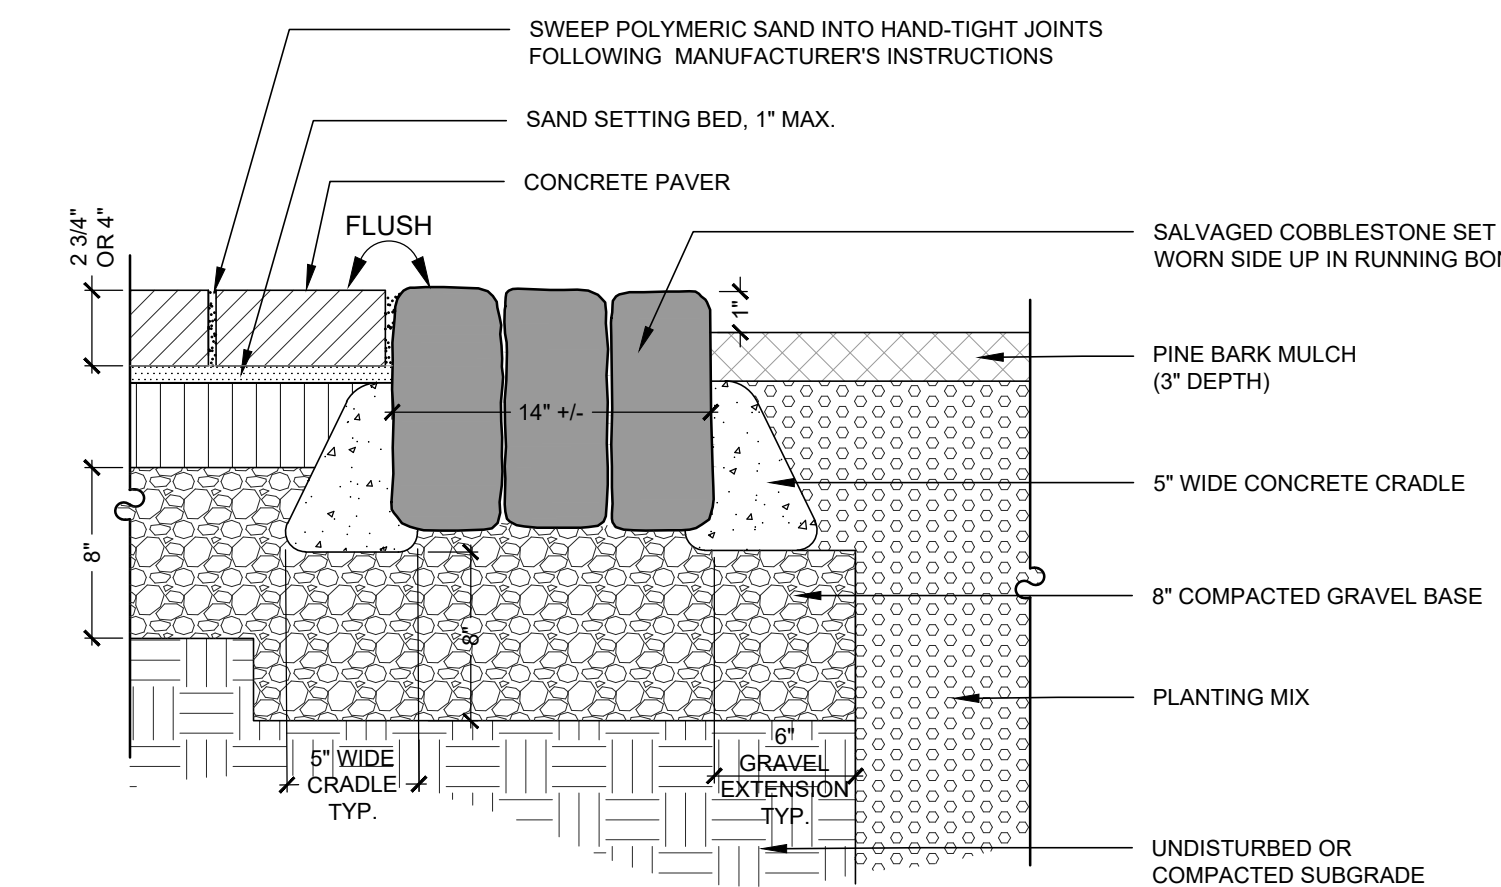


Cobblestone Border

Not to Scale

©IRONWOOD 2024

6
L 3.1

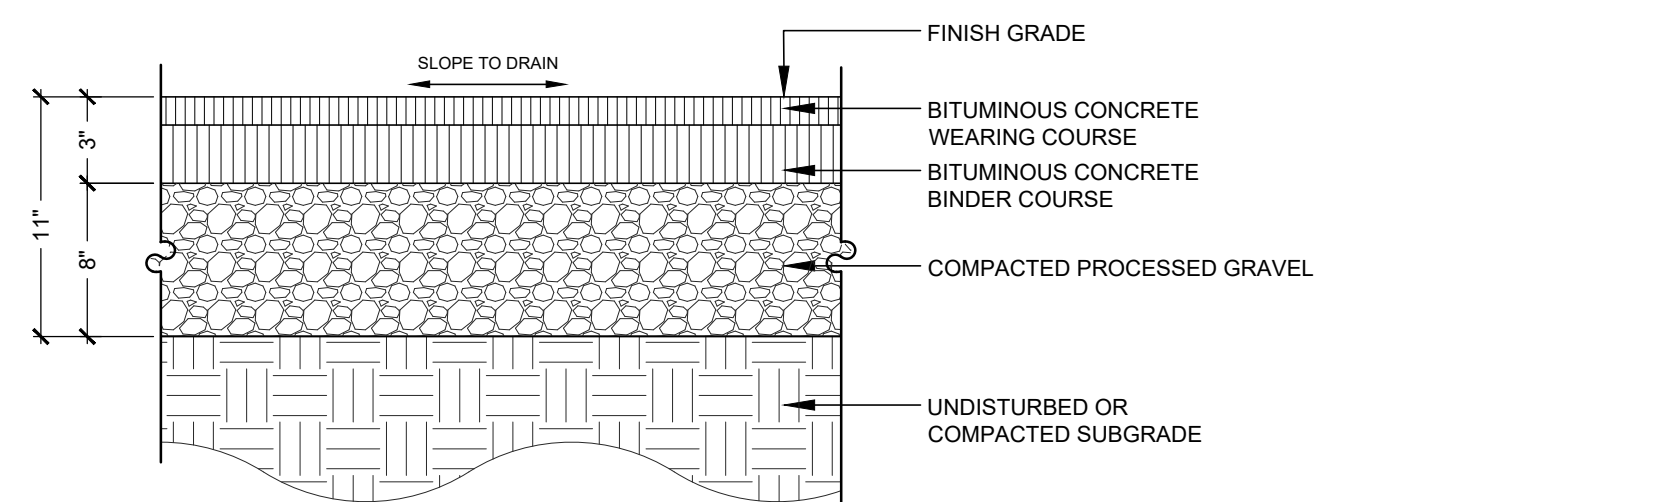


Bituminous Pavement

Not to Scale

©IRONWOOD 2024

7
L 3.1

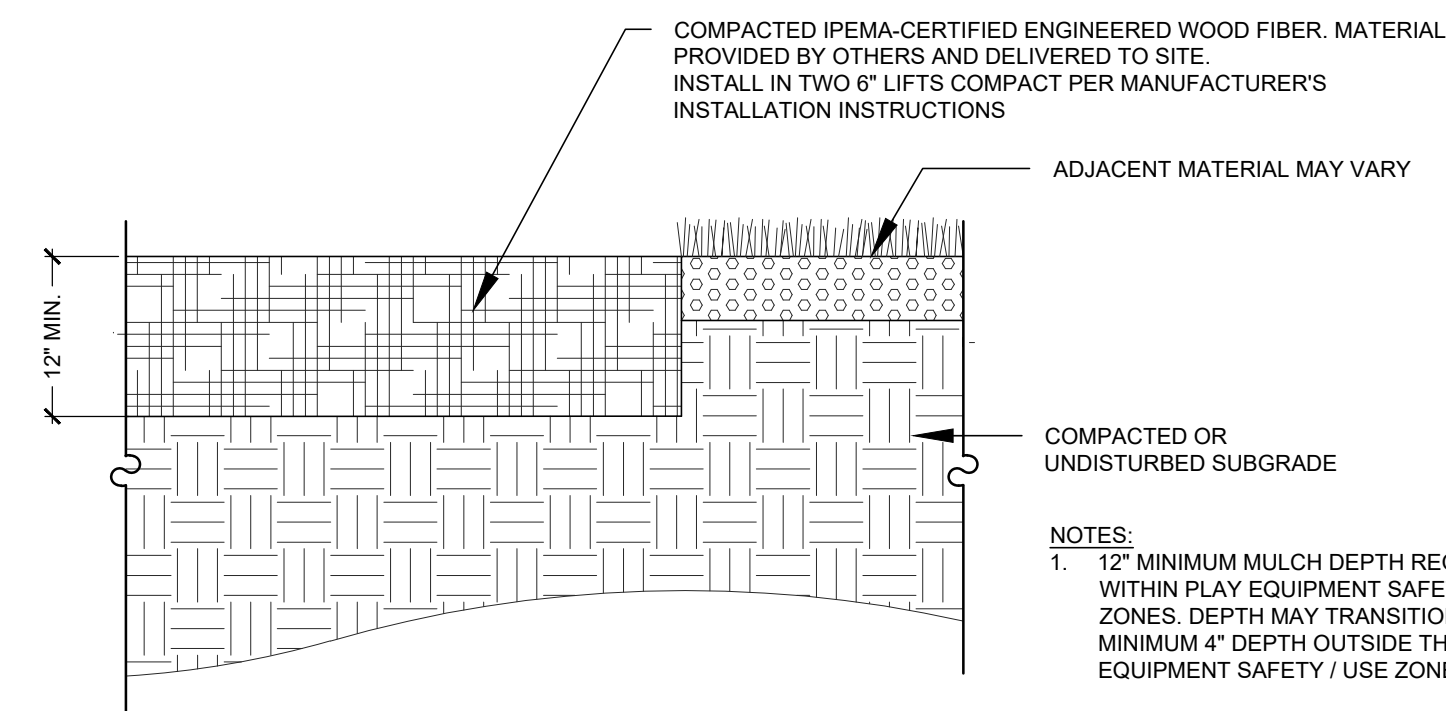


Engineered Wood Fiber Mulch

Not to Scale

©IRONWOOD 2023

8
L 3.1

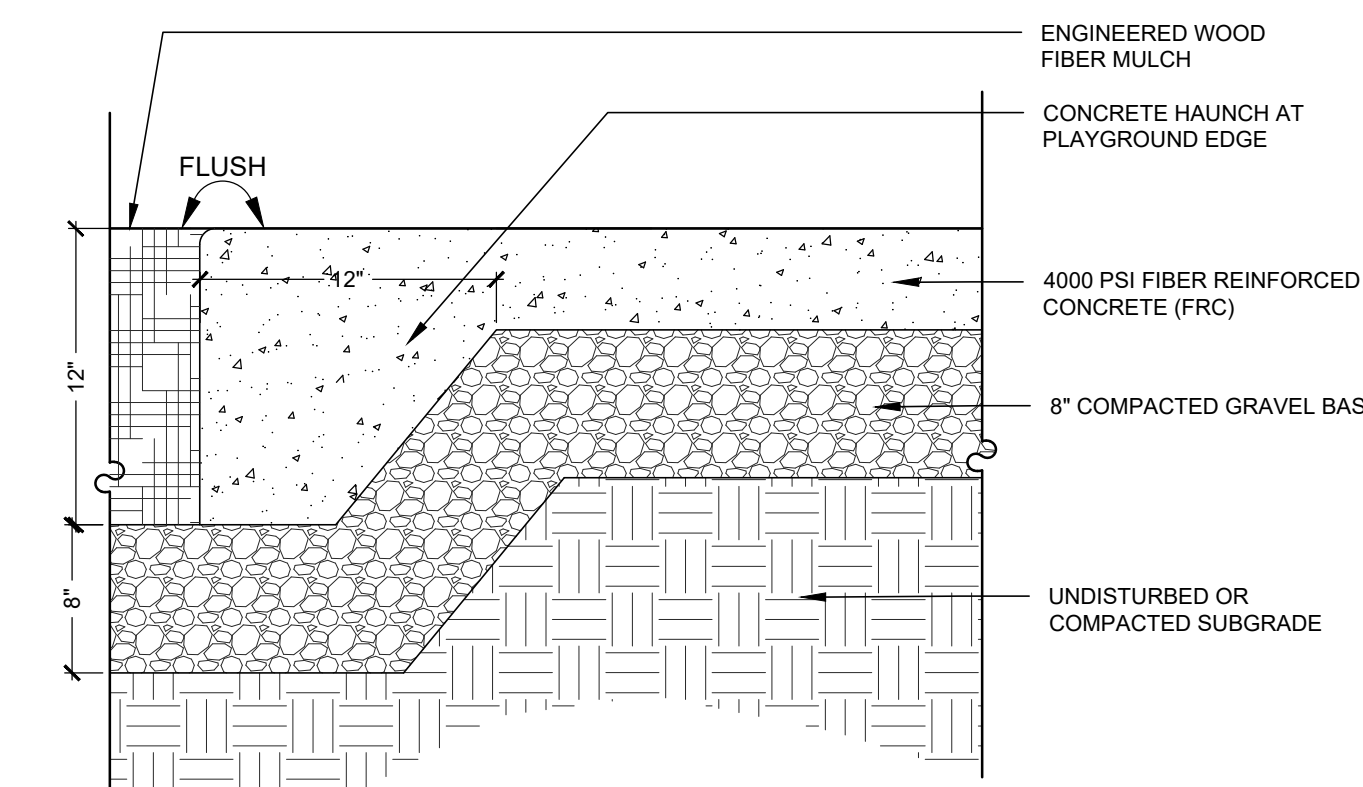


Concrete Haunch

Not to Scale

©IRONWOOD 2024

9
L 3.1

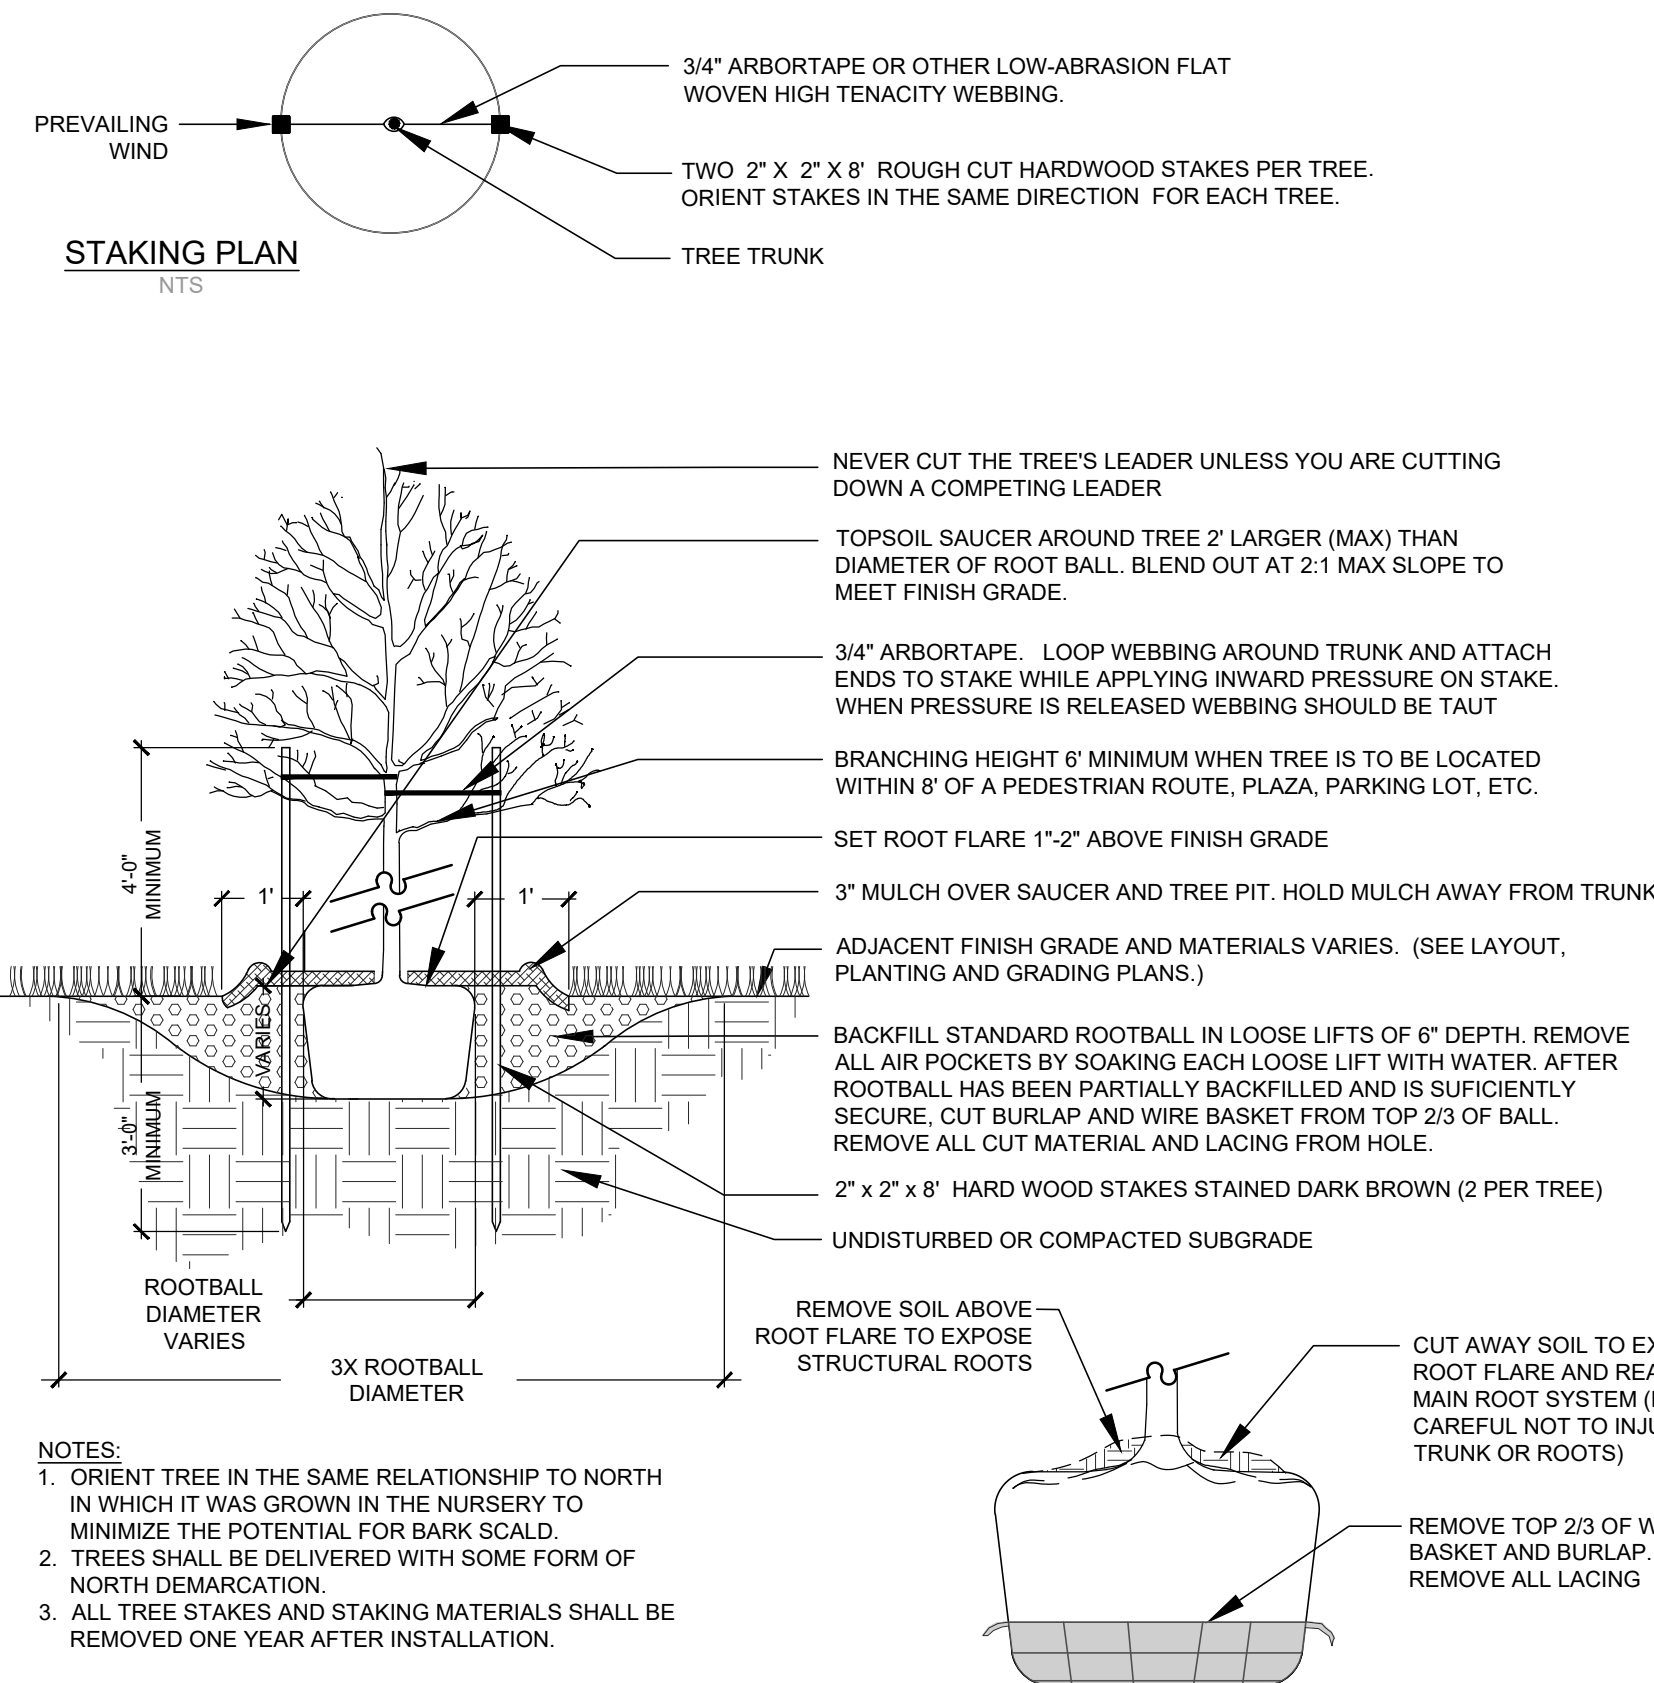


Deciduous Single-Stemmed Tree Planting

Not to Scale

©IRONWOOD 2023

4' Welded Wire Fence


Not to Scale

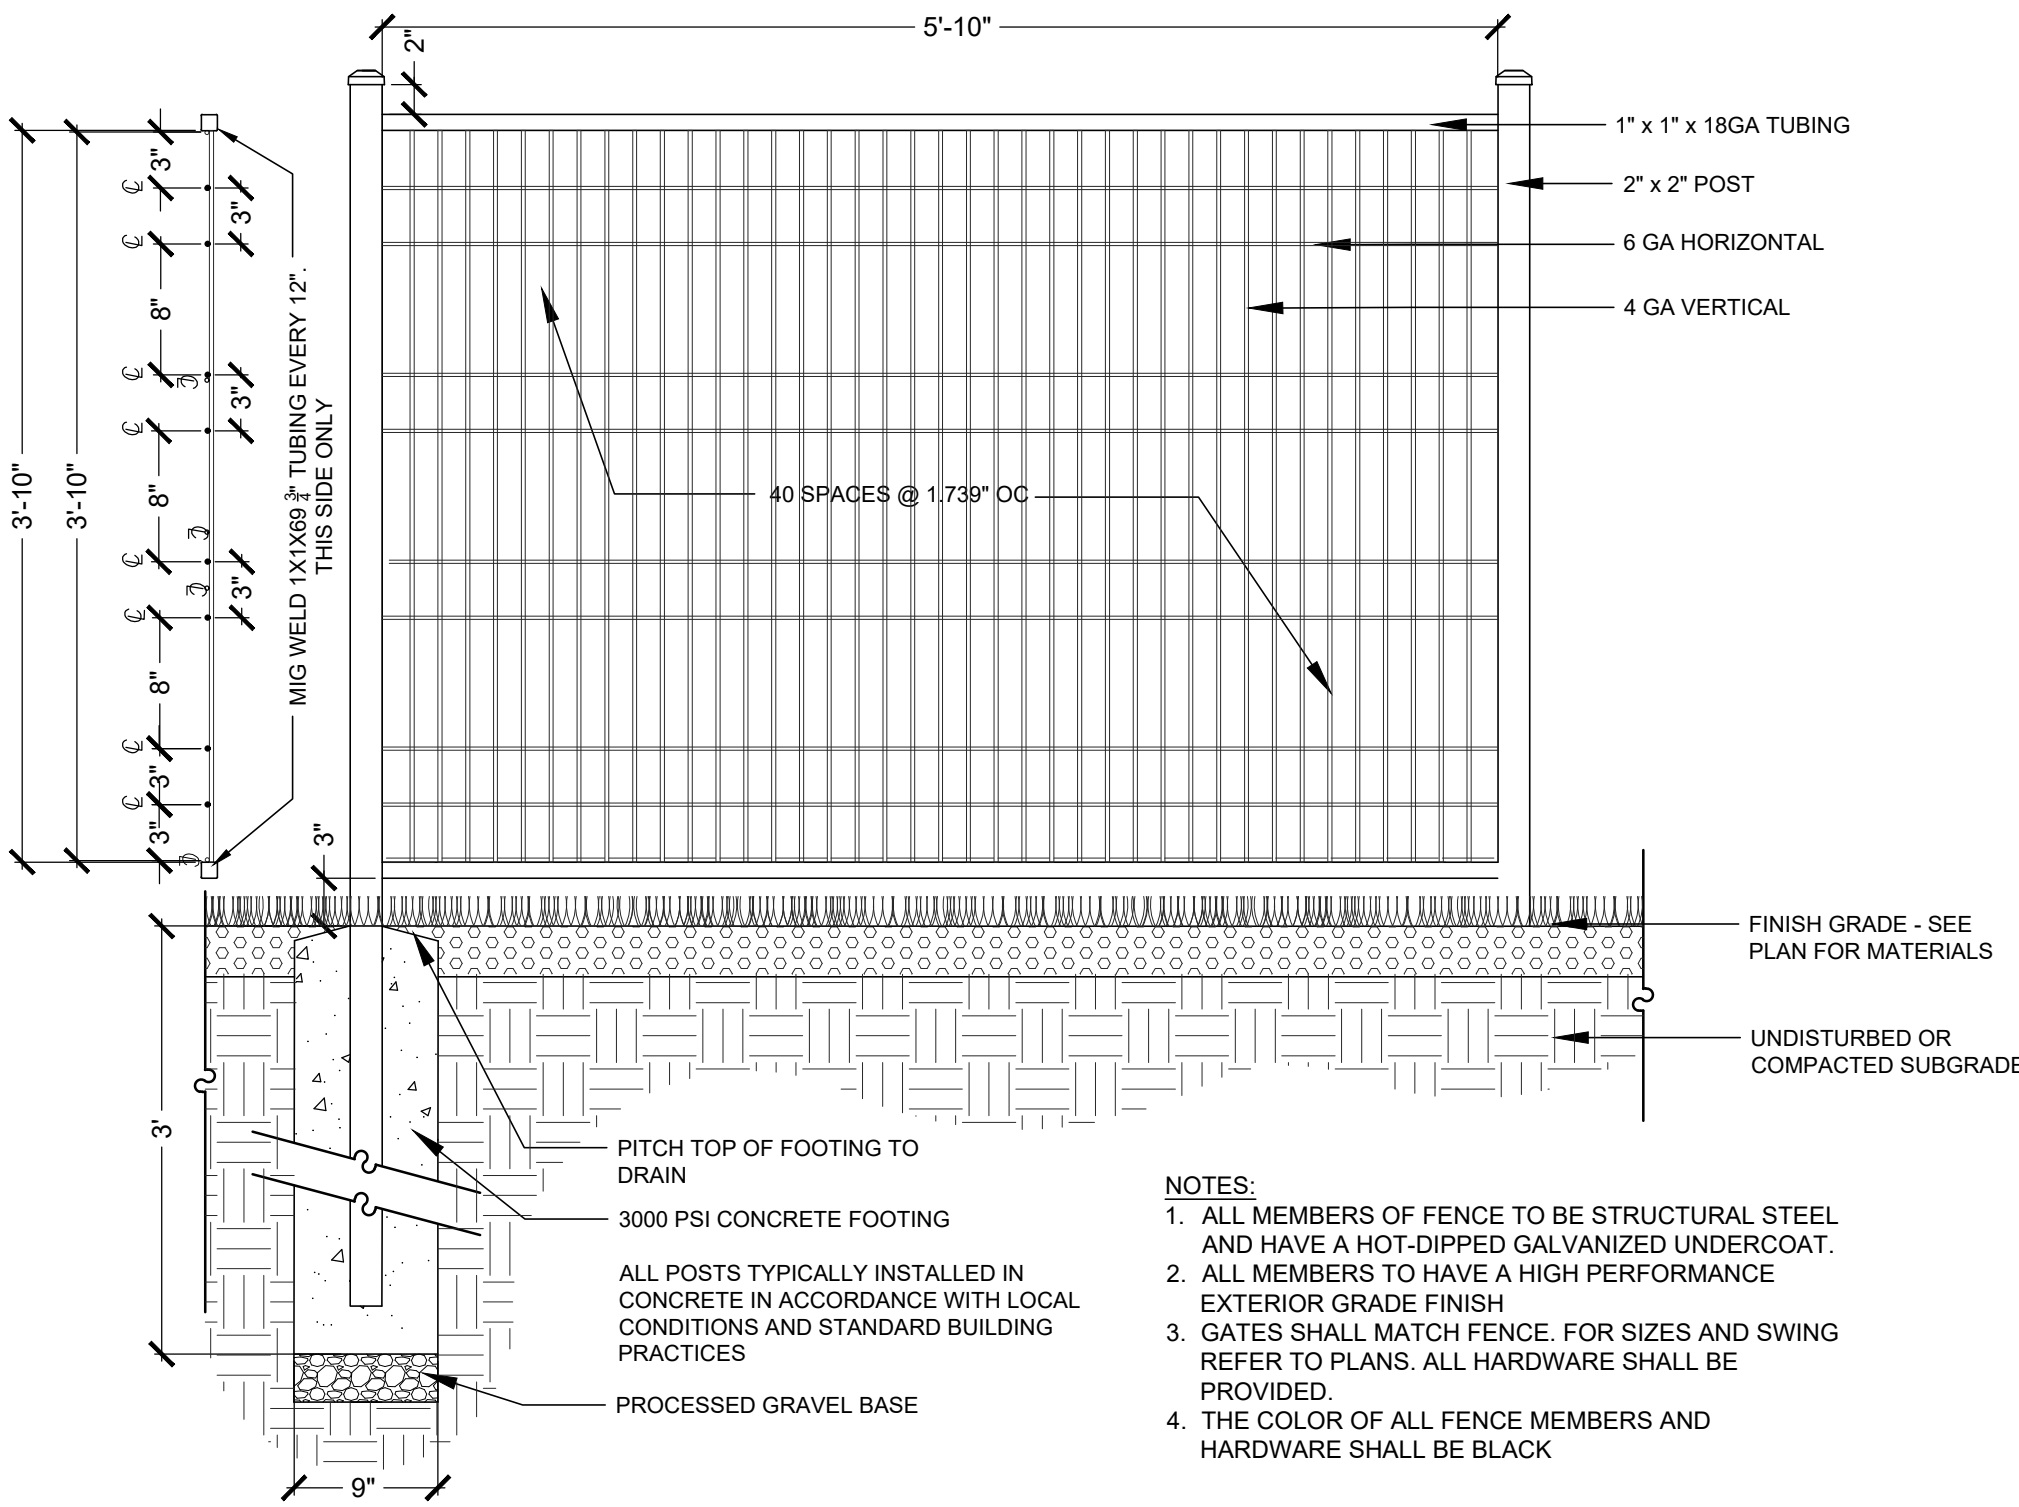

Wood Guardrail


Not to Scale

©IRONWOOD 2024

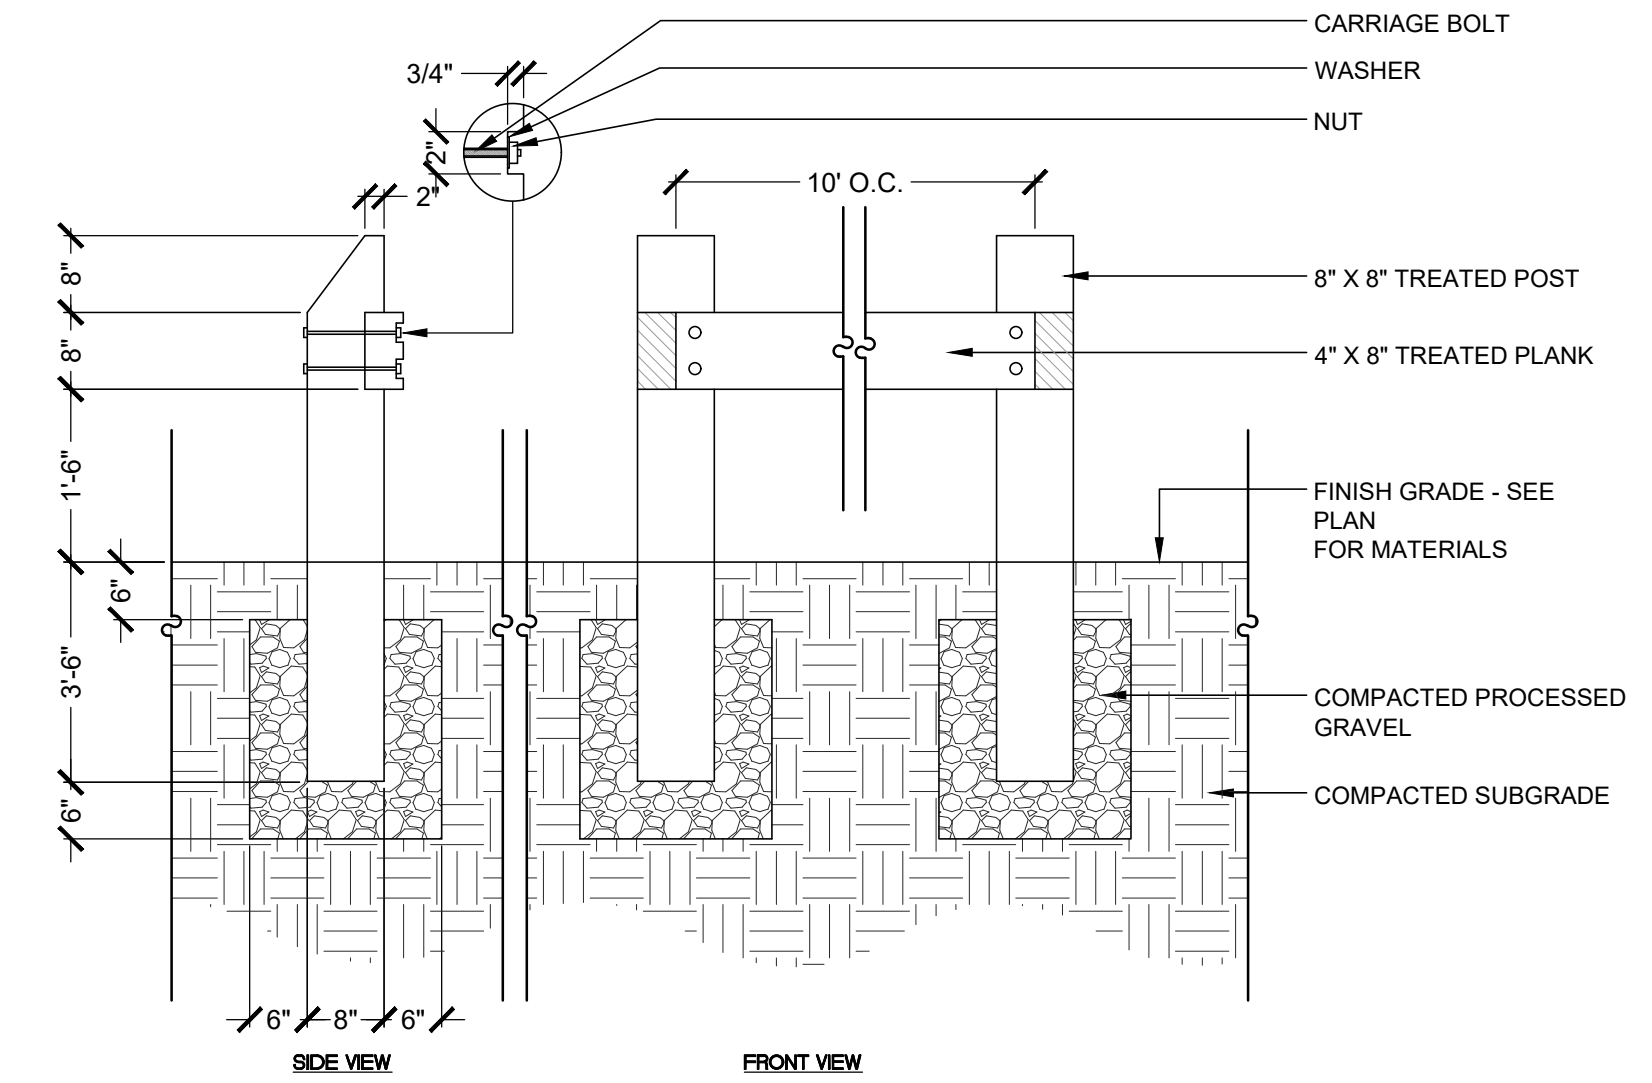

©IRONWOOD 2024

L3.3

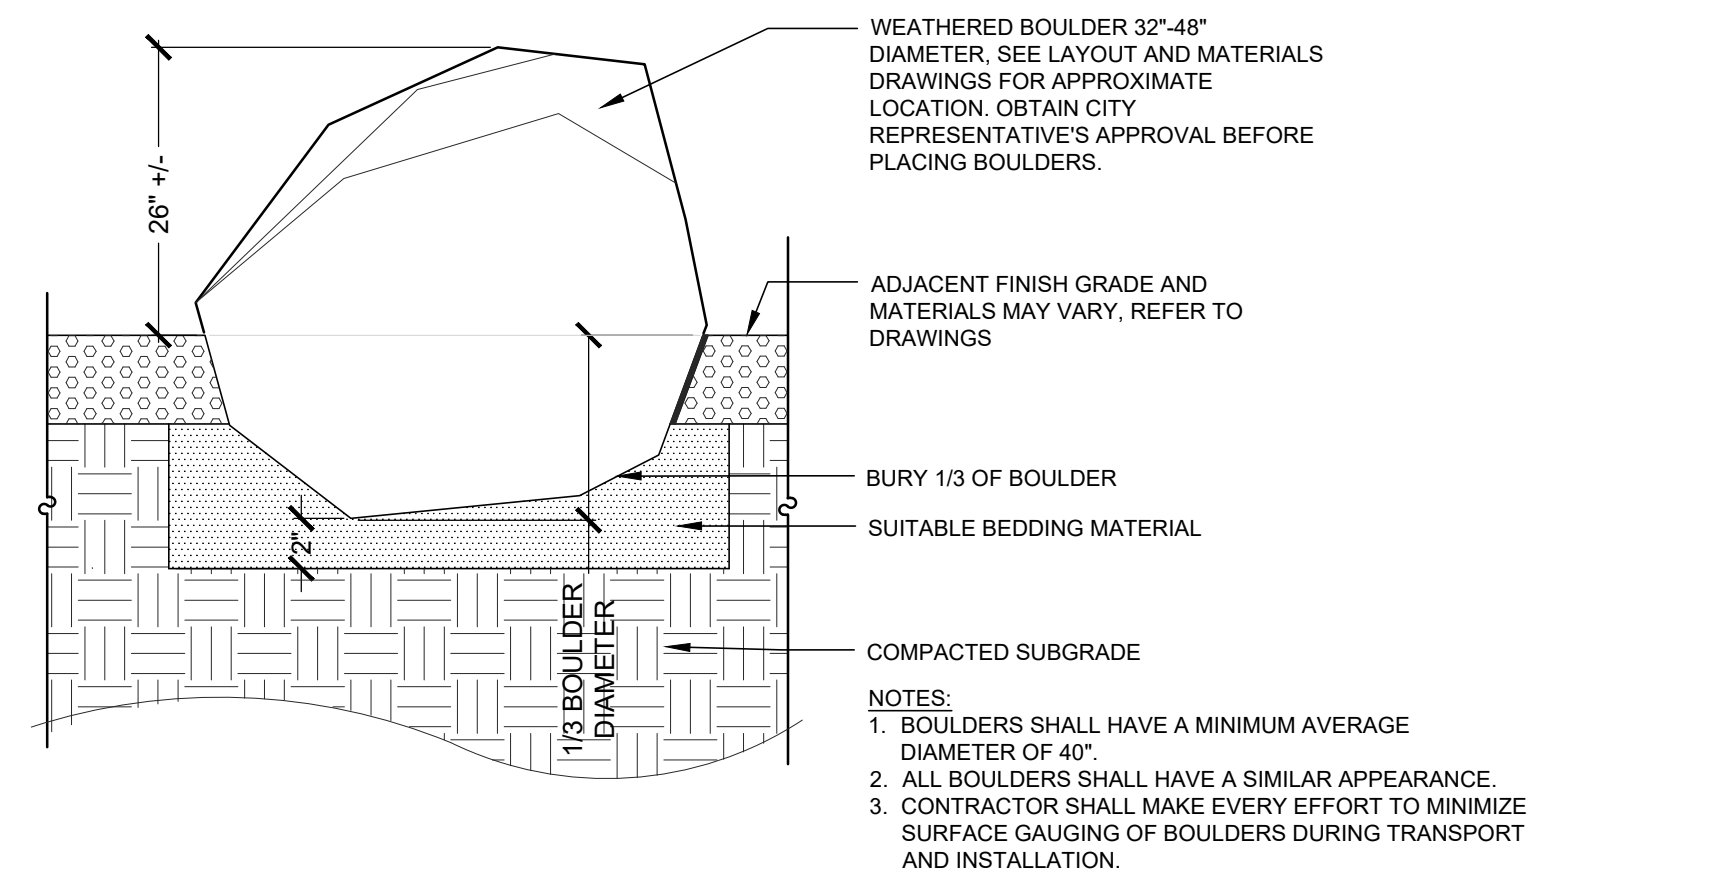

Boulder

Not to Scale


©IRONWOOD 2024

L3.3

Wear Mat

Not to Scale

©IRONWOOD 2024

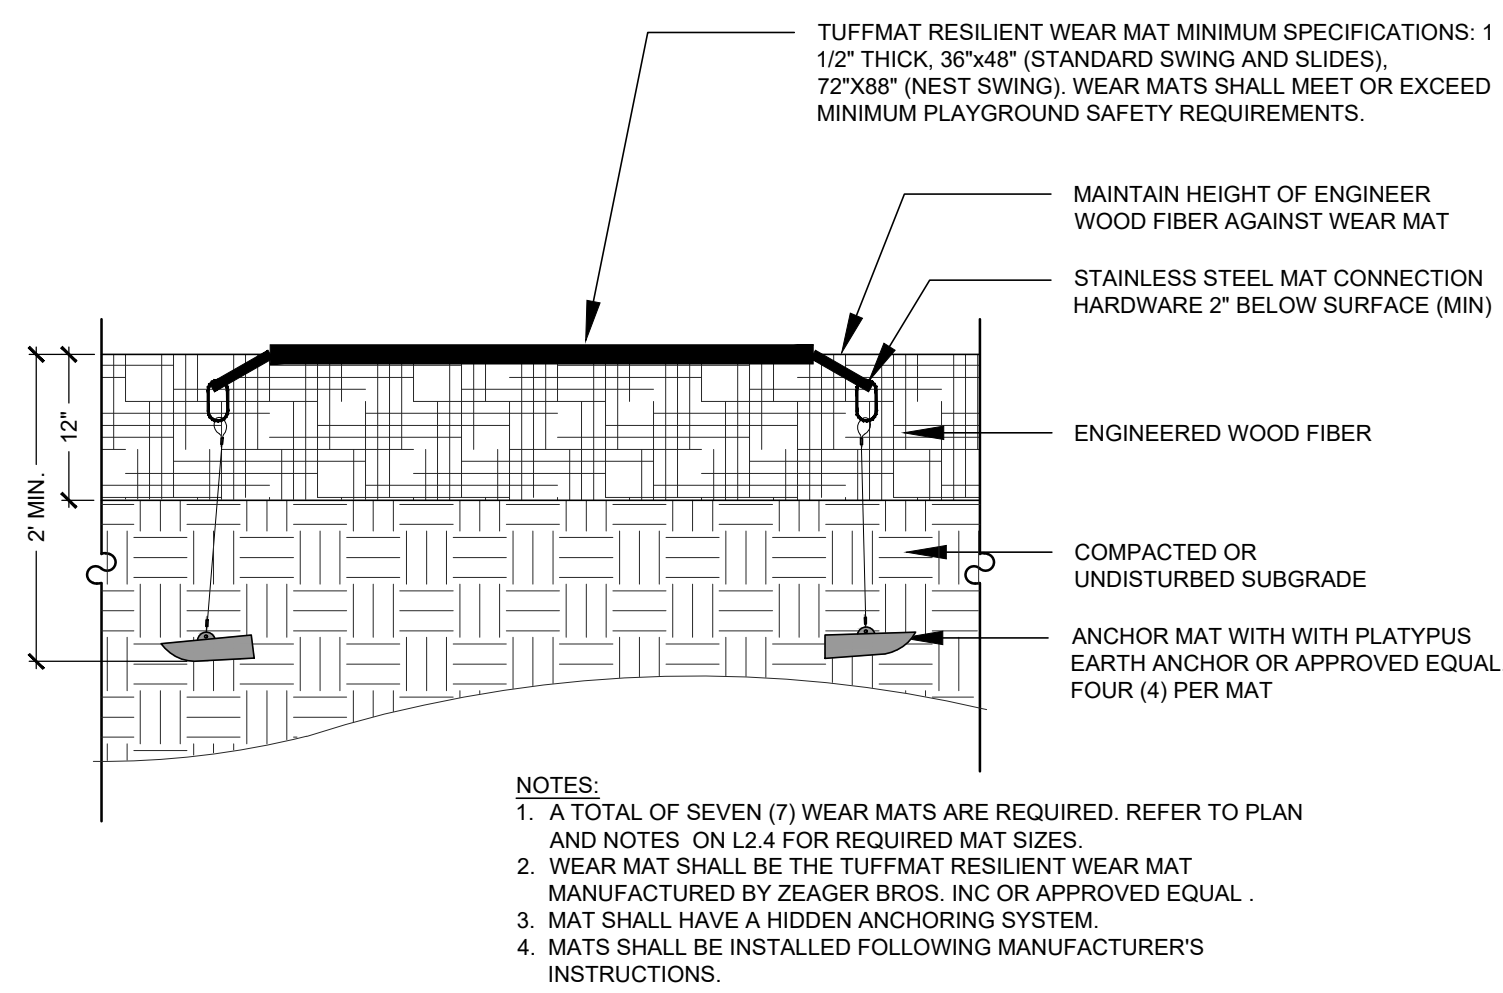



L3.3

Loam and Hydro-Seeding

Not to Scale

©IRONWOOD 2024

L3.3

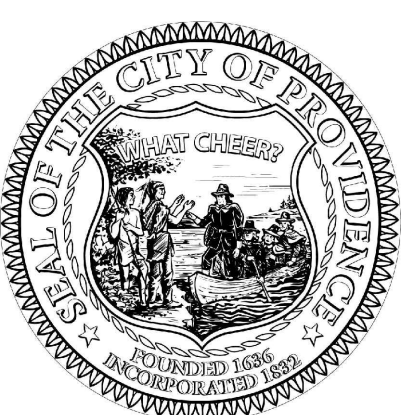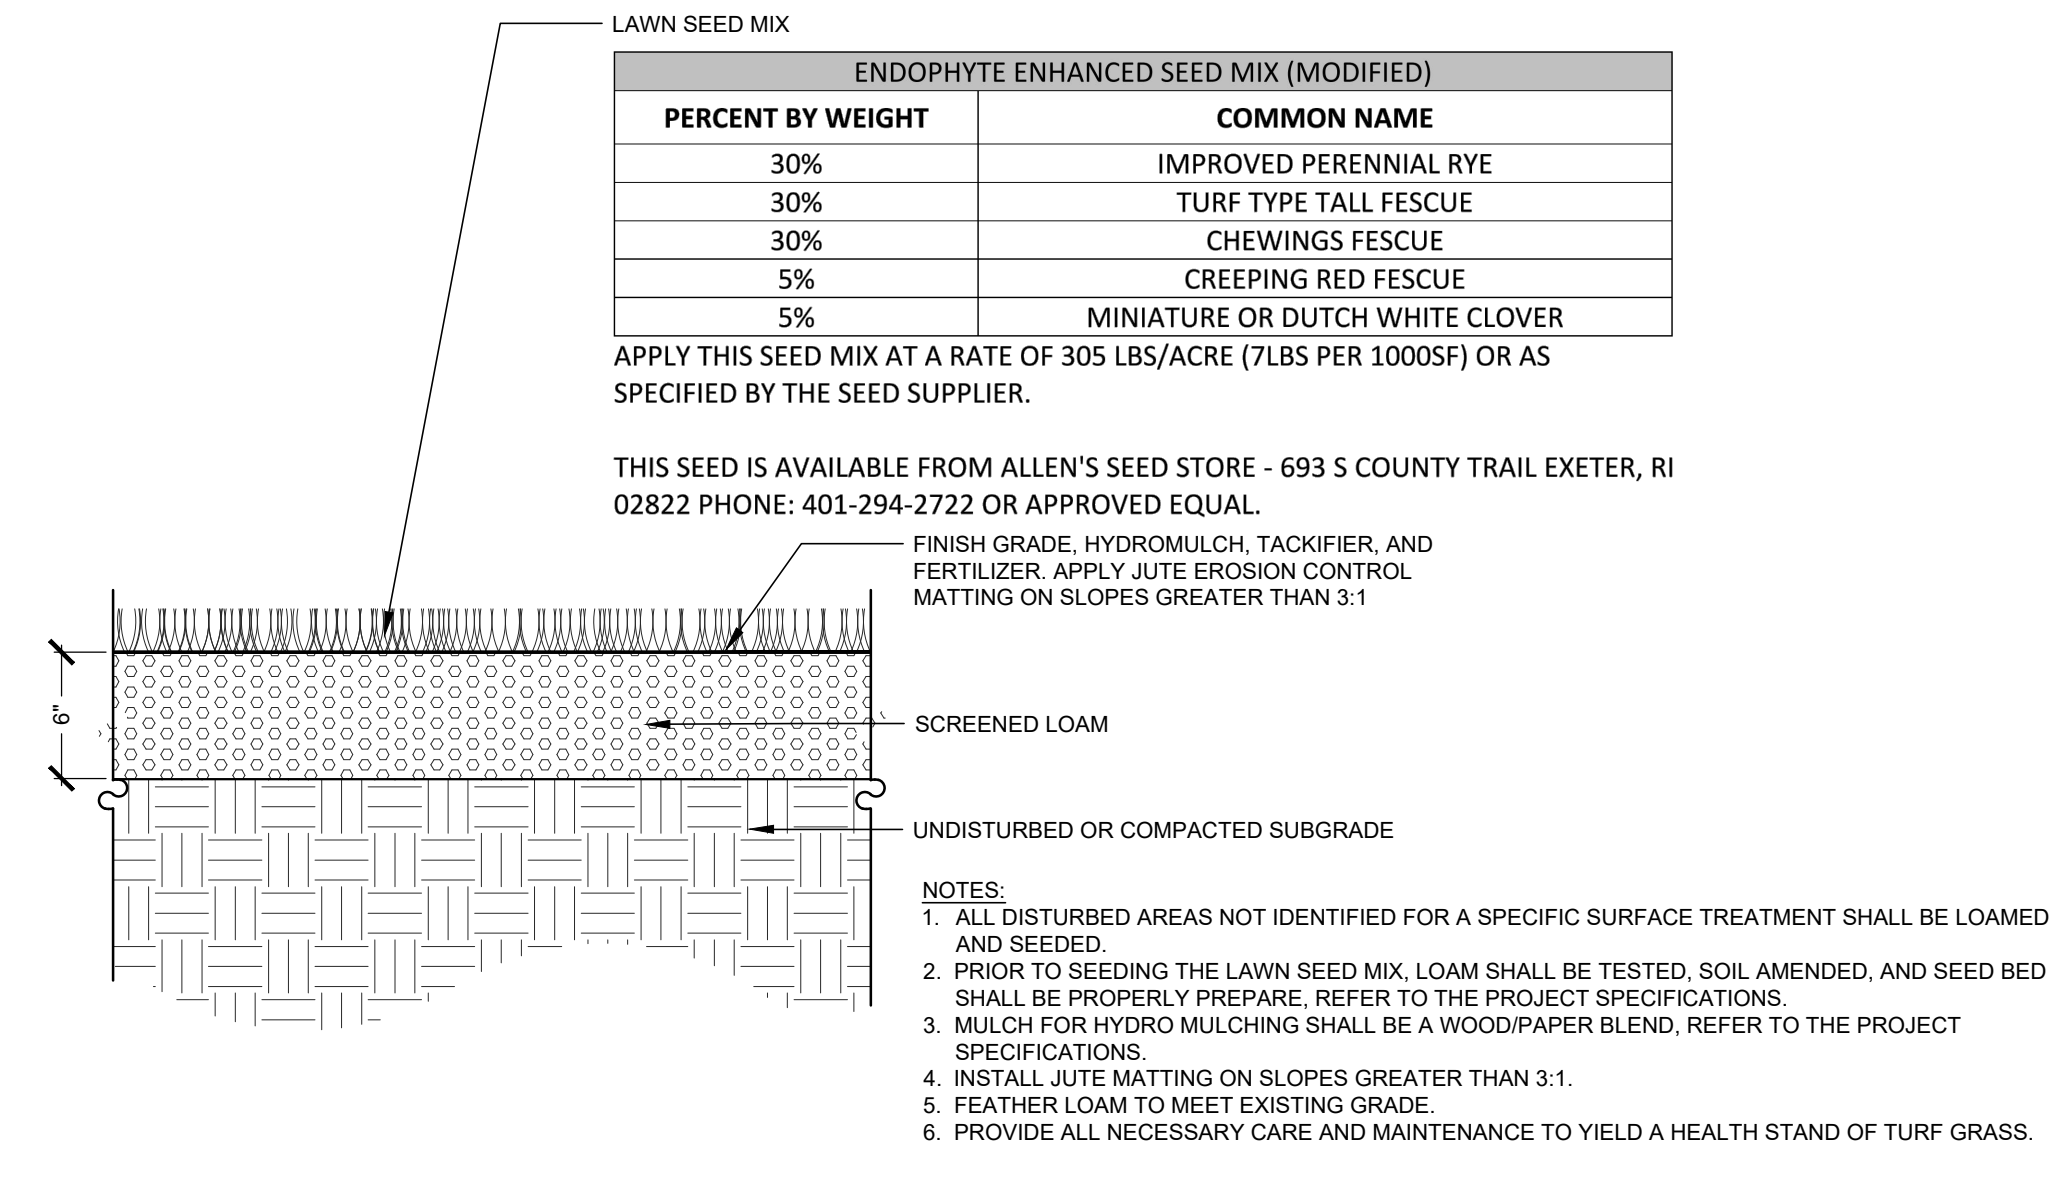

REV	DATE	DESCRIPTION

CLIENT:
PROVIDENCE PARKS DEPARTMENT
DALRYMPLE BOATHOUSE, MAPLE AVE,
PROVIDENCE, RI 02905

PROJECT:
SITE IMPROVEMENTS AT INDIA POINT PARK
103 INDIA STREET
PROVIDENCE, RI 02905

TITLE:
LANDSCAPE DETAILS

ISSUED FOR: BID
DATE: MARCH 25, 2024
SCALE: AS NOTED
DRAWN BY: S.WRIGHT, J.HYLAND
CHECKED BY: J.HYLAND, D.JENSEN
WSP PROJECT NO: 3652210316

L3.3

