SHEET INDEX:

CIVIL	
<u>C-0</u>	COVER
C-1	PHASE I EXISTING CONDITIONS PLAN
C-2.1	NOTES
C-2.2	PHASE II EXISTING CONDITIONS PLAN
C-3.1	200-FOOT ABUTTERS MAP
C-4.1	SITE LAYOUT PLAN
C-5.1	GRADING & DRAINAGE PLAN

ARCHITECTURAL

C-6.1 - C-6.6

A-04

A-01 LOWER AND MAIN LEVEL PLANS
A-02 UPPER LEVEL PLAN
A-03 EXTERIOR ELEVATIONS

EXTERIOR MASSING

DETAILS

A-05 RENDERINGS

LIGHTING


SL-1 LIGHTING DETAILS & NOTES

SL-2 OVERALL LAYOUT SL-3 LAYOUT EAST

LAYOUT WEST

LANDSCAPE

L-1.0 PLANTING PLAN

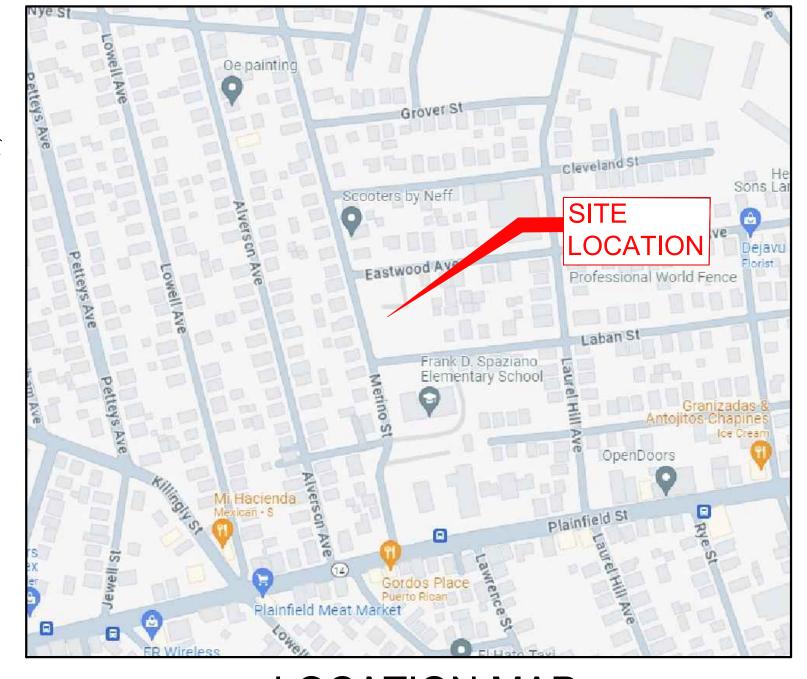

LOCATION MAP

NOT TO SCALE

SPAZIANO MIDDLE SCHOOL

254 EASTWOOD AVENUE PLAT 107 PARCEL111 PROVIDENCE, RHODE ISLAND

APRIL 2024

PREPARED FOR


CITY OF PROVIDENCE

25 DORRANCE STREET PROVIDENCE, RI 02903 401.680.5000



ENGINEER:

BRETT NEILAN, PE GM2 ASSOCIATES, INC. 200 MAIN STREET, SUITE 300 PAWTUCKET, RI 02860 401-726-4084 CITY OF PROVIDENCE
DEPARTMENT OF PLANNING AND
DEVELOPMENT
FINAL PLAN SUBMISSION
APRIL 2, 2024

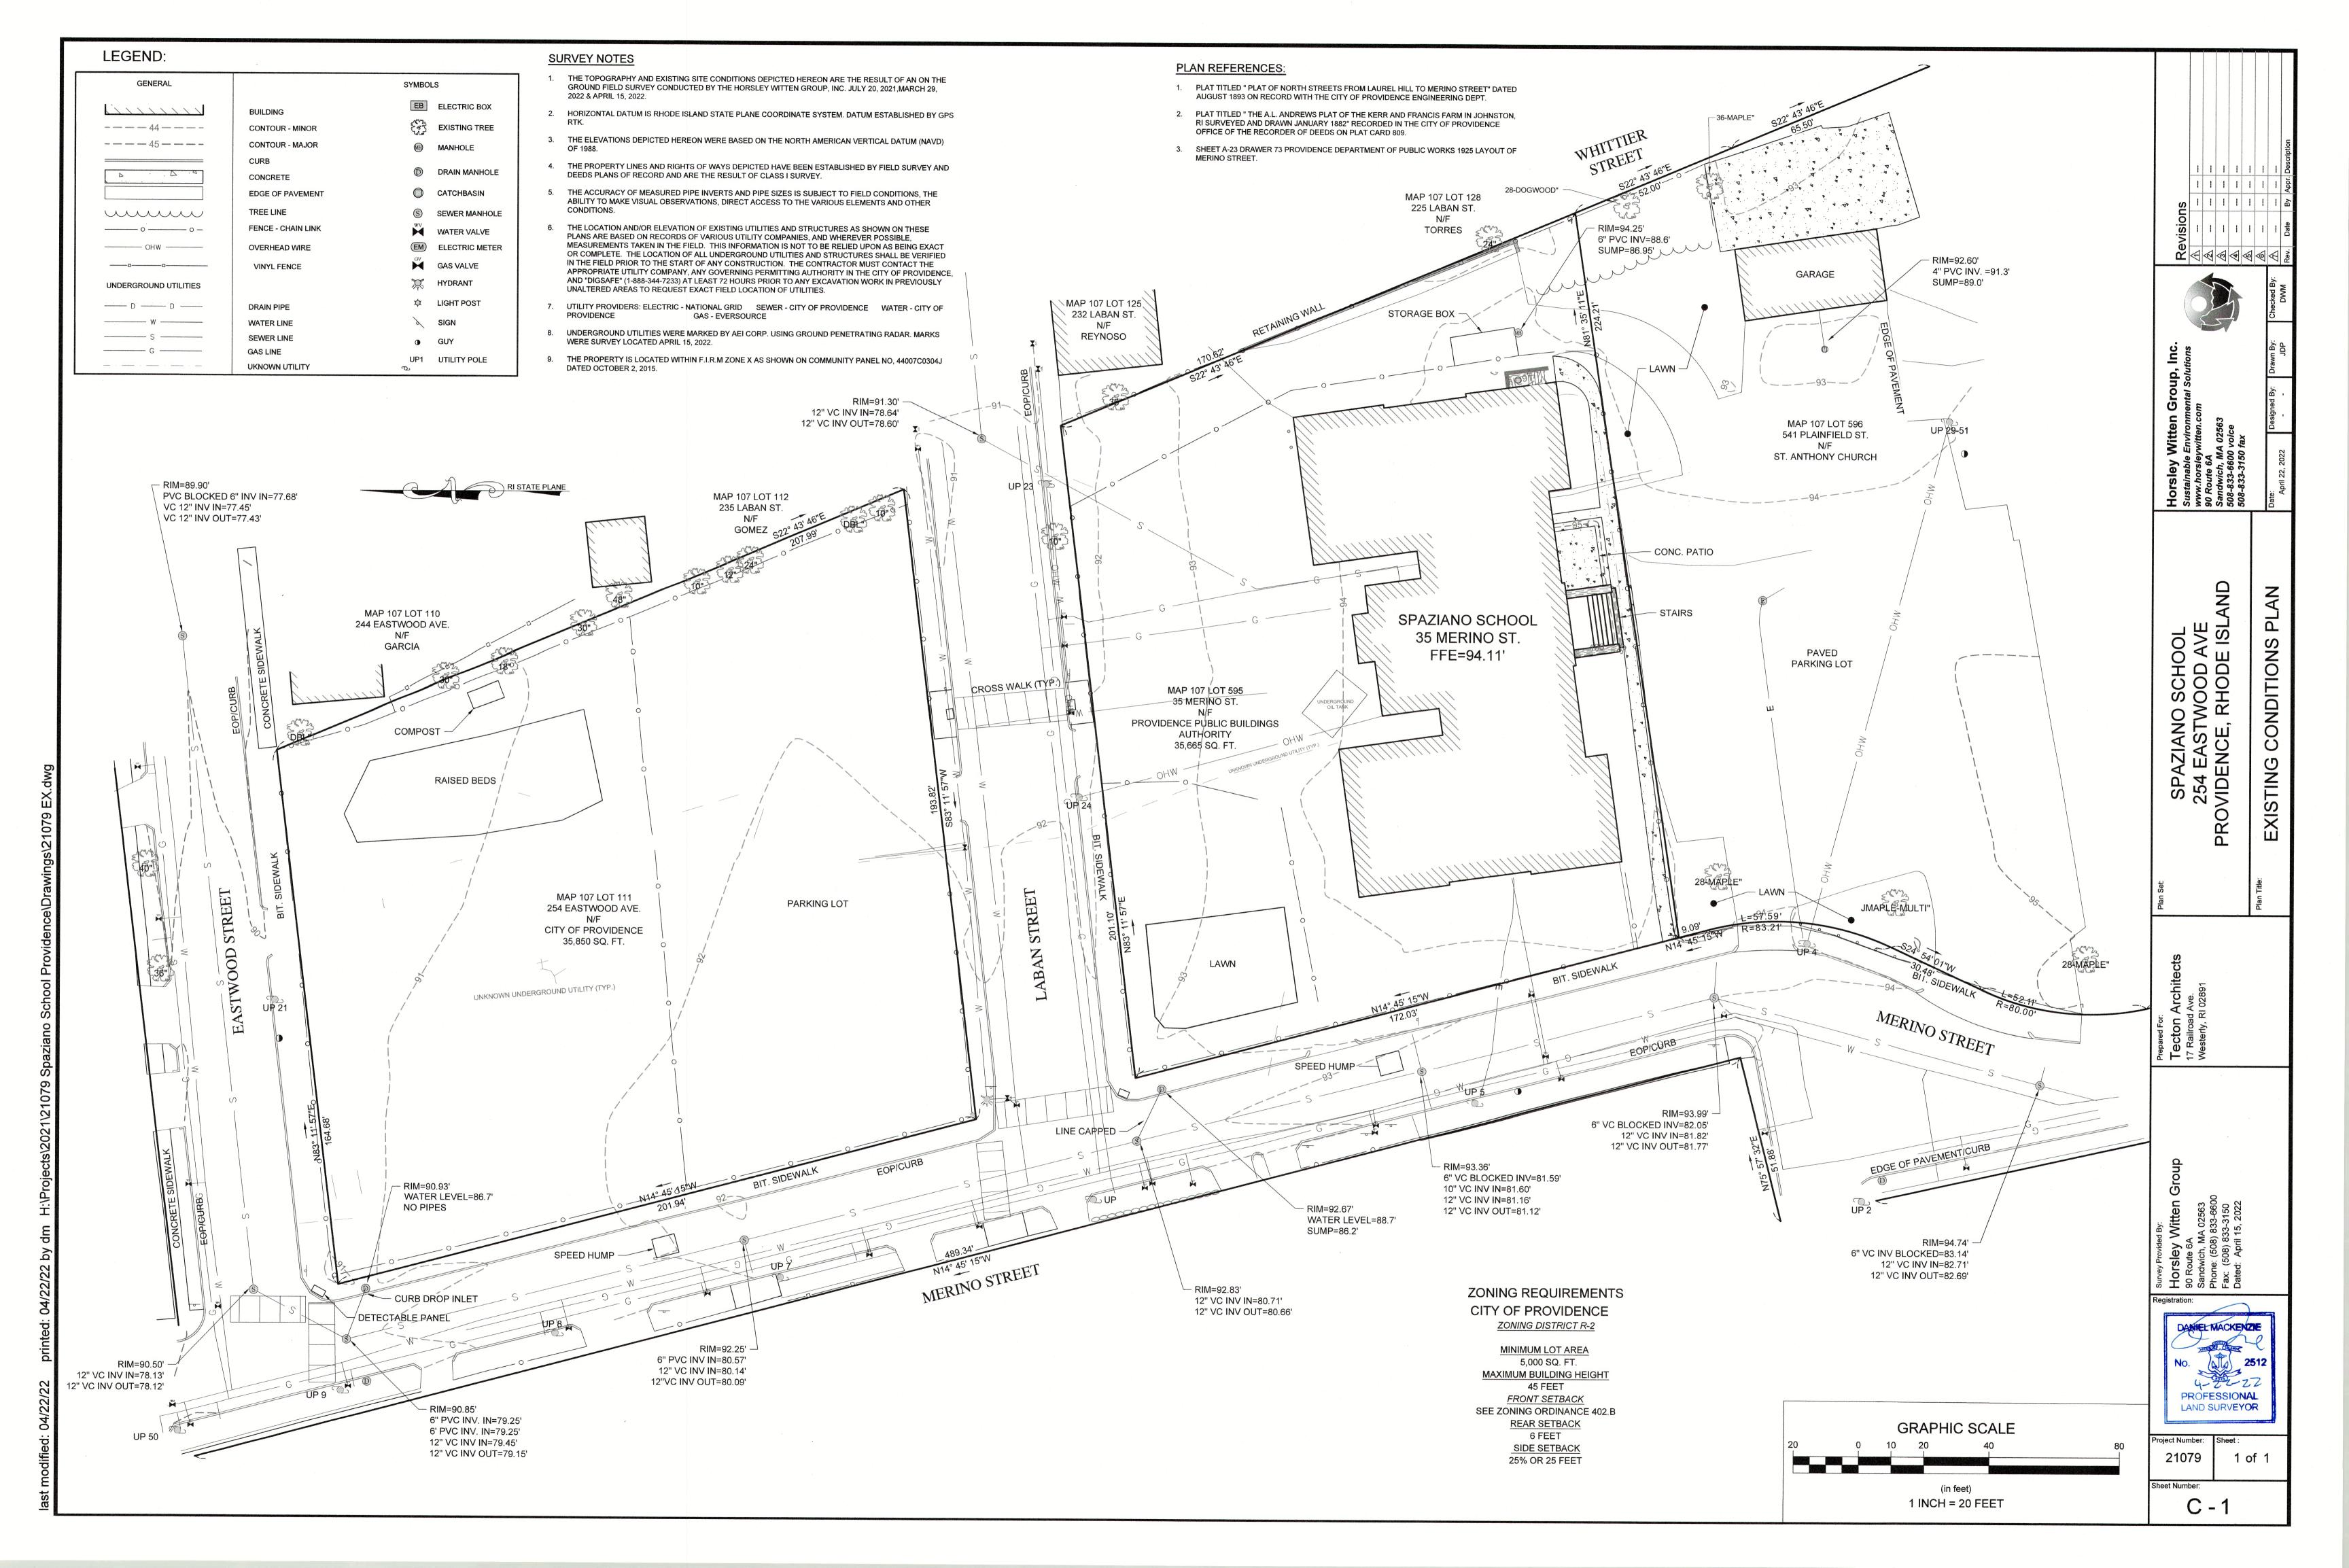

GENERAL NOTES:

- REFERENCE IS MADE TO THE LATEST EDITIONS OF THE RHODE ISLAND DEPARTMENT OF TRANSPORTATION (RIDOT) "STANDARD SPECIFICATIONS FOR ROAD AND BRIDGE CONSTRUCTION, 2022 EDITION" (INCLUDING ALL SUBEQUENTLY ISSUED SUPPLEMENTS, REVISIONS AND ADDENDA) AND THE "RHODE ISLAND STANDARD DETAILS, 1998 EDITION" (AMENDED JUNE 2019, INCLUDING ALL SUBEQUENTLY ISSUED SUPPLEMENTS, REVISIONS, AND ADDENDA). ALL PROJECT SITE IMPROVEMENTS SHALL CONFORM TO THE APPLICABLE STANDARDS SET FORTH IN THESE DOCUMENTS (INCLUDING ALL SUB-REFERENCES INCORPORATED THEREIN) UNLESS OTHERWISE
- 1.1. THE RIDOT "STANDARD SPECIFICATIONS FOR ROAD AND BRIDGE CONSTRUCTION" IS VIEWABLE VIA THE FOLLOWING WEBSITE ADDRESS: http://www.dot.ri.gov/business/bluebook.php
- 1.2. THE RIDOT "STANDARD DETAILS" IS VIEWABLE VIA THE FOLLOWING WEBSITE ADDRESS: https://www.dot.ri.gov/documents/doingbusiness/RIDOT Std Details.pdf
- ANY DAMAGE TO EXISTING PAVEMENT, CONDUIT, UTILITIES, SIDEWALK, FENCES, ETC., CAUSED BY THE CONTRACTOR SHALL BE REPAIRED AND RESTORED BY THE CONTRACTOR AT NO ADDITIONAL COST TO THE CITY OF PROVIDENCE.
- 3. THE CONTRACTOR SHALL PLACE ALL EQUIPMENT AND MATERIAL AS FAR AWAY AS POSSIBLE FROM THE EDGE OF THE TRAVEL LANE SO AS NOT TO CAUSE A SAFETY HAZARD, IN ACCORDANCE WITH SECTION 106.06 OF THE R.I.D.O.T. STANDARD SPECIFICATION, LATEST EDITION. EQUIPMENT STORAGE SHALL BE COORDINATED WITH THE RIPTA PRIOR TO CONSTRUCTION.
- IT IS THE CONTRACTOR'S RESPONSIBILITY TO ENSURE THAT THE EXISTING CONDITIONS ARE NOT OBLITERATED BEFORE CONTROL POINTS ARE LOCATED AND CONSTRUCTION LAYOUT IS ESTABLISHED.
- 5. THE FREQUENCY AND APPLICATION RATES FOR THE DUST CONTROL ITEMS SHALL BE COMPLETED IN ACCORDANCE WITH THE PROJECTS SOIL EROSION AND SEDIMENT CONTROL (SESC) PLAN, OR AS DIRECTED BY THE OWNER AND/OR ENGINEER.
- ASPHALT EMULSION TACK COAT SHALL BE PLACED PRIOR TO PAVEMENT PLACEMENT ON THE CONCRETE BASE OR COLD PLANED PAVEMENT, AND ON ANY NEW COURSE WHICH HAS BEEN OPEN TO TRAFFIC, OR ANY NEW COURSE WHICH HAS BEEN EXPOSED FOR MORE THAN 3 DAYS. AND/OR AS DIRECTED BY THE ENGINEER. IT SHALL ALSO BE APPLIED TO VERTICAL PAVEMENT FACES BETWEEN ADJOINING PAVEMENT SECTIONS. ALL APPLICATIONS ON BOTH HORIZONTAL AND VERTICAL SURFACES SHALL BE PAID FOR UNDER THE CONTRACT UNIT LUMP SUM PRICE FOR SITE WORK.
- THE LIMITS OF CLEARING AND SURFACE DISTURBANCE MUST BE STRICTLY ADHERED TO IN ALL AREAS.
- CLEANING AND SWEEPING SHALL BE DONE AT THE CONCLUSION OF EACH WORK DAY WITHIN THE CITY OF PROVIDENCE'S RIGHT-OF-WAY AS NEEDED.
- CLEANING AND SWEEPING OF PAVEMENT WILL INCLUDE REMOVAL OF ALL PAVEMENT DEBRIS PRIOR TO THE PLACEMENT OF EACH BITUMINOUS LIFT. ALL CLEANING AND SWEEPING SHALL BE DONE TO THE SATISFACTION OF THE
- 10. PRIOR TO INSTALLATION, ALL SIGNS, MOUNTINGS AND LOCATIONS SHALL BE APPROVED OR MODIFIED BY THE CITY OF PROVIDENCE AND/OR ENGINEER.
- 11. PAVEMENT OPERATIONS FOR CURBED SECTIONS: IN AREAS WHERE CURBING IS SET TO FINISH LINE AND GRADE, THE CONTRACTOR WILL NOT BE REQUIRED TO UTILIZE THE SENSOR AND SKY-TYPE DEVICE FOR AUTOMATIC GRADE CONTROL, BUT WILL BE ALLOWED TO MANUALLY ADJUST THE BITUMINOUS PAVER FOR CONTROLLING GRADE.
- 12. THE CONTRACTOR SHALL BE RESPONSIBLE FOR MAINTAINING ALL ROADWAYS FREE OF DEBRIS RESULTING FROM THEIR CONSTRUCTION OPERATIONS. ALL DEBRIS SHALL BE REMOVED TO THE SATISFACTION OF THE ENGINEER AT NO ADDITIONAL COST TO THE CITY OF PROVIDENCE.
- 13. NO FUEL STORAGE, VEHICLE REFUELING, OR EQUIPMENT STORAGE SHALL TAKE PLACE IN DESIGNATED WETLANDS, NOR WITHIN 100' OF ANY WATER BODY. THIS REQUIREMENT SHALL NOT SUPERSEDE ANY FEDERAL, STATE OR LOCAL LAW, ORDINANCE, RULE OR REGULATION THAT APPLIES TO THE SAME, UNLESS THIS REQUIREMENT IS MORE STRINGENT THAN SAID LAW. ORDINANCE, RULE OR REGULATION.
- 14. THE CONTRACTOR SHALL BE RESPONSIBLE TO ENSURE THAT AT THE END OF FINAL PAVING OPERATIONS, FLOW TO EXISTING DRAINAGE STRUCTURES HAS BEEN REESTABLISHED AND THAT NO ISOLATED DEPRESSIONS REMAIN. THERE SHALL BE NO SEPARATE PAYMENT FOR THIS PROVISION; IT SHALL BE CONSIDERED INCIDENTAL TO PAVING AND INCLUDED IN THE BID FOR SITE WORK.
- 15. ALL EMBANKMENTS SHALL BE PLACED IN HORIZONTAL LAYERS NOT EXCEEDING 12" (AFTER COMPACTION) AND SHALL BE COMPACTED AS SPECIFIED BEFORE THE NEXT LAYER IS PLACED. ALSO, EMBANKMENT CONSTRUCTION SHALL CONFORM TO SECTION 202.03.2 OF THE R.I.D.O.T. STANDARD SPECIFICATIONS, LATEST EDITION.
- 16. THE CONTRACTOR SHALL READ, BECOME FAMILIAR WITH, AND ADHERE TO ALL OF THE PROVISIONS, CONDITIONS, AND STIPULATIONS STATED IN THE ENVIRONMENTAL APPROVALS ISSUED FOR THE PROJECT FROM THE DEPARTMENT OF ENVIRONMENTAL MANAGEMENT (RIDEM). COPIES OF APPLICABLE PERMITS ARE INCLUDED IN THE CONTRACT DOCUMENTS. ALL COSTS ASSOCIATED WITH THESE CONDITIONS SHALL BE CONSIDERED INCIDENTAL TO THE CONSTRUCTION AND INCLUDED WITH THE BID FOR SITE WORK.

DRAINAGE AND EROSION CONTROL NOTES:

- 1. FOR ALL PROJECTS WITH AT LEAST ONE(1) ACRE OF SOIL DISTURBANCE. RIPTA IS REQUIRED TO DEVELOP AND ENFORCE A SITE SPECIFIC SOIL EROSION AND SEDIMENT CONTROL PLAN IN ORDER TO REMAIN IN COMPLIANCE WITH THE RIPDES GENERAL PERMIT FOR STORMWATER DISCHARGES ASSOCIATED WITH CONSTRUCTION ACTIVITIES. CONTRACTOR SHALL READ, BECOME FAMILIAR WITH, AND ADHERE TO ALL OF THE PROVISIONS, CONDITIONS, AND STIPULATIONS OF THE GENERAL PERMIT AND THE SITE SPECIFIC SESC FOR THIS PROJECT. COPIES OF THESE DOCUMENTS ARE INCLUDED IN THE CONTRACT DOCUMENTS. ALL COSTS ASSOCIATED WITH ADHERENCE TO THE SESC SHALL BE CONSIDERED INCIDENTAL TO THE CONSTRUCTION AND IS INCLUDED IN THE LUMP SUM PRICE FOR SITE WORK.
- 2. NO UNDISTURBED AREAS SHALL BE CLEARED OF EXISTING VEGETATION AFTER OCTOBER 15 OF ANY CALENDAR YEAR OR DURING ANY PERIOD OF FULL OR LIMITED WINTER SHUTDOWN. ALL DISTURBED SOILS EXPOSED PRIOR TO OCTOBER 15 OF ANY CALENDAR YEAR SHALL BE SEEDED OR PROTECTED BY THAT DATE. ANY SUCH AREAS THAT DO NOT HAVE ADEQUATE VEGETATIVE STABILIZATION, AS DETERMINED BY THE RESIDENT ENGINEER OR ENVIRONMENTAL INSPECTOR, BY NOVEMBER 15 OF ANY CALENDAR YEAR, MUST BE STABILIZED THROUGH THE USE OF EROSION CONTROL MATTING OR HAY MULCH. IN ACCORDANCE WITH SPECIFICATIONS CONTAINED WITHIN THE R.I. SOIL EROSION AND SEDIMENT CONTROL HANDBOOK. IF WORK CONTINUES WITHIN ANY OF THESE AREAS DURING THE PERIOD FROM OCTOBER 15 THROUGH APRIL 15, CARE MUST BE TAKEN TO ENSURE THAT ONLY THE AREA REQUIRED FOR THAT DAY'S WORK IS EXPOSED, AND ALL ERODABLE SOIL MUST BE RESTABILIZED WITHIN 5 WORKING DAYS. ANY WORK TO CORRECT PROBLEMS RESULTING FROM FAILURE TO COMPLY WITH THIS PROVISION SHALL BE THE RESPONSIBILITY OF THE CONTRACTOR. THERE WILL BE NO SEPARATE PAYMENT FOR THIS PROVISION. IT SHALL BE CONSIDERED INCIDENTAL TO CONSTRUCTION OPERATIONS. STABILIZATION OF ONE FORM OR ANOTHER AS DESCRIBED ABOVE SHALL BE ACHIEVED WITHIN 2 WEEKS OF FINAL GRADING.
- STOCKPILES SHALL HAVE SIDE SLOPES NO GREATER THAN 30% AND STOCKPILES OF ERODABLE MATERIAL SHALL ALSO BE SEEDED AND RINGED WITH R.I. STD. 9.1.0 TO STABILIZE. STOCKPILES SHALL BE USED IN ACCORDANCE WITH THE PROJECT SPECIFICATIONS.
- 4. IF THE PLANS INCLUDE SPECIFIC AREAS FOR PLACEMENT OF CONSTRUCTION DEWATERING BASINS AND/OR EQUIPMENT AND MATERIALS STORAGE AND STOCKPILING, AND IF THE CONTRACTOR ELECTS TO UTILIZE ANY OTHER AREAS FOR THESE PURPOSES. THIS SHALL BE APPROVED BY THE ENGINEER ONLY AFTER OBTAINING ANY NECESSARY PERMITS AND/OR PERMIT MODIFICATIONS FROM THE APPROPRIATE REGULATORY AUTHORITY(IES). ANY PERMITTING REQUIREMENTS SHALL BE THE RESPONSIBILITY OF THE CONTRACTOR AND SHALL BE ACCOMPLISHED AT NO COST TO THE STATE. THE ENGINEER WILL COORDINATE SUBMISSION OF ANY REQUIRED PERMIT APPLICATION MATERIALS WITH THE CITY OF PROVIDENCE.
- 5. SEEDING ON ALL SLOPES 3 TO 1 OR STEEPER SHALL CONSIST OF THE FOLLOWING APPLICATIONS UNLESS CHANGED IN THE CONTRACT

SEEDING TYPE I

ADHESIVE MULCH STABILIZER

- 6. UNVEGETATED SLOPES SHALL NOT BE UNATTENDED OR EXPOSED FOR PERIODS IN EXCESS OF 2 WEEKS OR THROUGH THE INACTIVE WINTER
- 7. PRIOR TO DRAINAGE AND UTILITY CONSTRUCTION, THE CONTRACTOR IS RESPONSIBLE FOR VERIFYING THE LOCATION (HORIZONTAL AND VERTICAL) OF ALL EXISTING PIPES AND/OR STRUCTURES WHICH ARE TO BE CONNECTED. ANY VARIATION FOUND FROM THE PLANS MUST BE BROUGHT TO THE ENGINEER'S ATTENTION PRIOR TO DRAINAGE AND UTILITY CONSTRUCTION. WORK CAN COMMENCE ONLY UPON THE ENGINEER'S AUTHORIZATION.
- 8. ALL DRAINAGE AND UTILITY STRUCTURES WITHIN THE PAVED ROADWAY SHALL BE ADJUSTED TO GRADE WITH THE SURROUNDING PAVEMENT PRIOR TO THE WINTER SHUTDOWN.
- 9. DURING CONSTRUCTION, THE CONTRACTOR SHALL BE RESPONSIBLE FOR MAINTAINING DRAINAGE AND RUNOFF FLOW DURING STORMS AND PERIODS OF RAINFALL THROUGHOUT THE WORK AREA. DURING CONSTRUCTION,
- 10. APPROVED EROSION CONTROLS SHALL BE INSTALLED IN ACCORDANCE WITH THE PROJECT SOIL EROSION AND SEDIMENT CONTROL (SESC) PLAN WHENEVER SUBBASE IS EXPOSED. AND CONTROLS SHALL REMAIN IN PLACE UNTIL THE ABUTTING GROUND SURFACES ARE STABILIZED.
- 11. THE TOE OF ANY FILL SLOPE IS TO REMAIN AT LEAST 1' INSIDE OF ALL EROSION CONTROLS. UNDER NO CIRCUMSTANCES SHALL THE CONTRACTOR COVER ANY PORTION OF THE EROSION CONTROL MEASURES WITH MATERIAL. ANY MATERIAL THAT IS PLACED ON ANY EROSION CONTROLS BY THE CONTRACTOR, OR ANY AGENT OF THE CONTRACTOR, SHALL BE IMMEDIATELY REMOVED BY THE CONTRACTOR, AND ANY NECESSARY REPAIRS TO THE EROSION CONTROLS ACCOMPLISHED.
- 12. PRIOR TO COMMENCING CONSTRUCTION ACTIVITIES, EROSION AND SEDIMENTATION CONTROLS SHALL BE INSTALLED AT THOSE AREAS INDICATED ON THE PLANS. CLEARING MAY OCCUR PRIOR TO INSTALLATION OF SUCH CONTROLS, HOWEVER NO GRUBBING, GRADING, FILLING, OR OTHER SOIL DISTURBANCE SHALL OCCUR PRIOR TO INSTALLATION. THE LIMITS OF CLEARING AND SURFACE DISTURBANCE MUST BE STRICTLY ADHERED TO IN ALL AREAS.
- ALL APPROVED EROSION CONTROLS OR TEMPORARY PROTECTION SHALL REMAIN IN PLACE UNTIL AN ACCEPTABLE STAND OF GRASS IS ESTABLISHED. IF NEEDED, TEMPORARY SEEDING CAN HELP TO MINIMIZE EROSION. TEMPORARY SEED WILL CONFORM TO R.I.D.O.T. STANDARD TEMPORARY SEED MIX.
- 14. THE NORMAL ACCEPTABLE SEASONAL SEEDING DATES ARE SPECIFIED IN SUBSECTION L.02.03 OF THE R.I.D.O.T. STANDARD SPECIFICATIONS. LATEST EDITION.

UTILITY NOTES:

- 1. EXISTING UTILITIES HAVE BEEN SHOWN ON THE PLANS USING THE BEST AVAILABLE INFORMATION AND ARE APPROXIMATE.
- 2. THE CONTRACTOR SHALL VERIFY THE LOCATIONS OF ALL EXISTING DRAINAGE AND UTILITIES BOTH UNDERGROUND AND OVERHEAD BEFORE EXCAVATION BEGINS IN ACCORDANCE WITH CHAPTER 39-1.2 OF THE R.I. GENERAL LAWS ENTITLED "EXCAVATION NEAR UNDERGROUND UTILITY FACILITIES", WITH AMENDMENTS EFFECTIVE AS OF NOVEMBER 1, 2009 AND, WHEN NECESSARY, BY CONTACTING THE INDIVIDUAL UTILITY COMPANIES. EXCAVATION SHALL BE IN ACCORDANCE WITH ALL STATUTES, ORDINANCES, RULES AND REGULATIONS OF ANY APPLICABLE CITY, TOWN, STATE OR FEDERAL AGENCY. THE CONTRACTOR SHOULD UNDERSTAND THAT NOT ALL UTILITIES SUBSCRIBE TO THE DIG SAFE PROGRAM. IT IS THE CONTRACTOR'S RESPONSIBILITY TO NOTIFY ALL UTILITY COMPANIES AND ENSURE THAT ALL UTILITIES HAVE BEEN MARKED PRIOR TO COMMENCING THEIR WORK. ANY DAMAGE TO EXISTING UTILITIES MARKED IN THE FIELD, OR AS A RESULT OF FAILING TO CONTACT THE APPROPRIATE UTILITY COMPANY, SHALL BE REPAIRED OR REPLACED AT NO ADDITIONAL COST TO THE CITY OF PROVIDENCE.
- ANY/ALL PROPOSED VARIANCE TO THE DRAINAGE AND UTILITY PLAN. OR UTILITY DETAILS PROVIDED HEREIN SHALL BE BROUGHT TO THE ATTENTION OF THE ENGINEER FOR REVIEW AND APPROVAL PRIOR TO CONSTRUCTION.

MAINTENANCE AND PROTECTION **OF TRAFFIC NOTES:**

- 1. ALL MAINTENANCE AND PROTECTION OF TRAFFIC CONTROL SETUPS, SIGNS, CHANNELIZING DEVICES, ETC., SHALL BE IN ACCORDANCE WITH THE MANUAL ON UNIFORM TRAFFIC CONTROL DEVICES, LATEST EDITION.
- 2. ALL SIGN MOUNTINGS FOR TEMPORARY AND CONSTRUCTION SIGNS SHALL BE IN ACCORDANCE WITH THE R.I.D.O.T. STANDARD SPECIFICATIONS, LATEST EDITION.
- 3. THE CONTRACTOR SHALL COVER ALL EXISTING AND/OR TEMPORARY SIGNS THAT ARE NOT RELEVANT TO THE TRAFFIC CONTROL REQUIRED DURING ANY PARTICULAR STAGE OF THE CONTRACT.
- TEMPORARY CONSTRUCTION SIGNS AND OTHER WORKZONE TRAFFIC CONTROL DEVICES THAT ARE DAMAGED OR REQUIRE RELOCATION SHALL BE REPLACED AND / OR RELOCATED AS REQUIRED. NO SEPARATE PAYMENT SHALL BE MADE FOR REPLACING OR RELOCATING SIGNS AS THIS WORK WILL BE CONSIDERED INCIDENTAL TO THE PROJECT AND INCLUDED IN THE LUMP SUM PRICE FOR SITE WORK.
- 5. THE PRIVATE VEHICLES OF CONSTRUCTION WORKERS SHALL NOT BE PARKED ON THE TRAVEL LANES OR SHOULDERS. PARKING SHALL BE COORDINATED WITH THE CITY OF PROVIDENCE AT ALL
- TEMPORARY CONSTRUCTION SIGNS AND OTHER TEMPORARY TRAFFIC CONTROL DEVICES SHALL BE INSTALLED PRIOR TO THE START OF WORK IN ANY AREA OPEN TO TRAFFIC. AND SHALL BE REMOVED AS SOON AS PRACTICAL WHEN THEY ARE NO LONGER APPROPRIATE.

SURVEY NOTES:

- 1. SURVEY HAS BEEN COMPLETED BY HORSLEY WITTEN GROUP, INC. THE SURVEY WAS COMPLETED FOR THE CITY OF PROVIDENCE AND UTILIZED BY FUSS & O'NEILL, INC. AS PART OF THE PHASE 1 DEVELOPMENT STAGE (SPAZIANO ELEMENTARY SCHOOL PROJECT).
- 2. HORSLEY WITTEN GROUP, INC'S JULY 20, 2021 AND MARCH 29, 2022 FIELD SURVEY UTILIZED:
 - a. HORIZONTAL DATUM IS RHODE ISLAND STATE PLANE COORDINATE SYSTEM. DATUM ESTABLISHED BY GPS RTK.
 - b. THE ELEVATIONS DEPICTED BASED ON NORTH AMERICAN VERTICAL DATUM (NAVD) OF 1988.
- 3. INFORMATION ILLUSTRATED ON THE PHASE II EXISTING CONDITIONS PLANS ARE APPROXIMATE ONLY AND DRAWN BASED ON DOCUMENTS RECEIVED BY GM2, INCLUDING THE ELEMENTARY SCHOOL PLAN SETS AND AS-BUILT DOCUMENTS
- SITE INFORMATION, INCLUDING BUT NOT LIMITED TO INVERTS, LOCATIONS, AND DIMENSIONS SHOWN AS PART OF THE SPAZIANO MIDDLE SCHOOL PROJECT (PHASE II DEVELOPMENT) ARE APPROXIMATE ONLY AND REPRESENT THE TEMPORARY CONDITIONS FOLLOWING THE PHASE 1 DEVELOPMENT. THESE CONDITIONS HAVE NOT BEEN SURVEYED BY GM2 OR ANY SUBCONSULTANT AS PART OF THE PHASE II DEVELOPMENT STAGE.
- 5. GM2 HAS COMPELTED A VISUAL INSPECTION OF THE SITE CONDITIONS ON FEBRUARY 19, 2024. OBSERVED SITE CONDITIONS ARE REPRESENTED ON THE PHASE II EXISTING CONDITIONS PLANS. GM2 DID NOT COMPLETE SURVEY MEASUREMENTS OR TOPOGRAPHIC INFORMATION AS PART OF THIS SITE RECONNAISSANCE.
- 6. IT IS THE RESPONSIBILITY OF THE CONTRACTOR TO REVIEW SITE CONDITIONS PRIOR TO INITIATING CONSTRUCITON ACTIVITIES. ALL DISCREPENCIES OBSERVED SHALL BE BROUGHT TO THE ATTENTION OF THE ENGINEER IMMEDIATELY.



This drawing is the property of Tecton Architects | pc. The use, re-use or reproduction of this drawing for any purpose whatsoever without an expressed written agreement petween Tecton Architects | pc and the user is prohibited. Rights to use the information on this sheet are not ransferred until payment has been received for services rendered. Any rights so granted are non-transferable to other parties without the prior expressed written consent

© 2024 Tecton Architects | pc



PROVIDENCE PUBLIC **SCHOOLS**

797 WESTMINSTER STREET PROVIDENCE, RI 02903

SPAZIANO MIDDLE

254 EASTWOOD AVENUE PROVIDENCE, RI 02909

PROGRESS SET

No.	s / Revisions Date	Description
	7/28/2023	SCHEMATIC DESIGN
	2/20/2024	CITY OF PROV MASTER PL
	2/29/2024	DESIGN DEVELOPMENT

NOTES

Project Manager: BDN Project No: 41037

Drawing Number

6

4

2


Client/ Contractor

SCHOOL

NOT FOR CONSTRUCTION

Issues	s / Revisions Date	Description
	7/28/2023	SCHEMATIC DESIGN
	2/20/2024	CITY OF PROV MASTER PL
	2/29/2024	DESIGN DEVELOPMENT

LBD Scale: AS NOTED

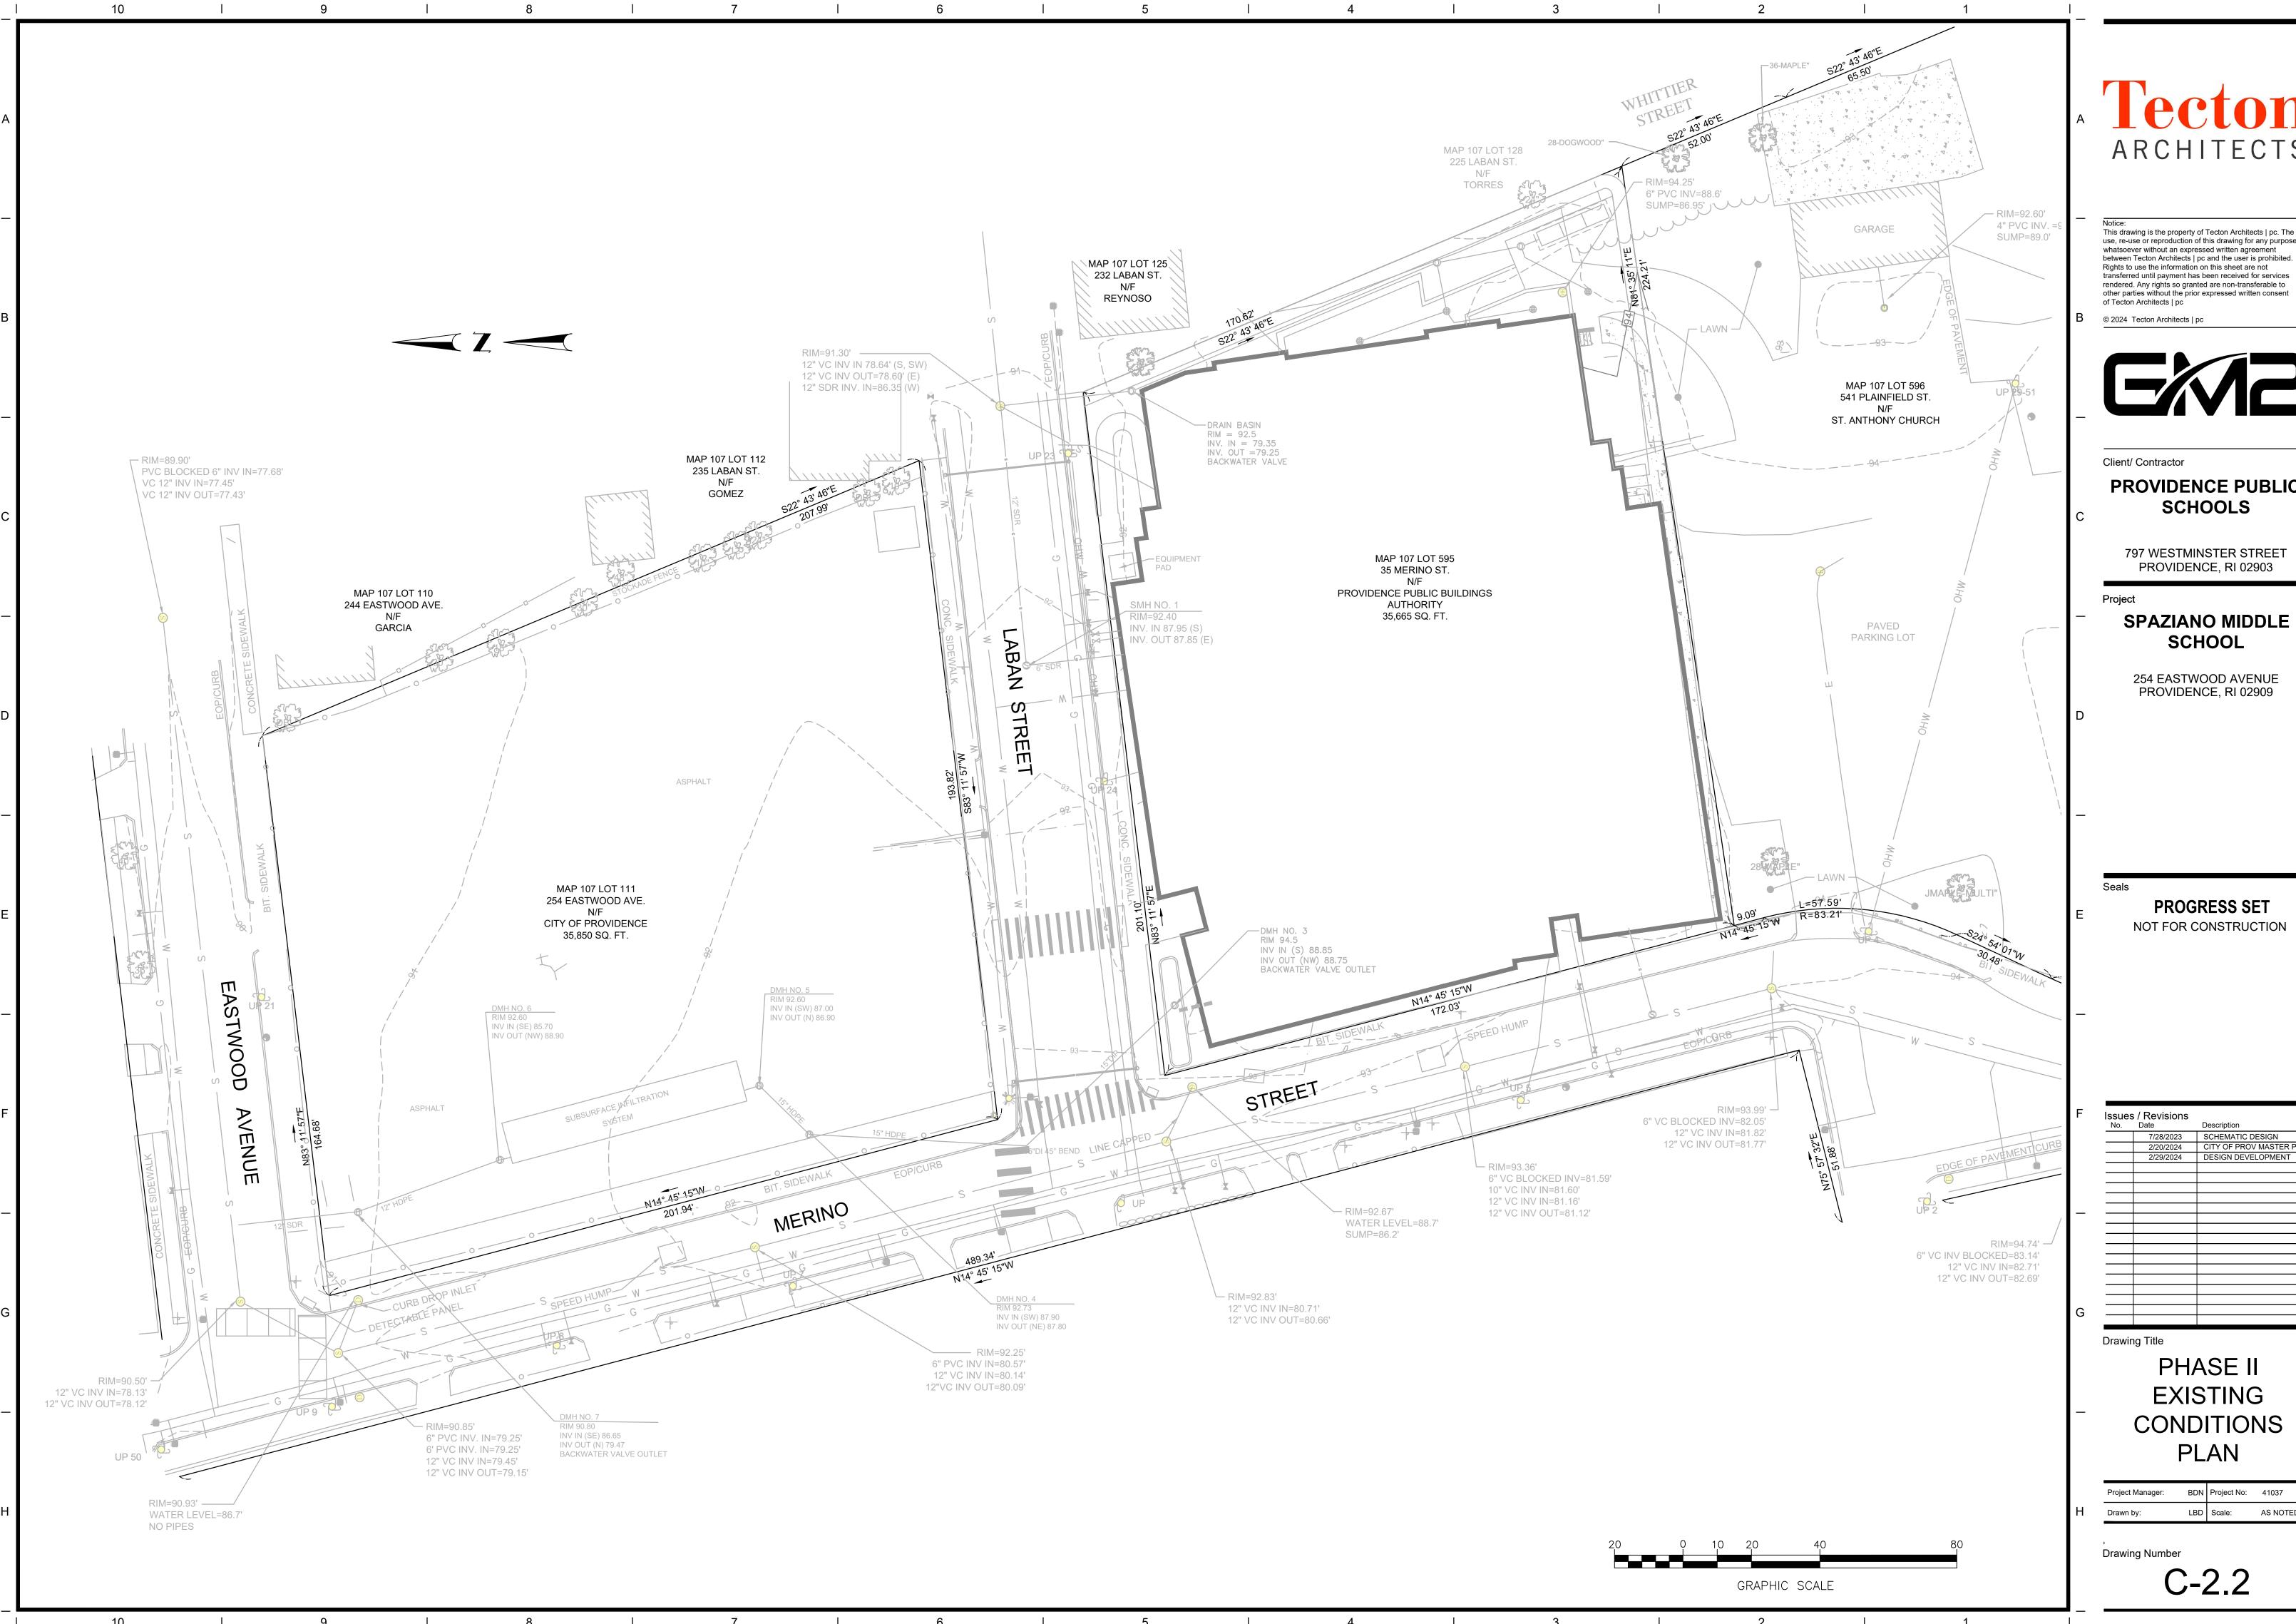

Tecton

This drawing is the property of Tecton Architects | pc. The use, re-use or reproduction of this drawing for any purpose whatsoever without an expressed written agreement between Tecton Architects | pc and the user is prohibited. Rights to use the information on this sheet are not transferred until payment has been received for services



PROVIDENCE PUBLIC **SCHOOLS**

797 WESTMINSTER STREET PROVIDENCE, RI 02903

SPAZIANO MIDDLE SCHOOL

254 EASTWOOD AVENUE PROVIDENCE, RI 02909

PROGRESS SET NOT FOR CONSTRUCTION

sues	/ Revisions	
Vo.	Date	Description
	7/28/2023	SCHEMATIC DESIGN
	2/20/2024	CITY OF PROV MASTER PLAN
	2/29/2024	DESIGN DEVELOPMENT

PHASE II **EXISTING** CONDITIONS PLAN

Project Manager: BDN Project No: 41037 LBD Scale: AS NOTED

Tecton ARCHITECTS

This drawing is the property of Tecton Architects | pc. The use, re-use or reproduction of this drawing for any purpose whatsoever without an expressed written agreement between Tecton Architects | pc and the user is prohibited. Rights to use the information on this sheet are not transferred until payment has been received for services rendered. Any rights so granted are non-transferable to other parties without the prior expressed written consent of Tecton Architects | pc

© 2024 Tecton Architects | pc



Client/ Contractor

PROVIDENCE PUBLIC **SCHOOLS**

797 WESTMINSTER STREET PROVIDENCE, RI 02903

SPAZIANO MIDDLE SCHOOL

254 EASTWOOD AVENUE PROVIDENCE, RI 02909

PROGRESS SET NOT FOR CONSTRUCTION

Issues / Revisions No. Date 7/28/2023 SCHEMATIC DESIGN
2/20/2024 CITY OF PROV MASTER PLAN
2/29/2024 DESIGN DEVELOPMENT

200' RADIUS MAP

H Drawer have ACAIOTED		Project Manager:	BDN	Project No:	41037
TI Drawn by: LBD Scale: AS NOTED	Н	Drawn by:	LBD	Scale:	AS NOTED

Drawing Number

Drawing Title

NOTES:

1. MAP SOURCES: CITY OF PROVIDENCE GIS (PARCEL BOUNDARIES, BUILDING FOOTPRINTS, AND ZONING

DISTRICT LAYERS), RIGIS (SPRING 2023 AERIALS). 2. THIS 200-FOOT RADIUS MAP IS PROVIDED TO MEET THE CITY OF PROVIDENCE REQUIREMENTS FOR MASTER PLAN AND UNIFIED DEVELOPMENT REVIEW. THE PLAN DOES NOT INDICATE PROPOSED CONSTRUCTION


ACTIVITIES. 3. PROPERTY INFORMATION (INCLUDING PLAT/LOT NUMBERS, OWNERS NAMES, MAILING ADDRESSES, PRESENT USES, ETC.) FOR ABUTTERS WITHIN THE 200-FOOT RADIUS WAS OBTAINED FROM THE CITY OF PROVIDENCE GIS 'BETA RADIUS MAP AND ABUTTERS LIST APPLICATION' TOOL ON FEBRUARY 19, 2024.


ZONING DISTRICT LEGEND:

ZONE PS - CITY OF PROVIDENCE PUBLIC SPACE DISTRICT ZONE R1 - CITY OF PROVIDENCE RESIDENTIAL (R1) DISTRICT ZONE R2 - CITY OF PROVIDENCE RESIDENTIAL (R2) DISTRICT

ZONE R3 - CITY OF PROVIDENCE RESIDENTIAL (R3) DISTRICT


GRAPHIC SCALE

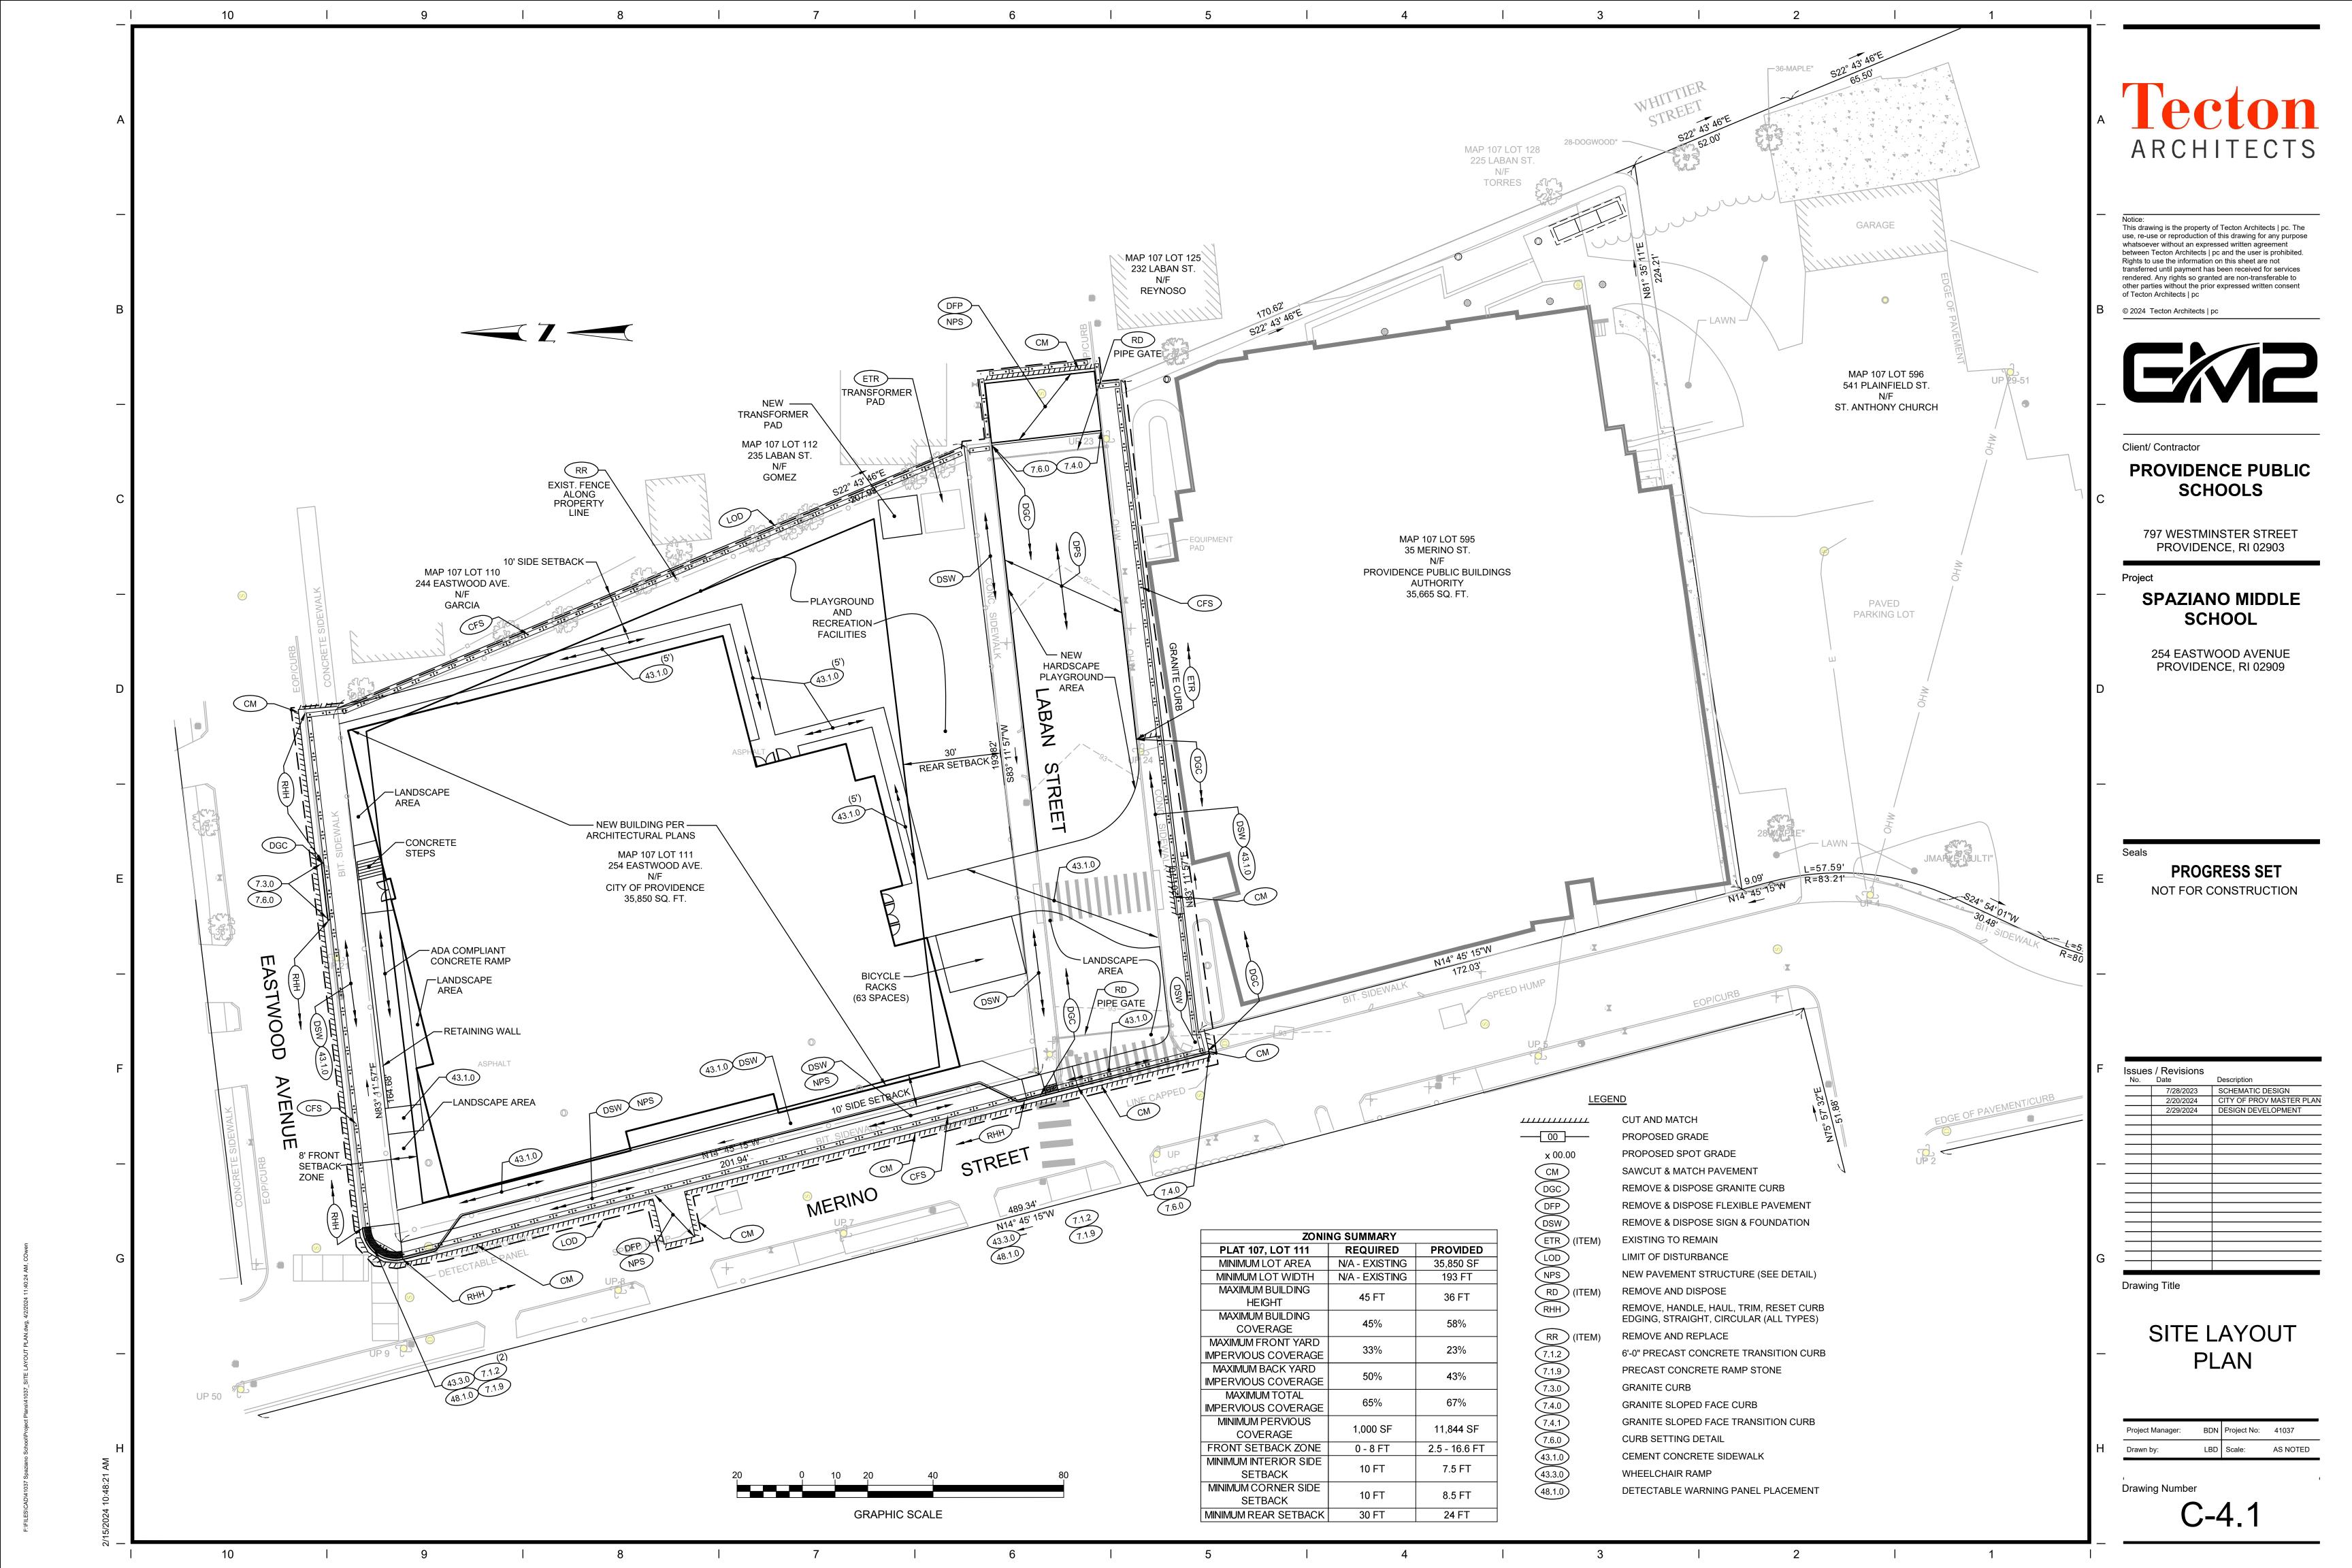

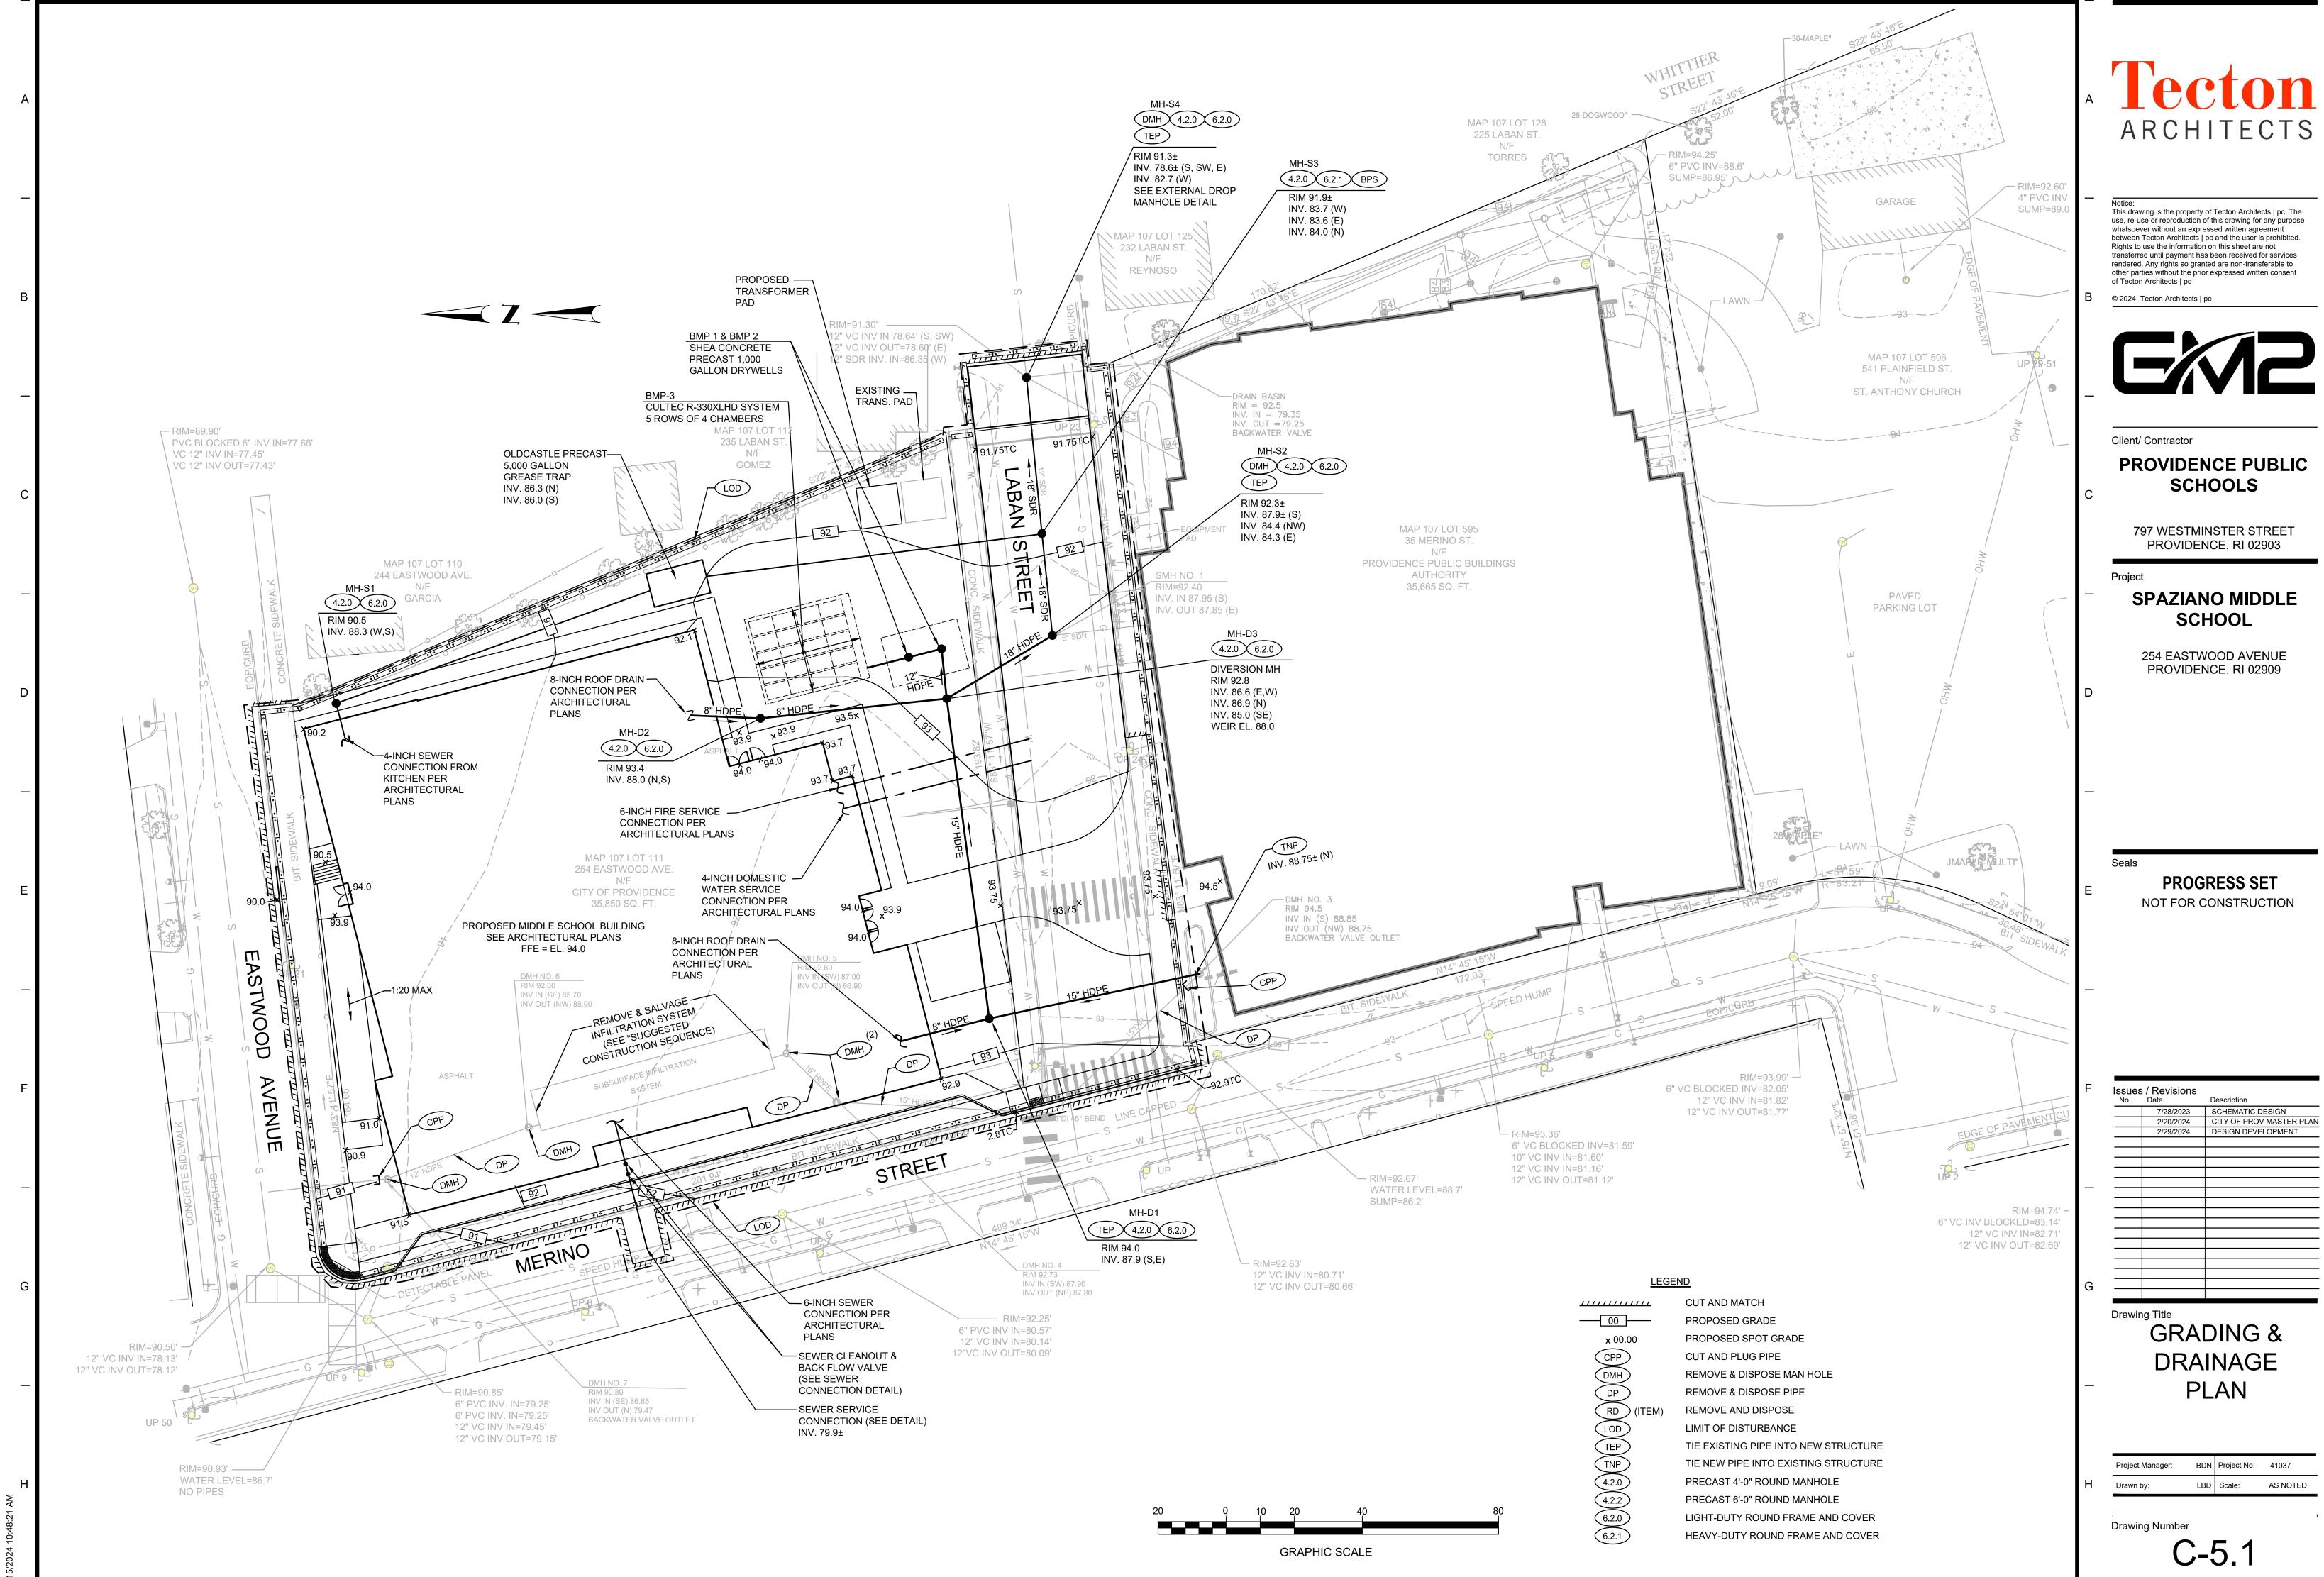



Issues	s / Revisions Date	Description
	7/28/2023	SCHEMATIC DESIGN
-	2/20/2024	CITY OF PROV MASTER PLAN
	2/29/2024	DESIGN DEVELOPMENT

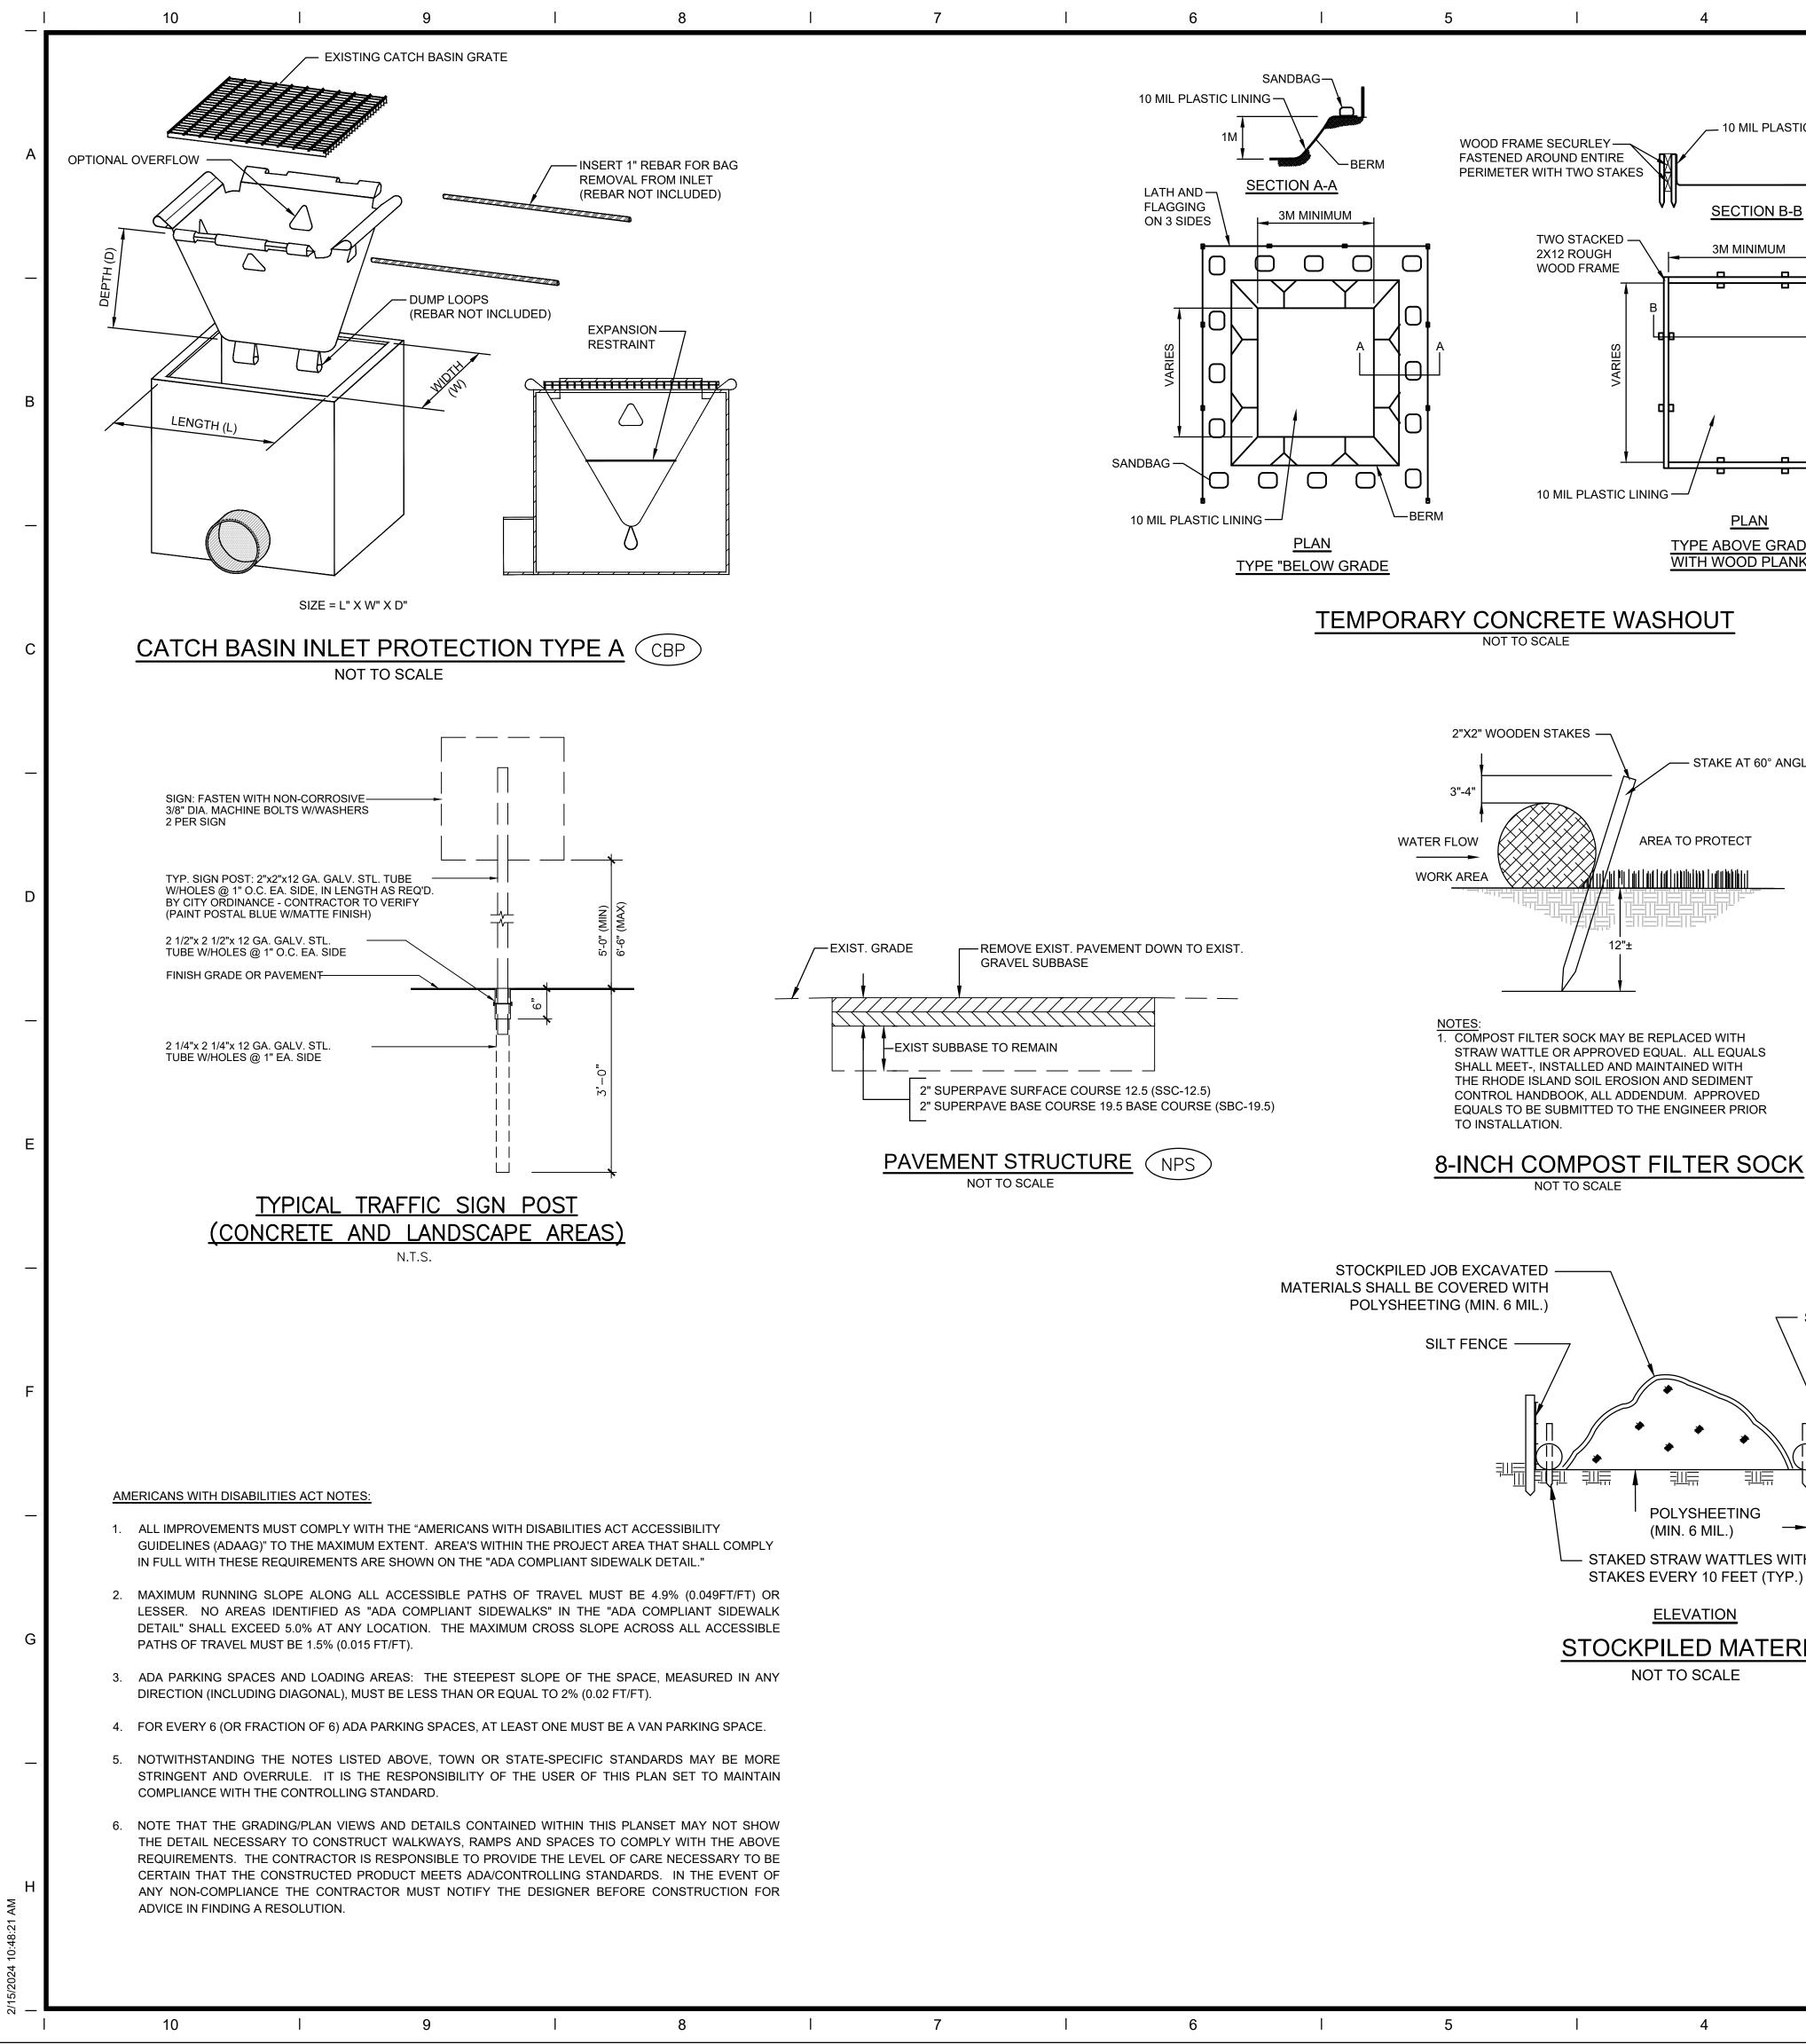

SELF-INSTALLED ABOVE GRADE WASHOUTS ON LARGER SITES MUST BE AT LEAST 10 FEET BY 10 FEE LONG AND SIZED TO CONTAIN ALL LIQUID AND SOLID WASTE EXPECTED TO BE GENERATED IN BETWEEN CLEANOUT PERIODS. WASHOUTS AT SMALLER SITES CAN BE SMALLER ACCORDING T THE EXPECTED CAPACITY NEEDED. INCLUDE A MINIMUM OF 12-INCH FREEBOARD IN THE SIZING CALCULATIONS. ONE CAN MAKE THE STRUCTURES FROM STAKED STRAW BALES OR SANDBAGS DOUBLE OR TRIPLE-LINED WITH PLASTIC SHEETING OF AT LEAST 10-MIL THICKNESS THAT HAS NO HOLES OR TEARS. SELF-INSTALLED BELOW-GRADE WASHOUTS SHOULD BE

- 10 MIL PLASTIC LINING

SECTION B-B

3M MINIMUM

<u>PLAN</u>

- STAKE AT 60° ANGLE

SILT FENCE

---| | 6" MIN.

3

AREA TO PROTECT

POLYSHEETING

(MIN. 6 MIL.)

— STAKED STRAW WATTLES WITH

STAKES EVERY 10 FEET (TYP.)

ELEVATION

STOCKPILED MATERIAL

NOT TO SCALE

TYPE ABOVE GRADE WITH WOOD PLANKS

TWO STACKED —

10 MIL PLASTIC LINING —


NOT TO SCALE

2X12 ROUGH


WOOD FRAME

CONSTRUCTED AS SHOWN ON THE DETAILS AT THE END OF THIS MEASURE, WITH A RECOMMENDED MINIMUM LENGTH AND MINIMUM WIDTH OF 10 FT. THEY MUST BE SIZED TO CONTAIN ALL LIQUID AND SOLID WASTE EXPECTED TO BE GENERATED IN BETWEEN CLEANOUT PERIODS.

O LATH AND FLAGGING SHOULD BE COMMERCIAL TYPE. O PLASTIC LINING MATERIAL SHALL BE A MINIMUM OF 10 MIL POLYETHYLENE SHEETING AND SHOULD BE FREE OF HOLES, TEARS OR OTHER DEFECTS THAT COMPROMISE THE IMPERMEABILITY OF THE MATERIAL

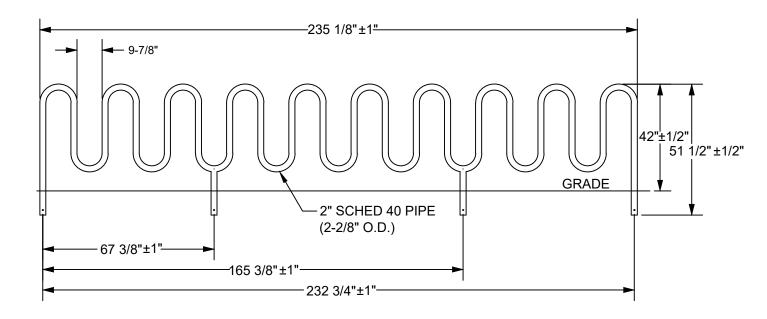

ELEVATION

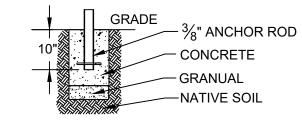


ANCHOR DETAIL

1. MODEL # HW238-21-IG-S MANUFACTURED BY MADRAX AND THOMAS

2. OWNER SHALL SELECT AND APPROVE FINAL COLOR FOR BICYCLE RACKS.

BIKE RACK DETAIL NOT TO SCALE

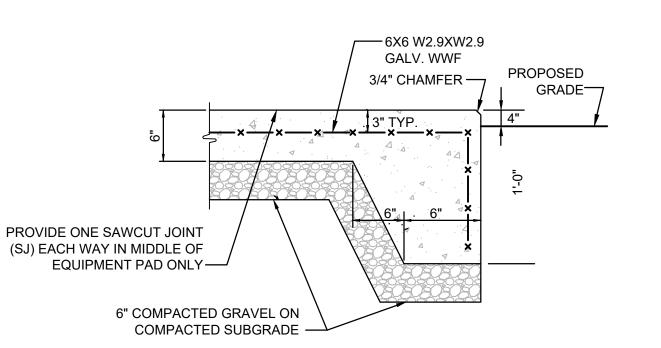

EQUIPMENT PAD DETAIL

NOT TO SCALE

ARCHITECTS

This drawing is the property of Tecton Architects | pc. The use, re-use or reproduction of this drawing for any purpose whatsoever without an expressed written agreement between Tecton Architects | pc and the user is prohibited. Rights to use the information on this sheet are not transferred until payment has been received for services rendered. Any rights so granted are non-transferable to other parties without the prior expressed written consent of Tecton Architects | pc

© 2024 Tecton Architects | pc



Client/ Contractor

PROVIDENCE PUBLIC SCHOOLS

797 WESTMINSTER STREET PROVIDENCE, RI 02903

SPAZIANO MIDDLE SCHOOL

254 EASTWOOD AVENUE PROVIDENCE, RI 02909

Seals

PROGRESS SET

NOT FOR CONSTRUCTION


Issues / Revisions
 V2
 7/28/2023
 SCHEMATIC DESIGN

 2/20/2024
 CITY OF PROV MASTER PLAN

 2/29/2024
 DESIGN DEVELOPMENT
 Drawing Title

CONSTRUCTION **DETAILS**

Project Manager: BDN Project No: 41037 LBD Scale: AS NOTED

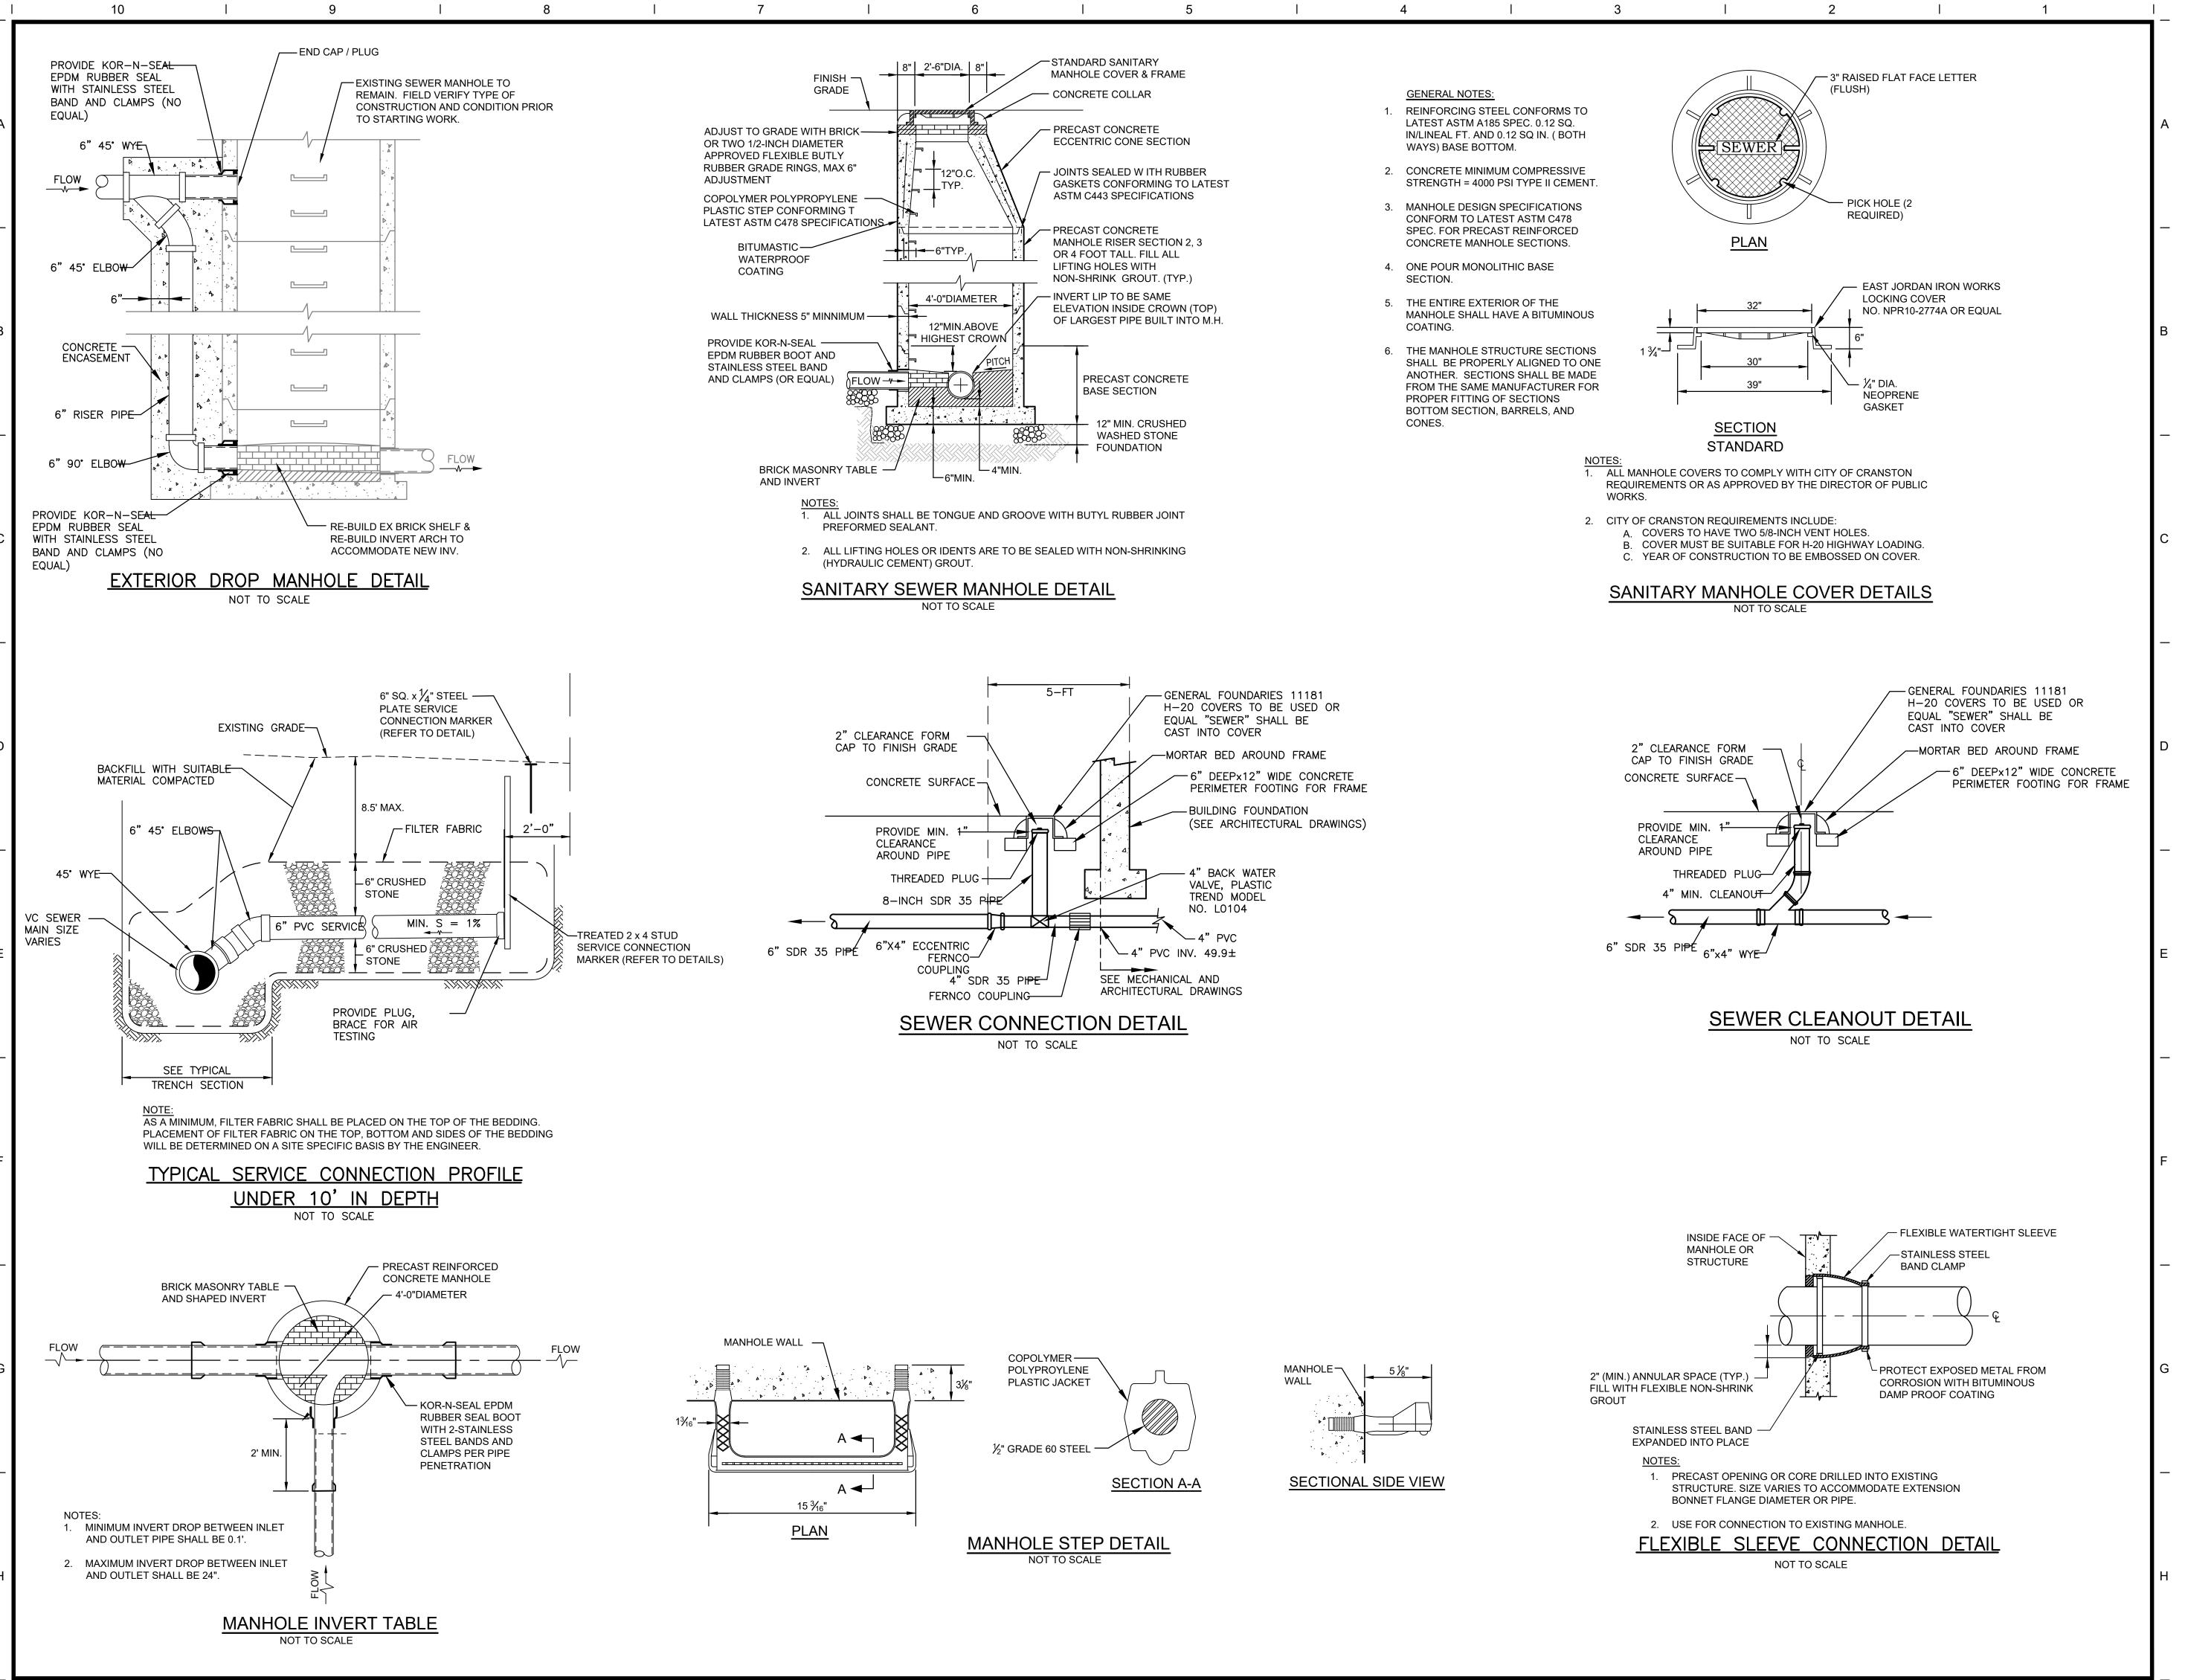

Tecton ARCHITECTS

Notice:
This drawing is the property of Tecton Architects | pc. The use, re-use or reproduction of this drawing for any purpose whatsoever without an expressed written agreement between Tecton Architects | pc and the user is prohibited. Rights to use the information on this sheet are not transferred until payment has been received for services rendered. Any rights so granted are non-transferable to other parties without the prior expressed written consent of Tecton Architects | pc

© 2024 Tecton Architects | pc



Client/ Contractor

PROVIDENCE PUBLIC SCHOOLS

797 WESTMINSTER STREET PROVIDENCE, RI 02903

Project

SPAZIANO MIDDLE SCHOOL

254 EASTWOOD AVENUE PROVIDENCE, RI 02909

Spale

PROGRESS SET

NOT FOR CONSTRUCTION

Issues / Revisions
No. Date Description

V2 7/28/2023 SCHEMATIC DESIGN

2/20/2024 CITY OF PROV MASTER PLAN

2/29/2024 DESIGN DEVELOPMENT

Drawing Title


CONSTRUCTION DETAILS

Project Manager: BDN Project No: 41037

Drawn by: LBD Scale: AS NOTED

Drawing Number

C-6.2

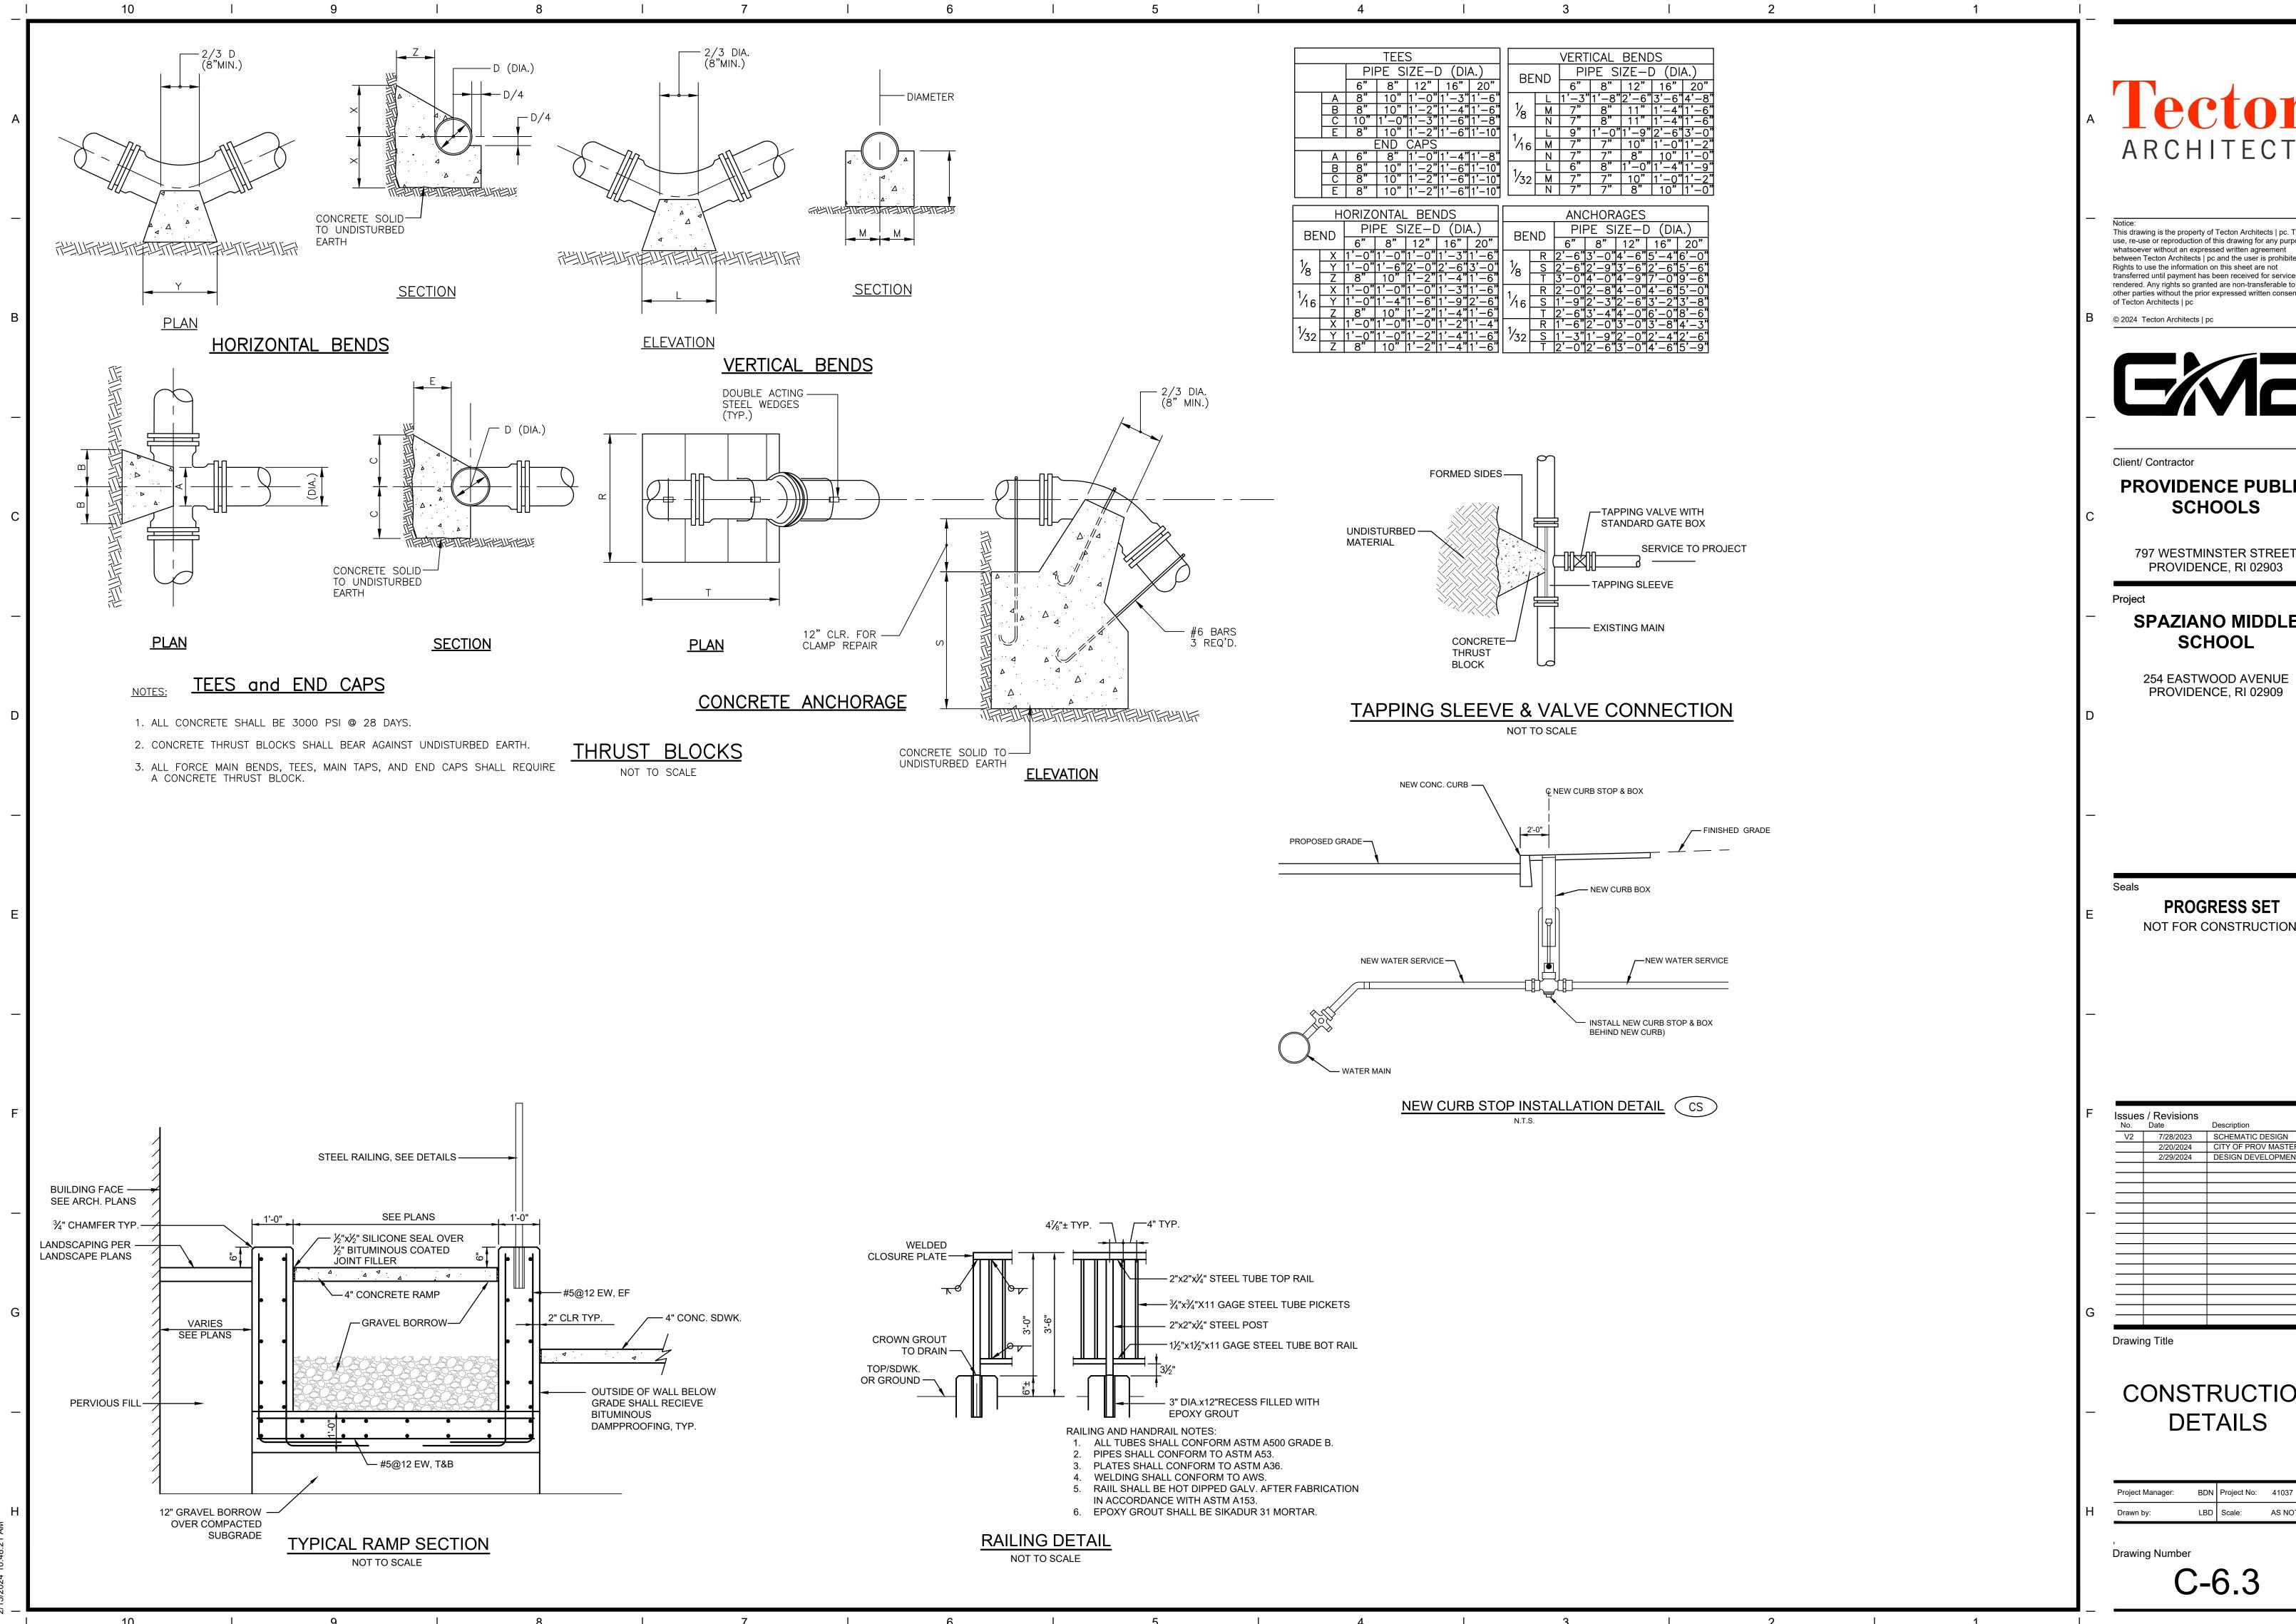

ARCHITECTS

This drawing is the property of Tecton Architects | pc. The use, re-use or reproduction of this drawing for any purpose whatsoever without an expressed written agreement between Tecton Architects | pc and the user is prohibited. Rights to use the information on this sheet are not transferred until payment has been received for services rendered. Any rights so granted are non-transferable to other parties without the prior expressed written consent

© 2024 Tecton Architects | pc



PROVIDENCE PUBLIC **SCHOOLS**

797 WESTMINSTER STREET PROVIDENCE, RI 02903

SPAZIANO MIDDLE SCHOOL


254 EASTWOOD AVENUE PROVIDENCE, RI 02909

PROGRESS SET

Issues	s / Revisions	
No.	Date	Description
V2	7/28/2023	SCHEMATIC DESIGN
	2/20/2024	CITY OF PROV MASTER PLAN
	2/29/2024	DESIGN DEVELOPMENT

CONSTRUCTION DETAILS

Project Manager:	BDN	Project No:	41037
Drawn by:	LBD	Scale:	AS NOTED

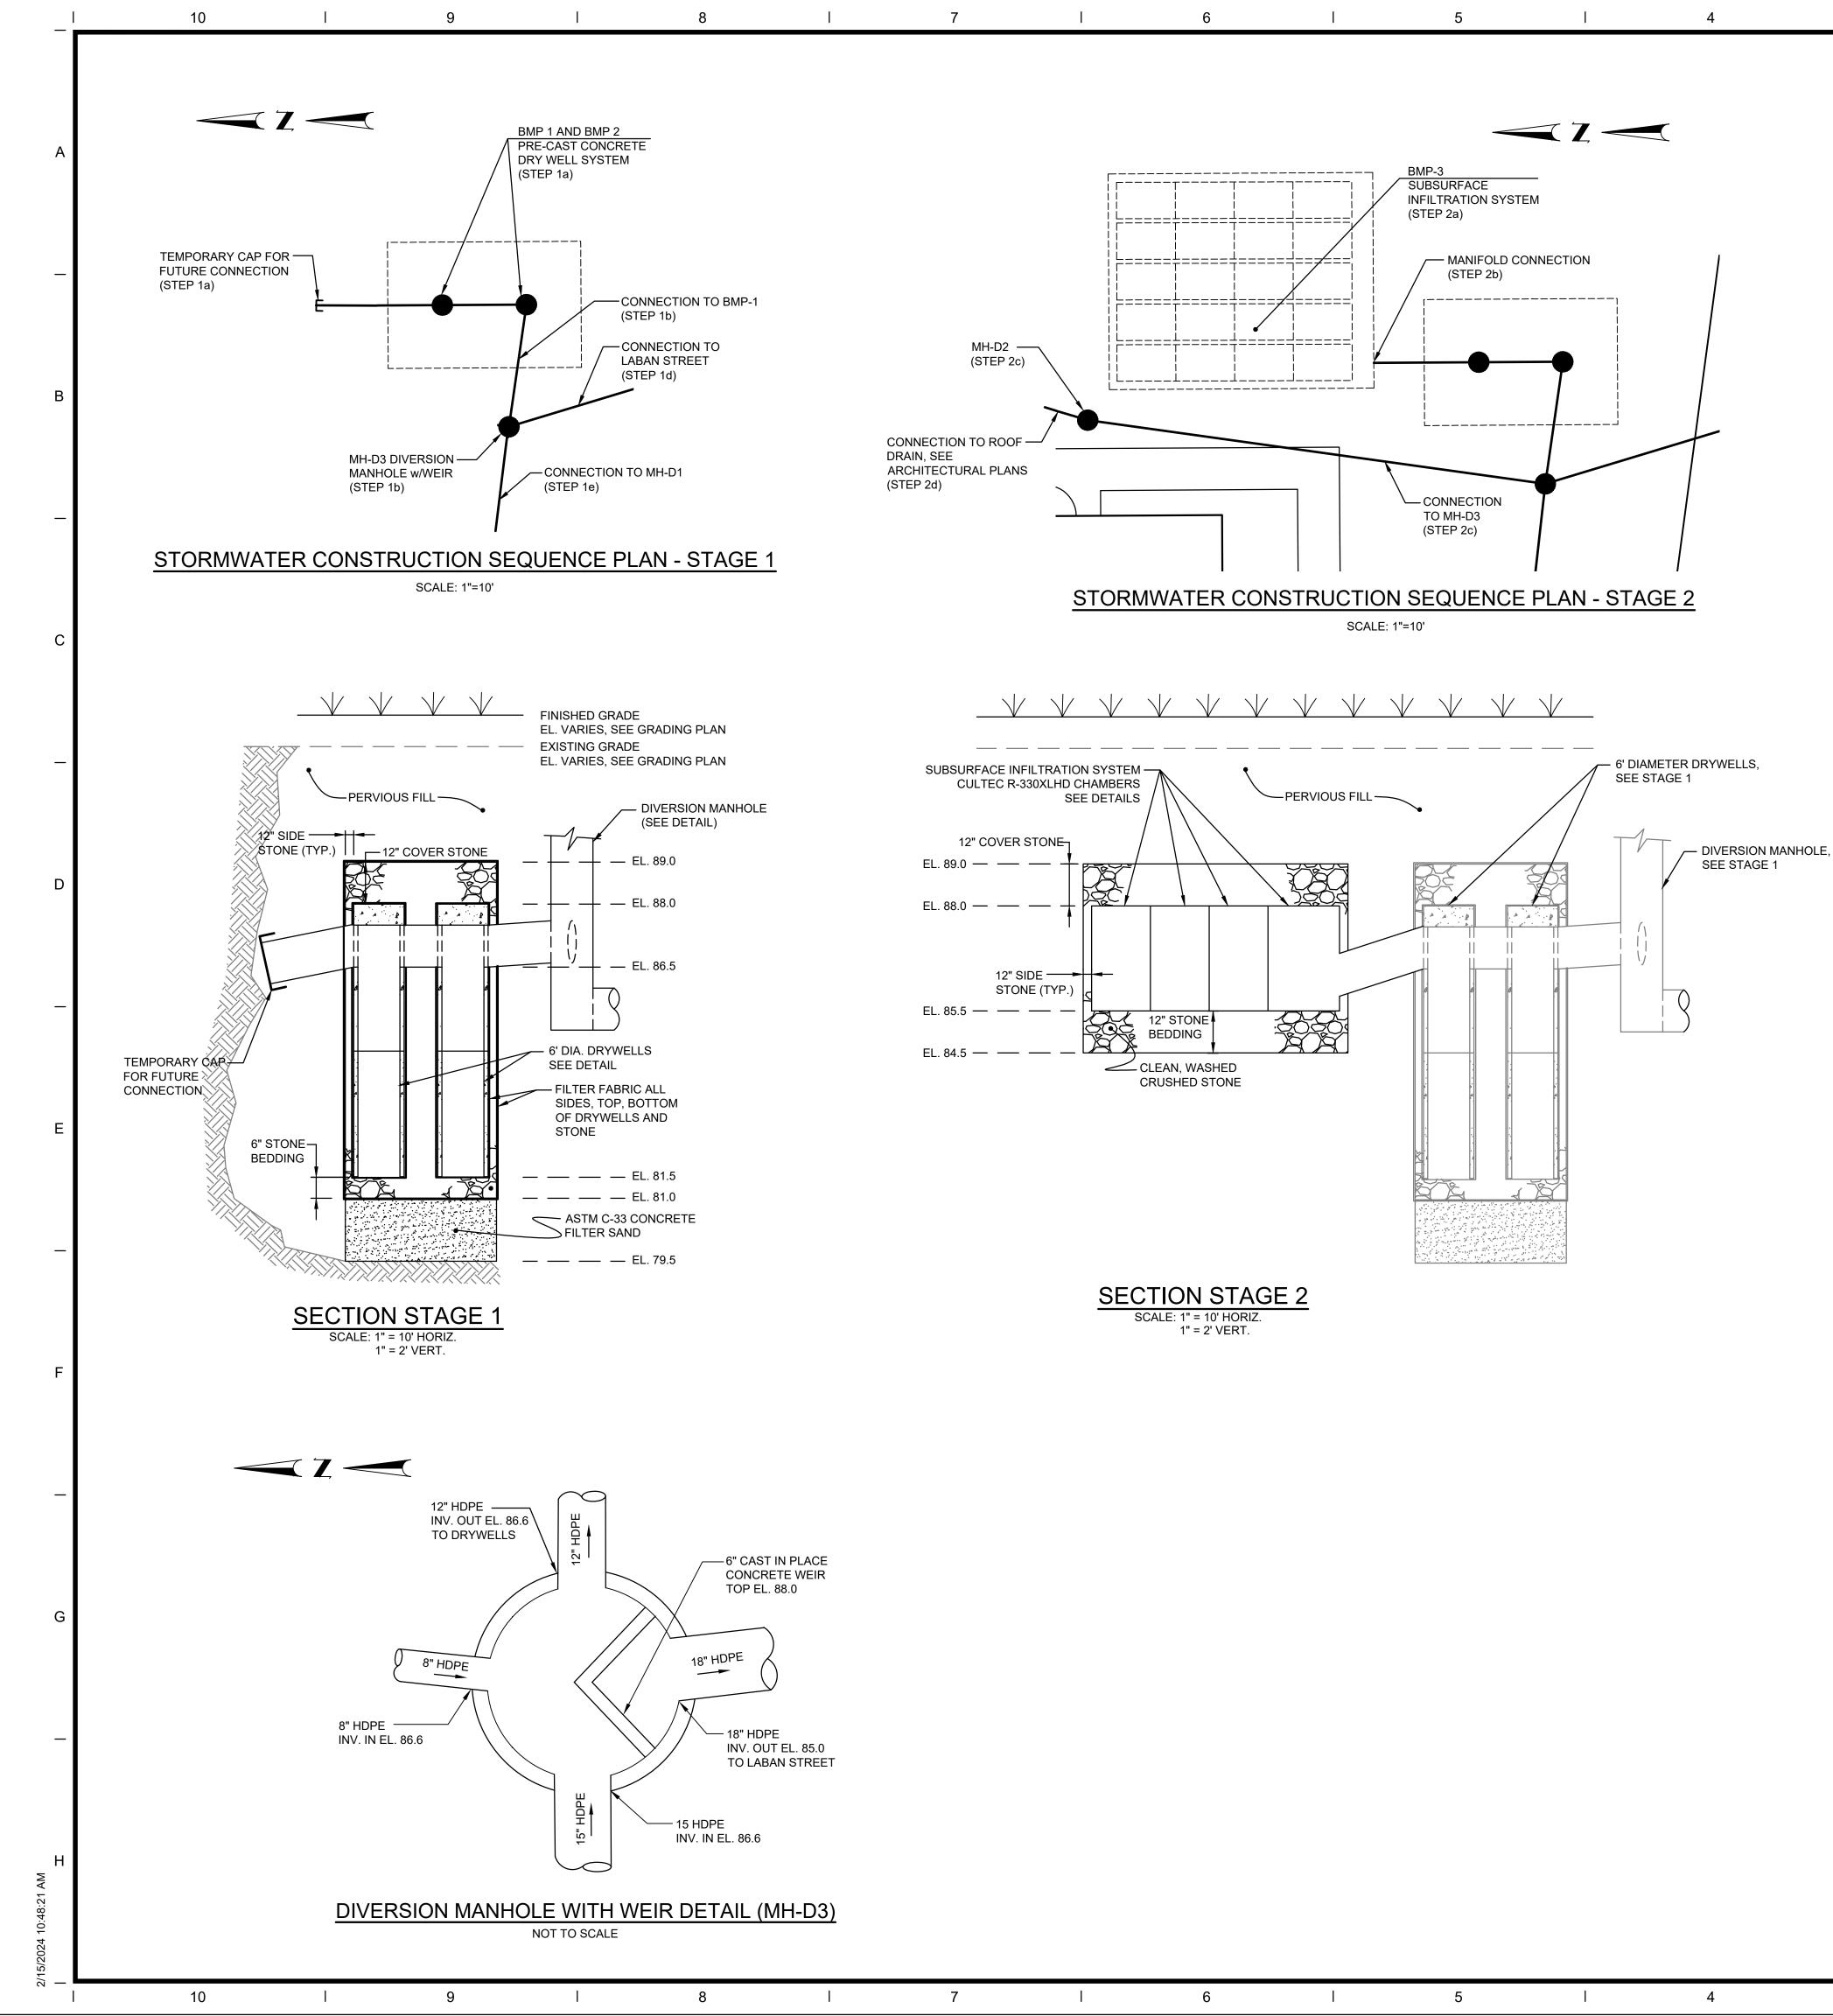

SUGGESTED STORMWATER CONSTRUCTION SEQUENCE:

1. STORMWATER CONSTRUCTION STAGE 1

a. CONSTRUCT BMP-1 AND BMP-2, INCLUDING DRYWELL STRUCTURES, DRAINAGE PIPES, FILTER SAND, CRUSHED STONE BASE, SIDE STONE, COVER STONE, FILTER FABRIC, ETC. INSTALL TEMPORARY CAP ON DRAINAGE CONVEYANCE PIPE EXITING BMP-2 FOR FUTURE CONNECTION.

b. CONSTRUCT THE DIVERSION MANHOLE (MH-D3) WITH INTERNAL WEIR, INCLUDING CONNECTION TO BMP-1.

c. CONSTRUCT NEW SEWER MANHOLES, MH-S2, MHS3,AND MH-S4 WITHIN LABAN STREET INCLUDING PIPE CONVEYANCES.

d. TIE NEW PIPE INTO SEWER MANHOLE MH-S2 WITHIN LABAN STREET. CONNECT NEW PIPE TO MH-D3. CONSTRUCT TEMPORARY PLUG ON NORTH INLET FOR FUTURE CONNECTION.

e. CONSTRUCT MH-D1 INCLUDING CONNECTION TO MH-D3. CONSTRUCT TEMPORARY PLUG ON NORTH INLET FOR FUTURE CONNECTION.

f. TIE NEW PIPE INTO EXISTING DRAINAGE MANHOLE (DMH NO. 3). CONNECT NEW PIPE TO MH-D1. ENSURE ALL CONNECTIONS, CAPS, PLUGS, ETC. ARE SECURE PRIOR TO PROCEEDING TO THE NEXT STEP.

g. CUT, CAP, REMOVE, AND DISPOSE DRAINAGE PIPE BETWEEN EXISTING DMH NO. 3 AND EXISTING DMH NO. 4.

h. CUT AND CAP EXISTING DRAINAGE PIPE FROM EXISTING DRAINAGE MANHOLE (DMH NO. 7) TO SEWER CONNECTION WITHIN EASTWOOD AVENUE.

i. REMOVE AND DISPOSE EXISTING DRAINAGE MAHNOLES (DMH NO. 4, 5, 6, & 7)
 AND ASSOCIATED DRAINAGE PIPES.
 j. REMOVE AND SALVAGE EXISTING SUBSURFACE INFILTRATION SYSTEM

2. STORMWATER CONSTRUCTION STAGE 2

a. CONSTRUCT BMP-3, INCLUDING ARCH CHAMBERS, MANIFOLD, FILTER FABRIC, AND CRUSHED STONE BEDDING.

 b. REMOVE TEMPORARY CAP ON DRAINAGE PIPE EXISTING BMP-2 AND CONNECT TO MANIFOLD SYSTEM OF BMP-3.

c. CONSTRUCT MH-D2, INCLUDING CONNECTION TO MH-D3.
d. INSTALL ROOF DRAIN CONNECTIONS TO MH-D1 AND MH-D2 PER ARCHITECTURAL

NOTES:

PLANS.

6' DIA —

1. THE SUGGESTED CONSTRUCTION SEQUENCE IS PROVIDED TO MAINTAIN CONVEYANCE AND TREATMENT OF RUNOFF IN ACCORDANCE WITH APPLICABLE REGULATORY PERMITS. ANY DEVIATIONS FROM THE SUGGESTED CONSTRUCTION SEQUENCE MUST BE COORDINATED WITH THE ENGINEER TO ENSURE COMPLIANCE WITH REGULATORY PERMITS.

2. THE CONTRACTOR SHALL NOT DISCONNECT THE EXISTING SUBSURFACE INFILTRATION SYSTEM (STEP 1G) FROM SERVICE UNTIL BMP-1 AND BMP-2 ARE PROPERLY INSTALLED AND PLACED ON-LINE.

3. THE CONTRACTOR SHALL TAKE CARE AND USE APPROPRIATE MEANS AND METHODS WHEN REMOVING COMPONENTS OF THE EXISTING SUBSURFACE INFILTRATION SYSTEM SO THEY MAY BE RE-USED IN THE CONSTRUCTION OF BMP-3. THE CONTRACTOR SHALL COORDINATE WITH THE OWNER TO STORE THE SALVAGED MATERIALS IN A SAFE AND SECURE LOCATION UNTIL SUCH TIME AS THEY MAY BE INSTALLED PER THE SUGGESTED CONSTRUCTION SEQUENCE. IF ANY COMPONENTS OF THE EXISTING SUBSURFACE INFILTRATION SYSTEM ARE DAMAGED DURING OR AFTER REMOVAL, THE CONTRACTOR SHALL PROVIDE AND INSTALL NEW COMPONENTS AT NO ADDITIONAL COST TO THE OWNER.

PLAN VIEW

SECTION VIEW

CONCRETE: 4,000 PSI MINIMUM AFTER 28 DAYS.
 ALSO AVAILABLE IN AASHTO HS-20 LOADING.

DRY WELL CYLINDRICAL

1000 GALLON STACKABLE

3. CAPACITY INCREASES IN INCREMENTS OF 500 GALLONS

ITEM NO.

FOR EACH 3' SECTION ADDED.

1000 GALLON | 1000SDW

3' STACKABLE 3SS

DRAIN HOLES 4" TO 1.5" TAPERED

H-20

____20" DIA INSPECTION COVER

(4) 10" DIA INLET

WEIGHT

STANDARD 6,778#

RYWELL STRUCTURES, DRAINAGE E, SIDE STONE, COVER STONE,

Notice:
This drawing is the property of Tecton Architects | pc. The use, re-use or reproduction of this drawing for any purpose whatsoever without an expressed written agreement between Tecton Architects | pc and the user is prohibited. Rights to use the information on this sheet are not transferred until payment has been received for services rendered. Any rights so granted are non-transferable to other parties without the prior expressed written consent of Tecton Architects | pc

ARCHITECTS

© 2024 Tecton Architects | pc



Client/ Contractor

PROVIDENCE PUBLIC SCHOOLS

797 WESTMINSTER STREET PROVIDENCE, RI 02903

ject

SPAZIANO MIDDLE SCHOOL

254 EASTWOOD AVENUE PROVIDENCE, RI 02909

Seals

PROGRESS SET

NOT FOR CONSTRUCTION

Issues / Revisions
No. Date Description

V2 7/28/2023 SCHEMATIC DESIGN
2/20/2024 CITY OF PROV MASTER PLAN
2/29/2024 DESIGN DEVELOPMENT

CONSTRUCTION DETAILS


Project Manager: BDN Project No: 41037

Drawn by: LBD Scale: AS NOTED

Drawing Number

Drawing Title

C-6.4

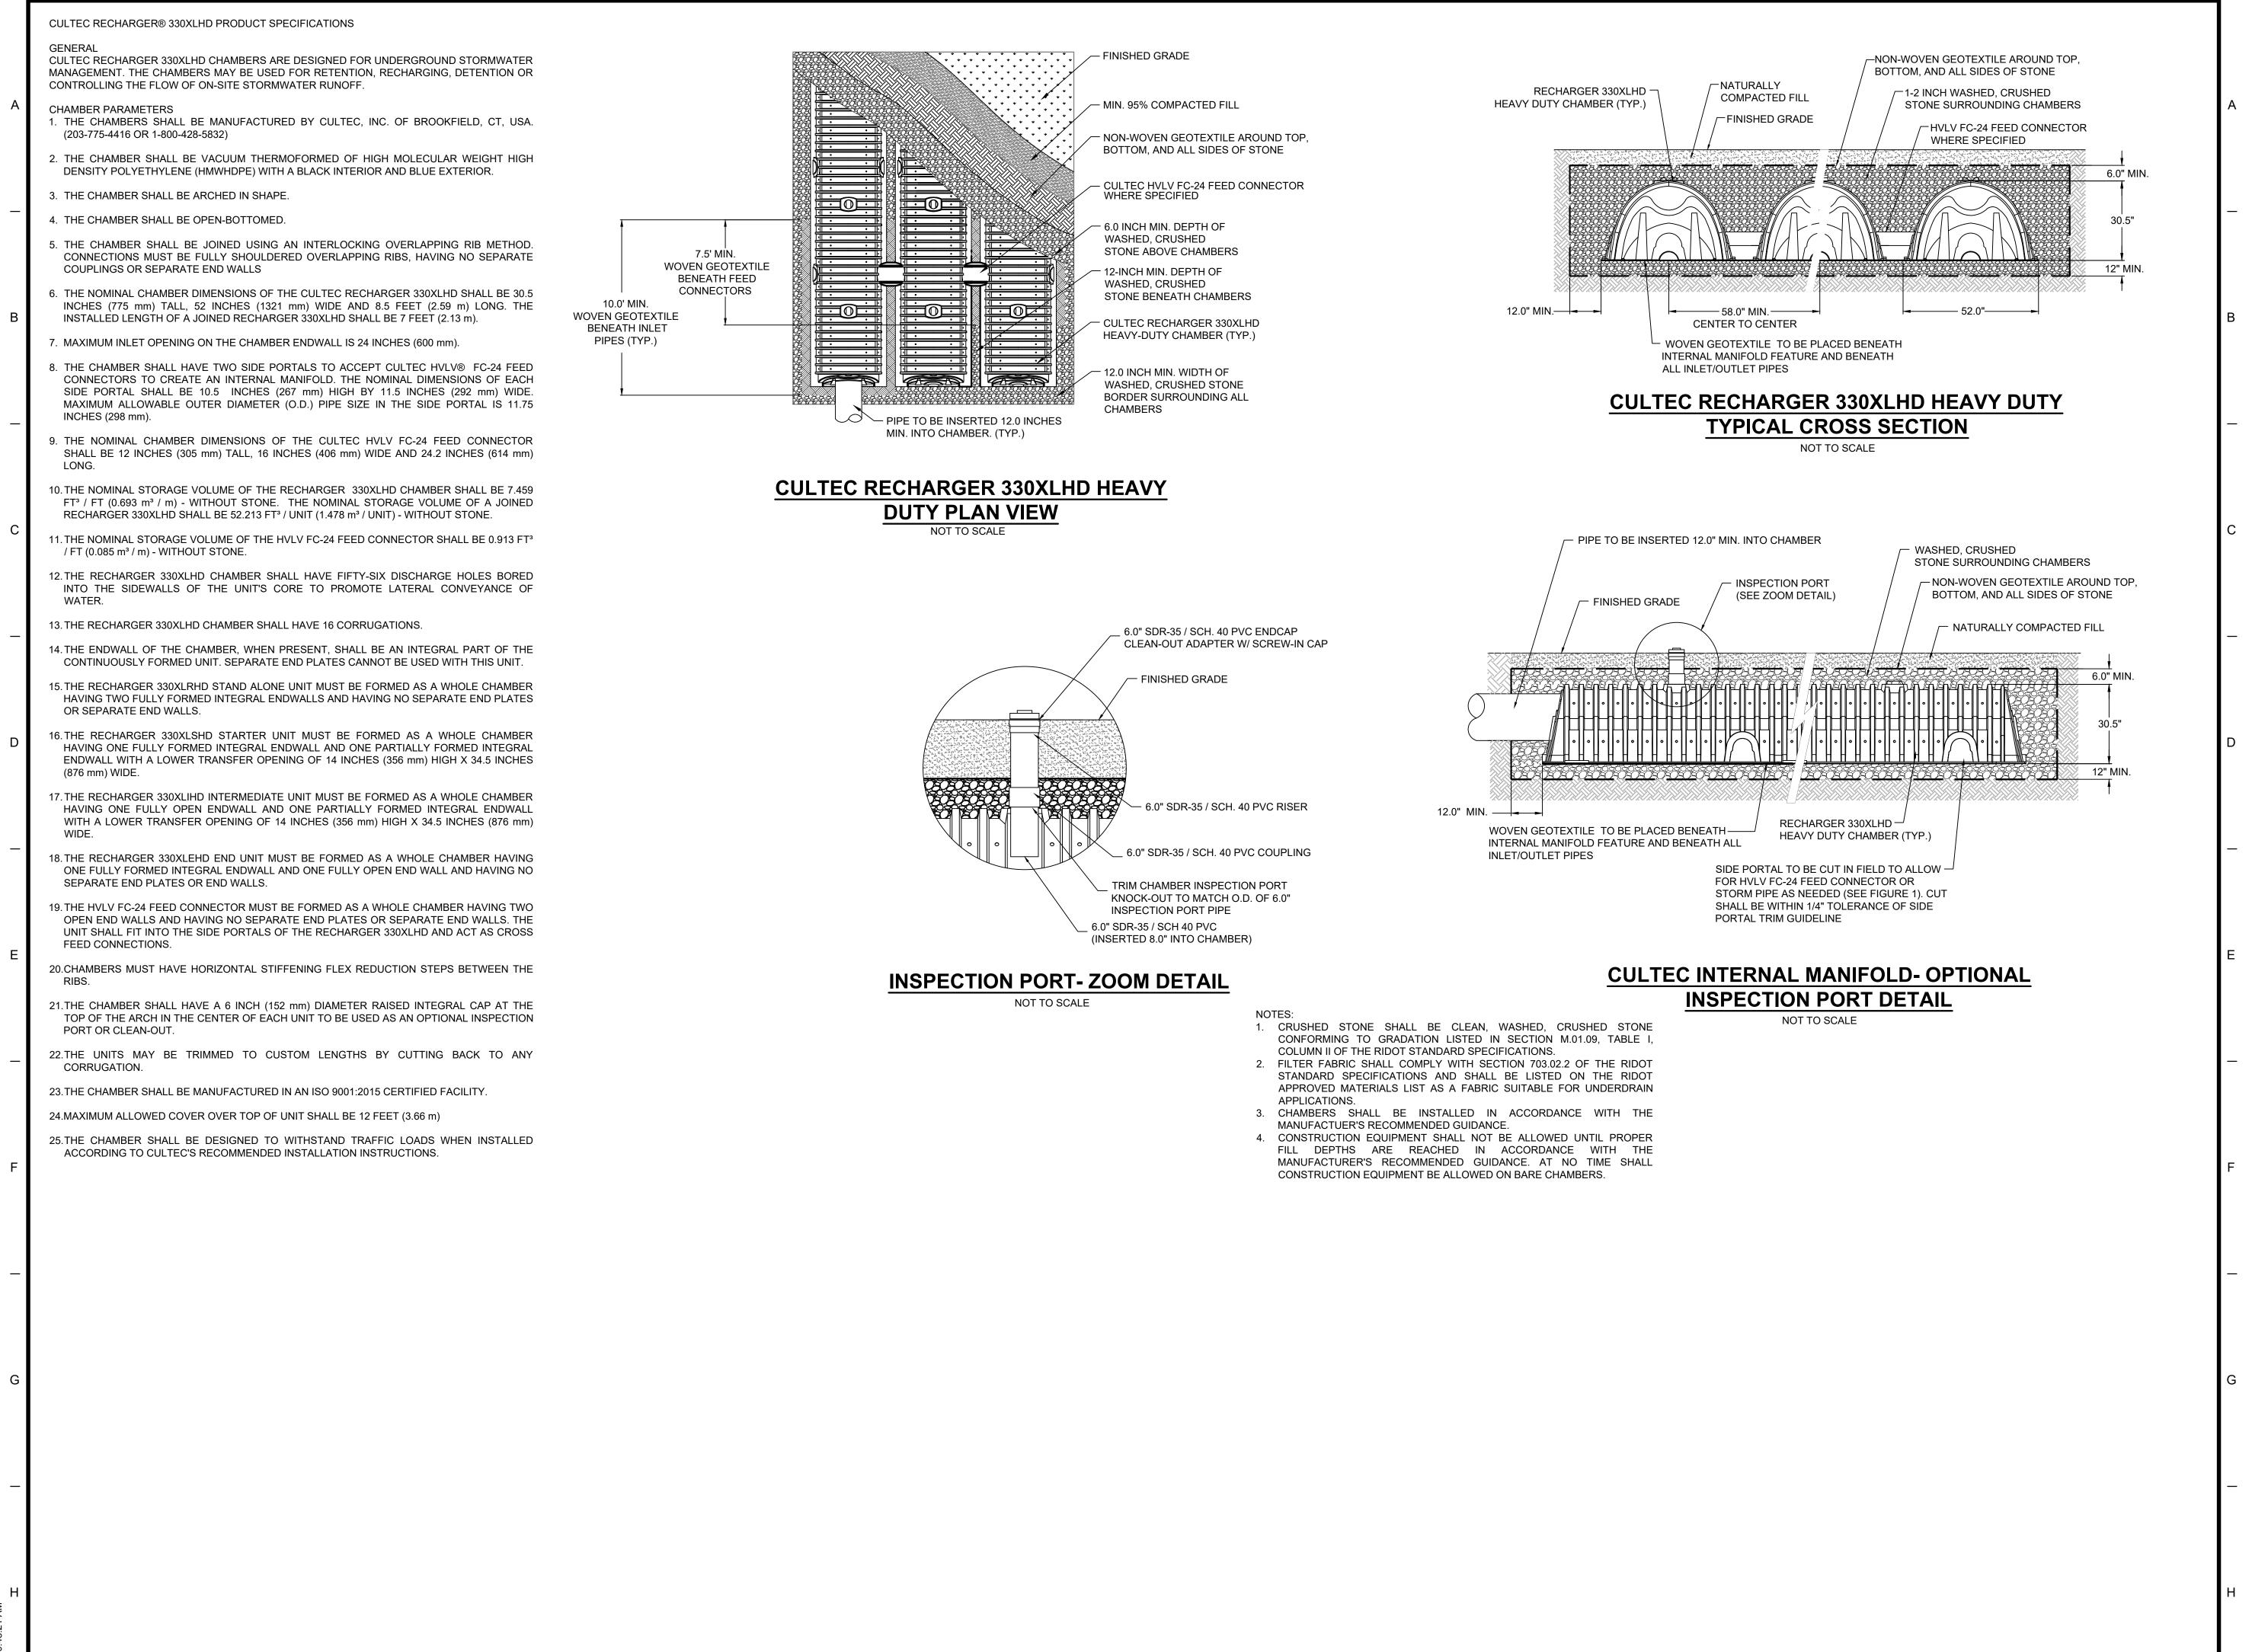

6

5

3

Tecton ARCHITECTS

Notice:
This drawing is the property of Tecton Architects | pc. The use, re-use or reproduction of this drawing for any purpose whatsoever without an expressed written agreement between Tecton Architects | pc and the user is prohibited. Rights to use the information on this sheet are not transferred until payment has been received for services rendered. Any rights so granted are non-transferable to other parties without the prior expressed written consent of Tecton Architects | pc

© 2024 Tecton Architects | pc



Client/ Contractor

PROVIDENCE PUBLIC SCHOOLS

797 WESTMINSTER STREET PROVIDENCE, RI 02903

Project

SPAZIANO MIDDLE SCHOOL

254 EASTWOOD AVENUE PROVIDENCE, RI 02909

Seals

PROGRESS SET

NOT FOR CONSTRUCTION

Issues / Revisions
No. Date Description

V2 7/28/2023 SCHEMATIC DESIGN
2/20/2024 CITY OF PROV MASTER PLAN
2/29/2024 DESIGN DEVELOPMENT

CONSTRUCTION DETAILS


Project Manager: BDN Project No: 41037

Drawn by: LBD Scale: AS NOTED

Drawing Number

Drawing Title

C-6.5

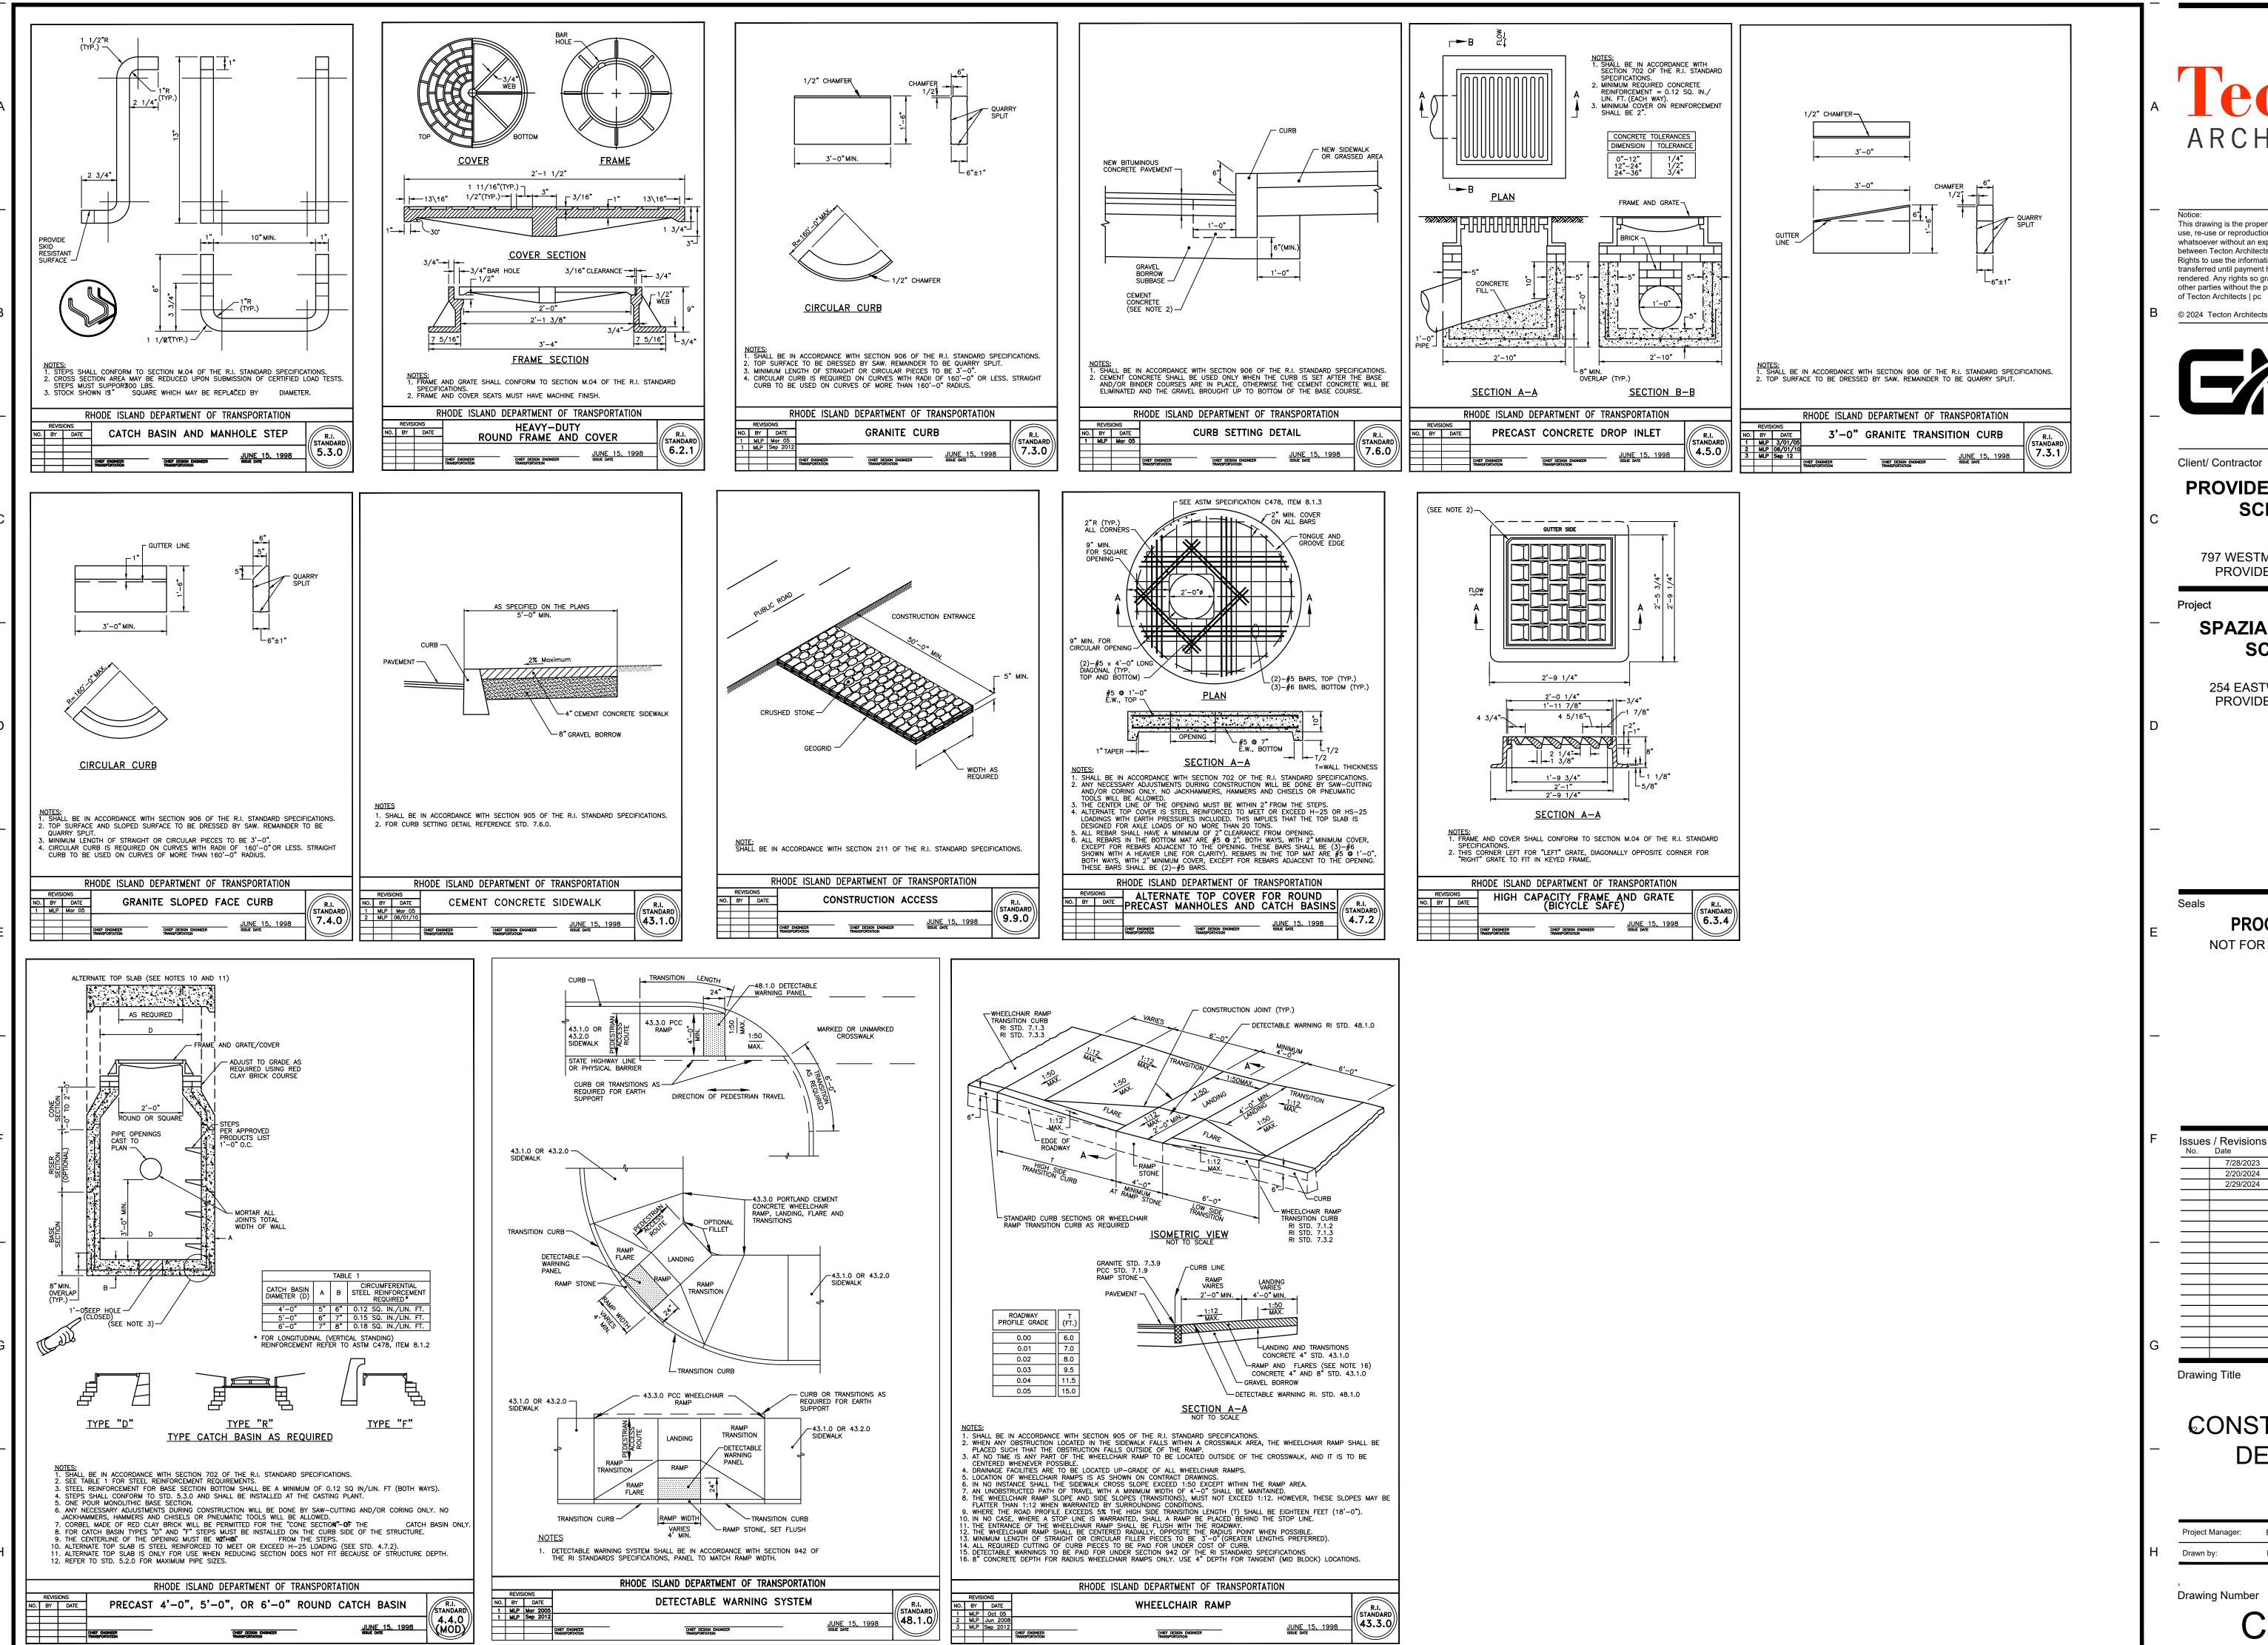

10

ARCHITECTS

This drawing is the property of Tecton Architects | pc. The use, re-use or reproduction of this drawing for any purpose whatsoever without an expressed written agreement between Tecton Architects | pc and the user is prohibited. Rights to use the information on this sheet are not transferred until payment has been received for services rendered. Any rights so granted are non-transferable to other parties without the prior expressed written consent

© 2024 Tecton Architects | pc



Client/ Contractor

PROVIDENCE PUBLIC **SCHOOLS**

797 WESTMINSTER STREET PROVIDENCE, RI 02903

Proiect

SPAZIANO MIDDLE SCHOOL


254 EASTWOOD AVENUE PROVIDENCE, RI 02909


PROGRESS SET NOT FOR CONSTRUCTION


No.	Date	Description
	7/28/2023	SCHEMATIC DESIGN
	2/20/2024	CITY OF PROV MASTER PLAN
	2/29/2024	DESIGN DEVELOPMENT


CONSTRUCTION **DETAILS**

Project Manager:	BDN	Project No:	41037
Drawn by:	LBD	Scale:	AS NOTED
			•

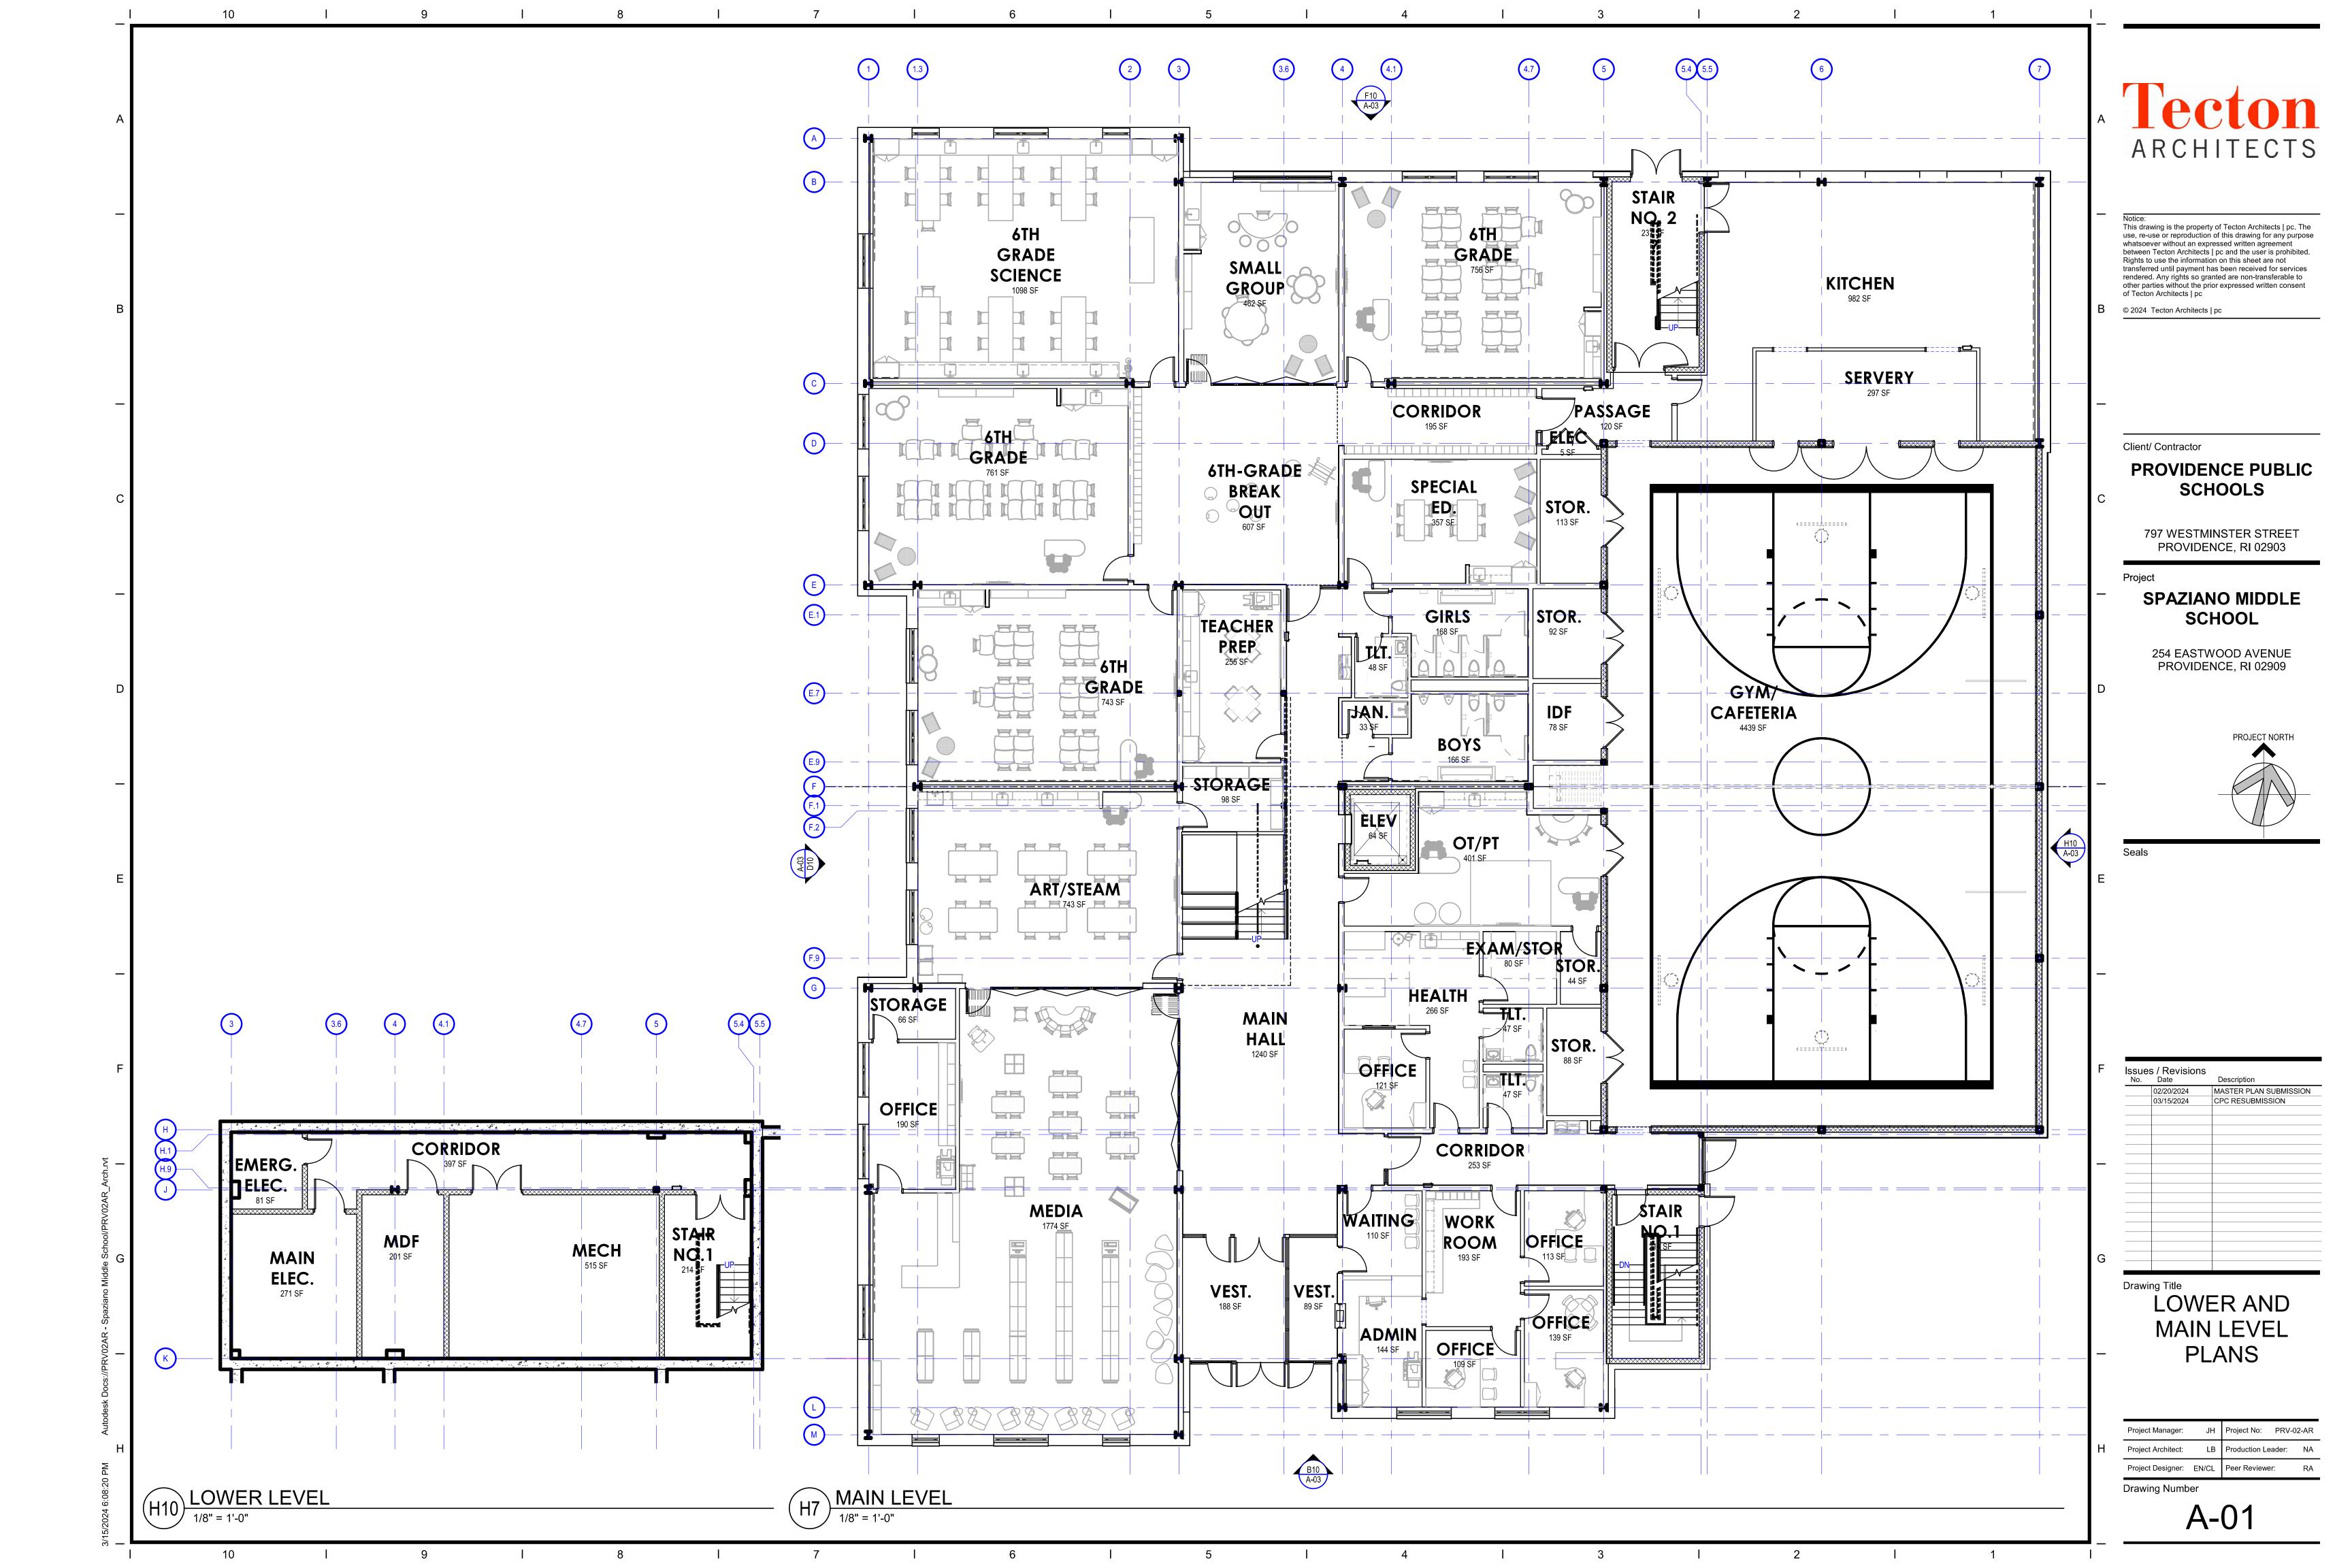

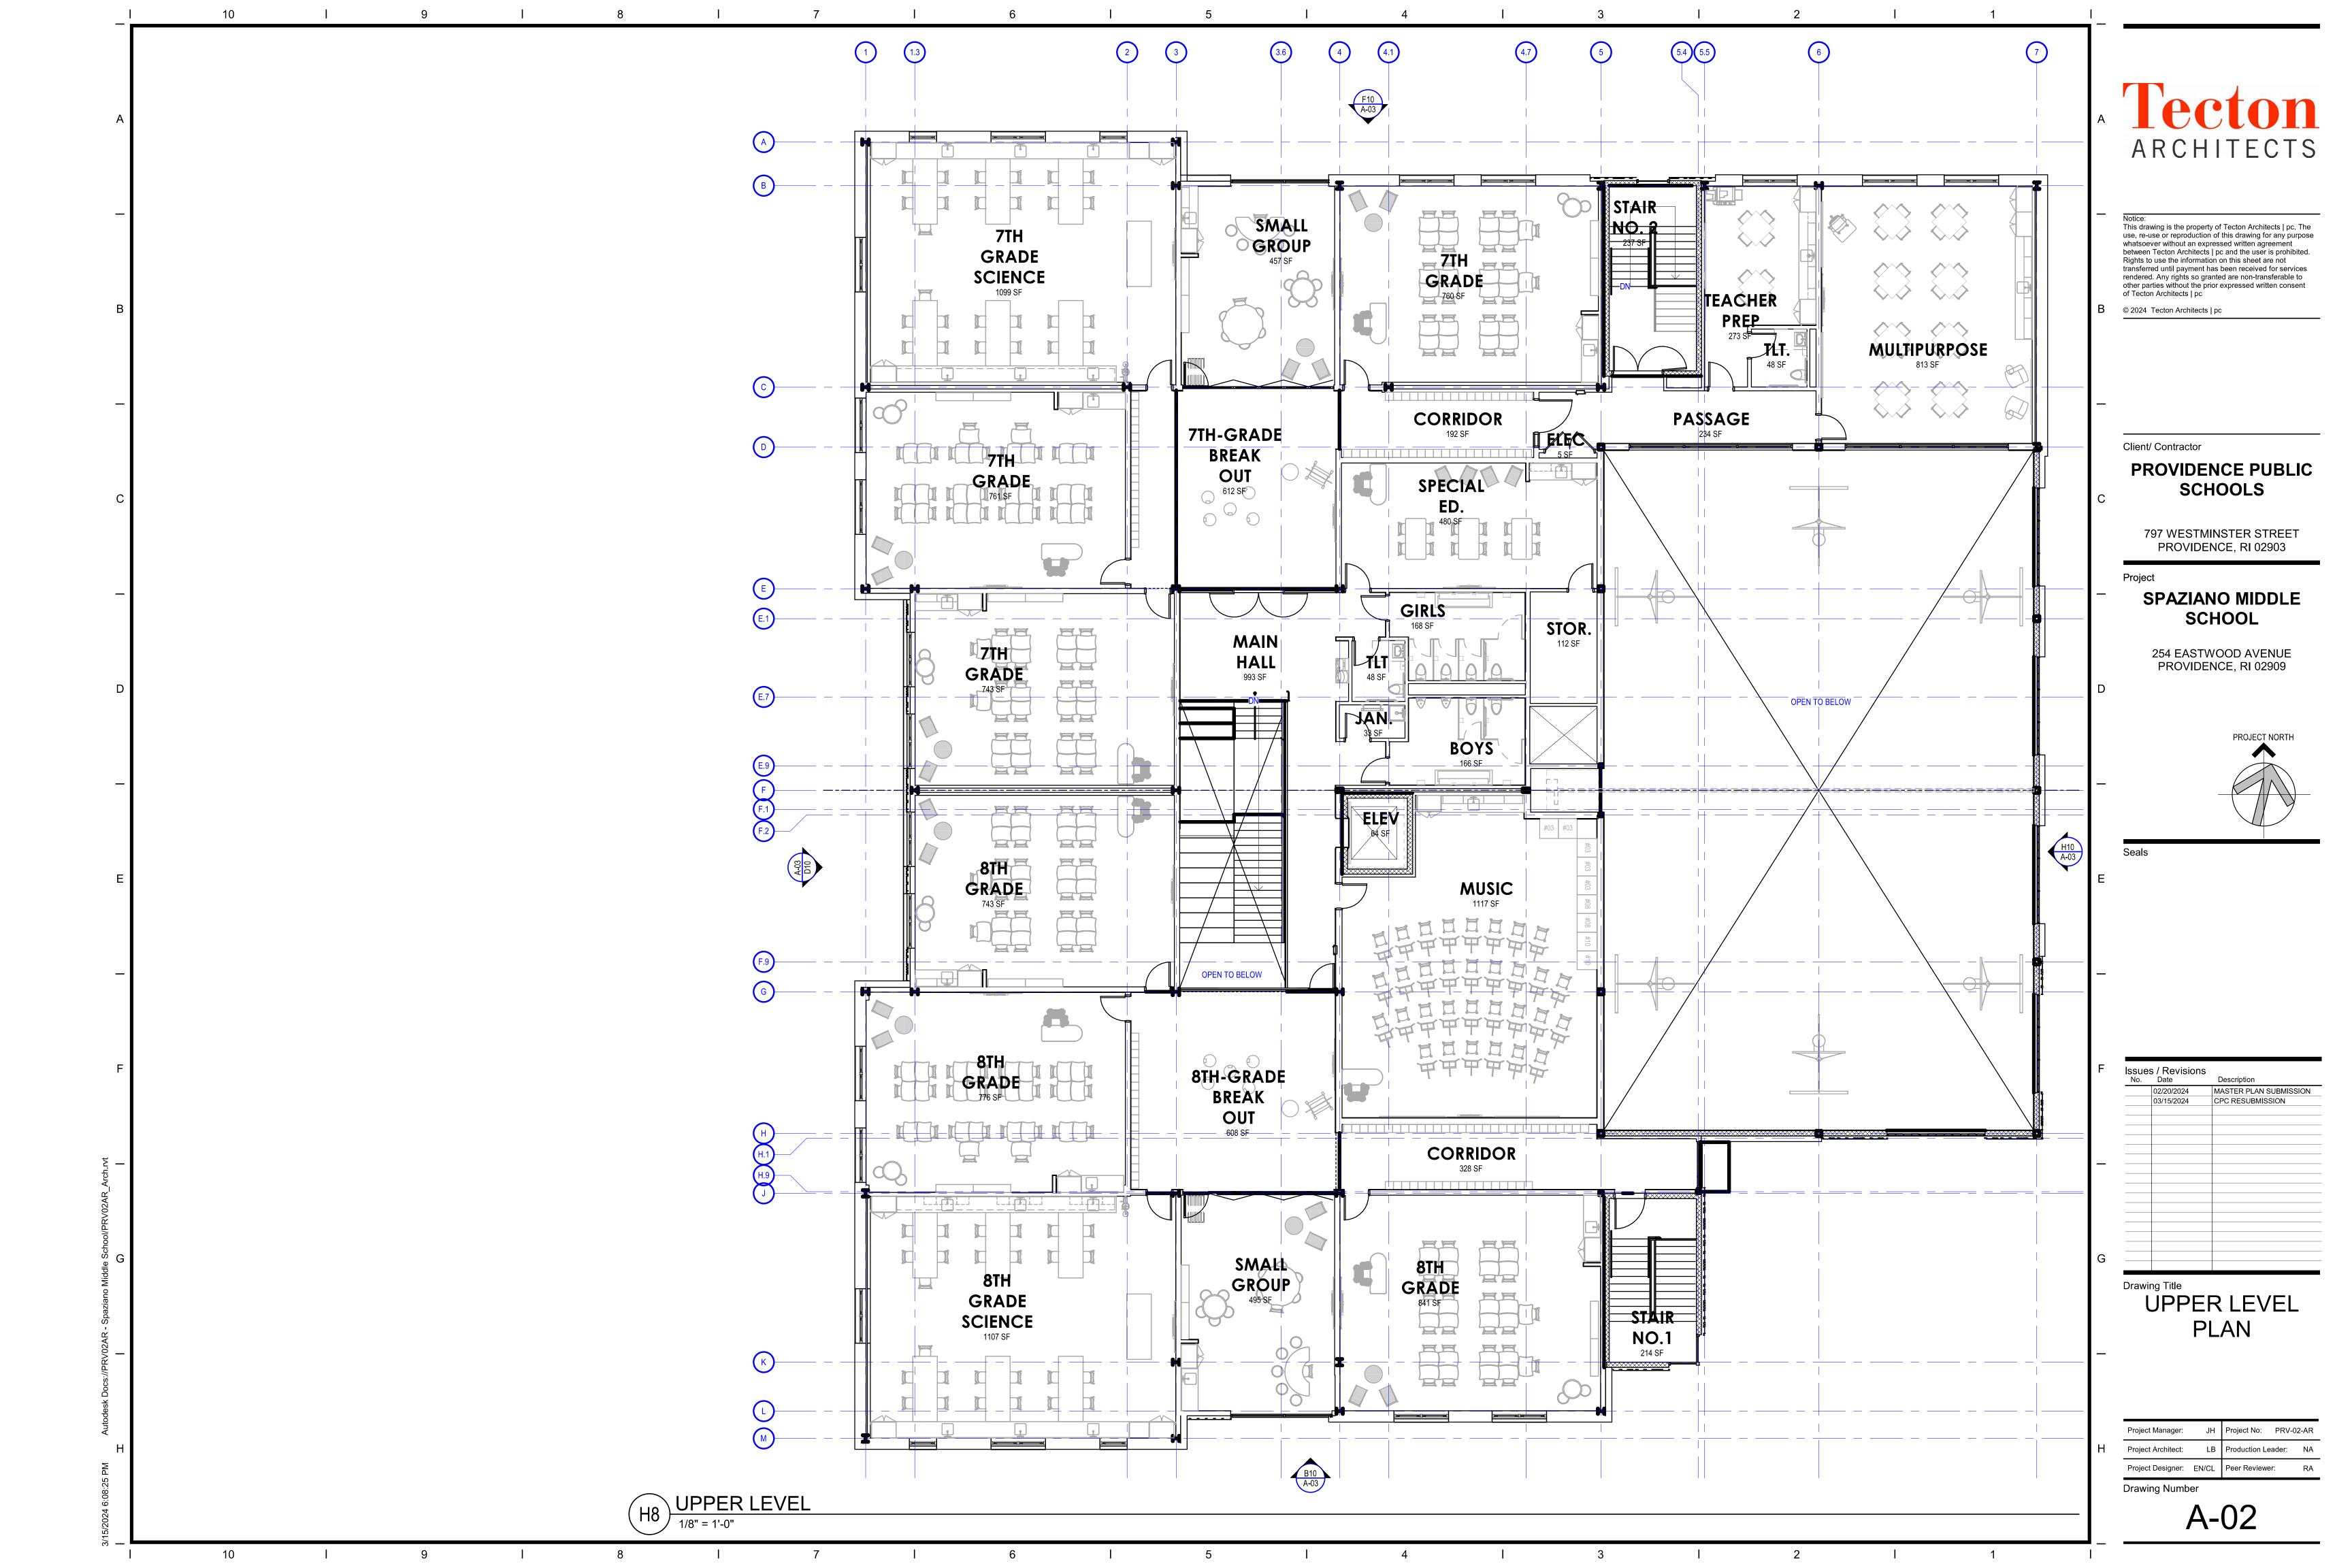

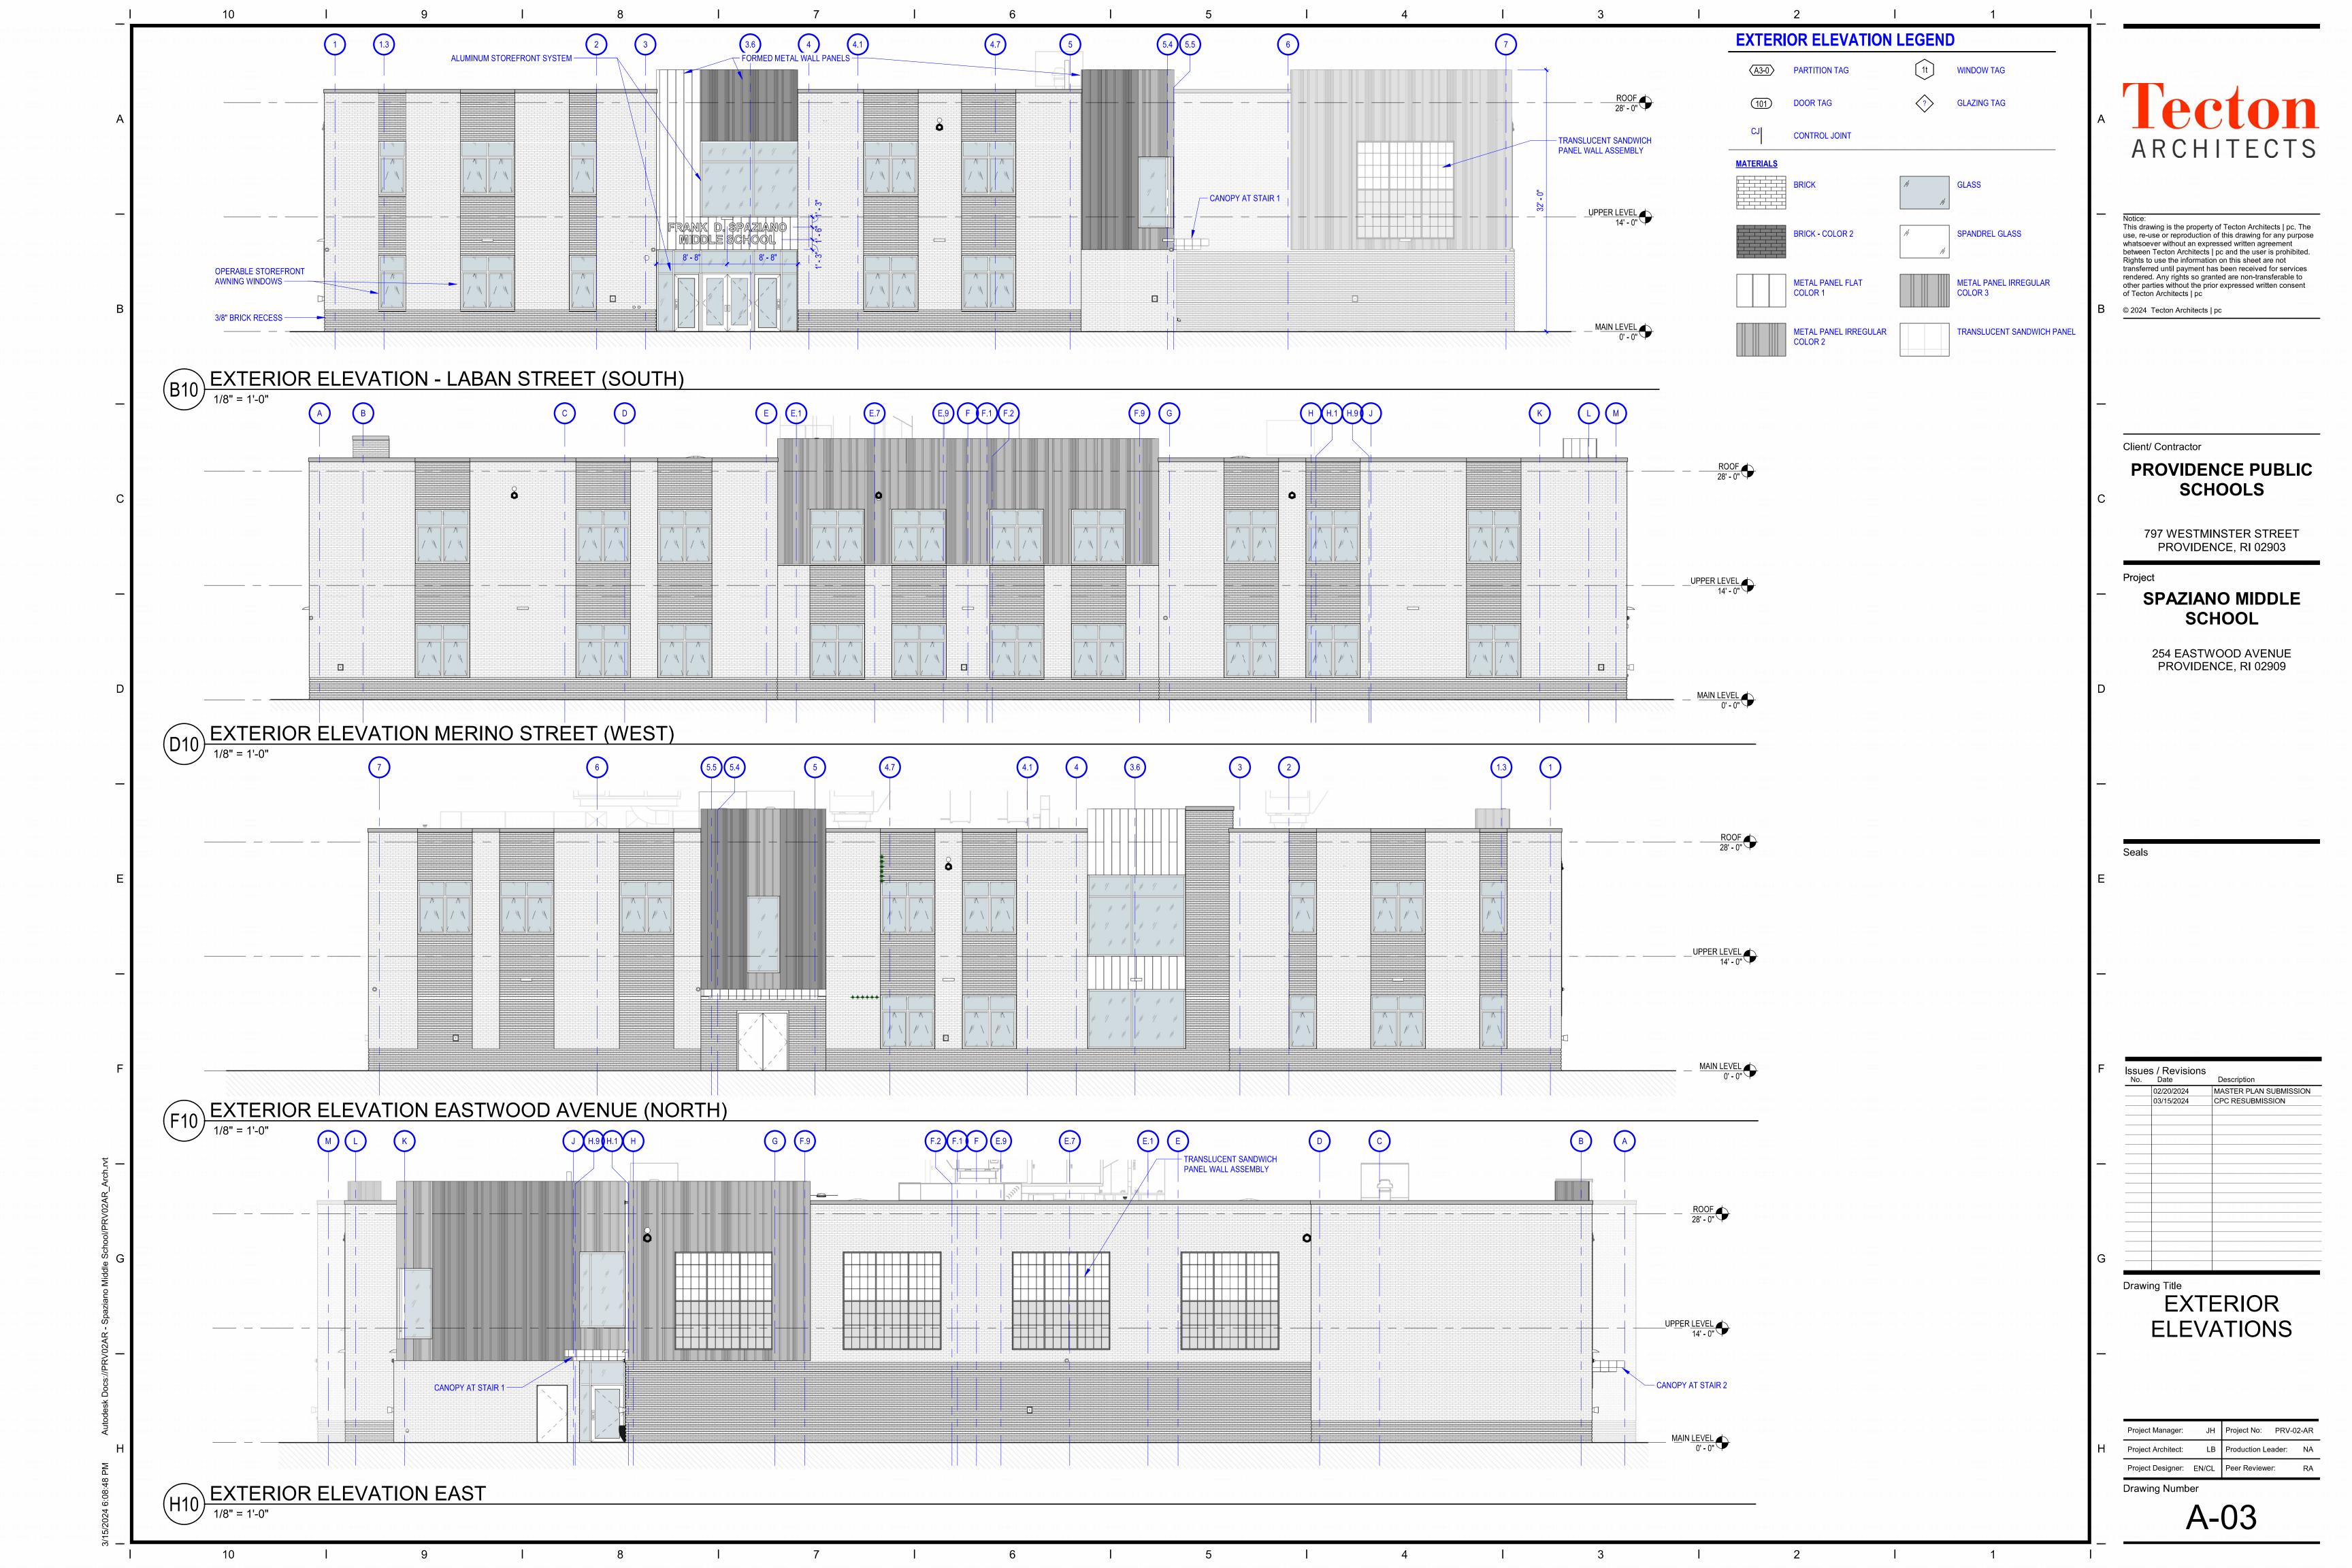

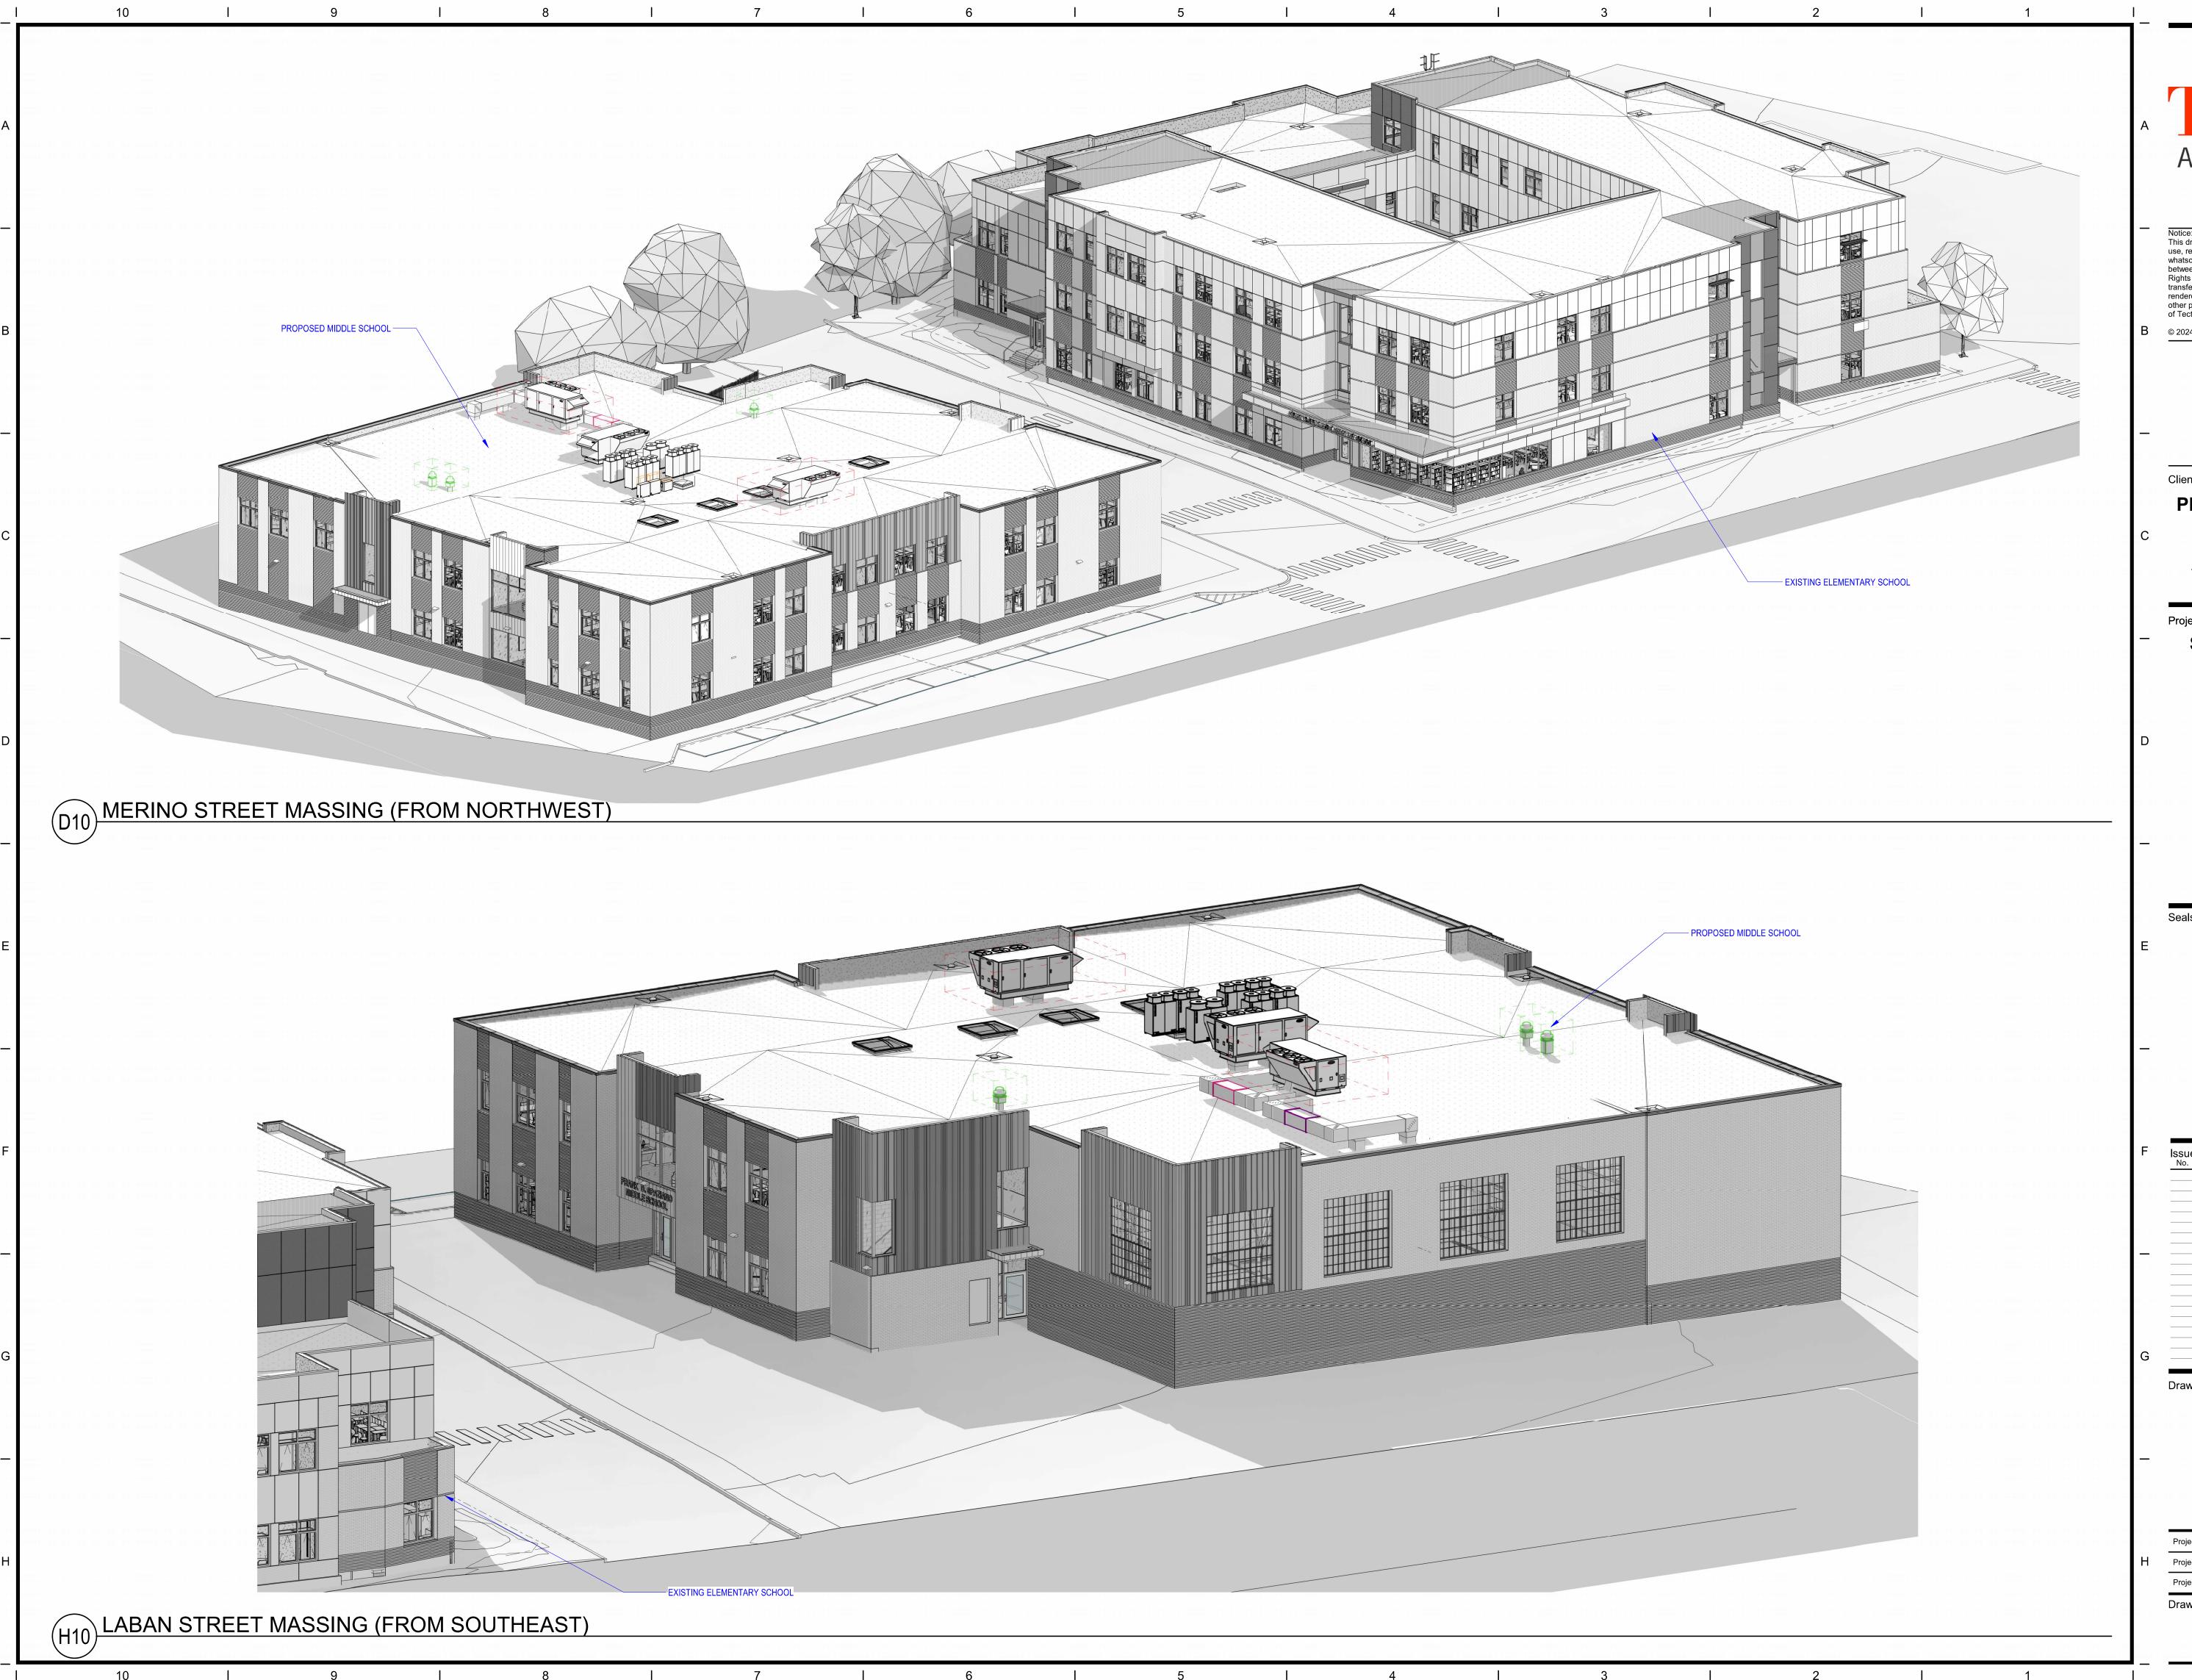

Tecton ARCHITECTS

Notice:
This drawing is the property of Tecton Architects | pc. The use, re-use or reproduction of this drawing for any purpose whatsoever without an expressed written agreement between Tecton Architects | pc and the user is prohibited. Rights to use the information on this sheet are not transferred until payment has been received for services rendered. Any rights so granted are non-transferable to other parties without the prior expressed written consent of Tecton Architects | pc

© 2024 Tecton Architects | pc

Client/ Contractor

PROVIDENCE PUBLIC SCHOOLS

797 WESTMINSTER STREET PROVIDENCE, RI 02903

Project

SPAZIANO MIDDLE SCHOOL

254 EASTWOOD AVENUE PROVIDENCE, RI 02909

Issues / Revisions
No. Date Description

02/20/2024 MASTER PLAN SUBMISSION
03/15/2024 CPC RESUBMISSION

Drawing Title
EXTERIOR
MASSING

H Project Manager: JH Project No: PRV-02-AR

Project Architect: LB Production Leader: NA

Project Designer: EN/CL Peer Reviewer: RA

Drawing Number

A-04

D7 VIEW FROM LABAN STREET



VIEW FROM MERINO AND LABAN

A Tecton ARCHITECTS

Notice:
This drawing is the property of Tecton Architects | pc. The use, re-use or reproduction of this drawing for any purpose whatsoever without an expressed written agreement between Tecton Architects | pc and the user is prohibited. Rights to use the information on this sheet are not transferred until payment has been received for services rendered. Any rights so granted are non-transferable to other parties without the prior expressed written consent of Tecton Architects | pc

© 2024 Tecton Architects | pc

Client/ Contractor

PROVIDENCE PUBLIC SCHOOLS

797 WESTMINSTER STREET PROVIDENCE, RI 02903

Project

SPAZIANO MIDDLE SCHOOL

254 EASTWOOD AVENUE PROVIDENCE, RI 02909

Seals KEY PLAN

H7 D7

Issues / Revisions
No. Date Description

02/20/2024 MASTER PLAN SUBMISSION

03/15/2024 CPC RESUBMISSION

Drawing Title
RENDERINGS


Project Manager: JH Project No: PRV-02-A

Project Architect: LB Production Leader: N

Project Designer: EN/CL Peer Reviewer: R

Drawing Number

A-05

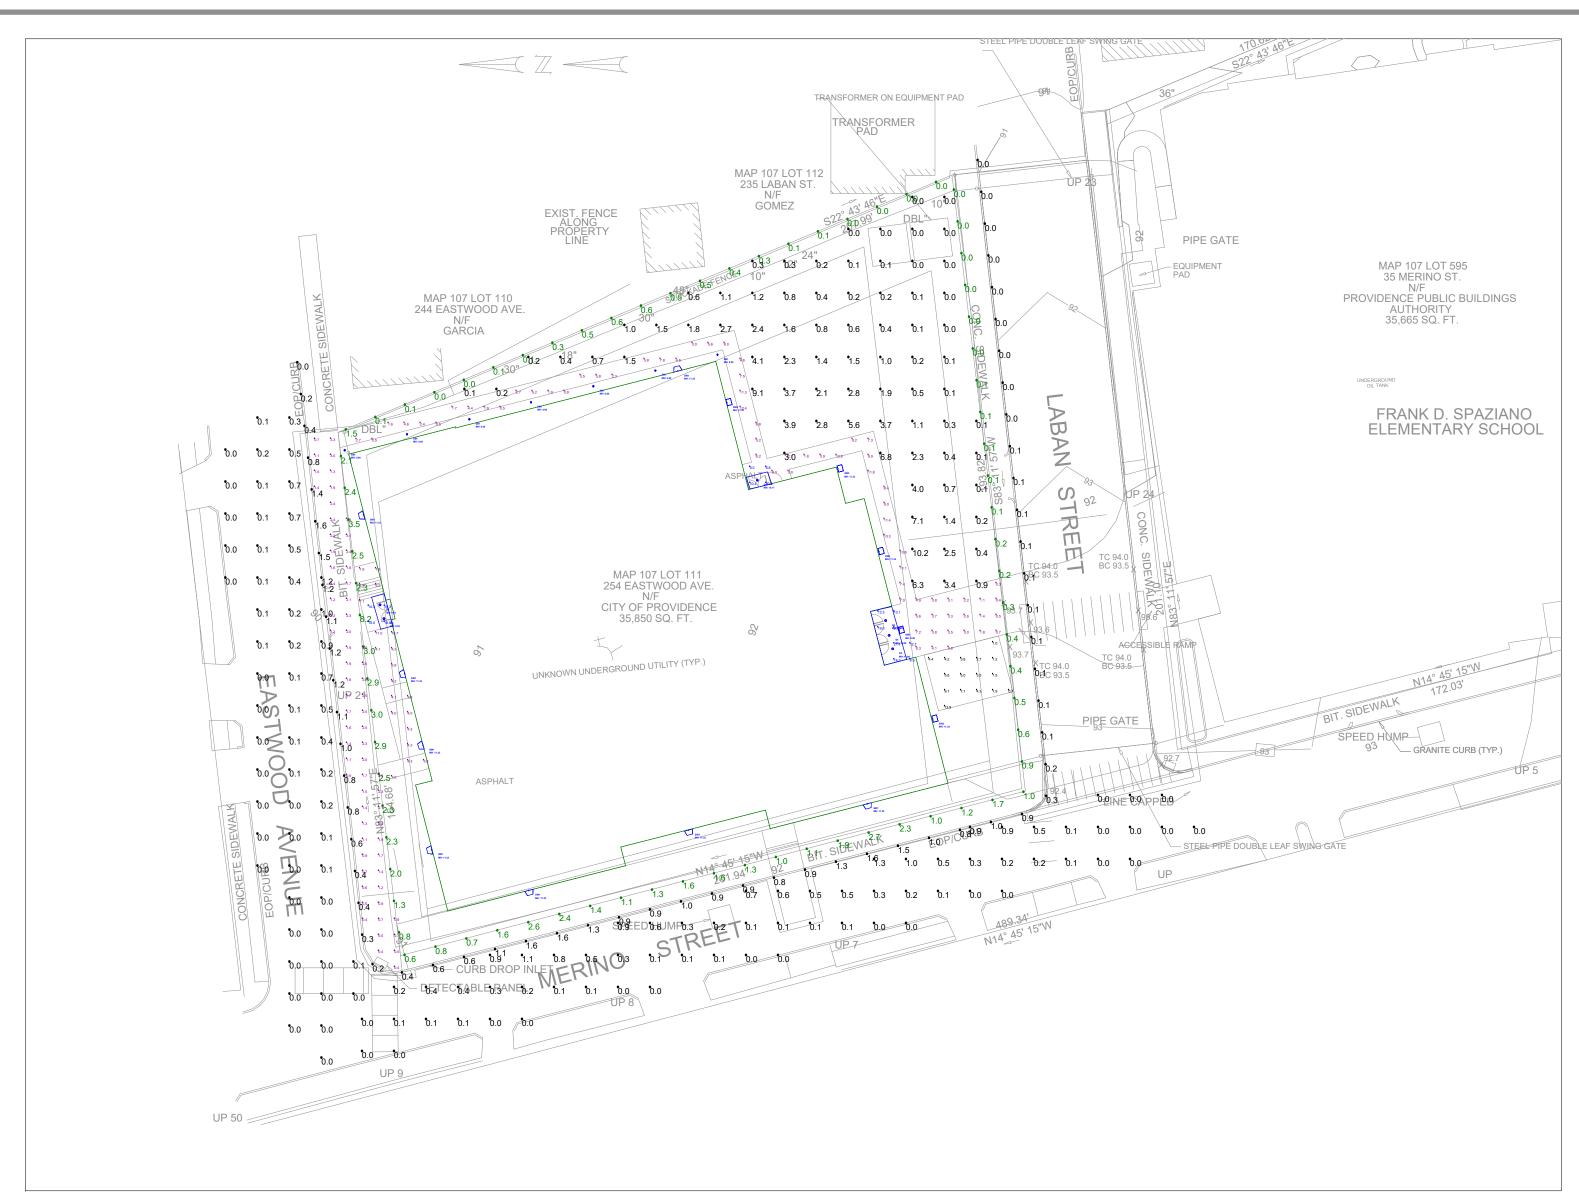

Scale: 1 inch= 30 Ft.

DESIGN NOTES:

- 1. MOUNTING HEIGHTS: SEE FIXTURE LOCATIONS
- 2. MEASUREMENTS TAKEN 0" AFF
- 3. SURFACE REFLECTANCE: .5

Note on this Design

This report makes no representations in regard to Lighting Design or Specification, rather it attempts to accurately reflect the photometric results of a design, as approved by others.

Note on these Photometric Calculations:

This analysis is a mathematical model and can be only as accurate as is permitted by the third-party software and the IES standards used. All digital CAD data appear to be accurate, however, this apparent accuracy is an artifact of the techniques used to generate it and is in no way intended to imply accuracy in the real world.


There are many factors that will impact the actual performance of Lighting in the constructed space, including: the accuracy of the original source (.ies) files supplied by the manufacturer, input voltage ballast variances, actual finish values in the constructed environment, manufacturing variations in both the source (lamp) and the luminaire, final luminaire placement, obstructions, and installation quality. Further, field measurement itself is subject to errors arising from measuring methods and/or technology selected, and the knowledge/ability of the measuring party. While the creator of this lighting study makes every effort to ensure accuracy, they cannot be held liable for any errors. The recipient of this lighting study understands and accepts that the likelihood of scaling error increases when no .DWG file or other properly-dimensioned drawing is provided to the designer.

Reflective Values have a significant effect on light levels, the end-user of the document should confirm these values before accepting the results of any photometric report. The managing contractor/ architect/engineer is responsible for ensuring compliance to all relevant lighting ordinance(s) and energy codes required on this project.

LIGHTING DETAILS:

Lumin	aire Schedu	ıle					
Label	Symbol	Qty	LLF	[MANUFAC]	Description	Luminaire	Luminaire
						Lumens	Watts
D4		6	0.774	LIGHTOLIER BY	4RN, P4RDL20935WCCZ10U	1844	16.1
				SIGNIFY			
SB1		7	0.900	SIGNIFY	PBL-36-14L-100-NW-G2-3-UNV-XX	492	6.1
				GARDCO			
SW1		8	0.900	SIGNIFY GARDCO	101L-16L-400-NW-G2-3-UNV-FAWS-XX	2728	22
SW2	→	1	0.900	STONCO	LPW32-70-NW-G3-4-UNV-FAWS-XX	8139	64.6
SW3	-	4	0.900	STONCO	LPW32-70-NW-G3-3-UNV-FAWS-XX	8248	64.6

Calculation Summary								
Label	CalcType	Units	Avg	Max	Min	Avg/Min	Max/Min	Grid Z
BIKE RACKS	Illuminance	Fc	4.37	13.9	0.7	6.24	19.86	0
BIT SIDEWALK	Illuminance	Fc	1.65	3.4	0.4	4.13	8.50	0
EASTWOOD STREET	Illuminance	Fc	0.18	1.2	0.0	N.A.	N.A.	0
ENTRANCE - EASTWOOD STREET	Illuminance	Fc	16.60	19.3	14.0	1.19	1.38	0
ENTRANCE - LABAN STREET	Illuminance	Fc	15.26	21.4	8.6	1.77	2.49	0
ENTRANCE - SOUTHEAST	Illuminance	Fc	9.63	10.4	8.8	1.09	1.18	0
EOP-CRUB	Illuminance	Fc	0.63	1.6	0.0	N.A.	N.A.	N.A.
MERINO STREET	Illuminance	Fc	0.26	1.3	0.0	N.A.	N.A.	0
PLAYGROUND	Illuminance	Fc	1.55	10.2	0.0	N.A.	N.A.	0
PROPERTY BOUNDARY	Illuminance	Fc	1.10	8.2	0.0	N.A.	N.A.	N.A.
SIDEWALK NORTH	Illuminance	Fc	4.68	11.0	1.8	2.60	6.11	0
SIDEWALK SOUTHEAST	Illuminance	Fc	5.04	13.8	0.3	16.80	46.00	0

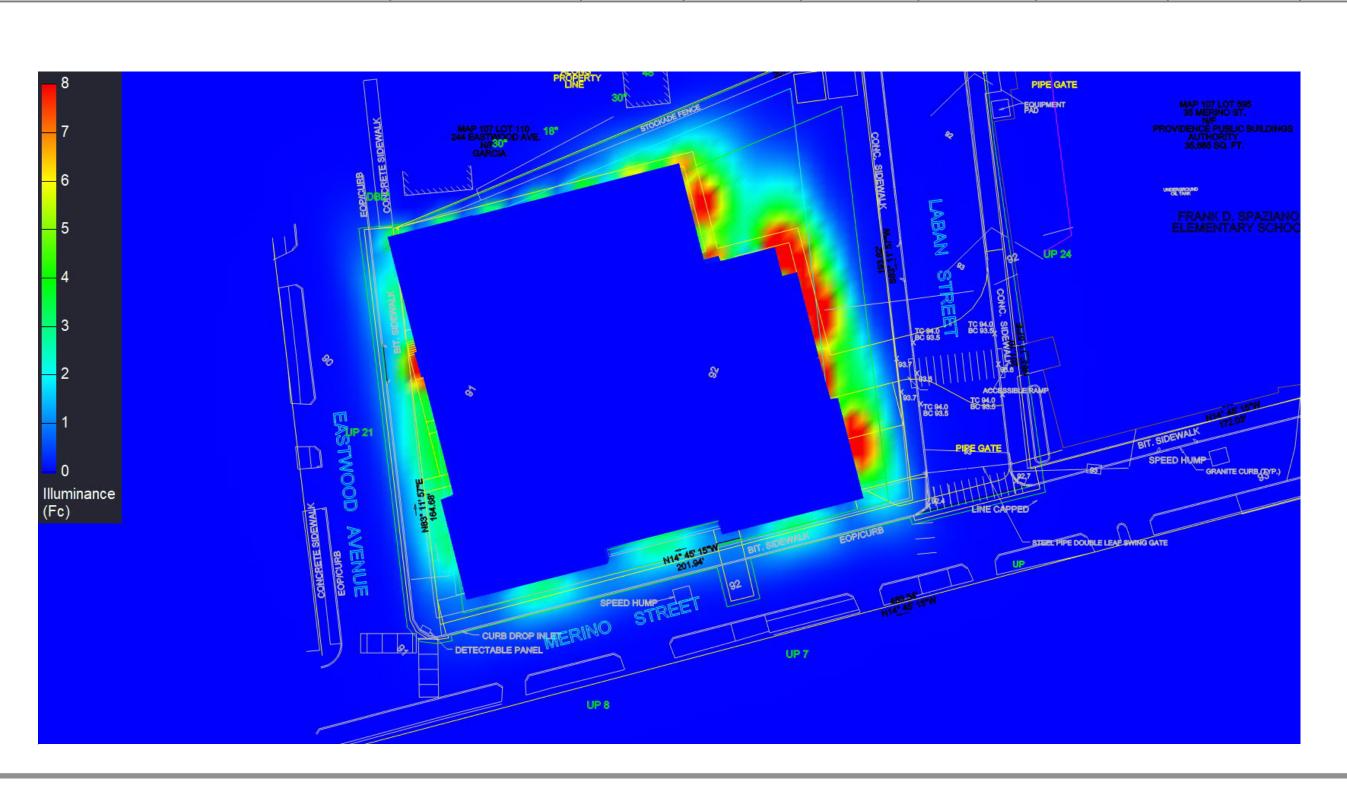


Date: 2/12/2024

Drawn By: SBM

Revision #: 0

Page 1 of 4

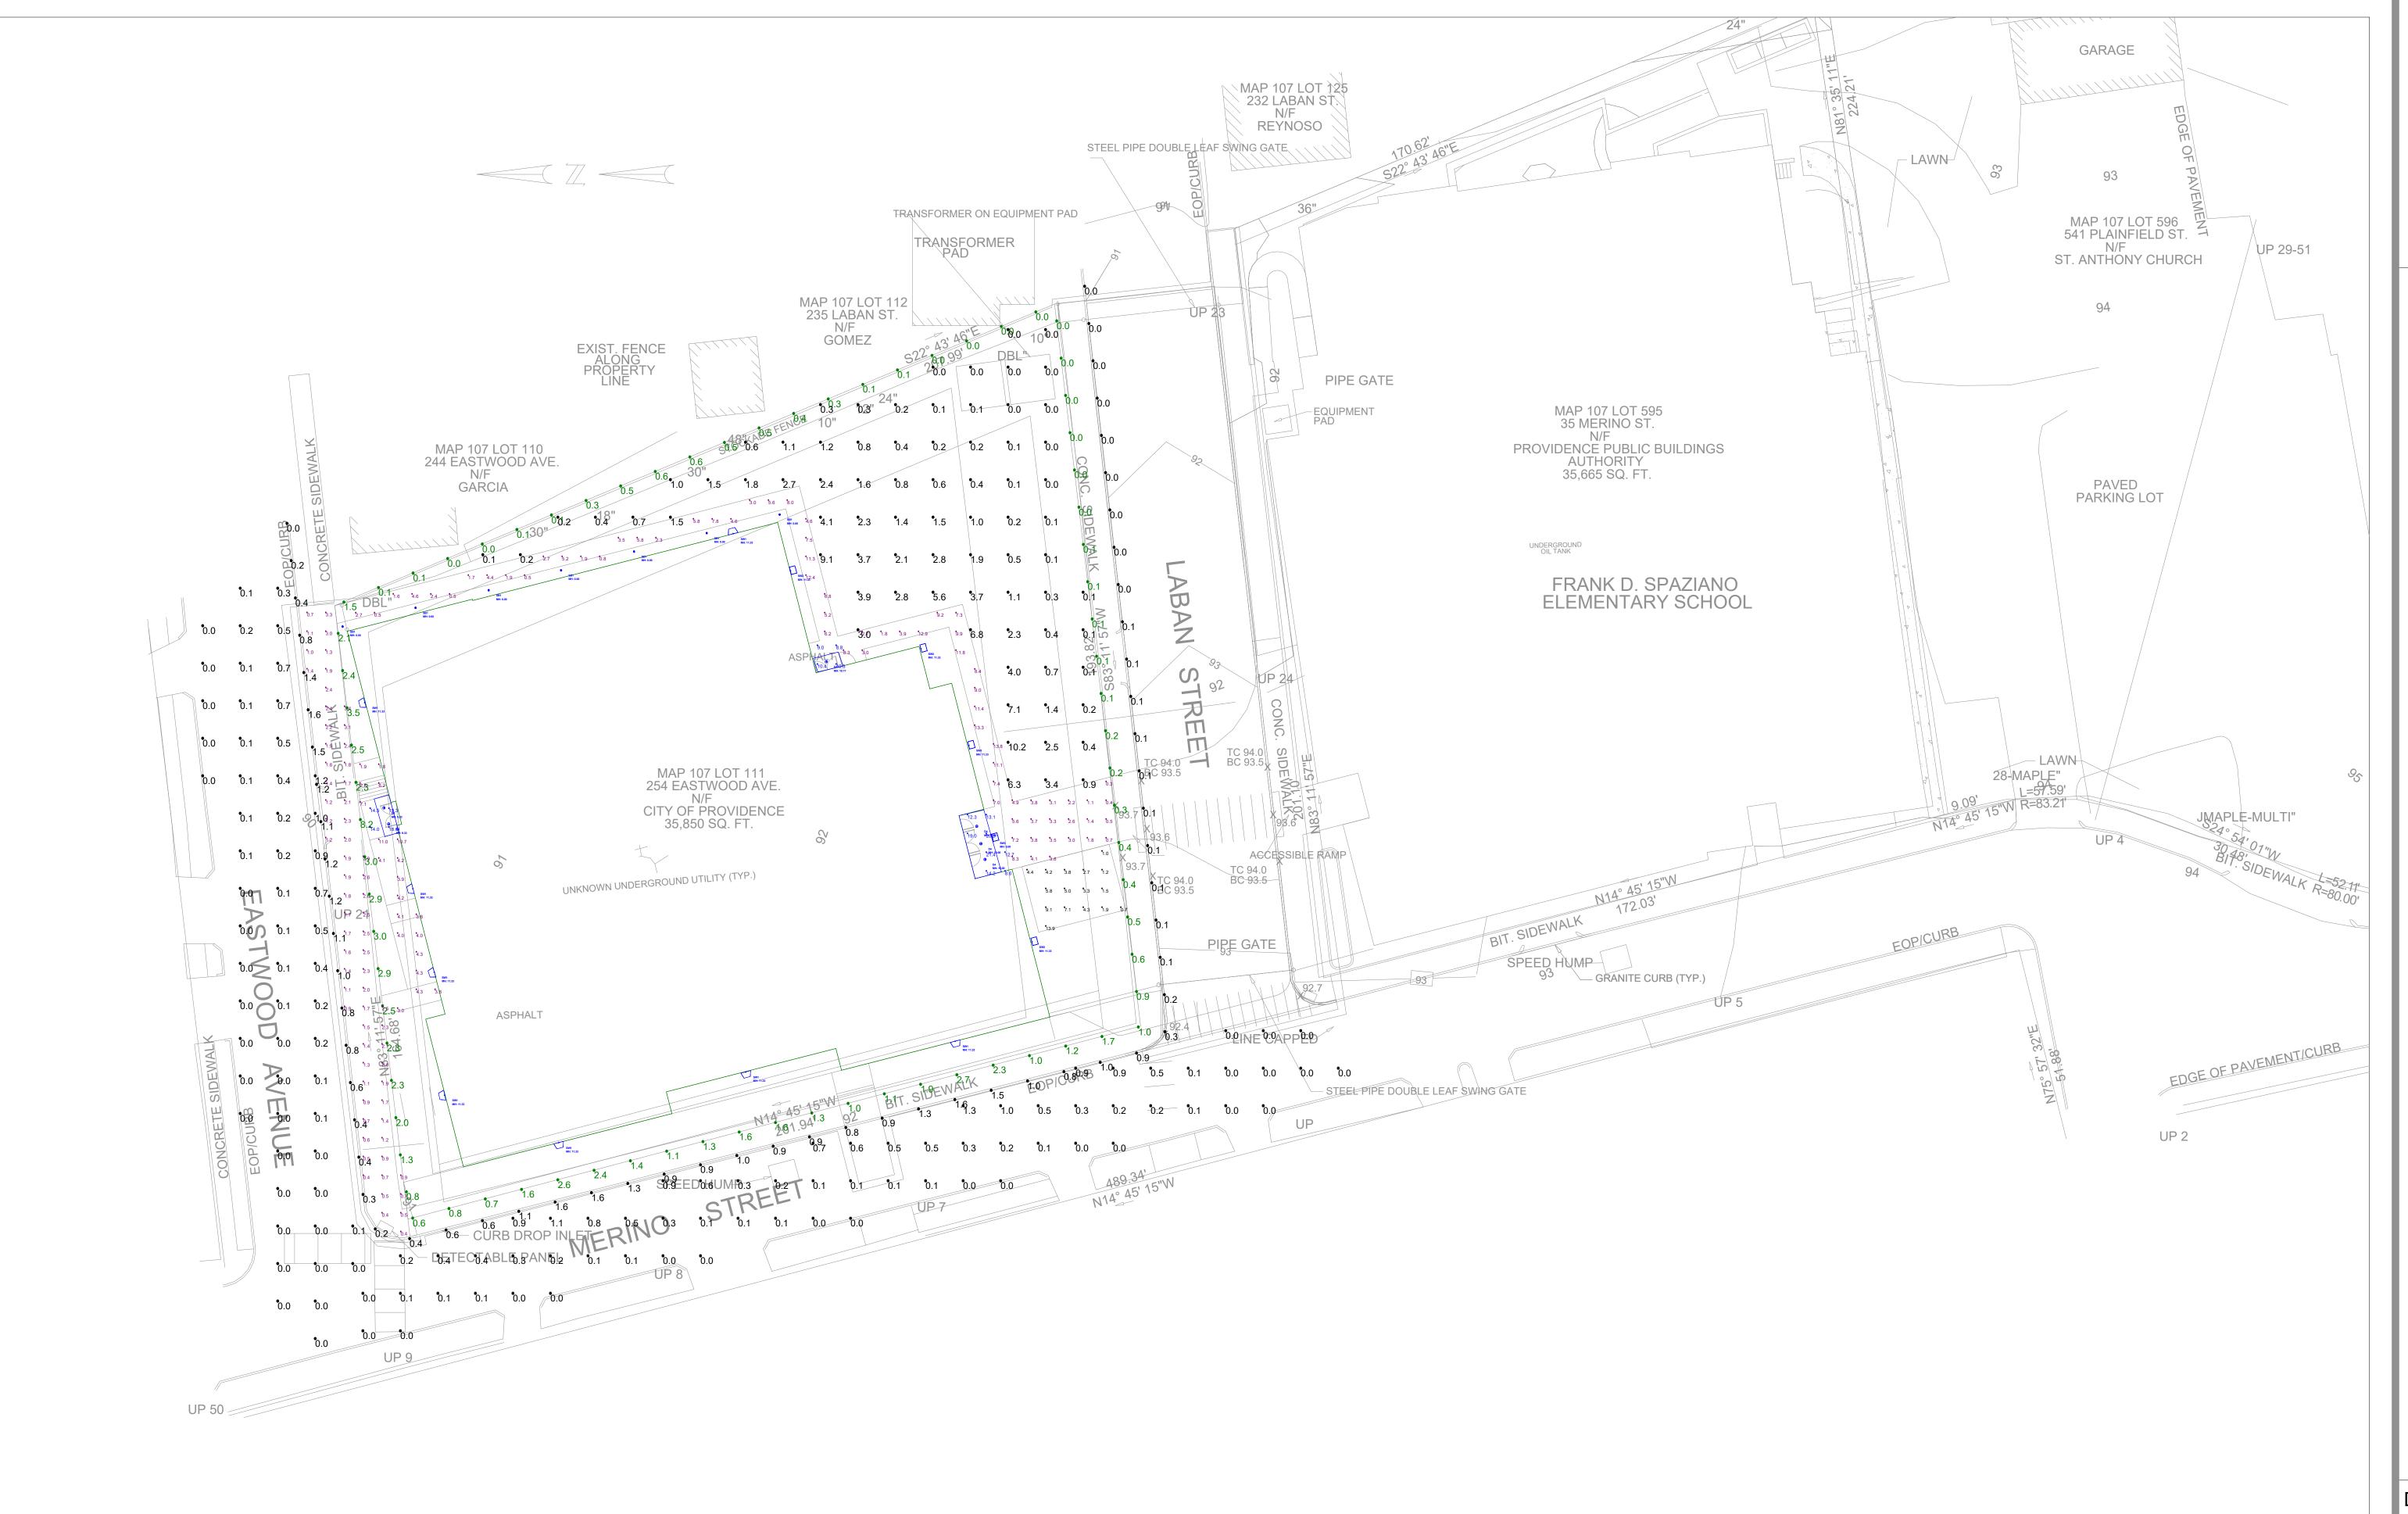

Scale: 1 inch= 20 Ft.

Date: 2/12/2024

Drawn By: SBM

Revision #: 0


Page 2 of 4

Scale: 1 inch= 10 Ft.


Date: 2/12/2024

Drawn By: SBM Revision #: 0

Page 3 of 4

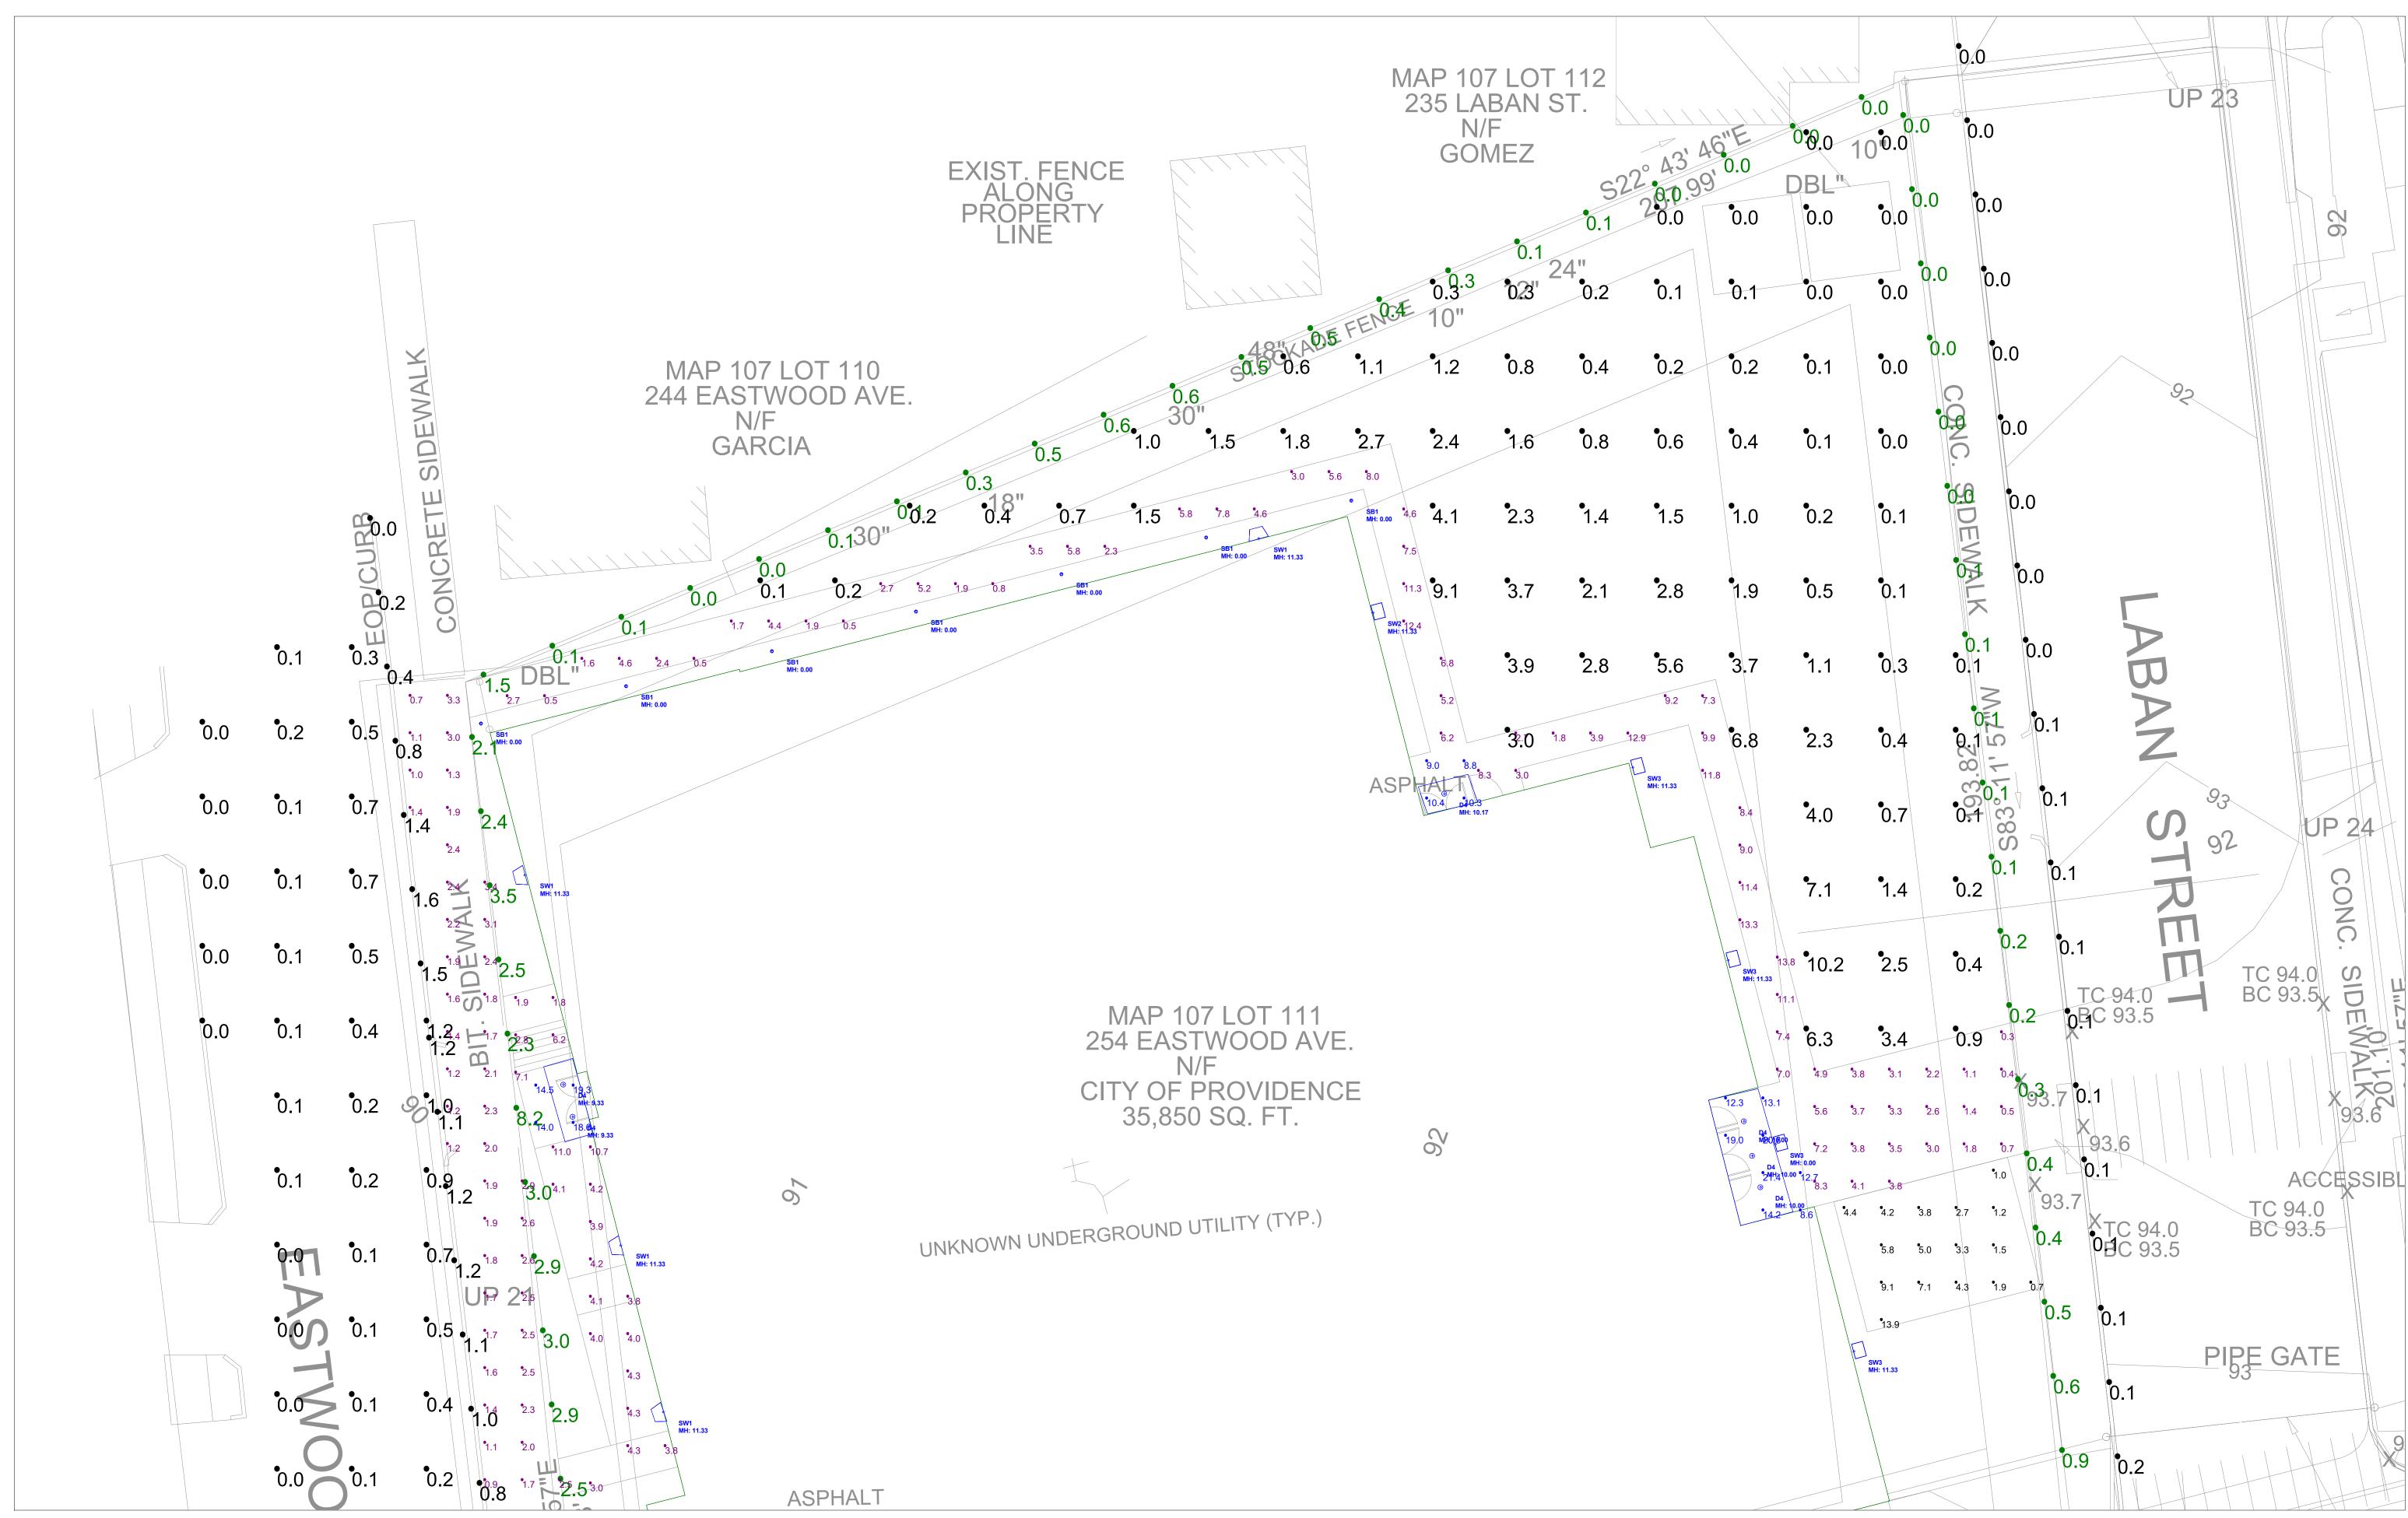

Layout West:

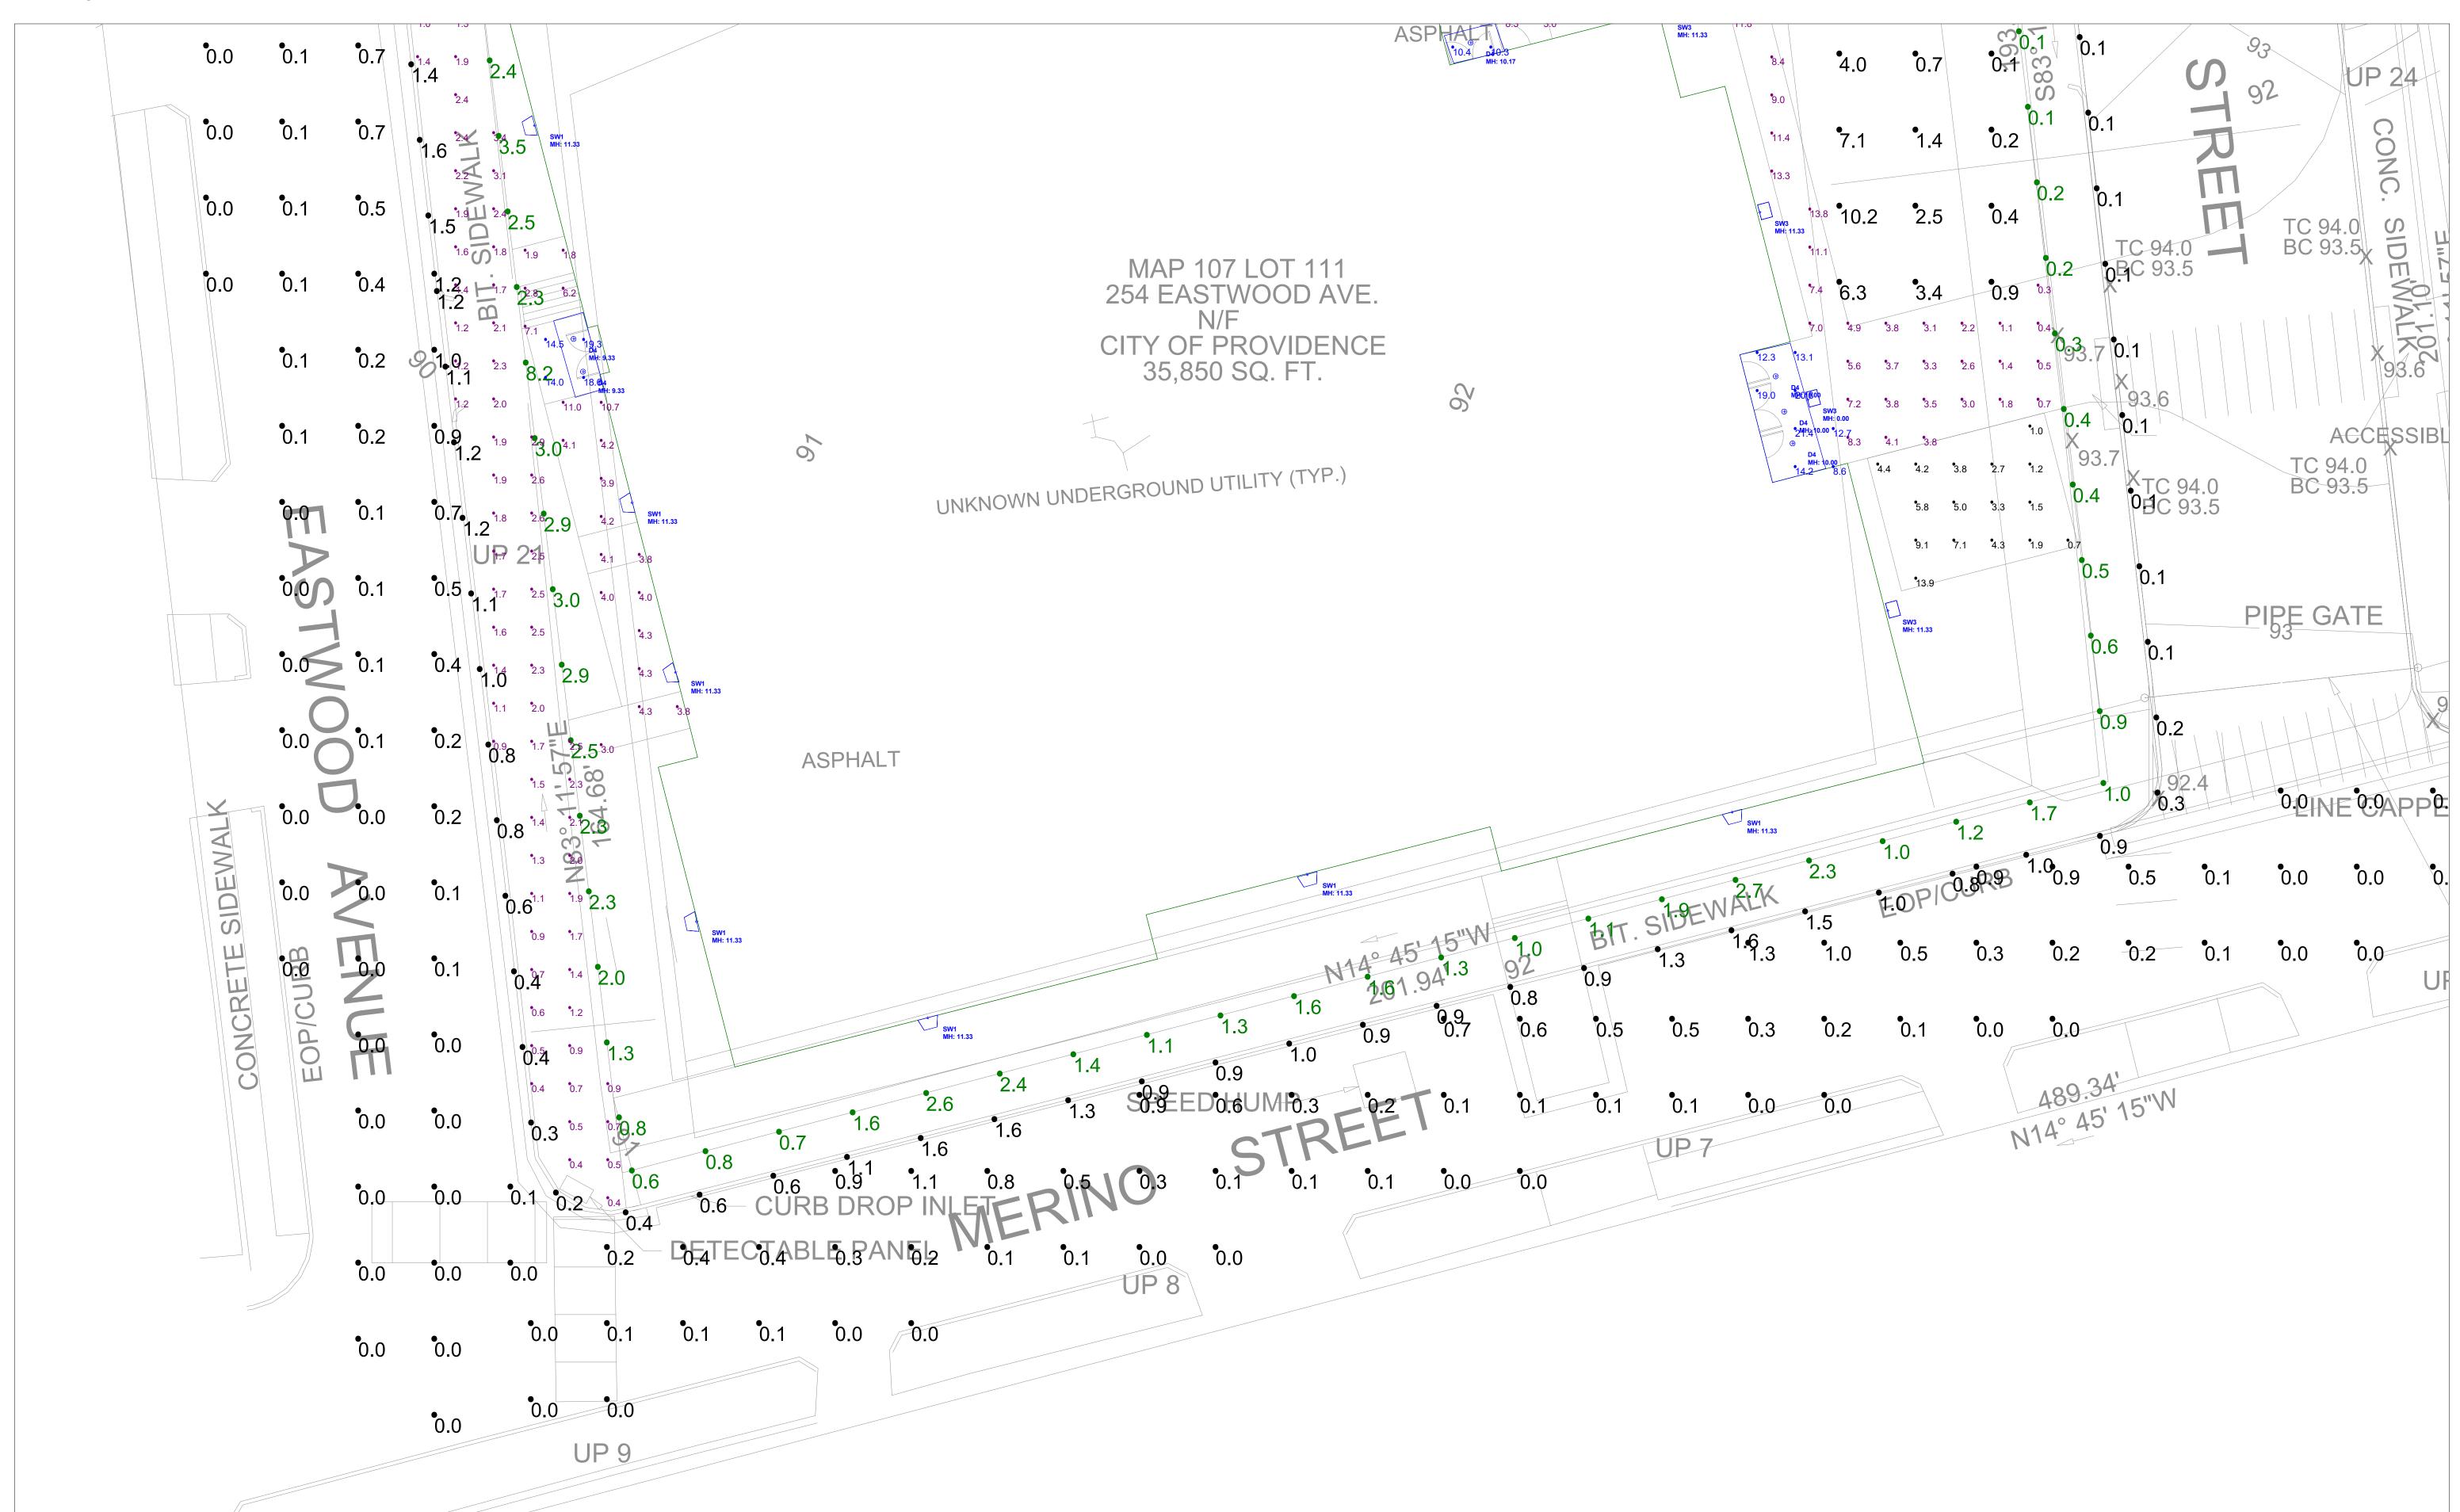


Scale: 1 inch= 10 Ft.

Date: 2/12/2024

Drawn By: SBM

Revision #: 0

Page 4 of 4

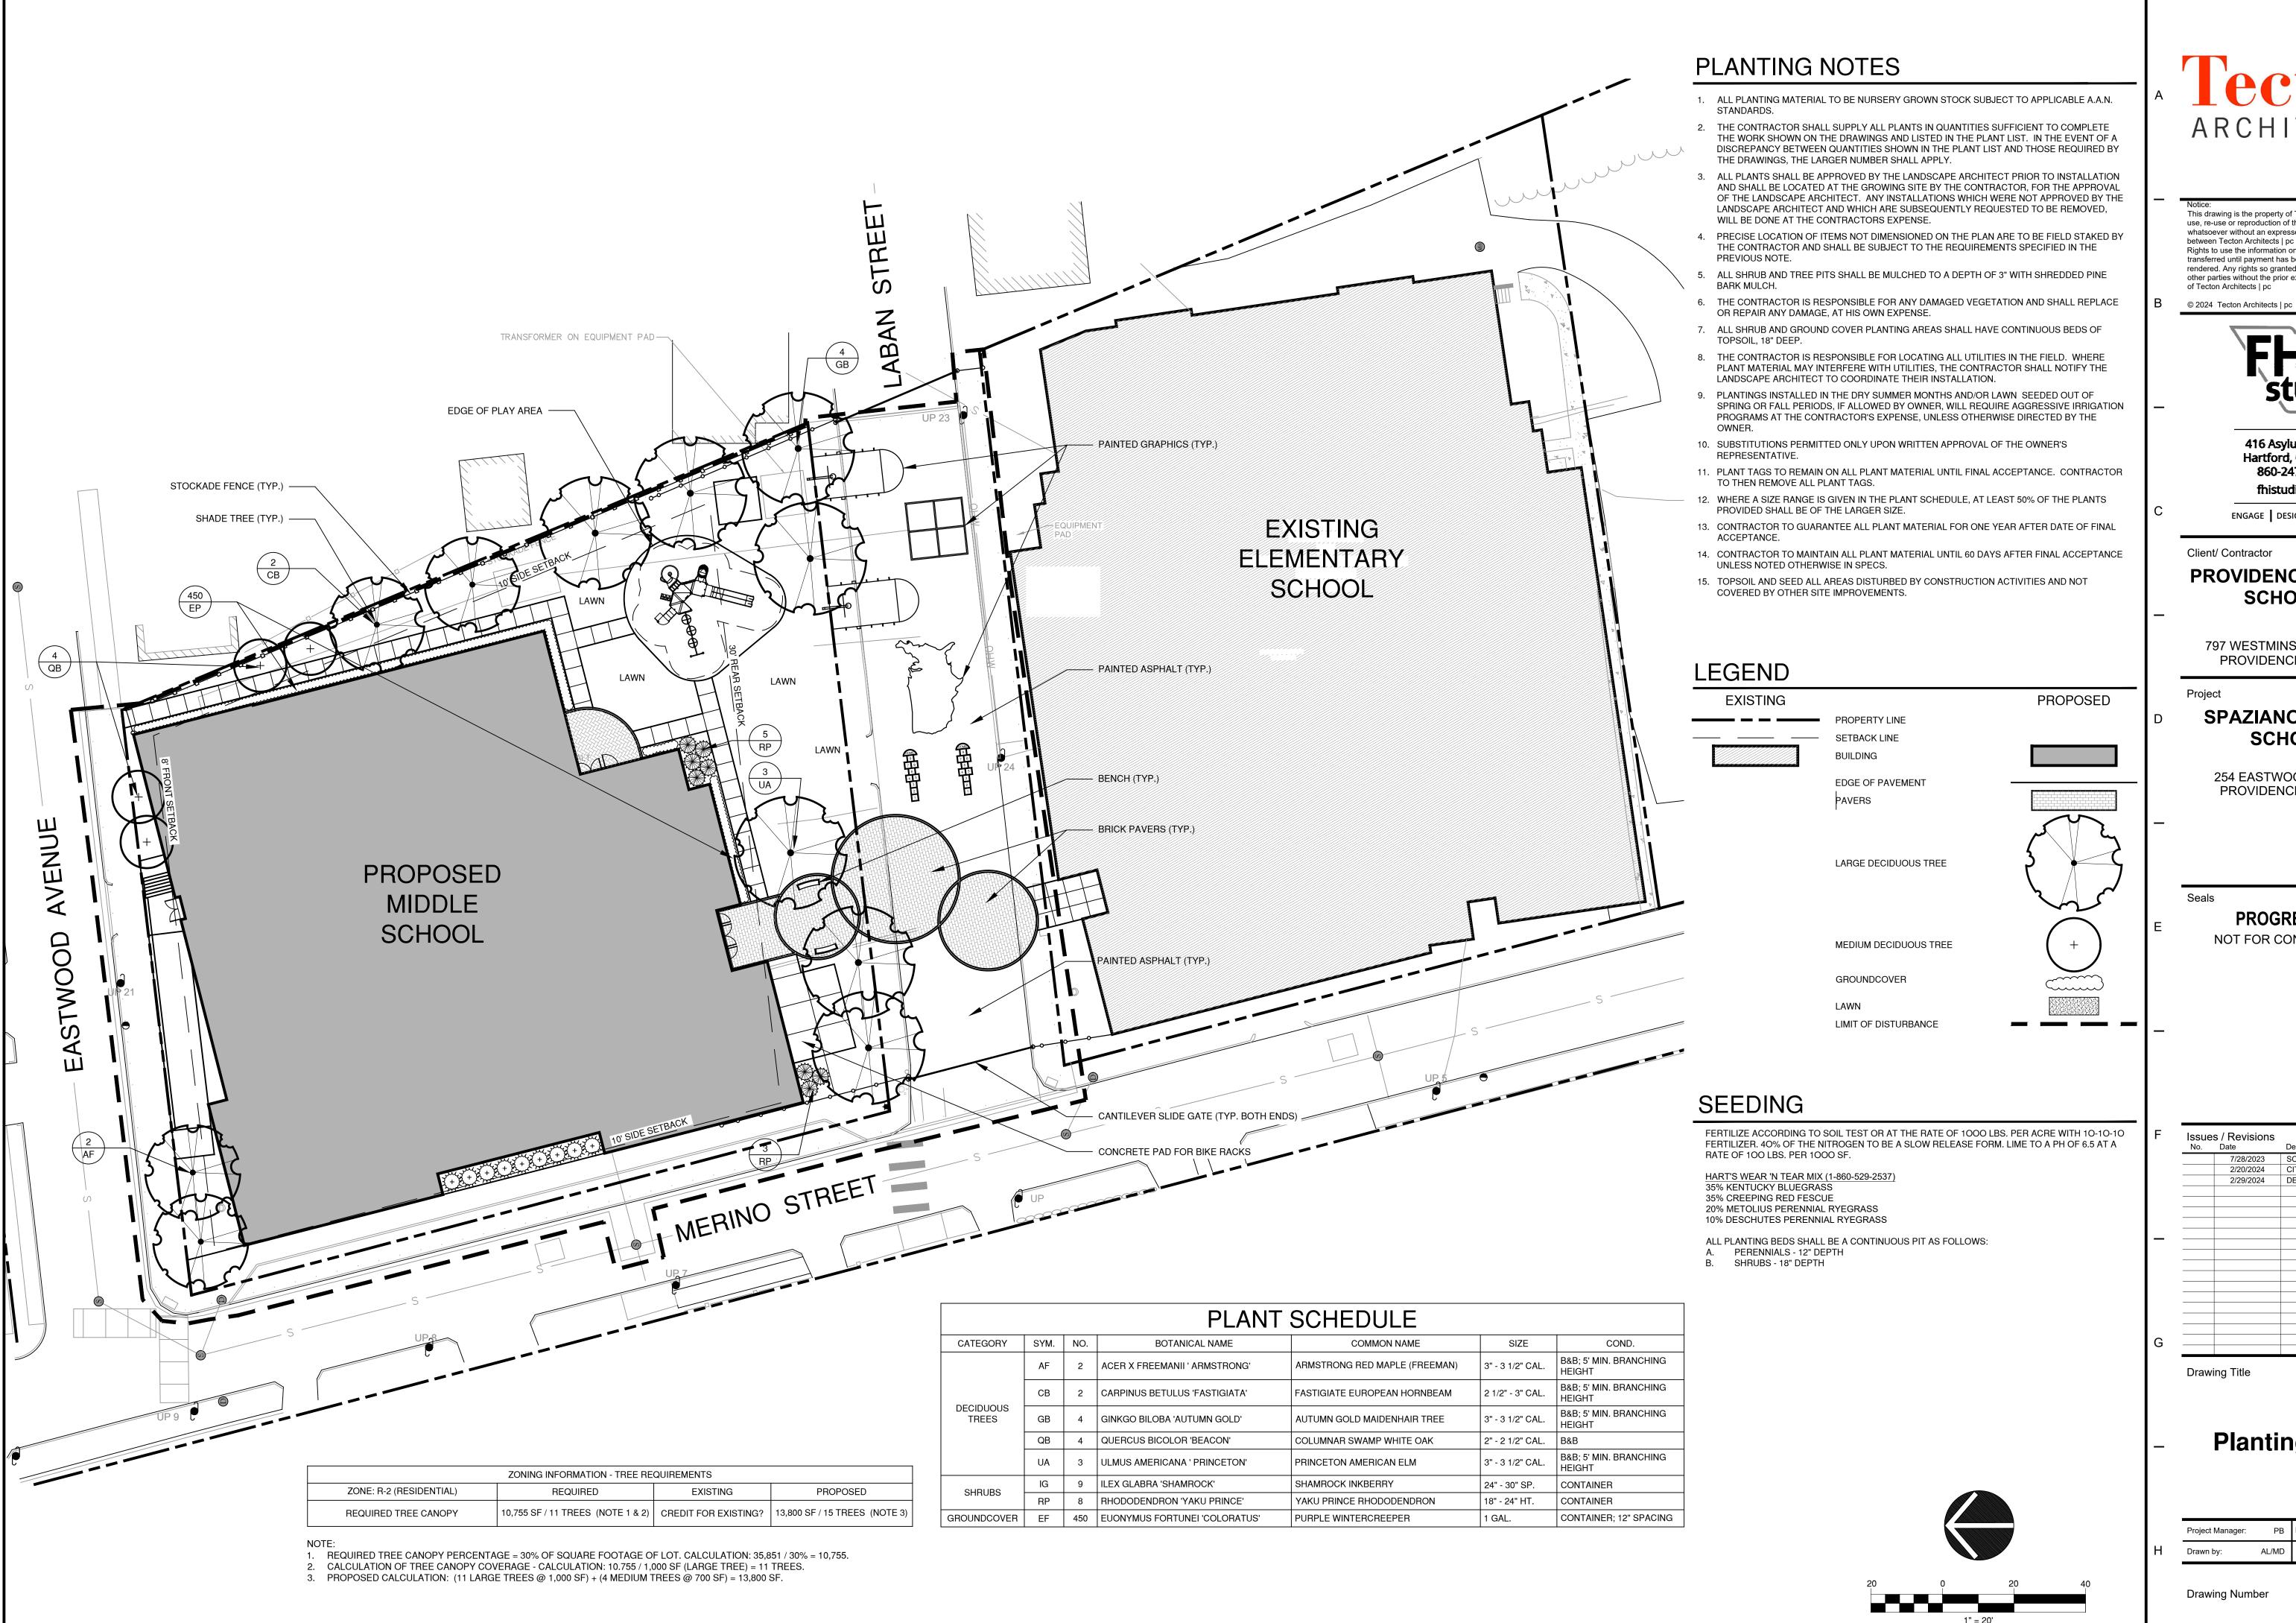

ARCHITECTS

This drawing is the property of Tecton Architects | pc. The use, re-use or reproduction of this drawing for any purpose whatsoever without an expressed written agreement between Tecton Architects | pc and the user is prohibited. Rights to use the information on this sheet are not transferred until payment has been received for services rendered. Any rights so granted are non-transferable to other parties without the prior expressed written consent of Tecton Architects | pc



416 Asylum Street Hartford, CT 06103 860-247-7200 fhistudio.com

ENGAGE DESIGN ADVANCE

Client/ Contractor

PROVIDENCE PUBLIC **SCHOOLS**

797 WESTMINSTER STREET PROVIDENCE, RI 02903

SPAZIANO MIDDLE SCHOOL

254 EASTWOOD AVENUE PROVIDENCE, RI 02909

PROGRESS SET NOT FOR CONSTRUCTION

F	Issue No.	s / Revisions Date	Description
		7/28/2023	SCHEMATIC DESIGN
		2/20/2024	CITY OF PROV MASTER PLAN
		2/29/2024	DESIGN DEVELOPMENT
l —			

Drawing Title

Planting Plan

Project Manager:	РВ	Project No:	41037 (P2057)
Drawn by:	AL/MD	Scale:	AS NOTED