

REFERENCE

- 1. PROJECT LOCATION: PROVIDENCE DPW, 40 EARNEST STREET, PROVIDENCE, RI 02905. ASSESSOR'S MAP 101 LOT 796 AND MAP 56 LOT 70.
- 2. EXISTING CONDITIONS MAPPING TAKEN FROM PLAN ENTITLED "EXISTING CONDITIONS SURVEY MAP PREPARED FOR ROWSE ARCHITECTS ASSESSORS PLAT 56 LOT 70 and ASSESSORS PLAT 101 LOTS 30, 31, 497, 773, 775, 777, 778, 779, 796, 797 and PART OF 764 700 & 780 ALLENS AVENUE, 5 & 40 60 ERNEST STREET, SHIPYARD STREET, and 54 & 58, 75, 82 CHAPMAN STREET PROVIDENCE, RHODE ISLAND" PREPARED BY CAPUTO AND WICK, DATED 3/15/2024.

GENERAL NOTES

- 1. PER AVAILABLE RIDEM MAPPING, THE PROJECT SITE IS LOCATED OUTSIDE OF A NATURAL HERITAGE AREA.
- 2. THE STATE OF RHODE ISLAND STANDARD SPECIFICATIONS FOR ROAD AND BRIDGE CONSTRUCTION, AMENDED FEBRUARY 2024 WITH ALL REVISIONS AND ADDENDA, AND THE RHODE ISLAND STANDARD DETAILS ARE MADE A PART HEREOF AS FULLY AND COMPLETELY AS IF ATTACHED HERETO. ALL WORK SHALL MEET OR EXCEED THE RHODE ISLAND STANDARD SPECIFICATIONS FOR ROAD AND BRIDGE CONSTRUCTION, WITH LATEST REVISIONS. THE LATEST REVISION OF THE STANDARD SPECIFICATIONS MAY BE OBTAINED AT THE RHODE ISLAND DEPARTMENT OF TRANSPORTATION.
- 3. THE CONTRACTOR SHALL MAKE ALL NECESSARY CONSTRUCTION NOTIFICATIONS AND APPLY FOR AND OBTAIN ALL NECESSARY CONSTRUCTION PERMITS, PAY ALL FEES AND POST ALL BONDS ASSOCIATED WITH THE SAME, AND COORDINATE WITH THE ENGINEER AND OWNER'S REPRESENTATIVE AS REQUIRED.
- 4. THE CONTRACTOR SHALL BE SOLELY RESPONSIBLE FOR JOB SITE SAFETY. THE CONTRACTOR SHALL PROVIDE TEMPORARY FENCING AND/OR BARRIERS AROUND ALL OPEN EXCAVATED AREAS IN ACCORDANCE WITH OSHA FEDERAL, STATE, AND LOCAL REQUIREMENTS.
- 5. THE CONTRACTOR SHALL BE RESPONSIBLE FOR VERIFYING THAT THE PROPOSED IMPROVEMENTS SHOWN ON THE PLANS DO NOT CONFLICT WITH ANY KNOWN EXISTING OR OTHER PROPOSED IMPROVEMENTS. IF ANY CONFLICTS ARE DISCOVERED, THE CONTRACTOR SHALL NOTIFY THE OWNER AND THE ENGINEER PRIOR TO INSTALLATION OF ANY PORTION OF THE SITE WORK WHICH WOULD BE AFFECTED. NO FIELD ADJUSTMENTS IN THE LOCATION OF SITE ELEMENTS SHALL BE MADE WITHOUT THE ENGINEER'S APPROVAL.
- 6. IF ANY DEVIATION OR ALTERATION OF THE WORK PROPOSED ON THESE DRAWINGS IS REQUIRED, THE CONTRACTOR SHALL IMMEDIATELY CONTACT AND COORDINATE ANY DEVIATIONS WITH THE ENGINEER AND OWNER.
- 7. ANY AREA OUTSIDE OF THE LIMIT OF WORK THAT IS DISTURBED SHALL BE RESTORED TO ITS ORIGINAL CONDITION AT NO ADDITIONAL COST TO THE OWNER.
- 8. ALL SITE WORK SHALL MEET OR EXCEED THE SITE WORK SPECIFICATIONS PREPARED FOR THIS PROJECT.
- 9. ALL SIGNS SHALL BE REFLECTORIZED TYPE III SHEETING AND CONFORM WITH THE MANUAL OF UNIFORM TRAFFIC CONTROL DEVICES (MUTCD), LATEST REVISION.
- 10. ALL UTILITIES (LOCATION AND ELEVATION) DEPICTED SHALL BE CONSIDERED APPROXIMATE ONLY. BEFORE COMMENCING SITE WORK IN ANY AREA, CONTACT "DIG SAFE" AT 1-888-DIG-SAFE (1-888-344-7233) TO ACCURATELY LOCATE UNDERGROUND UTILITIES. ANY DAMAGE TO EXISTING UTILITIES OR STRUCTURES AND THE COST TO REPAIR THE DAMAGES TO INITIAL CONDITIONS, AS DEPICTED ON THE PLANS, SHALL BE THE CONTRACTOR'S RESPONSIBILITY.
- 11. NO EXCAVATION SHALL BE DONE UNTIL UTILITY COMPANIES ARE PROPERLY NOTIFIED IN ADVANCE. NOTE THAT NOT ALL EXISTING UNDERGROUND UTILITIES ARE SHOWN. IT IS THE CONTRACTOR'S RESPONSIBILITY TO CONTACT ALL RESPECTIVE UTILITY COMPANIES TO VERIFY AND LOCATE EXISTING UTILITIES.

LAYOUT NOTES

- 1. ALL LINES ARE PERPENDICULAR OR PARALLEL TO THE LINES FROM WHICH THEY ARE MEASURED UNLESS OTHERWISE INDICATED.
- 2. ACCESSIBLE RAMPS SHALL BE FURNISHED AND INSTALLED IN ACCORDANCE WITH THE AMERICANS WITH DISABILITIES ACT (ADA) ACCESSIBILITY STANDARDS.
- 3. PRIOR TO COMMENCING WORK, THE CONTRACTOR SHALL PERFORM BENCHMARK FIELD LEVEL VERIFICATION AND COORDINATE LAYOUT CHECK. THE CONTRACTOR SHALL CONTACT PARE CORPORATION IF ANY DISCREPANCIES ARE FOUND.
- 4. DIMENSIONS OF PARKING SPACES AND DRIVEWAYS ARE FROM FACE OF CURB TO FACE OF CURB. DIMENSIONS FROM BUILDING ARE FROM FACE OF BUILDING TO FACE OF CURB.
- 5. ALIGN WALKWAYS ON DOORWAYS THEY SERVE TO PROVIDE MINIMUM REQUIRED MANEUVERING CLEARANCE IN ACCORDANCE WITH THE AMERICAN WITH DISABILITIES ACT (ADA) ACCESSIBILITY GUIDELINES.

DEMOLITION NOTES

- 1. THE CONTRACTOR SHALL COORDINATE ALL DEMOLITION OF STRUCTURES, PAVEMENT AND CONCRETE MATERIALS, AND UTILITIES WITH APPROPRIATE PROPOSED SITE GENERAL, GRADING, UTILITY, AND LANDSCAPING DRAWINGS.
- 2. ALL NOTED UTILITIES TO BE REMOVED AND DISPOSED OF, RELOCATED OR CAPPED REPRESENT ALL KNOWN SITE CONDITIONS TO BE DEMOLISHED. THE CONTRACTOR SHALL COORDINATE ALL UNFORESEEN CONDITIONS WITH THE PROJECT ENGINEER, OWNER AND/OR RESPECTIVE UTILITY COMPANIES PRIOR TO PROCEEDING WITH WORK.
- 3. WATER, SEWER, DRAINAGE, GAS, AND OTHER SITE UTILITIES SERVICING THE EXISTING FACILITIES ARE TO REMAIN ACTIVE THROUGHOUT CONSTRUCTION.
 THERE SHALL BE NO INTERRUPTION OF UTILITY SERVICES DURING THE CONSTRUCTION OPERATION WITHOUT APPROVAL FROM THE OWNER.

GRADING AND UTILITY NOTES

- 1. UNDERGROUND UTILITIES DEPICTED WERE COMPILED FROM AVAILABLE RECORD PLANS AND SHALL BE CONSIDERED APPROXIMATE ONLY. BEFORE COMMENCING SITE WORK IN ANY AREA, CONTACT "DIG SAFE" AT 1-888-DIG-SAFE (1-888-344-7233) TO ACCURATELY LOCATE UNDERGROUND UTILITIES. ANY DAMAGE TO EXISTING UTILITIES OR STRUCTURES DEPICTED OR NOT DEPICTED ON THE PLANS SHALL BE THE CONTRACTOR'S RESPONSIBILITY. NO EXCAVATION SHALL BE DONE UNTIL UTILITY COMPANIES ARE PROPERLY
- 2. ALL WORK PERFORMED AND ALL MATERIALS FURNISHED SHALL CONFORM WITH THE LINES AND GRADES ON THE PLANS AND SITE WORK SPECIFICATIONS.
- 3. AT ALL LOCATIONS WHERE EXISTING CURBING OR PAVEMENT ABUT NEW CONSTRUCTION, THE EDGE OF THE EXISTING CURB OR PAVEMENT SHALL BE SAWCUT TO A CLEAN, SMOOTH EDGE. BLEND NEW PAVEMENT AND CURBS SMOOTHLY INTO EXISTING BY MATCHING LINES, GRADES AND JOINTS.
- 4. ALL UTILITY COVERS, GRATES, ETC. SHALL BE ADJUSTED TO BE FLUSH WITH THE SURROUNDING SURFACE OR PAVEMENT FINISH GRADE. RIM ELEVATIONS OF STRUCTURES AND MANHOLES ARE APPROXIMATE. FINAL ELEVATIONS ARE TO BE SET FLUSH AND CONSISTENT WITH THE GRADING PLANS.
- 5. THE CONTRACTOR SHALL MAKE ALL ARRANGEMENTS FOR THE ALTERATION OF PRIVATE UTILITIES BY THE UTILITY COMPANIES, AS REQUIRED.
- 6. WHERE AN EXISTING UTILITY IS FOUND TO CONFLICT WITH THE PROPOSED WORK, THE LOCATION, ELEVATION AND SIZE OF THE UTILITY SHALL BE ACCURATELY DETERMINED WITHOUT DELAY BY THE CONTRACTOR AND THE INFORMATION SHALL BE PROVIDED ON A SKETCH TO SCALE OF THE EXISTING UTILITY WITH TIES TO KNOWN POINTS, PHOTOS AND FURNISHED TO THE ENGINEER FOR RESOLUTION.
- 7. THE CONTRACTOR SHALL PROTECT ALL UNDERGROUND DRAINAGE, SEWER AND UTILITY FACILITIES FROM EXCESSIVE VEHICULAR LOADS DURING CONSTRUCTION. ANY DAMAGE TO THESE FACILITIES RESULTING FROM CONSTRUCTION LOADS SHALL BE RESTORED TO ORIGINAL CONDITION AT NO ADDITIONAL COST TO THE OWNER.
- 8. GAS, ELECTRIC, AND COMMUNICATIONS ROUTING ARE SUBJECT TO REVIEW AND APPROVAL BY APPROPRIATE UTILITY COMPANIES.
- 9. DURING CONSTRUCTION OPERATIONS, THE CONTRACTOR SHALL PROTECT EXISTING UTILITIES BY PROVIDING TEMPORARY SUPPORTS OR SHEETING AS REQUIRED AT NO ADDITIONAL COST TO THE OWNER.
- 10. ALL GRAVITY SANITARY PIPING SHALL BE SDR-35 PVC. ALL SEWER CONSTRUCTION SHALL CONFORM TO THE PROVIDENCE SEWER/NARRAGANSETT BAY COMMISSION JURISDICTION REGULATIONS.
- 11. ALL WATER LINE BENDS AND TEES SHALL BE REINFORCED WITH THRUST BLOCKS. ALL WATER DISTRIBUTION PIPING AND FITTINGS MUST ADHERE TO THE PROVIDENCE WATER SPECIFICATIONS AND SHALL BE INSPECTED BEFORE, DURING, AND AFTER CONSTRUCTION PRIOR TO TAPPING THE SERVICE MAIN. THE CONTRACTOR SHALL COORDINATE AND CONFIRM ALL WATER DISTRIBUTION MATERIAL PRODUCTS WITH THE PROVIDENCE WATER PRIOR TO ORDERING OR PURCHASING PRODUCTS.
- 12. EXCAVATION REQUIRED WITHIN THE PROXIMITY OF EXISTING UTILITY LINES SHALL BE DONE BY HAND. CONTRACTOR SHALL REPAIR ANY DAMAGE TO EXISTING UTILITY LINES OR STRUCTURES INCURRED DURING CONSTRUCTION OPERATIONS AT NO ADDITIONAL COST TO THE OWNER.
- 13. PITCH EVENLY BETWEEN SPOT GRADES. ALL PAVED AREAS MUST PITCH TO DRAIN AT A MIN. OF 1/8" PER FOOT UNLESS SPECIFIED OTHERWISE.
- 14. THE PROPOSED WALKWAYS SHALL HAVE A MAXIMUM CROSS SLOPE OF 2% AND A MAXIMUM RUNNING SLOPE OF 5% AS SHOWN ON CONSTRUCTION DETAILS AND GRADING PLAN.

EROSION AND SEDIMENTATION CONTROL NOTES - RHODE ISLAND

- 1. THE CONTRACTOR AND RELEVANT SUBCONTRACTORS SHALL READ AND UNDERSTAND THE RIPDES GENERAL PERMIT FOR STORMWATER DISCHARGES ASSOCIATED WITH CONSTRUCTION ACTIVITY (GENERAL PERMIT) AND THE SITE SPECIFIC SOIL EROSION AND SEDIMENT CONTROL PLAN (SESC) PREPARED FOR THE PROJECT. ALL EROSION CONTROLS SHALL BE IN ACCORDANCE WITH THE RHODE ISLAND SOIL EROSION AND SEDIMENT CONTROL HANDBOOK, LATEST REVISION.
- 2. THE CONTRACTOR SHALL BECOME FAMILIAR WITH THE CONDITIONS ISSUED FOR THE PROJECT BY RIDEM AND BE RESPONSIBLE FOR CONFORMANCE WITH ALL PERMIT REQUIREMENTS AND CONSTRUCTION DOCUMENTS.
- 3. THE CONTRACTOR SHALL BE RESPONSIBLE FOR ESTABLISHING OR INSTALLING ALL TEMPORARY SEDIMENT AND EROSION CONTROLS AS SHOWN ON THESE PLANS AND SHALL MAINTAIN ALL EROSION CONTROL MEASURES AS NECESSARY DURING THE ENTIRE CONSTRUCTION PERIOD.
- 4. ANTI-TRACKING PADS (R.I. STD. DETAIL 9.9.0) SHALL BE PROVIDED AT ALL POINTS OF VEHICULAR INGRESS AND EGRESS ON THE CONSTRUCTION SITE AND SHALL BE MAINTAINED TO LIMIT TRACKING OR FLOWING OF SEDIMENT ONTO PUBLIC ROADS.
- 5. EROSION CONTROL BARRIERS SHALL BE INSTALLED AS SHOWN ON THE EROSION CONTROL PLAN PRIOR TO COMMENCEMENT OF CONSTRUCTION OPERATIONS.
- 6. SOIL EROSION AND SEDIMENTATION CONTROL MEASURES SHALL BE INSPECTED AND MAINTAINED ON A WEEKLY BASIS AND AFTER EACH STORM EVENT OF 0.25 INCH OR GREATER DURING CONSTRUCTION TO ENSURE THAT CHANNELS, DITCHES AND PIPES ARE CLEAR OF DEBRIS AND THAT THE EROSION CONTROL BARRIERS ARE INTACT. IDENTIFIED DEFICIENCIES SHALL BE CORRECTED IMMEDIATELY.
- 7. DUST SHALL BE CONTROLLED BY WATERING OR OTHER APPROVED METHODS AS NECESSARY, OR AS DIRECTED BY THE OWNER OR OWNER'S REPRESENTATIVE.
- 8. THE CONTRACTOR SHALL CLEAN AND MAINTAIN EROSION CONTROL BARRIER WHEN SEDIMENT ACCUMULATES TO ONE HALF THE HEIGHT OF THE BARRIER. MATERIAL COLLECTED FROM THE SEDIMENTATION BARRIERS SHALL BE REMOVED AS NECESSARY AND DISPOSED IN AN UPLAND AREA.
- 9. THE CONTRACTOR SHALL SCHEDULE HIS WORK TO ALLOW THE FINISHED SUBGRADE ELEVATIONS TO DRAIN PROPERLY WITHOUT PONDING. SPECIFICALLY, ALLOW WATER TO ESCAPE WHERE PROPOSED CURB MAY RETAIN RUNOFF PRIOR TO APPLICATION OF SURFACE PAVING. PROVIDE TEMPORARY POSITIVE DRAINAGE, AS REQUIRED, TO STABILIZED DISCHARGE POINTS.
- 10. INSTALLATION OF THE EROSION CONTROL BARRIERS AS ILLUSTRATED IS INTENDED TO REPRESENT THE MINIMUM SEDIMENTATION CONTROL FACILITIES NECESSARY TO MEET ANTICIPATED SITE CONDITIONS. ADDITIONAL EROSION CONTROL MEASURES SHALL BE IMPLEMENTED AS CONDITIONS WARRANT OR AS DIRECTED BY THE OWNER OR OWNER'S REPRESENTATIVE.
- 11. REQUIRED SEDIMENTATION CONTROL FACILITIES MUST BE PROPERLY ESTABLISHED, CLEARLY VISIBLE AND IN OPERATION PRIOR TO INITIATING ANY LAND CLEARING ACTIVITY AND/OR OTHER CONSTRUCTION RELATED WORK. SUCH FACILITIES SHALL REPRESENT THE LIMIT OF WORK. WORKERS SHALL BE INFORMED THAT NO CONSTRUCTION ACTIVITY IS TO OCCUR BEYOND THE LIMIT OF WORK AT ANY TIME THROUGHOUT THE CONSTRUCTION PERIOD.
- 12. THE CONTRACTOR SHALL MAINTAIN A SUFFICIENT RESERVE OF VARIOUS EROSION CONTROL MATERIALS ONSITE AT ALL TIMES FOR EMERGENCY PURPOSES OR ROUTINE MAINTENANCE.
- 13. EXISTING AND NEWLY INSTALLED CATCH BASINS AND STORM DRAIN INLETS SHALL BE PROTECTED WITH APPROPRIATE TEMPORARY INLET PROTECTION IN ACCORDANCE WITH THE RHODE ISLAND SOIL EROSION AND SEDIMENT CONTROL
- 14. DEWATERING WASTE WATERS PUMPED FROM EXCAVATIONS SHALL BE CONVEYED BY HOSE TO AN UPLAND AREA AND DISCHARGED INTO STRAW BALE CORRALS OR SEDIMENTATION BAGS.
- 15. THE CONTRACTOR SHALL NOT REMOVE ANY TEMPORARY SEDIMENT CONTROL BARRIERS UNTIL THE CONTRIBUTING DRAINAGE AREA HAS BEEN PERMANENTLY STABILIZED.
- 16. CONSTRUCTION SITE WASTE MATERIALS SHALL BE PROPERLY CONTAINED ONSITE AND DISPOSED OFF SITE AT A LOCATION IN ACCORDANCE WITH THE LOCAL AND STATE REGULATIONS.
- 17. RIP-RAP OR OTHER ENERGY DISSIPATERS SHALL BE USED WHERE NECESSARY TO PREVENT SCOUR.
- 18. ALL DISTURBED AREAS SHALL BE STABILIZED WITHIN 14 DAYS UPON COMPLETION OF WORK IN THAT AREA.
- 19. ALL DRAINAGE STRUCTURES SHALL BE CLEARED OF ACCUMULATED SEDIMENT PRIOR TO ACCEPTANCE OF FINAL PROJECT.
- 20. NEWLY VEGETATED AREAS SHALL BE MAINTAINED REGULARLY TO ENSURE STABLE VEGETATED SURFACES.
- 21. EROSION AND SEDIMENTATION CONTROLS SHALL BE UTILIZED AS SHOWN ON THE PLANS. POTENTIAL EROSION AND SEDIMENTATION PROBLEMS ASSOCIATED WITH THE CONSTRUCTION OF THE PROJECT SHALL BE AVOIDED THROUGH THE PROJECT SCHEDULING AND THE USE OF APPROPRIATE STANDARD CONTROLS (RHODE ISLAND SOIL EROSION AND SEDIMENTATION CONTROL HANDBOOK) AS ILLUSTRATED ON THE PROJECT PLANS.
- 22. WHERE EROSION CONTROLS ARE NEEDED ON IMPERVIOUS SURFACES, THE CONTRACTOR SHALL PROVIDE SAND BAG EROSION CONTROL BARRIER.
- 23. TEMPORARY DIVERSION (TD) MAY CONSIST OF A DITCH OR SWALE, OR MAY BE ACHIEVED USING WOOD CHIPS, COIR LOGS, OR SIMILAR MATERIALS
- 24. TEMPORARY SEDIMENT TRAPS (TST) AND TEMPORARY SWALES (TSW) SHALL BE SIZED BY THE CONTRACTOR USING THE PARAMETERS CONTAINED IN THE RHODE ISLAND SOIL EROSION AND SEDIMENT CONTROL HANDBOOK.

STORMWATER MANAGEMENT SYSTEM INSPECTION AND MAINTENANCE NOTES

- DURING CONSTRUCTION (CONTRACTOR'S RESPONSIBILITY)

 1. THE CONTRACTOR SHALL REMOVE SEDIMENT AND DEBRIS FROM ALL CATCH BASINS, MANHOLES, AND THE DRAINAGE SYSTEM ON A ROUTINE BASIS, IMMEDIATELY FOLLOWING SITE STABILIZATION, AND PRIOR TO PROJECT COMPLETION AND ACCEPTANCE.
- 2. THE CLOSED DRAINAGE SYSTEM AND ASSOCIATED STRUCTURES SHALL BE CLEANED AND FLUSHED BY THE CONTRACTOR AT THE COMPLETION OF CONSTRUCTION, AND THE CONTRACTOR SHALL BE RESPONSIBLE FOR INSPECTION AND MAINTENANCE OF THE DRAINAGE SYSTEM UNTIL ACCEPTANCE OF THE SYSTEM BY THE ENGINEER AND THE CITY OF PROVIDENCE. FOLLOWING ACCEPTANCE OF THE PROPOSED DRAINAGE SYSTEM, THE OWNER OF THE SITE SHALL BE RESPONSIBLE FOR THE LONG-TERM INSPECTION AND MAINTENANCE OF THE DRAINAGE SYSTEM.
- 3. ANY ACCUMULATION OF PONDING WATER IN AREAS WITHIN THE LIMITS OF DISTURBANCE, OTHER THAN DESIGNATED AREAS, SHALL BE REMOVED ACCORDINGLY AND PREVENTED IN THE FUTURE.

POST CONSTRUCTION (OWNER'S RESPONSIBILITY)

- TRASH, LITTER, SEDIMENT AND OTHER DEBRIS SHALL BE REMOVED FROM ANY STORMWATER MANAGEMENT SYSTEM FACILITY (INCLUDING BUT NOT LIMITED TO CATCH BASINS, MANHOLES, INLET, OUTLET AND DIVERSION STRUCTURES, AND STORMWATER BEST MANAGEMENT PRACTICES (BMPs)) A MINIMUM OF TWO TIMES PER YEAR, PREFERABLY IN THE SPRING AND FALL.
- THE PARKING LOT AND ENTRY DRIVE SHALL BE SWEPT BY THE OWNER AS EARLY AS POSSIBLE EVERY SPRING AND ONCE IN THE FALL TO REMOVE SEDIMENTS.
- 3. ALL CLEANING AND MAINTENANCE OF STORMWATER MANAGEMENT SYSTEMS POST-CONSTRUCTION SHALL BE THE RESPONSIBILITY OF THE OWNER.

CATCH BASINS WITH SUMPS INSPECTION, MAINTENANCE, AND REPAIR NOTES

- 1. INSPECTIONS SHALL BE PERFORMED A MINIMUM OF TWO TIMES PER YEAR (SPRING/FALL). UNITS SHALL BE CLEANED ANNUALLY AND WHENEVER THE DEPTH OF SEDIMENT IS GREATER THAN OR EQUAL TO HALF THE SUMP DEPTH.
- 2. THE INLET GRATE SHALL NOT BE WELDED TO THE FRAME OR PAVED OVER SO THAT THE SUMP CAN BE EASILY INSPECTED AND MAINTAINED.
- 3. CARE SHALL BE TAKEN TO AVOID DAMAGING AND DISPLACING HOODS PLACED ON HOODED OUTLETS DURING CLEANING.

UNDERGROUND INFILTRATION/DETENTION SYSTEM BASIN INSPECTION, MAINTENANCE, AND REPAIR NOTES


FOLLOWING CONSTRUCTION, THE COMPLETION OF THE INSPECTION AND MAINTENANCE REQUIREMENTS BELOW SHALL BE THE RESPONSIBILITY OF THE OWNER.

- 1. THE SYSTEM SHALL BE MAINTAINED AS RECOMMENDED BY THE MANUFACTURER.
- FOLLOWING STORM EVENTS WITH RAINFALL EXCEEDING 2.7"
 INSPECT INFILTRATION/DETENTION SYSTEM FOR TRASH, DEBRIS, SEDIMENT, EROSION, STANDING WATER, AND OVERALL PERFORMANCE. DEFECTS SHALL BE REPAIRED BY THE OWNER.
- BI-ANNUALLY
 INSPECTIONS SHALL BE PERFORMED A MINIMUM OF TWO TIMES PER YEAR ON THE INSPECTION PORTS AND DRAINAGE STRUCTURES OF THE UNDERGROUND INFILTRATION/DETENTION SYSTEM TO ENSURE PROPER

THROUGH THE PRETREATMENT ROW. THE JETVAC PROCESS SHALL ONLY BE PERFORMED ON THE PRETREATMENT

OPERATION OF THE SYSTEM.

4. JETVAC MAINTENANCE IS RECOMMENDED IF SEDIMENT HAS BEEN COLLECTED TO A DEPTH OF 3" IN THE PRETREATMENT ROW. MORE FREQUENT MAINTENANCE MAY BE REQUIRED TO MAINTAIN MINIMUM FLOW RATES

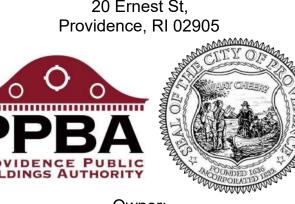

CITY OF

DEPT. OF PUBLIC

WORKS COMPLEX

Owner:
Providence Department of Public Works
20 Ernest Street
Providence, RI 02905



OWNERSHIP AND USE OF DOCUMENTS, DRAWINGS AND SPECIFICATIONS AS INSTRUMENTS OF PROFESSIONAL SERVICE, ARE, AND SHALL REMAIN, THE PROPERTY OF THE ARCHITECT. THESE DOCUMENTS ARE NOT TO BE USED, IN WHOLE OR IN PART, FOR ANY OTHER PROJECTS OR PURPOSES, OR BY ANY OTHER PARTIES THAN THOSE PROPERLY AUTHORIZED BY CONTRACT WITHOUT THE EXPRESS AUTHORIZATION OF THE ARCHITECT.




GENERAL NOTES

1. CONTRACTOR SHALL VISIT SITE, PRIOR TO BID, AND CAREFULLY INVESTIGATE AND EXAMINE THE AREA OF WORK SO AS TO SATISFY HIMSELF AS TO THE NATURE AND LOCATION OF THE WORK. CONTRACTOR TO NOTE THE CHARACTER, QUALITY, QUANTITIES OF MATERIALS REQUIRED AND DIFFICULTIES TO BE ENCOUNTERED, THE KIND AND EXTENT OF EQUIPMENT AND FACILITIES NEEDED FOR PERFORMANCE OF THE WORK AND OTHER ITEMS WHICH MAY, IN ANY WAY, AFFECT THE WORK OR CONTRACTOR'S

2. DRAWINGS DO NOT INCLUDE NECESSARY COMPONENTS FOR CONSTRUCTION SAFETY.

MAJOR LAND
DEVELOPMENT
APPLICATION
SUBMISSION

CONSTRUCTION

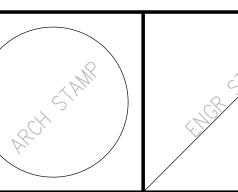

Date: 01-17-2025

Drawn by: Proj. Mgr.:

Revisions

No. Date Description

NOTES

C1 1

<u>LEGEND</u> EXIST (or EX) EXISTING RCP REINFORCED CONCRETE PIPE **ABBREVIATIONS EXISTING** PROPOSED EXC **EXCAVATION** ROADWAY REM **GENERAL** FRAME AND COVER REMOVE PROPERTY LINE F&G RET FRAME AND GRATE RETAIN AADT ANNUAL AVERAGE DAILY TRAFFIC SETBACKS _____ FDC **RET WALL** FIRE DEPARTMENT CONNECTION **RETAINING WALL** ABAN ABANDON FDN FOUNDATION RRLS RIPRAP LEVEL SPREADER ADA AMERICANS WITH DISABILITIES ACT **EASEMENT LINE** FES FLARED END SECTION RIGHT OF WAY ADJ FFE FINISH FLOOR ELEVATION RAILROAD CONTOUR _____ 262 _____ APPROX **APPROXIMATE** FLDSTN **FIELDSTONE** RIPRAP SLOPE ASPHALT CONCRETE x 261.5 SPOT ELEVATION X 407.5 FND FOUND RIPRAP SPILLWAY ACCM PIPE ASPHALT COATED CORRUGATED METAL PIPE FOOT ____D ____D _____D ____ AREA SUBJECT TO STORM FLOWAGE DRAINAGE LINE ____D ____D ____D ___ GAR GARAGE RTAD REFER TO ARCHITECTURAL DRAWINGS ATD ASPHALT TURNDOWN WATER LINE RTED GROUND REFER TO ELECTRICAL DRAWINGS ____w___w___w___ ATG ADJUST TO GRADE **GAS GATE** RTFPD GG REFER TO FIRE PROTECTION DRAWINGS BITUMINOUS BERM FIRE WATER LINE _____FW _____FW _____ RTLD REFER TO LANDSCAPE DRAWINGS **GUTTER INLET** BOTTOM OF CURB (FINISHED GRADE ON LOW SIDE OF CURB) RTMD GALVANIZED IRON PIPE REFER TO MECHANICAL DRAWINGS SANITARY SEWER LINE ___s___s___s__ BOUND GRAN GRANITE RTPD REFER TO PLUMBING DRAWINGS **BITUMINOUS** GAS LINE _____G ______G _____ **GRAV** GRAVEL RTSD REFER TO STRUCTURAL DRAWINGS BASELINE GRD GUARD BLDG BUILDING **ELECTRIC** ——Е ———Е ———Е — ____E ____E ___E ___ GTD **GRADE TO DRAIN** SAND BAG EROSION CONTROL BARRIER BENCHMARK **GATE VALVE** SDR STANDARD DIMENSIONAL RATIO ____T____T____T___ TELEPHONE LINE BEST MANAGEMENT PRACTICE ____T____T____T___ SED **HCPS** SEDIMENT HANDICAP ACCESSIBLE PARKING SIGN BY OTHERS HDBC HEAVY DUTY BITUMINOUS CONCRETE SESC SOIL EROSION AND SEDIMENT CONTROL OVERHEAD ELECTRIC LINE ____OHW ____ BOL BOLLARD SFL HDPE HIGH DENSITY POLYETHYLENE PIPE STATE FREEWAY LINE BOS **BOTTOM OF SLOPE** LIMIT OF DISTURBANCE _____ _____LOD _____ SFCD HDPS HANDICAP ACCESSIBLE PARKING SIGN SEDIMENT FOREBAY CHECK DAM BOTTOM HDW SG HEADWALL SWING GATE LIMIT OF DISTURBANCE/COMPOST FILTER SOCK — — LOD/CFS — L BPM BLACKOUT PAVEMENT MARKING HMA HOT MIX ASPHALT SHL STATE HIGHWAY LINE BRIDGE CATCH BASIN HOT MIXED ASPHALT WALKWAY SHOULDER BOTTOM OF STAIR (FINISHED GRADE AT BOTTOM STAIR) SHLO HOR HORIZONTAL STATE HIGHWAY LAYOUT BOTTOM OF WALL (FINISHED GRADE ON LOW SIDE OF WALL) **HYDRANT** HPR HEADWALL PROTECTION RACK HANDICAP PARKING PAVEMENT MARKING BWL BROKEN WHITE LINE HYD HYDRANT SEDIMENT MARKER DRAINAGE MANHOLE **BROKEN YELLOW LINE INSIDE DIAMETER** SEWER MANHOLE CURVE LENGTH SEWER MANHOLE INVERT SSD STOPPING SIGHT DISTANCE CATCH BASIN JUNCTION STREET UTILITY POLE CATCH BASIN WITH CURB INLET LENGTH OF CURVE STA STATION CEMENT CONCRETE WATER VALVE SIDEWALK LEACH BASIN \mathbb{W} CEMENT CONCRETE MASONRY LIMIT OF DISTURBANCE SINGLE SOLID WHITE LINE CEMENT CONCRETE WALK GG 🔘 GAS GATE SWR LOW POINT SEWER CD CHECK DAM SINGLE SOLID YELLOW LINE LICENSE PLATE READER LIGHT POLE CONSTRUCTION ENTRANCE LS LOAM AND SEED TANGENT DISTANCE OF CURVE/TRUCK % CEM CEMENT TREE LINE LSOD LOAM AND SOD TANGENT CFS COMPOST FILTER SOCK LEFT TEMPORARY DIVERSION CLEAR AND GRUB VEGETATION STONE WALL LTP LIGHT POLE **TEMPORARY** CHORD LENGTH **MAXIMUM** TOP OF CURB CHAIN LINK FENCE $-\circ$ \circ $-\circ$ ____X___X___X____X **CURB INLET** MAILBOX TDS TEMPORARY DIVERSION SWALE CAST IRON PIPE WIRE FENCE —x——x——x——x——x——x— MONOLITHIC CONCRETE WALK TREE GROUP PROTECTION CONSTRUCTION JOINT MANHOLE TEMPORARY INLET PROTECTION WOOD FENCE CENTERLINE MINIMUM TELEPHONE MANHOLE CEMENT-LINED DUCTILE IRON CLDI **FENCE** MONITORING TOP OF SLOPE CHAIN LINK FENCE MANUAL OF UNIFORM TRAFFIC CONTROL DEVICES, LATEST EDITION TEST PIT CONTROLLED LOW STRENGTH MATERIAL CURBING NIC NOT IN CONTRACT TRANSITION CLR CLEAR NO NUMBER TURF REINFORCEMENT MAT **EDGE OF PAVEMENT** CLS CLASS TOP OF STAIR (FINISHED GRADE OF TOP STAIR) NOT TO SCALE SAWCUT AND MATCH SAWCUT LINE ocs OUTLET CONTROL STRUCTURE TEMPORARY SEDIMENT TRAP CMP CORRUGATED METAL PIPE OD OUTSIDE DIAMETER TEMPORARY SWALE SIGN CO CLEANOUT OSHA OCCUPATIONAL SAFETY AND HEALTH ADMINISTRATION TOP OF WALL CONC CONCRETE COMPOST FILTER SOCK **TYPICAL** OIL WATER SEPARATOR CONT CONTINUOUS POINT OF CURVATURE UTILITY POLE SAND BAGS CONST CONSTRUCTION \cdot PCC POINT OF COMPOUND CURVATURE **VARIES** CONCRETE PAD # NO. OF PARKING SPACES **PCFES** VERTICAL PRECAST CONCRETE FLARED END SECTION CR GR **CROWN GRADE** PCTC PRECAST CONCRETE TRANSITION CURB VERTICAL CURVE WF A52 WF A51 WETLAND EDGE CSP CORRUGATED STEEL PIPE PCR PEDESTRIAN CURB RAMP VERTICAL CONCRETE CURB CSTR CONCRETE STAIRS 50' PERIMETER WETLAND VCP POLYETHYLENE VEHICULAR CONCRETE PAVEMENT CTE CONNECT TO EXISTING PERF PERFORATED VITRIFIED CLAY 200' RIVERBANK __________ CROSSWALK PGL PROFILE GRADE LINE VEGETATION DEMO DEMOLITION POROUS HOT MIXED ASPHALT PAVEMENT VEH VEHICULAR DET DETECTABLE POINT OF INTERSECTION VFS VEGETATED FILTER STRIP DHV DESIGN HOURLY VOLUME VGC POST INDICATOR VALVE VERTICAL GRANITE CURB RHODE ISLAND STANDARD DETAILS DROP INLET POC VGTC POINT ON CURVE VERTICAL GRANITE TRANSITION CURB DIAMETER POT POINT ON TANGENT VINYL FENCE (2.3.0) = PRECAST CONCRETE FLARED END SECTION - R.I. STD. 2.3.0 DUCTILE IRON PIPE WITH PAVEMENT MARKING DIVERSION (7.2.4) = PRECAST CONCRETE CAR STOPS - R.I. STD. 7.2.4 WATER GATE POINT OF REVERSE CURVATURE DMH DRAIN MANHOLE PROJ **PROJECT** WROUGHT IRON PIPE (7.3.0) = GRANITE CURB - R.I. STD. 7.3.0 DTP DRIPLINE TREE PROTECTION PROPOSED WATER METER/WATER MAIN DWL DOTTED WHITE LINE 7.3.9 = GRANITE RAMP STONE - R.I. STD. 7.3.9 PSB PLANTABLE SOIL BORROW WMH WATER MANHOLE **DWLEx** DOTTED WHITE LINE EXTENSION POINT OF TANGENCY WATER PAINT MARK 9.9.0 = CONSTRUCTION ACCESS - R.I. STD. 9.9.0 DBWL DOUBLE WHITE LINE PVC **CROSS SECTION** POINT OF VERTICAL CURVATURE X-SECT DWP DETECTABLE WARNING PAVER (43.1.0M) = CEMENT CONCRETE SIDEWALK (MODIFIED) - R.I. STD. 43.1.0 POLYVINYL CHLORIDE YARD DRAIN DYL DOTTED YELLOW LINE PVI 4" DOUBLE YELLOW EPOXY RESIN PAVEMENT MARKING POINT OF VERTICAL INTERSECTION 4DY (43.3.1M) = WHEELCHAIR RAMP FOR LIMITED RIGHT-OF-WAY AREAS (MODIFIED) - R.I. STD. 43.3.1 DYLEx DOTTED YELLOW LINE EXTENSION PVT POINT OF VERTICAL TANGENCY 4" SOLID WHITE EPOXY RESIN PAVEMENT MARKING DBYL DOUBLE YELLOW LINE (43.3.0M) = WHEELCHAIR RAMP (MODIFIED) - R.I. STD. 43.3.0M **PVMT** PAVEMENT 12" SOLID WHITE EPOXY RESIN PAVEMENT MARKING DW STEADY DON'T WALK - PORTLAND ORANGE PAVED WATER WAY DRIVEWAY (43.3.2M) = RAMP-LANDING FOR NARROW SIDEWALK (MODIFIED) - R.I. STD. 43.3.2M DWY QPA QUALIFYING PERVIOUS AREA **EXPANSION JOINT** : DETECTABLE WARNING SYSTEM (MODIFIED) - R.I. STD. 48.1.0M REMOVE AND DISPOSE ELEV (or EL) ELEVATION R&R REMOVE AND RESET **EMBANKMENT** REMOVE AND STACK RHODE ISLAND ABBREVIATIONS ELECTRIC MANHOLE **RADIUS** EDGE OF PAVEMENT RAILING ETR EXISTING TO REMAIN. PROTECT DURING CONSTRUCTION. RHODE ISLAND DEPARTMENT OF ENVIRONMENTAL MANAGEMENT


RHODE ISLAND DEPARTMENT OF TRANSPORTATION

RHODE ISLAND POLLUTION DISCHARGE ELIMINATION SYSTEM

RHODE ISLAND HIGHWAY PLAT

RHODE ISLAND STANDARD

CITY OF PROVIDENCE -DEPT. OF PUBLIC WORKS COMPLEX

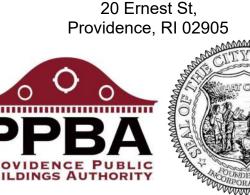

Owner:
Providence Department of Public Works
20 Ernest Street
Providence, RI 02905



OWNERSHIP AND USE OF DOCUMENTS, DRAWINGS AND SPECIFICATIONS AS INSTRUMENTS OF PROFESSIONAL SERVICE, ARE, AND SHALL REMAIN, THE PROPERTY OF THE ARCHITECT. THESE DOCUMENTS ARE NOT TO BE USED, IN WHOLE OR IN PART FOR ANY OTHER PROJECTS OR PURPOSES, OR BY ANY OTHER PARTIES THAN THOSE PROPERLY AUTHORIZED BY CONTRACT WITHOUT THE EXPRESS AUTHORIZATION OF THE ARCHITECT.




GENERAL NOTES

1. CONTRACTOR SHALL VISIT SITE, PRIOR TO BID, AND CAREFULLY INVESTIGATE AND EXAMINE THE AREA OF WORK SO AS TO SATISFY HIMSELF AS TO THE NATURE AND LOCATION OF THE WORK. CONTRACTOR TO NOTE THE CHARACTER, QUALITY, QUANTITIES OF MATERIALS REQUIRED AND DIFFICULTIES TO BE ENCOUNTERED, THE KIND AND EXTENT OF EQUIPMENT AND FACILITIES NEEDED FOR PERFORMANCE OF THE WORK AND OTHER ITEMS WHICH MAY, IN ANY WAY, AFFECT THE WORK OR CONTRACTOR'S

DRAWINGS DO NOT INCLUDE NECESSARY COMPONENTS FOR CONSTRUCTION SAFETY.

MAJOR LAND DEVELOPMENT APPLICATION SUBMISSION

NOT FOR CONSTRUCTION

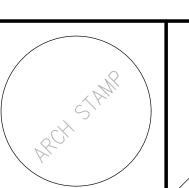

Date: 01–17–2025


Drawn by: Proj. Mgr.:


Revisions

No. Date Description

LEGEND

C1.2

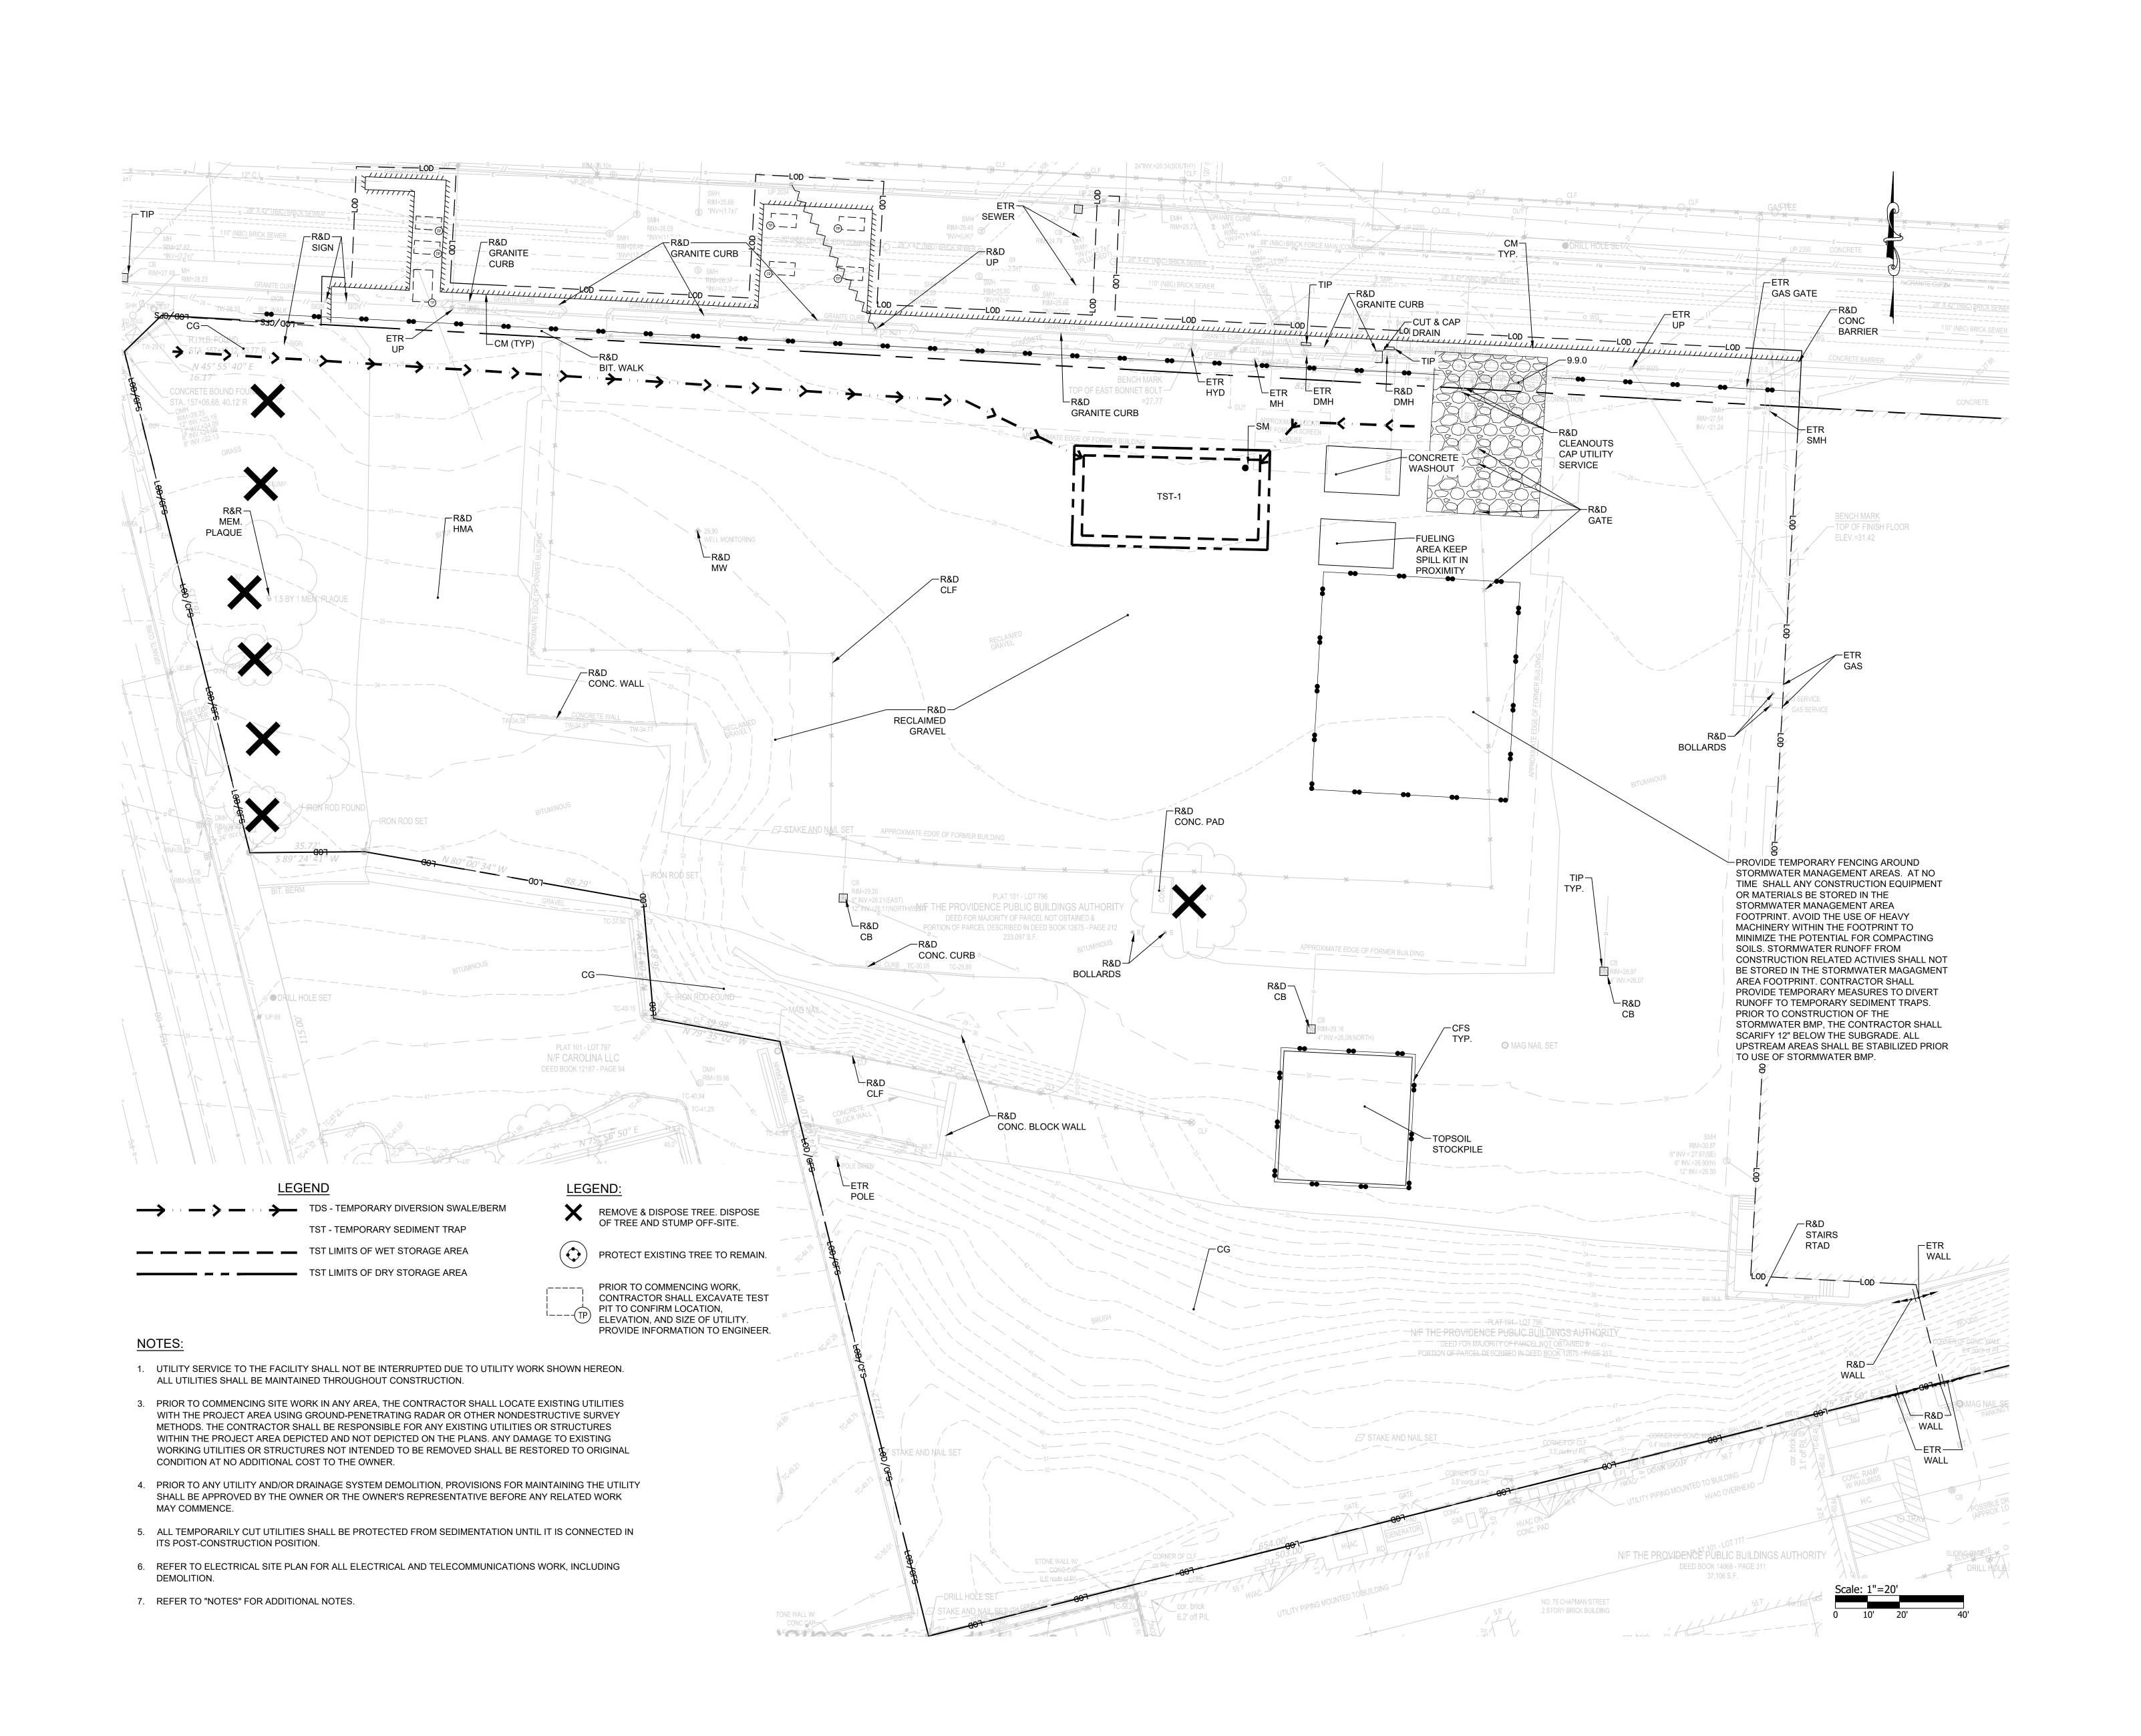

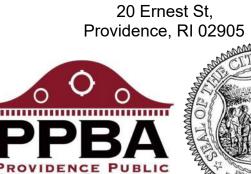

Owner: Providence Department of Public Works 20 Ernest Street Providence, RI 02905



400 Massasoit Avenue, Suite 300, Second Floor East Providence, Rhode Island p. (401) 331-9200 2 Hampshire Street, Suite 106, First Floor Foxboro, Massachusetts p. (774) 215-0290

OWNERSHIP AND USE OF DOCUMENTS, DRAWINGS AND SPECIFICATIONS AS INSTRUMENTS OF PROFESSIONAL SERVICE, ARE, AND SHALL REMAIN, THE PROPERTY OF THE ARCHITECT. THESE DOCUMENTS ARE NOT TO BE USED, IN WHOLE OR IN PART. FOR ANY OTHER PROJECTS OR PURPOSES, OR BY ANY OTHER PARTIES THAN THOSE PROPERLY AUTHORIZED BY CONTRACT



WITHOUT THE EXPRESS AUTHORIZATION OF THE ARCHITECT.


GENERAL NOTES

. CONTRACTOR SHALL VISIT SITE, PRIOR TO BID, AND CAREFULLY INVESTIGATE AND EXAMINE THE AREA OF WORK SO AS TO SATISFY HIMSELF AS TO THE NATURE AND LOCATION OF THE WORK. MATERIALS REQUIRED AND DIFFICULTIES TO BE ENCOUNTERED THE KIND AND EXTENT OF EQUIPMENT AND FACILITIES NEEDED FOR PERFORMANCE OF THE WORK AND OTHER ITEMS WHICH MAY, IN ANY WAY, AFFECT THE WORK OR CONTRACTOR'S

2. DRAWINGS DO NOT INCLUDE NECESSARY COMPONENTS FOR CONSTRUCTION SAFETY.

> MAJOR LAND DEVELOPMENT **APPLICATION** SUBMISSION

NOT FOR CONSTRUCTION

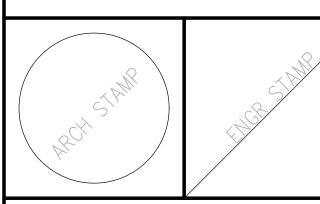

Proj. Mgr.: Drawn by: Revisions

No. Date Description

> **DEMOLITION** AND EROSION **CONTROL PLAN 1**

ZONIN	IG TABLE	
ZONE: MANUFACTURING (M- JSE:	1)	
	M-1	PROPOSED
MINIMUM LOT SIZE	NONE	274,865 SF
MAXIMUM BUILDING HEIGHT	N/A	LESS THAN 90'
FRONT SETBACK	NONE	0'*
SIDE SETBACK	NONE	47'

OFF-STREET PARK	(ING SUMMAR)	′
	REQUIRED*	PROVIDED***
STANDARD SPACES (8.5'x18')	71	71
ACCESSIBLE SPACES**	3	3
TOTAL SPACES	74	74

- * PUBLIC WORKS FACILITY: 1 SPACES/1,000 SF GFA 1 SPACES/1,000 SF x (48,000 SF NEW CONSTRUCTION + 22,800 SF EXISTING BUILDING) = 71 SPACES
- BICYCLE PARKING SUMMARY REQUIRED* PROVIDED SHORT TERM SPACES LONG TERM SPACES** 10 10 TOTAL SPACES

50% SHOULD BE LONG TERM PARKING SPACES = 5 SPACES

- - TOTAL SPACES * FOR INDUSTRIAL USES OF 40,001 - 100,000 SF OF GFA

LOADING SPACE PARKING SUMMARY

- * PUBLIC WORKS FACILITY: 1 SPACES/5,000 SF GFA 1 SPACES/5,000 SF x 48,000 SF = 10 SPACES
- REQUIRED* PROVIDED 2 SPACES ARE REQURED

Owner: Providence Department of Public Works 20 Ernest Street

CITY OF


PROVIDENCE -

DEPT. OF PUBLIC

WORKS COMPLEX

20 Ernest St,

Providence, RI 02905

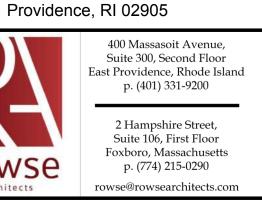

OWNERSHIP AND USE OF DOCUMENTS, DRAWINGS AND SPECIFICATIONS AS INSTRUMENTS OF PROFESSIONAL SERVICE, ARE, AND SHALL REMAIN, THE PROPERTY OF THE ARCHITECT. THESE DOCUMENTS ARE NOT TO BE USED, IN WHOLE OR IN PART, PARTIES THAN THOSE PROPERLY AUTHORIZED BY CONTRACT WITHOUT THE EXPRESS AUTHORIZATION OF THE ARCHITECT.




GENERAL NOTES

1. CONTRACTOR SHALL VISIT SITE, PRIOR TO BID, AND CAREFULLY INVESTIGATE AND EXAMINE THE AREA OF WORK SO AS TO SATISFY HIMSELF AS TO THE NATURE AND LOCATION OF THE WORK. CONTRACTOR TO NOTE THE CHARACTER, QUALITY, QUANTITIES OF MATERIALS REQUIRED AND DIFFICULTIES TO BE ENCOUNTERED, THE KIND AND EXTENT OF EQUIPMENT AND FACILITIES NEEDED FOR PERFORMANCE OF THE WORK AND OTHER ITEMS WHICH MAY, IN ANY WAY, AFFECT THE WORK OR CONTRACTOR'S

2. DRAWINGS DO NOT INCLUDE NECESSARY COMPONENTS FOR


MAJOR LAND DEVELOPMENT APPLICATION SUBMISSION

NOT FOR CONSTRUCTION

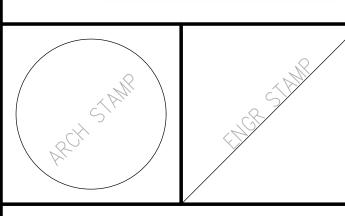


Date: 01–17–2	025
Drawn by:	Proj. Mgr.:
Revisions	
No. Date	Description

GENERAL PLAN 1

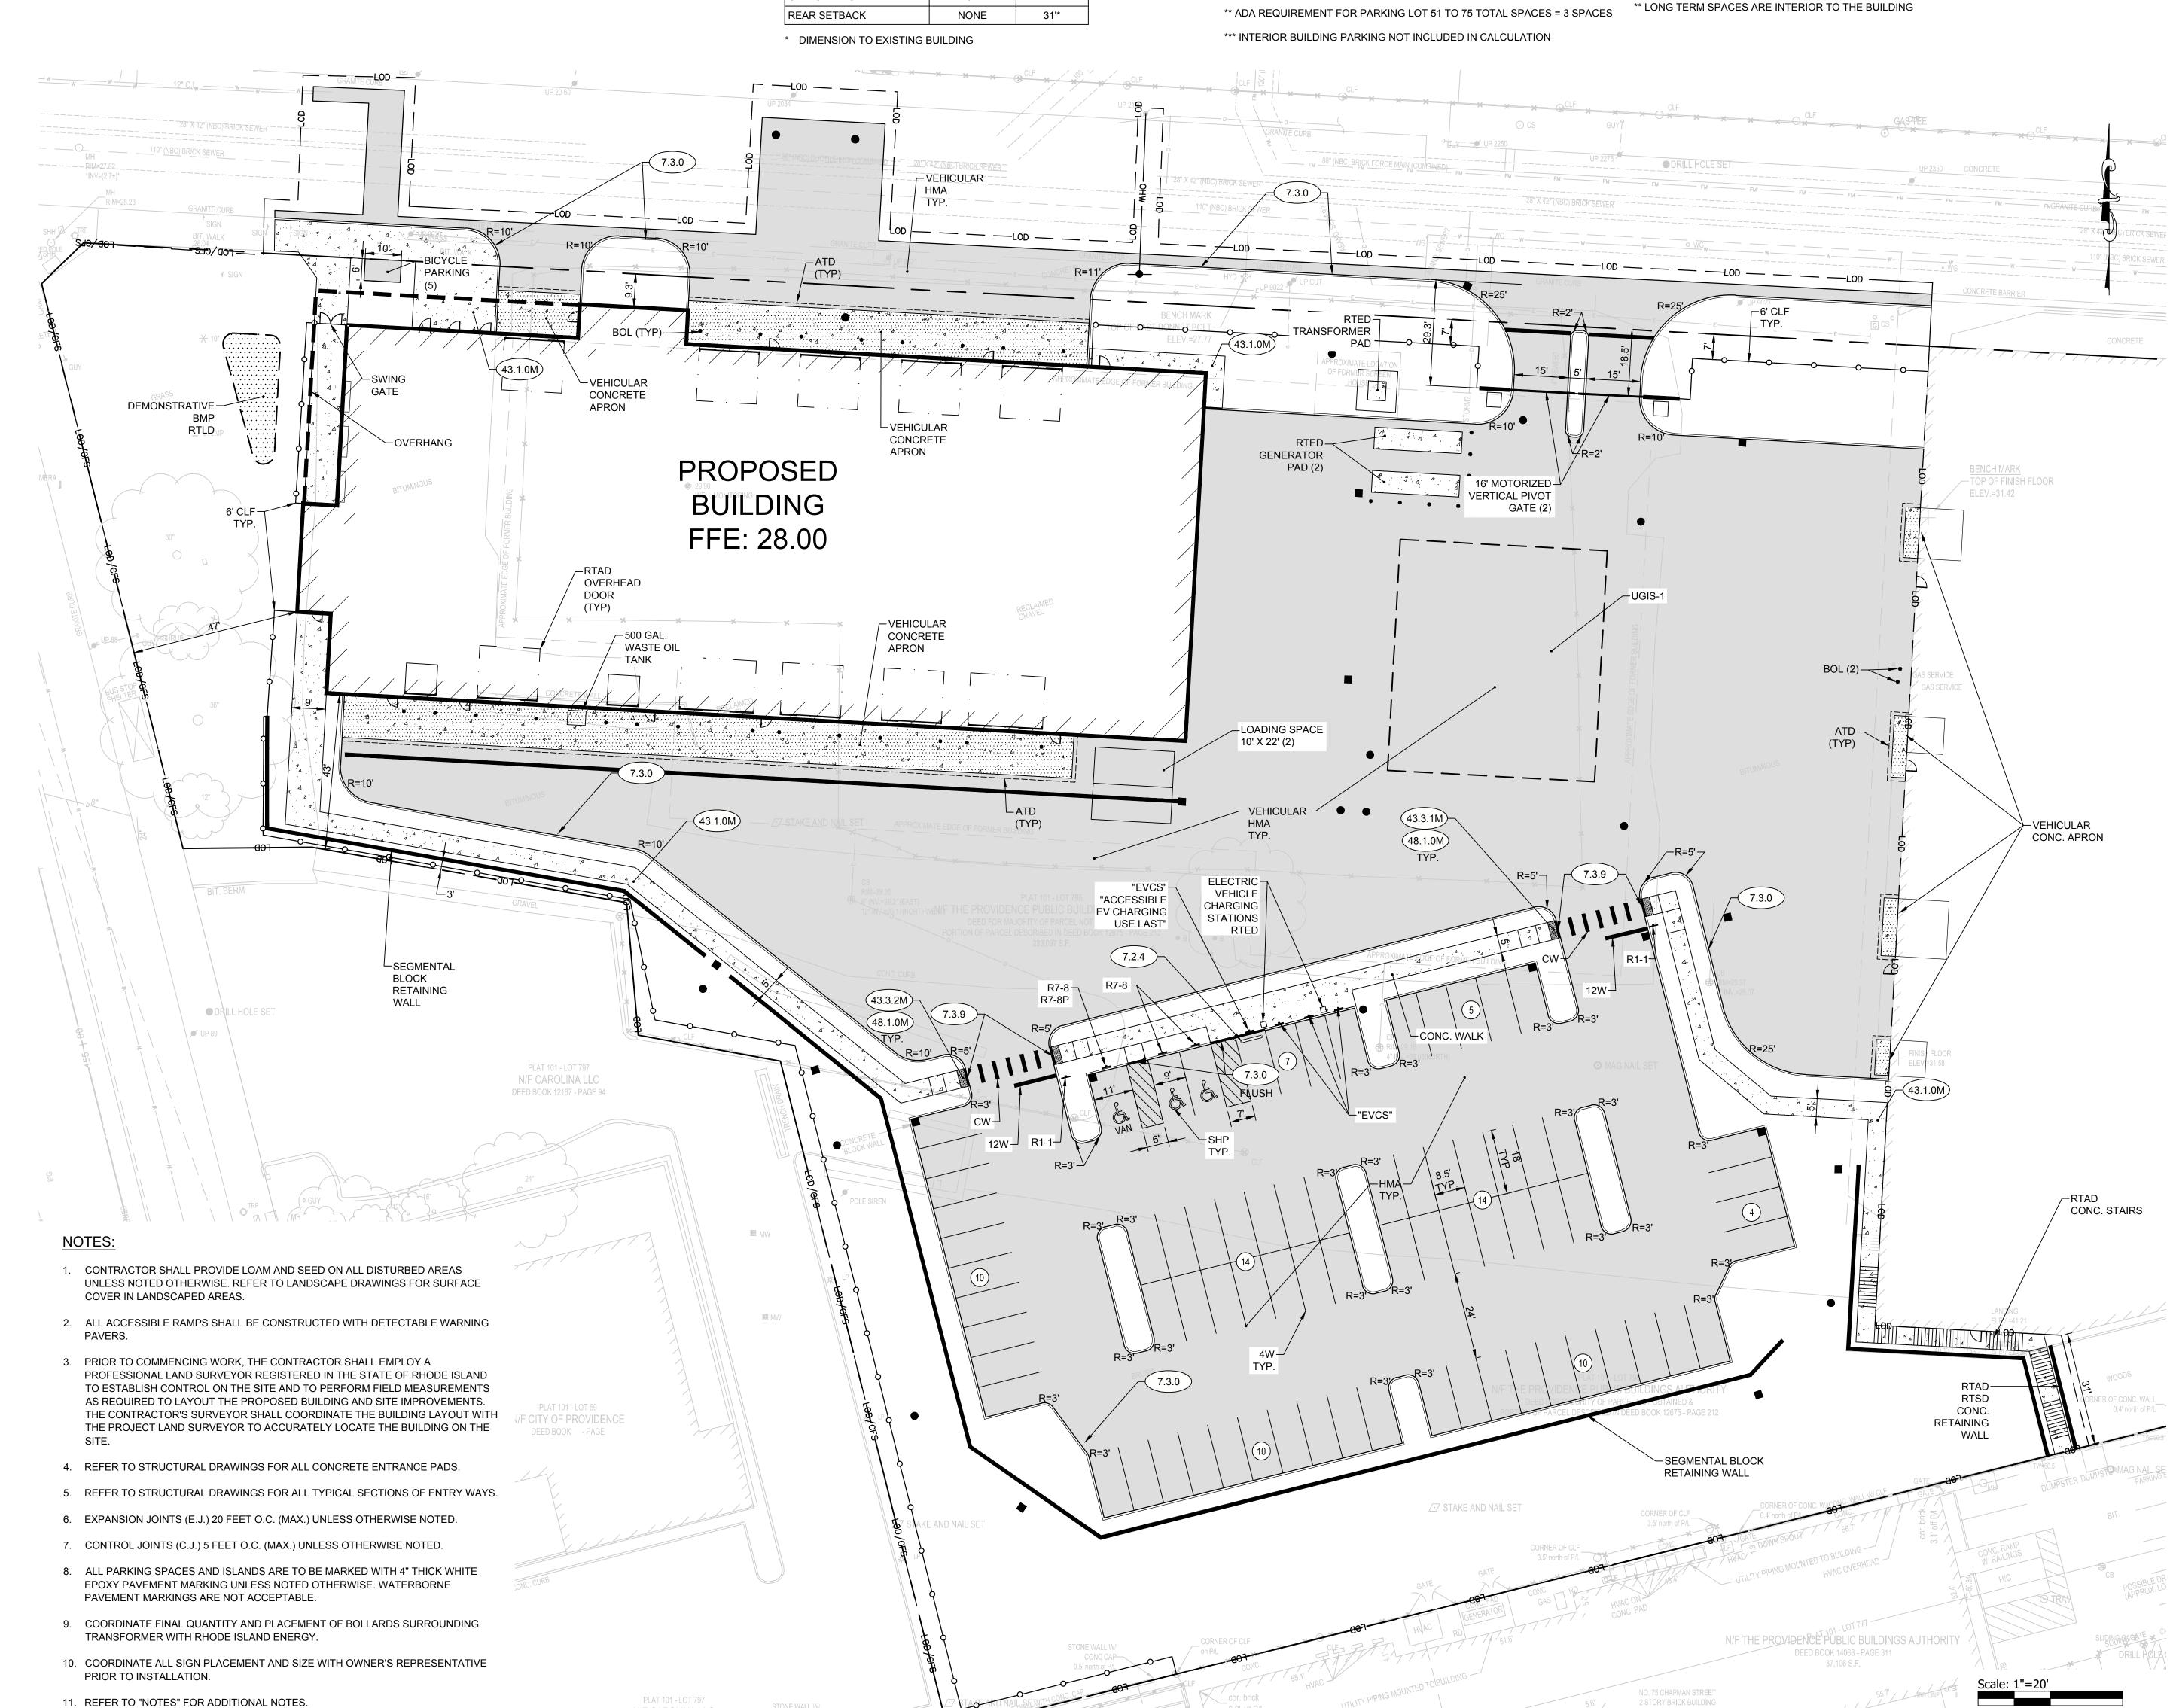

N/F CAROLINA LLO

DEED BOOK 12187 - PAGE 94

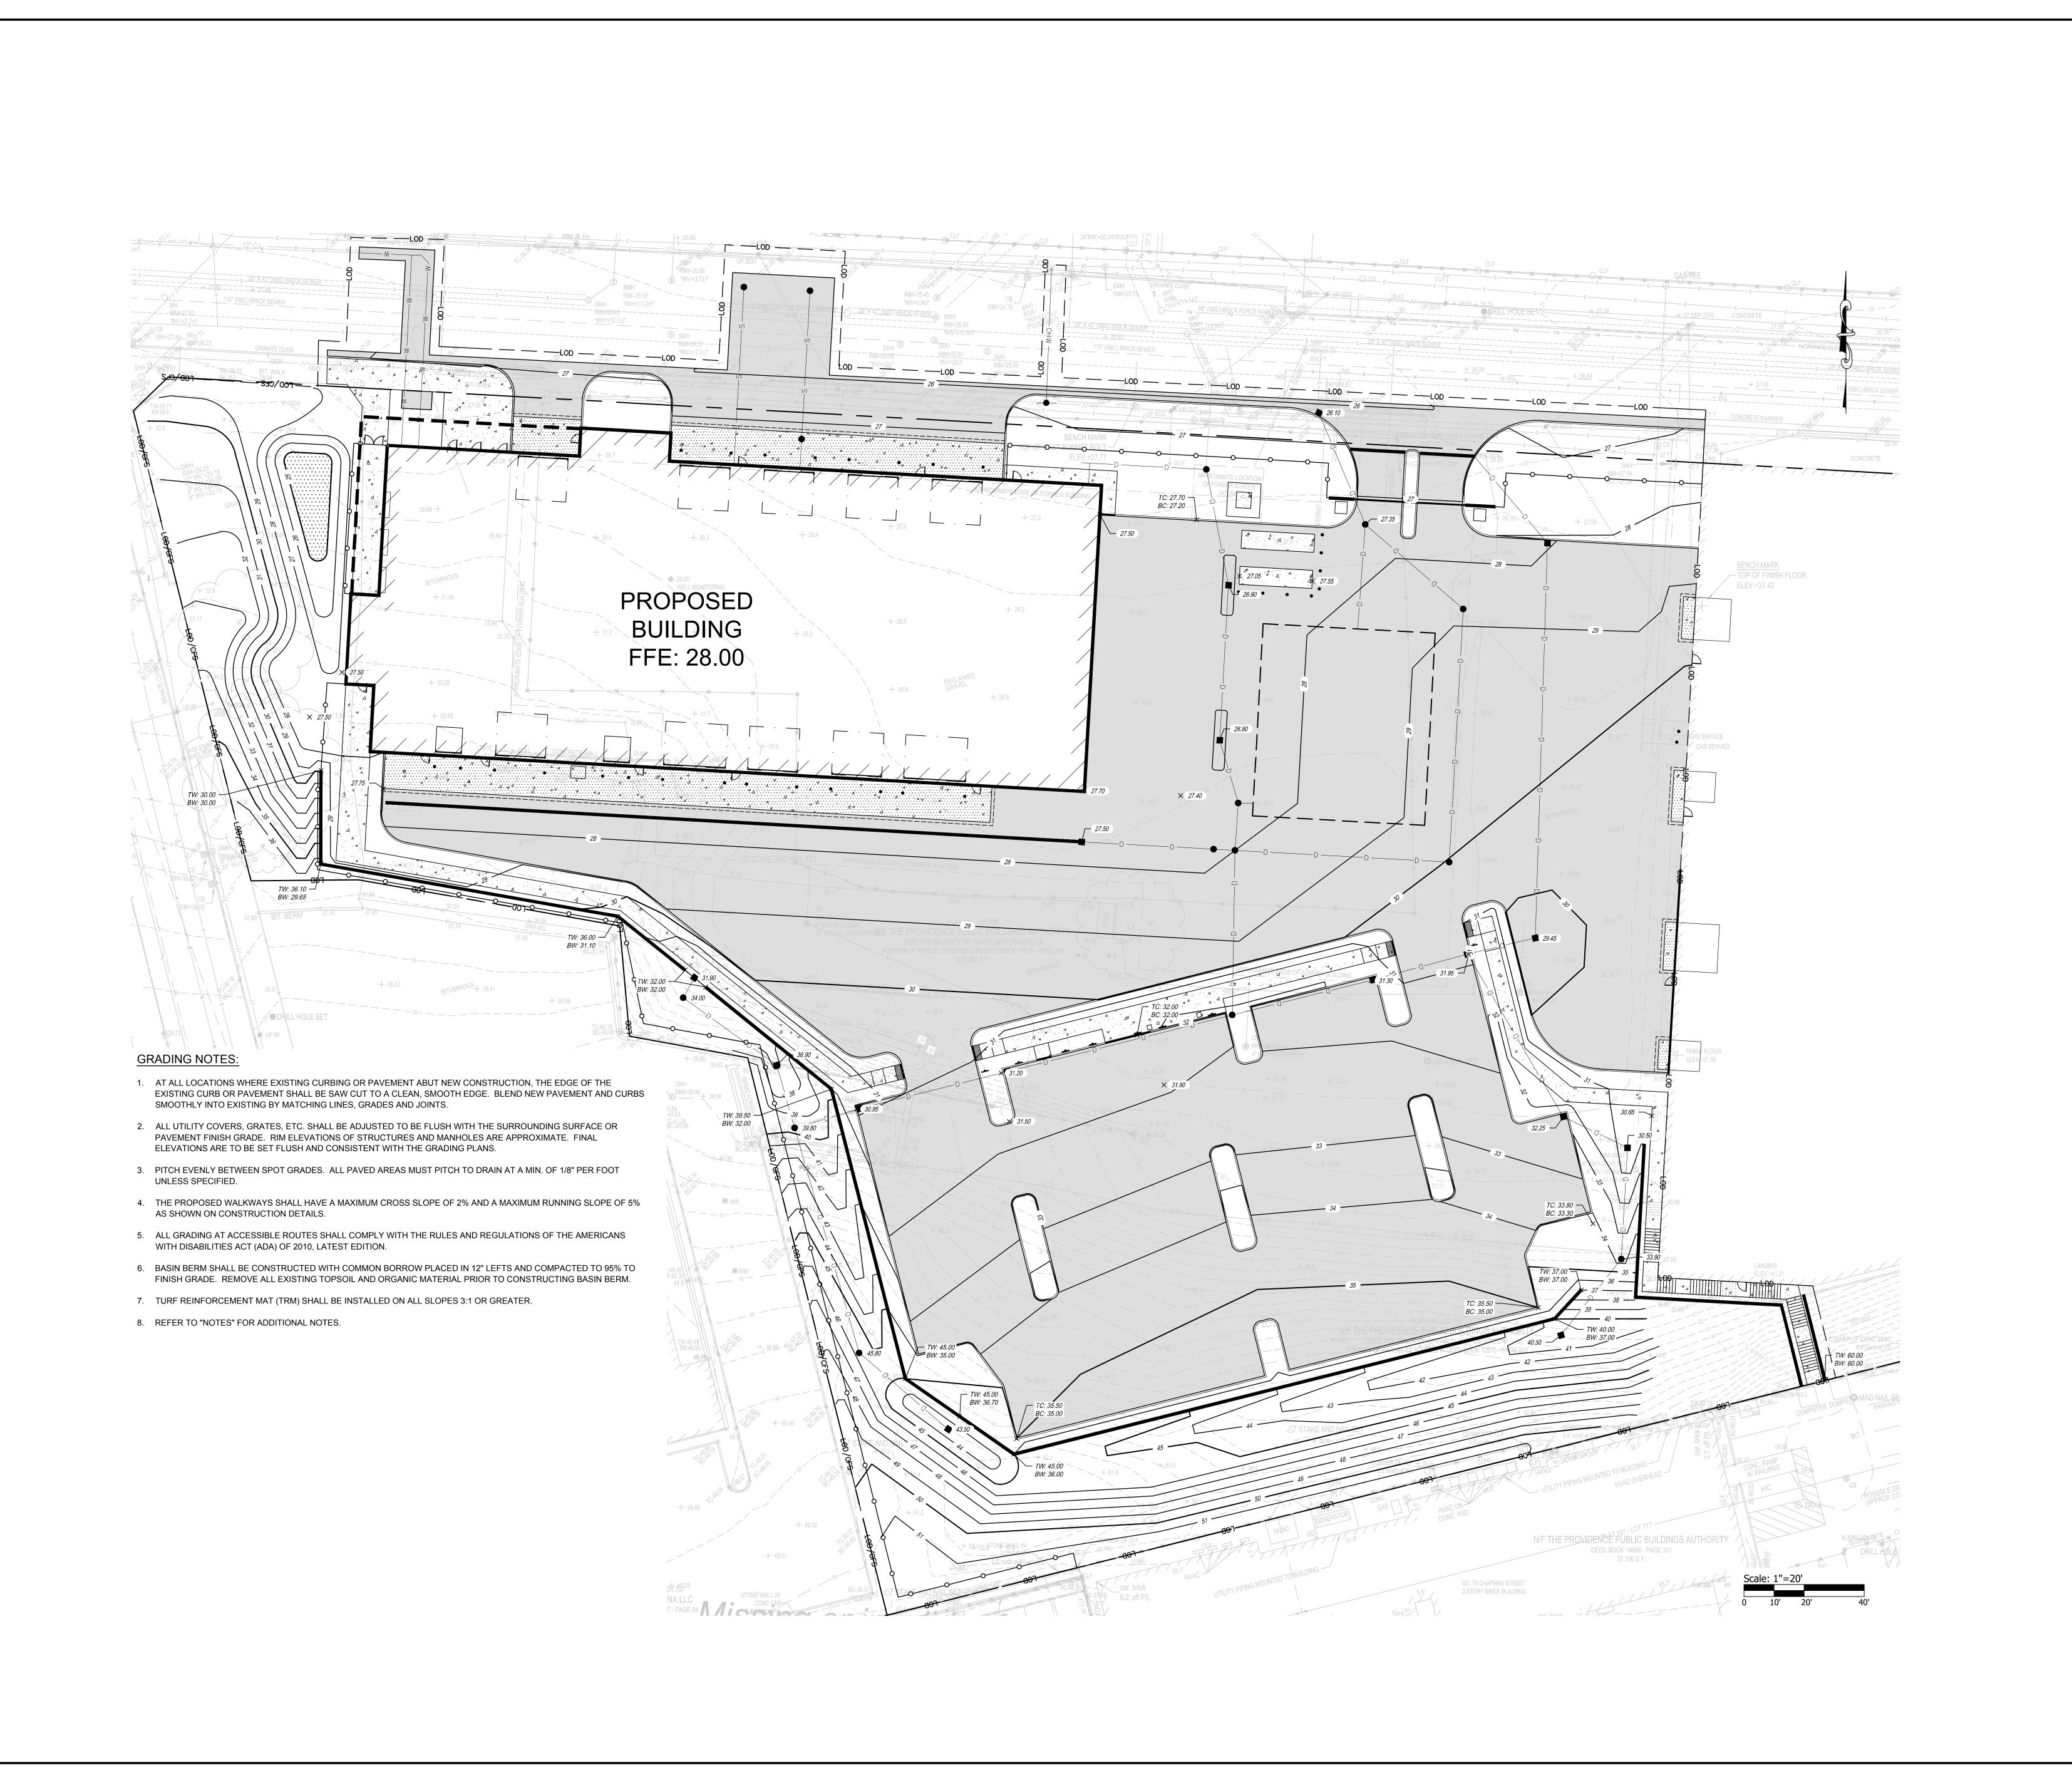

20 Ernest St, Providence, RI 02905



Owner: Providence Department of Public Works 20 Ernest Street Providence, RI 02905



Suite 300, Second Floor East Providence, Rhode Island p. (401) 331-9200 2 Hampshire Street, Suite 106, First Floor Foxboro, Massachusetts p. (774) 215-0290 rowse@rowsearchitects.com

400 Massasoit Avenue,

OWNERSHIP AND USE OF DOCUMENTS, DRAWINGS AND SPECIFICATIONS AS INSTRUMENTS OF PROFESSIONAL SERVICE, ARE, AND SHALL REMAIN, THE PROPERTY OF THE ARCHITECT. THESE DOCUMENTS ARE NOT TO BE USED, IN WHOLE OR IN PART, FOR ANY OTHER PROJECTS OR PURPOSES, OR BY ANY OTHER PARTIES THAN THOSE PROPERLY AUTHORIZED BY CONTRACT

WITHOUT THE EXPRESS AUTHORIZATION OF THE ARCHITECT.




GENERAL NOTES

1. CONTRACTOR SHALL VISIT SITE, PRIOR TO BID, AND CAREFULLY INVESTIGATE AND EXAMINE THE AREA OF WORK SO AS TO SATISFY HIMSELF AS TO THE NATURE AND LOCATION OF THE WORK. CONTRACTOR TO NOTE THE CHARACTER, QUALITY, QUANTITIES OF MATERIALS REQUIRED AND DIFFICULTIES TO BE ENCOUNTERED, THE KIND AND EXTENT OF EQUIPMENT AND FACILITIES NEEDED FOR PERFORMANCE OF THE WORK AND OTHER ITEMS WHICH MAY, IN ANY WAY, AFFECT THE WORK OR CONTRACTOR'S DEDECOMANCE

2. DRAWINGS DO NOT INCLUDE NECESSARY COMPONENTS FOR

MAJOR LAND DEVELOPMENT APPLICATION SUBMISSION


NOT FOR CONSTRUCTION

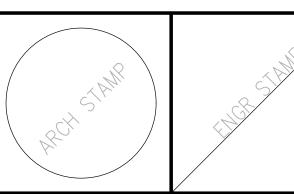



Proj. Mgr.: Drawn by: Revisions

No. Date Description

GRADING PLAN 1

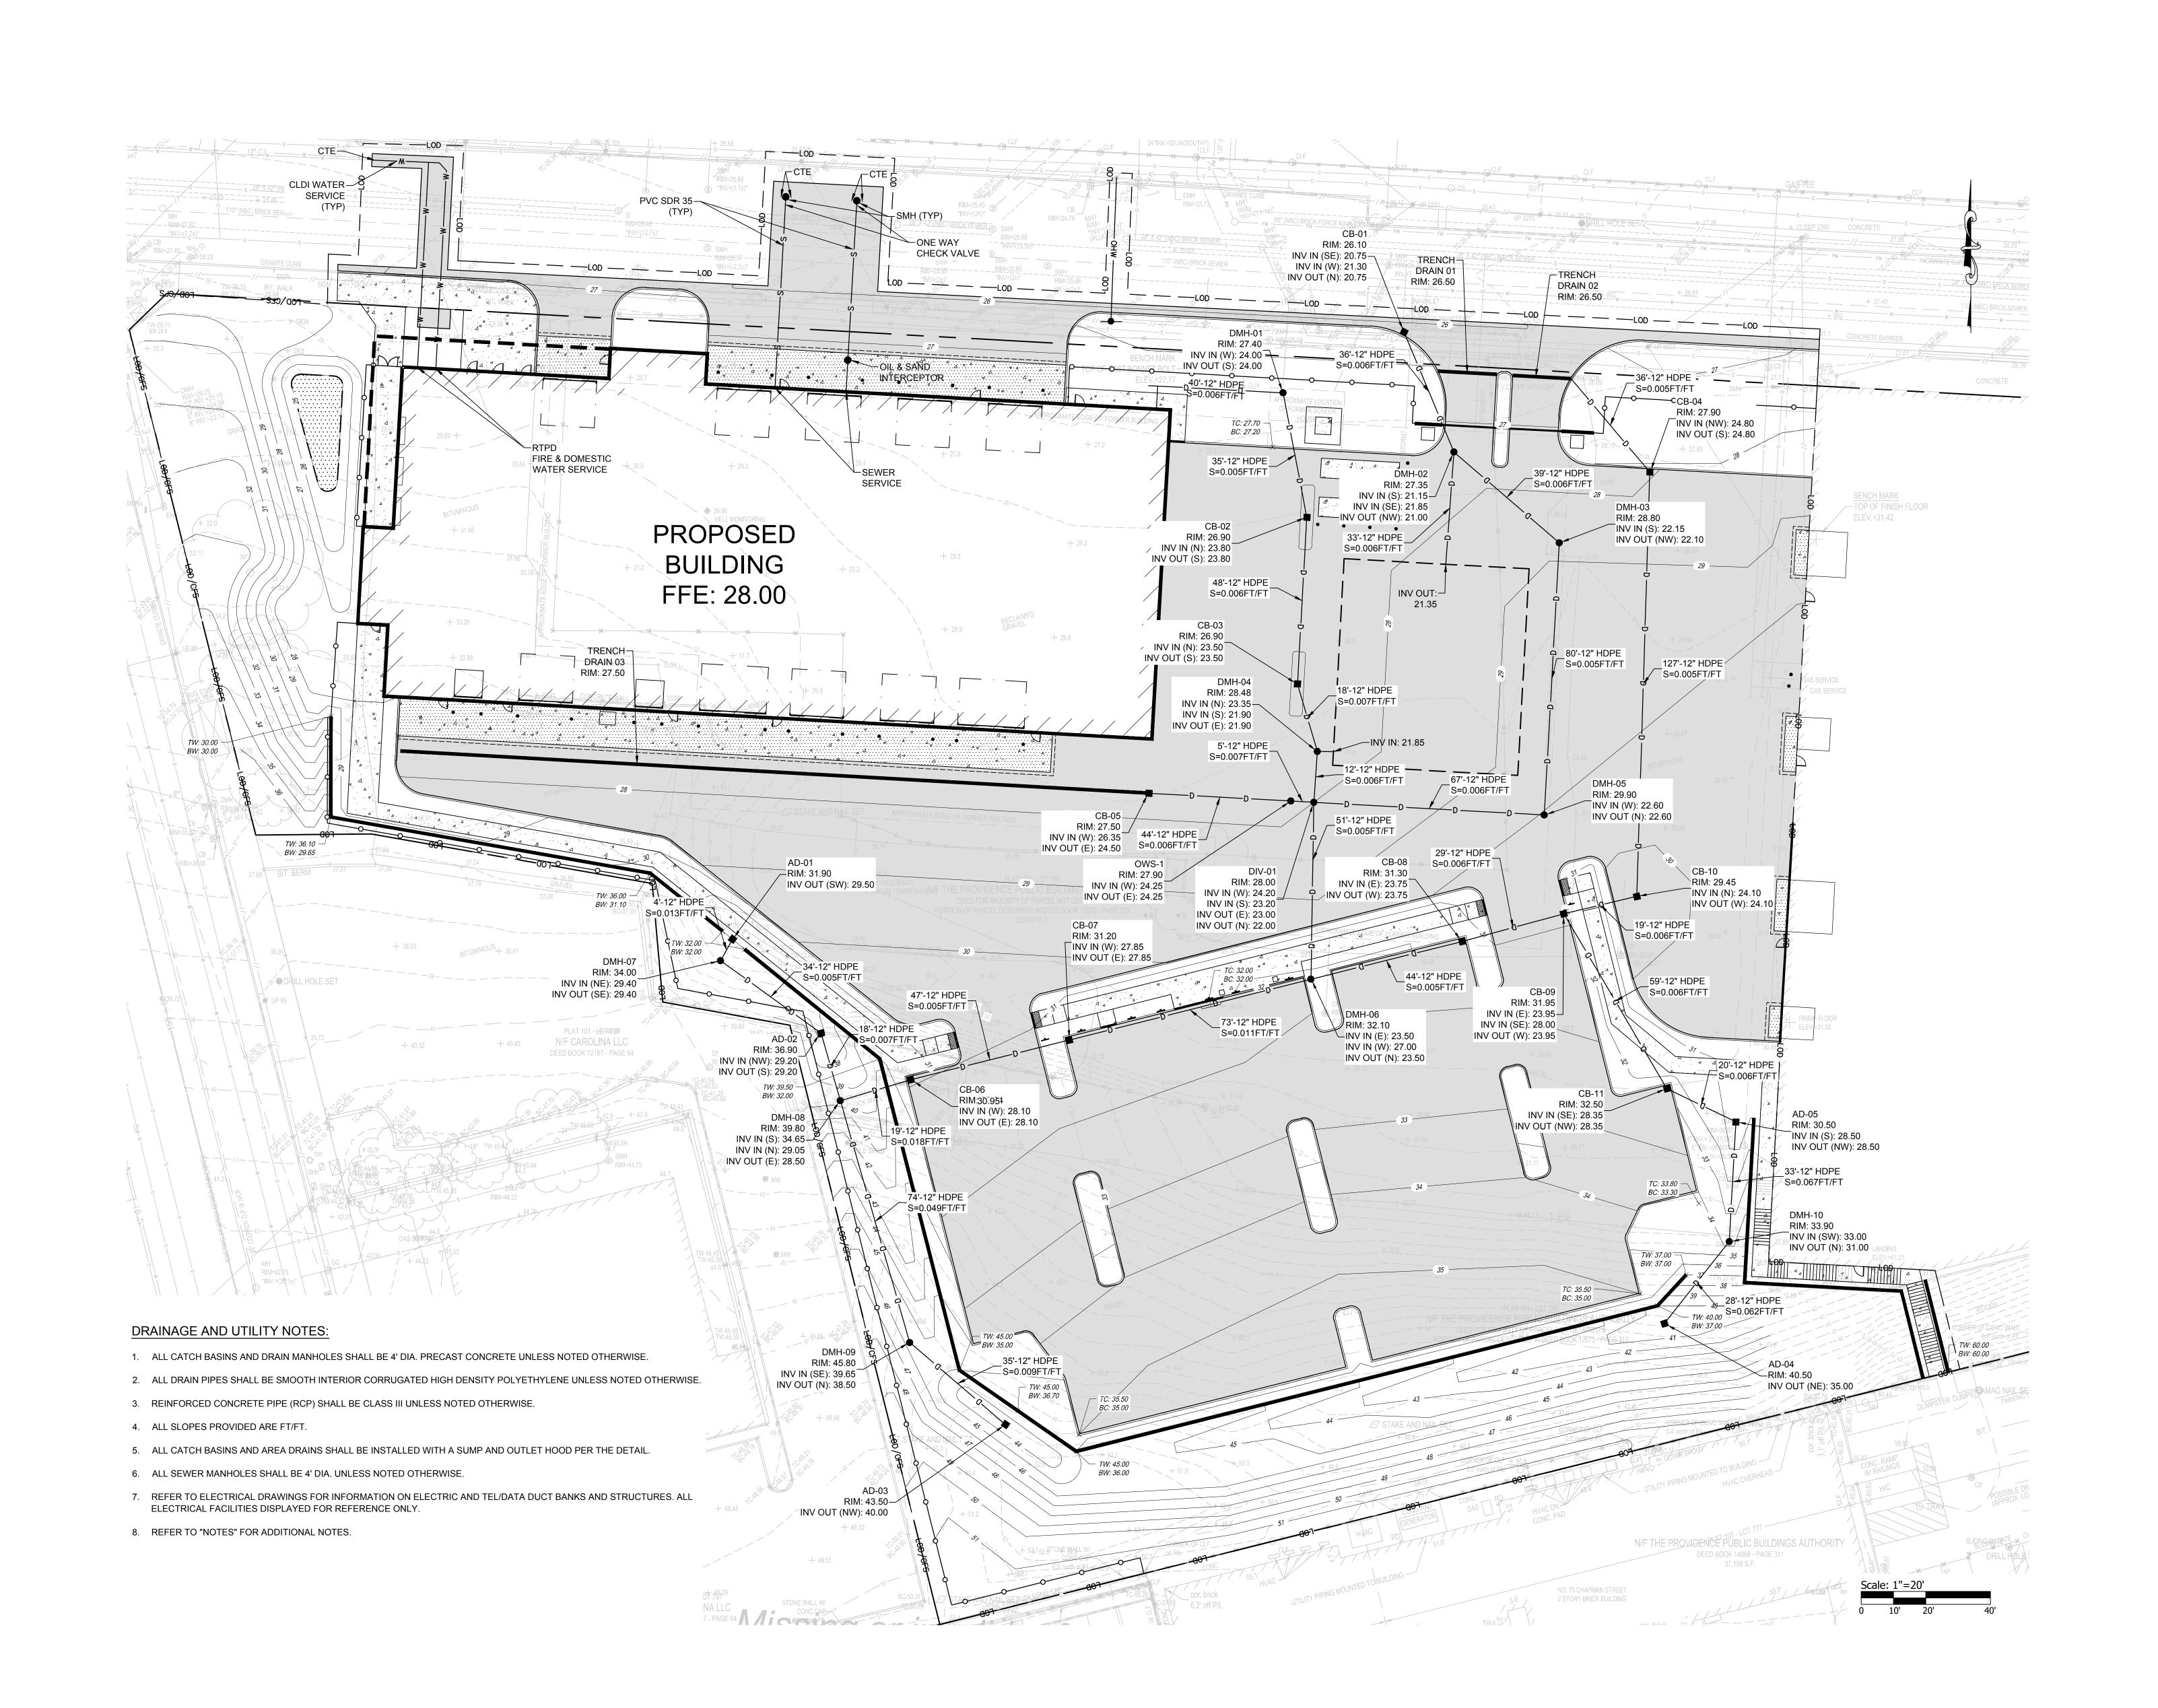

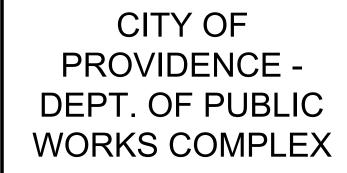

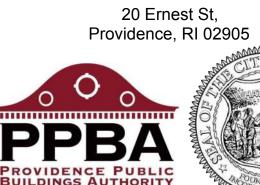

Owner:
Providence Department of Public Works
20 Ernest Street
Providence, RI 02905



Suite 300, Second Floor
East Providence, Rhode Island
p. (401) 331-9200

2 Hampshire Street,
Suite 106, First Floor
Foxboro, Massachusetts
p. (774) 215-0290
rowse@rowsearchitects.com

400 Massasoit Avenue,

OWNERSHIP AND USE OF DOCUMENTS, DRAWINGS AND SPECIFICATIONS AS INSTRUMENTS OF PROFESSIONAL SERVICE, ARE, AND SHALL REMAIN, THE PROPERTY OF THE ARCHITECT. THESE DOCUMENTS ARE NOT TO BE USED, IN WHOLE OR IN PART, FOR ANY OTHER PROJECTS OR PURPOSES, OR BY ANY OTHER PARTIES THAN THOSE PROPERLY AUTHORIZED BY CONTRACT WITHOUT THE EXPRESS AUTHORIZATION OF THE ARCHITECT.




GENERAL NOTES

1. CONTRACTOR SHALL VISIT SITE, PRIOR TO BID, AND CAREFULLY INVESTIGATE AND EXAMINE THE AREA OF WORK SO AS TO SATISFY HIMSELF AS TO THE NATURE AND LOCATION OF THE WORK. CONTRACTOR TO NOTE THE CHARACTER, QUALITY, QUANTITIES OF MATERIALS REQUIRED AND DIFFICULTIES TO BE ENCOUNTERED, THE KIND AND EXTENT OF EQUIPMENT AND FACILITIES NEEDED FOR PERFORMANCE OF THE WORK AND OTHER ITEMS WHICH MAY, IN ANY WAY, AFFECT THE WORK OR CONTRACTOR'S

DRAWINGS DO NOT INCLUDE NECESSARY COMPONENTS FOR

MAJOR LAND DEVELOPMENT APPLICATION SUBMISSION

NOT FOR CONSTRUCTION

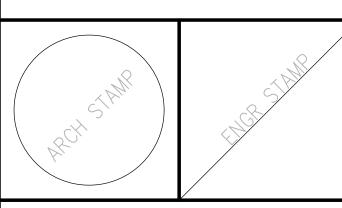

Date: 01-17-2025


Drawn by: Proj. Mgr.:

Revisions

No. Date Description

DRAINAGE AND UTILITY PLAN 1

C5_1

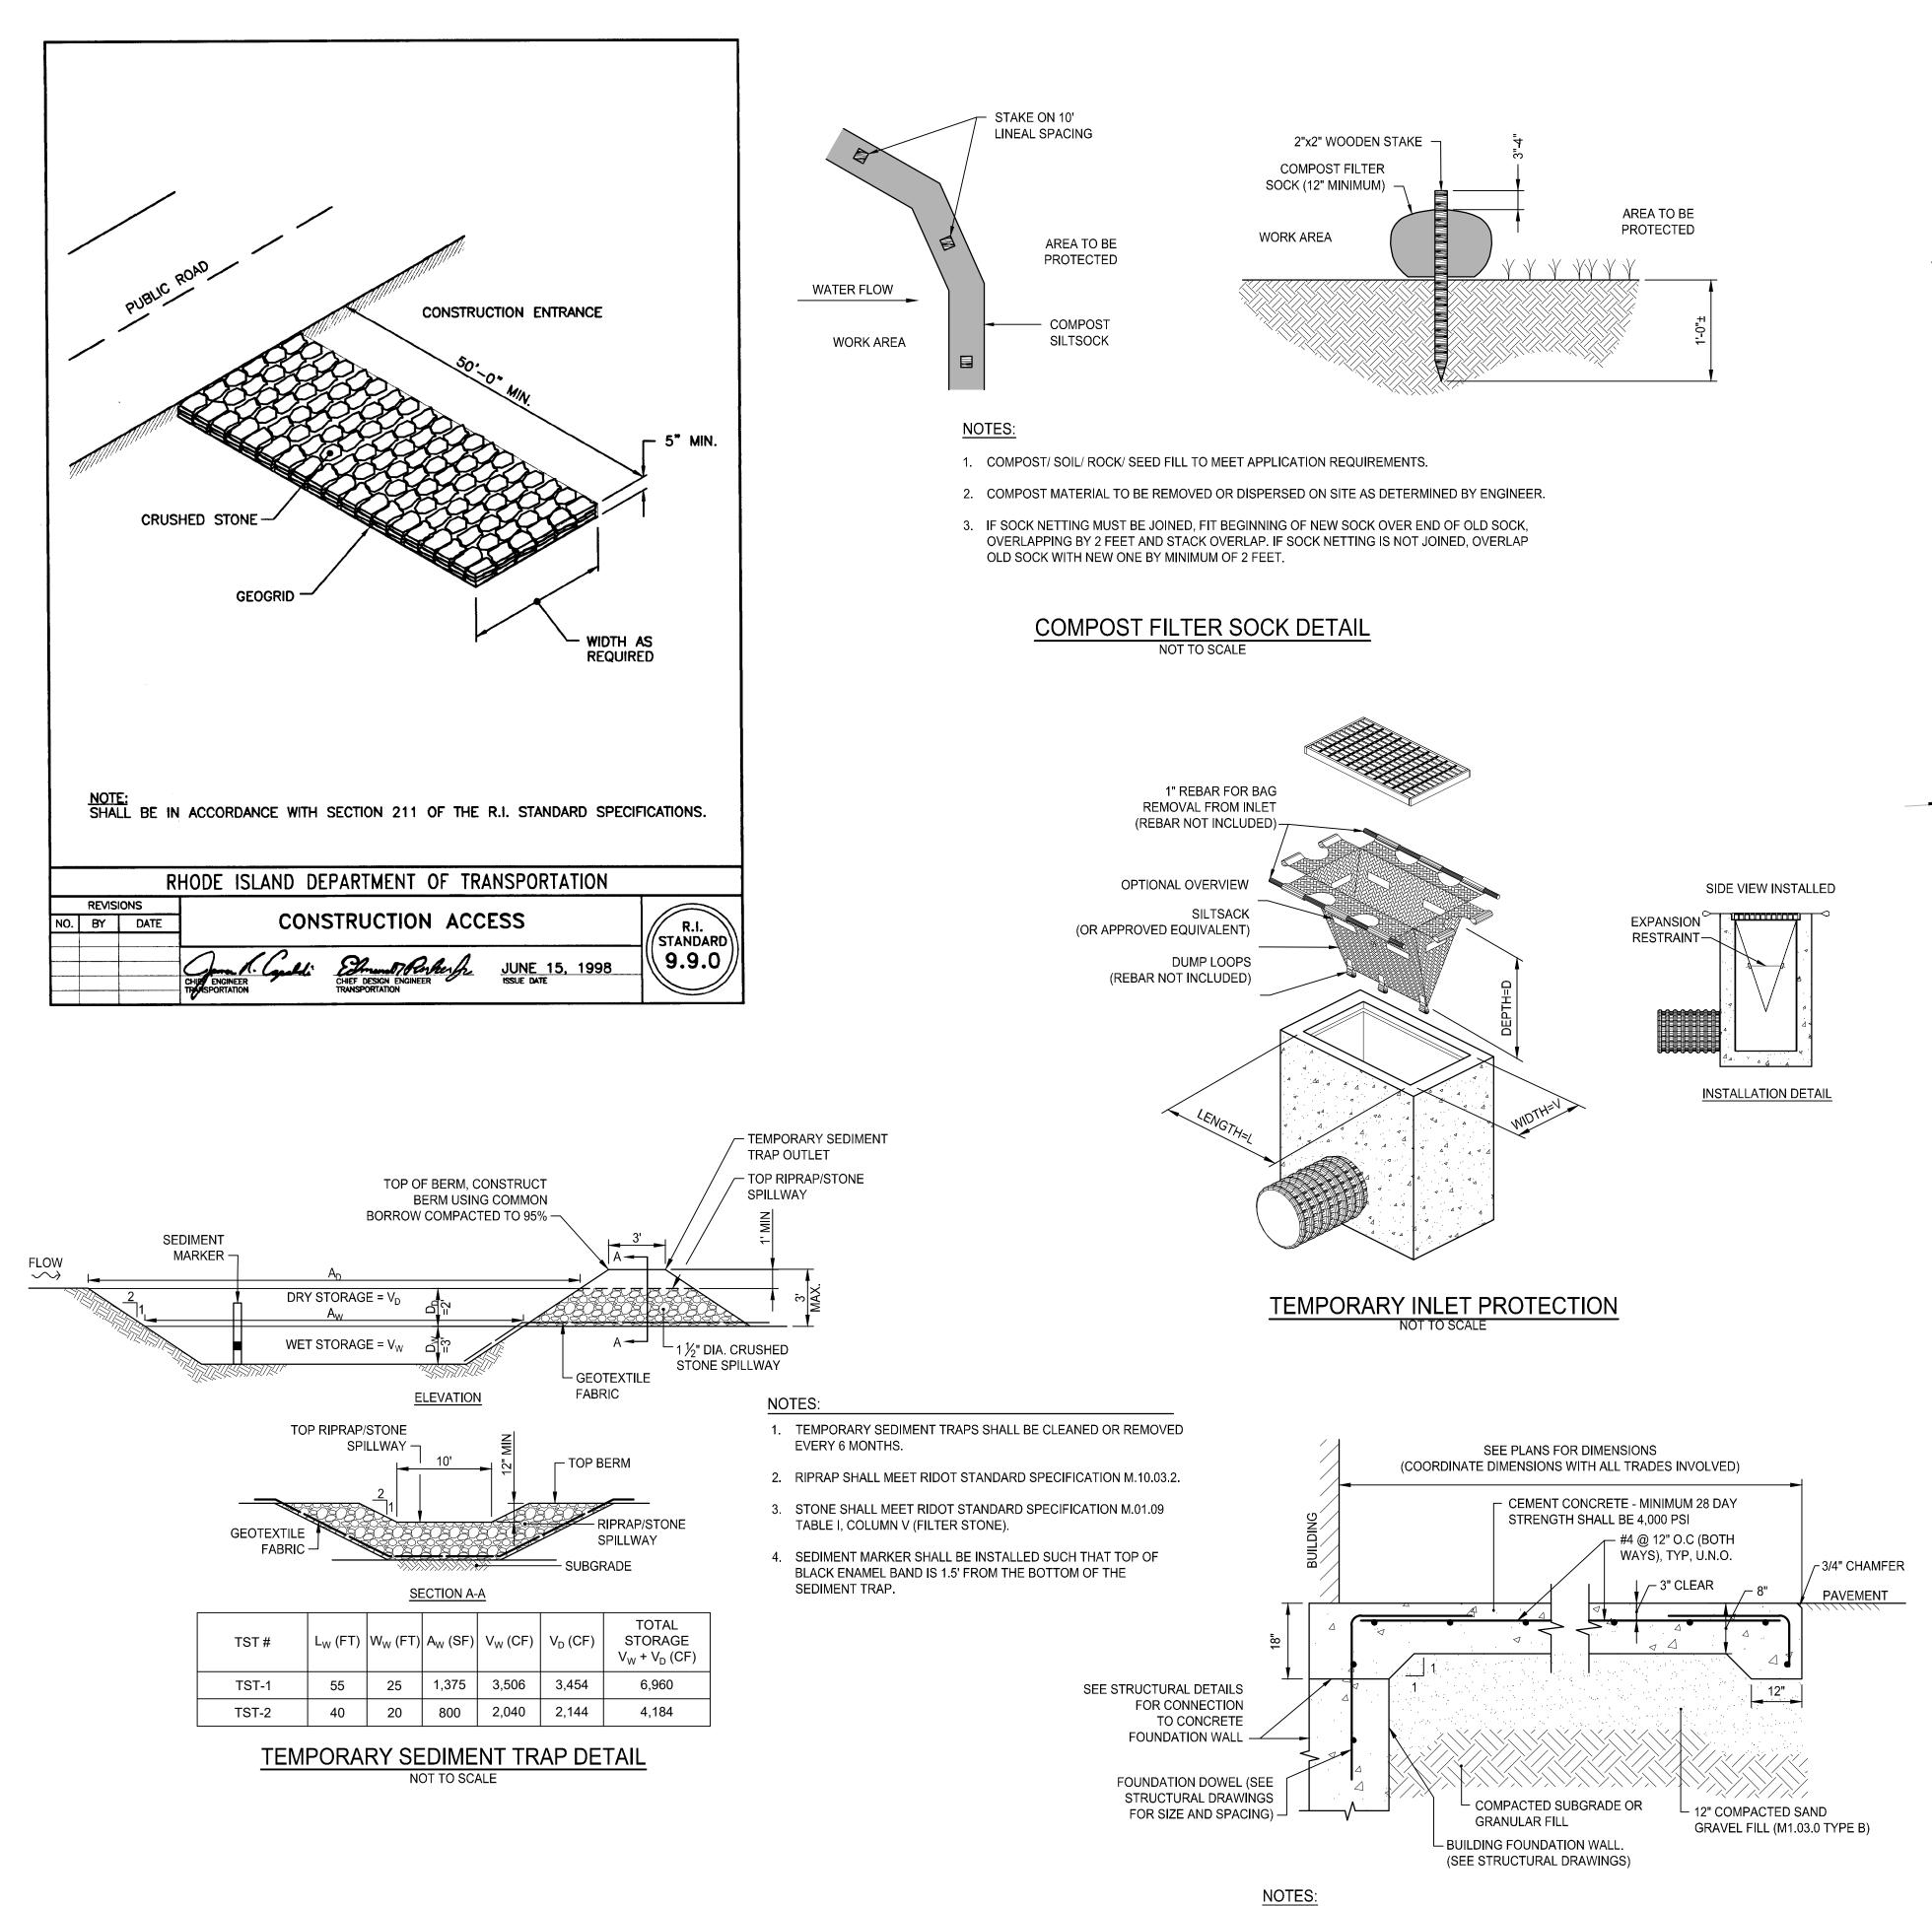


1. SEE PLANS FOR LOCATIONS.

OF 3" CLEARANCE FROM FACE OF CONCRETE.

2. REINFORCING TO BE #4 GRADE 60 BARS AND SHALL CONFORM TO ASTM STANDARD A-615 OF THE

LATEST DATE. REINFORCING RODS TO BE LOCATED IN THE CENTER OF THE SLAB, WITH A MINIMUM

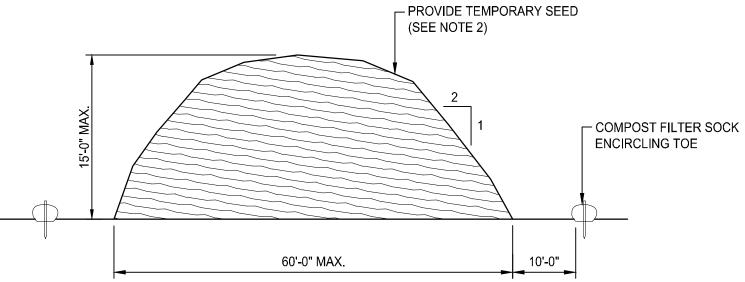



NOTES:


1. STOCKPILE AREA SHALL NOT EXCEED SPECIFIED DIMENSIONS WITHOUT APPROVAL FROM ENGINEER.

- 2. STOCKPILED ERODIBLE MATERIAL THAT WILL NOT BE USED FOR GREATER THAN 14 DAYS SHALL BE STABILIZED WITH TEMPORARY SEED IMMEDIATELY FOLLOWING PLACEMENT. USE RIDOT STD. M.18.10.5 SEED MIX.
- 3. CONTRACTOR SHALL NOT PLACE SOIL STOCKPILES OVER EXISTING UTILITIES OR MANHOLES WITHOUT PERMISSION FROM UTILITY COMPANY, CONTRACTOR IS RESPONSIBLE TO CONFIRM STOCKPILES DO NOT IMPACT UNDERGROUND UTILITIES.

 ERODIBLE MATERIAL STOCKPILE

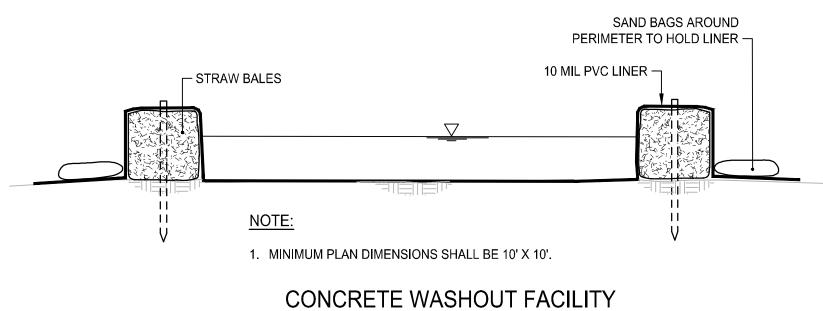

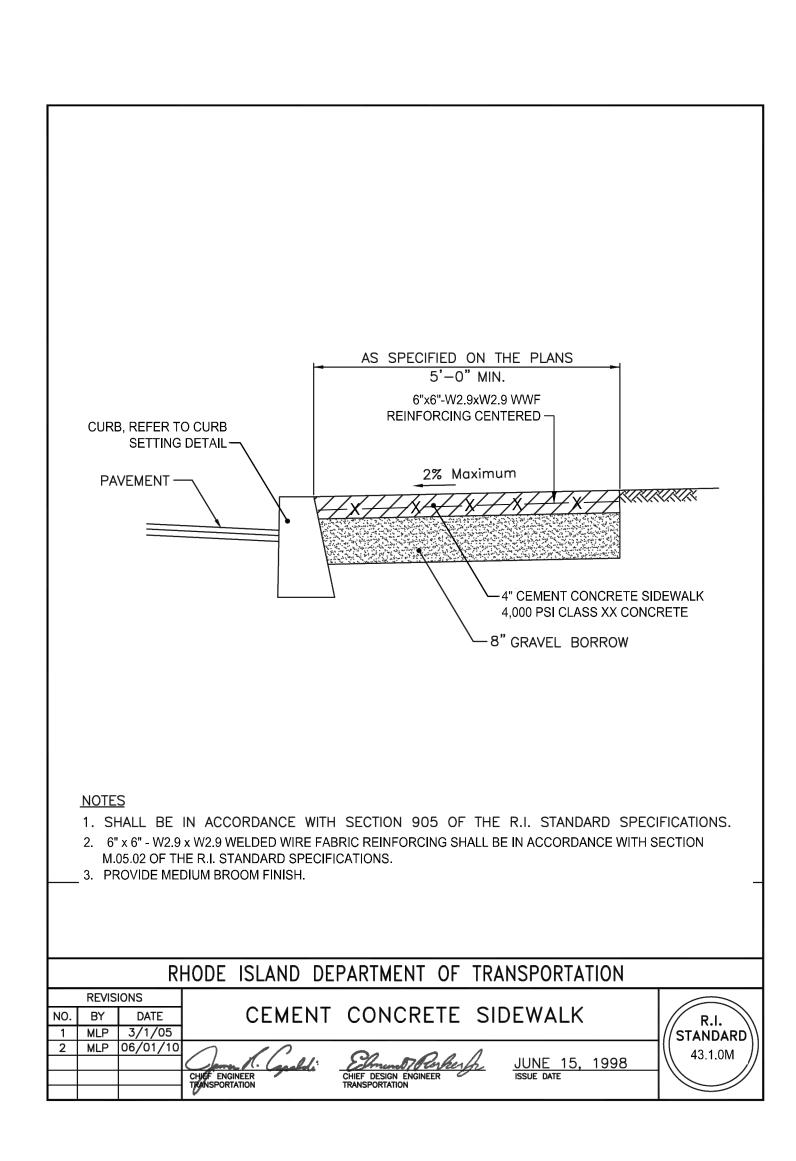

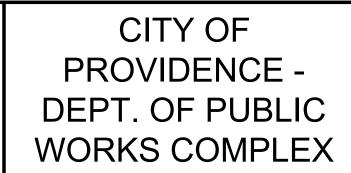

20 Ernest St, Providence, RI 02905

PROVIDENCE PUBLIC BUILDINGS AUTHORITY

Owner:

Providence Department of Public Works 20 Ernest Street



OWNERSHIP AND USE OF DOCUMENTS, DRAWINGS AND SPECIFICATIONS AS INSTRUMENTS OF PROFESSIONAL SERVICE, ARE, AND SHALL REMAIN, THE PROPERTY OF THE ARCHITECT. THESE DOCUMENTS ARE NOT TO BE USED, IN WHOLE OR IN PART, FOR ANY OTHER PROJECTS OR PURPOSES, OR BY ANY OTHER PARTIES THAN THOSE PROPERLY AUTHORIZED BY CONTRACT WITHOUT THE EXPRESS AUTHORIZATION OF THE ARCHITECT.




GENERAL NOTES

1. CONTRACTOR SHALL VISIT SITE, PRIOR TO BID, AND CAREFULLY INVESTIGATE AND EXAMINE THE AREA OF WORK SO AS TO SATISFY HIMSELF AS TO THE NATURE AND LOCATION OF THE WORK. CONTRACTOR TO NOTE THE CHARACTER, QUALITY, QUANTITIES OF MATERIALS REQUIRED AND DIFFICULTIES TO BE ENCOUNTERED, THE KIND AND EXTENT OF EQUIPMENT AND FACILITIES NEEDED FOR PERFORMANCE OF THE WORK AND OTHER ITEMS WHICH MAY, IN ANY WAY, AFFECT THE WORK OR CONTRACTOR'S

DRAWINGS DO NOT INCLUDE NECESSARY COMPONENTS FOR CONSTRUCTION SAFETY.

MAJOR LAND DEVELOPMENT APPLICATION SUBMISSION

NOT FOR CONSTRUCTION

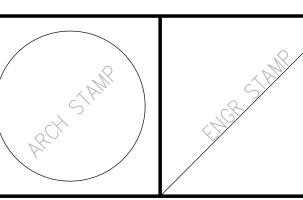

Date: 01–17–2025


Drawn by: Proj. Mgr.:

Revisions

No. Date Description

DETAILS 1

C6.1

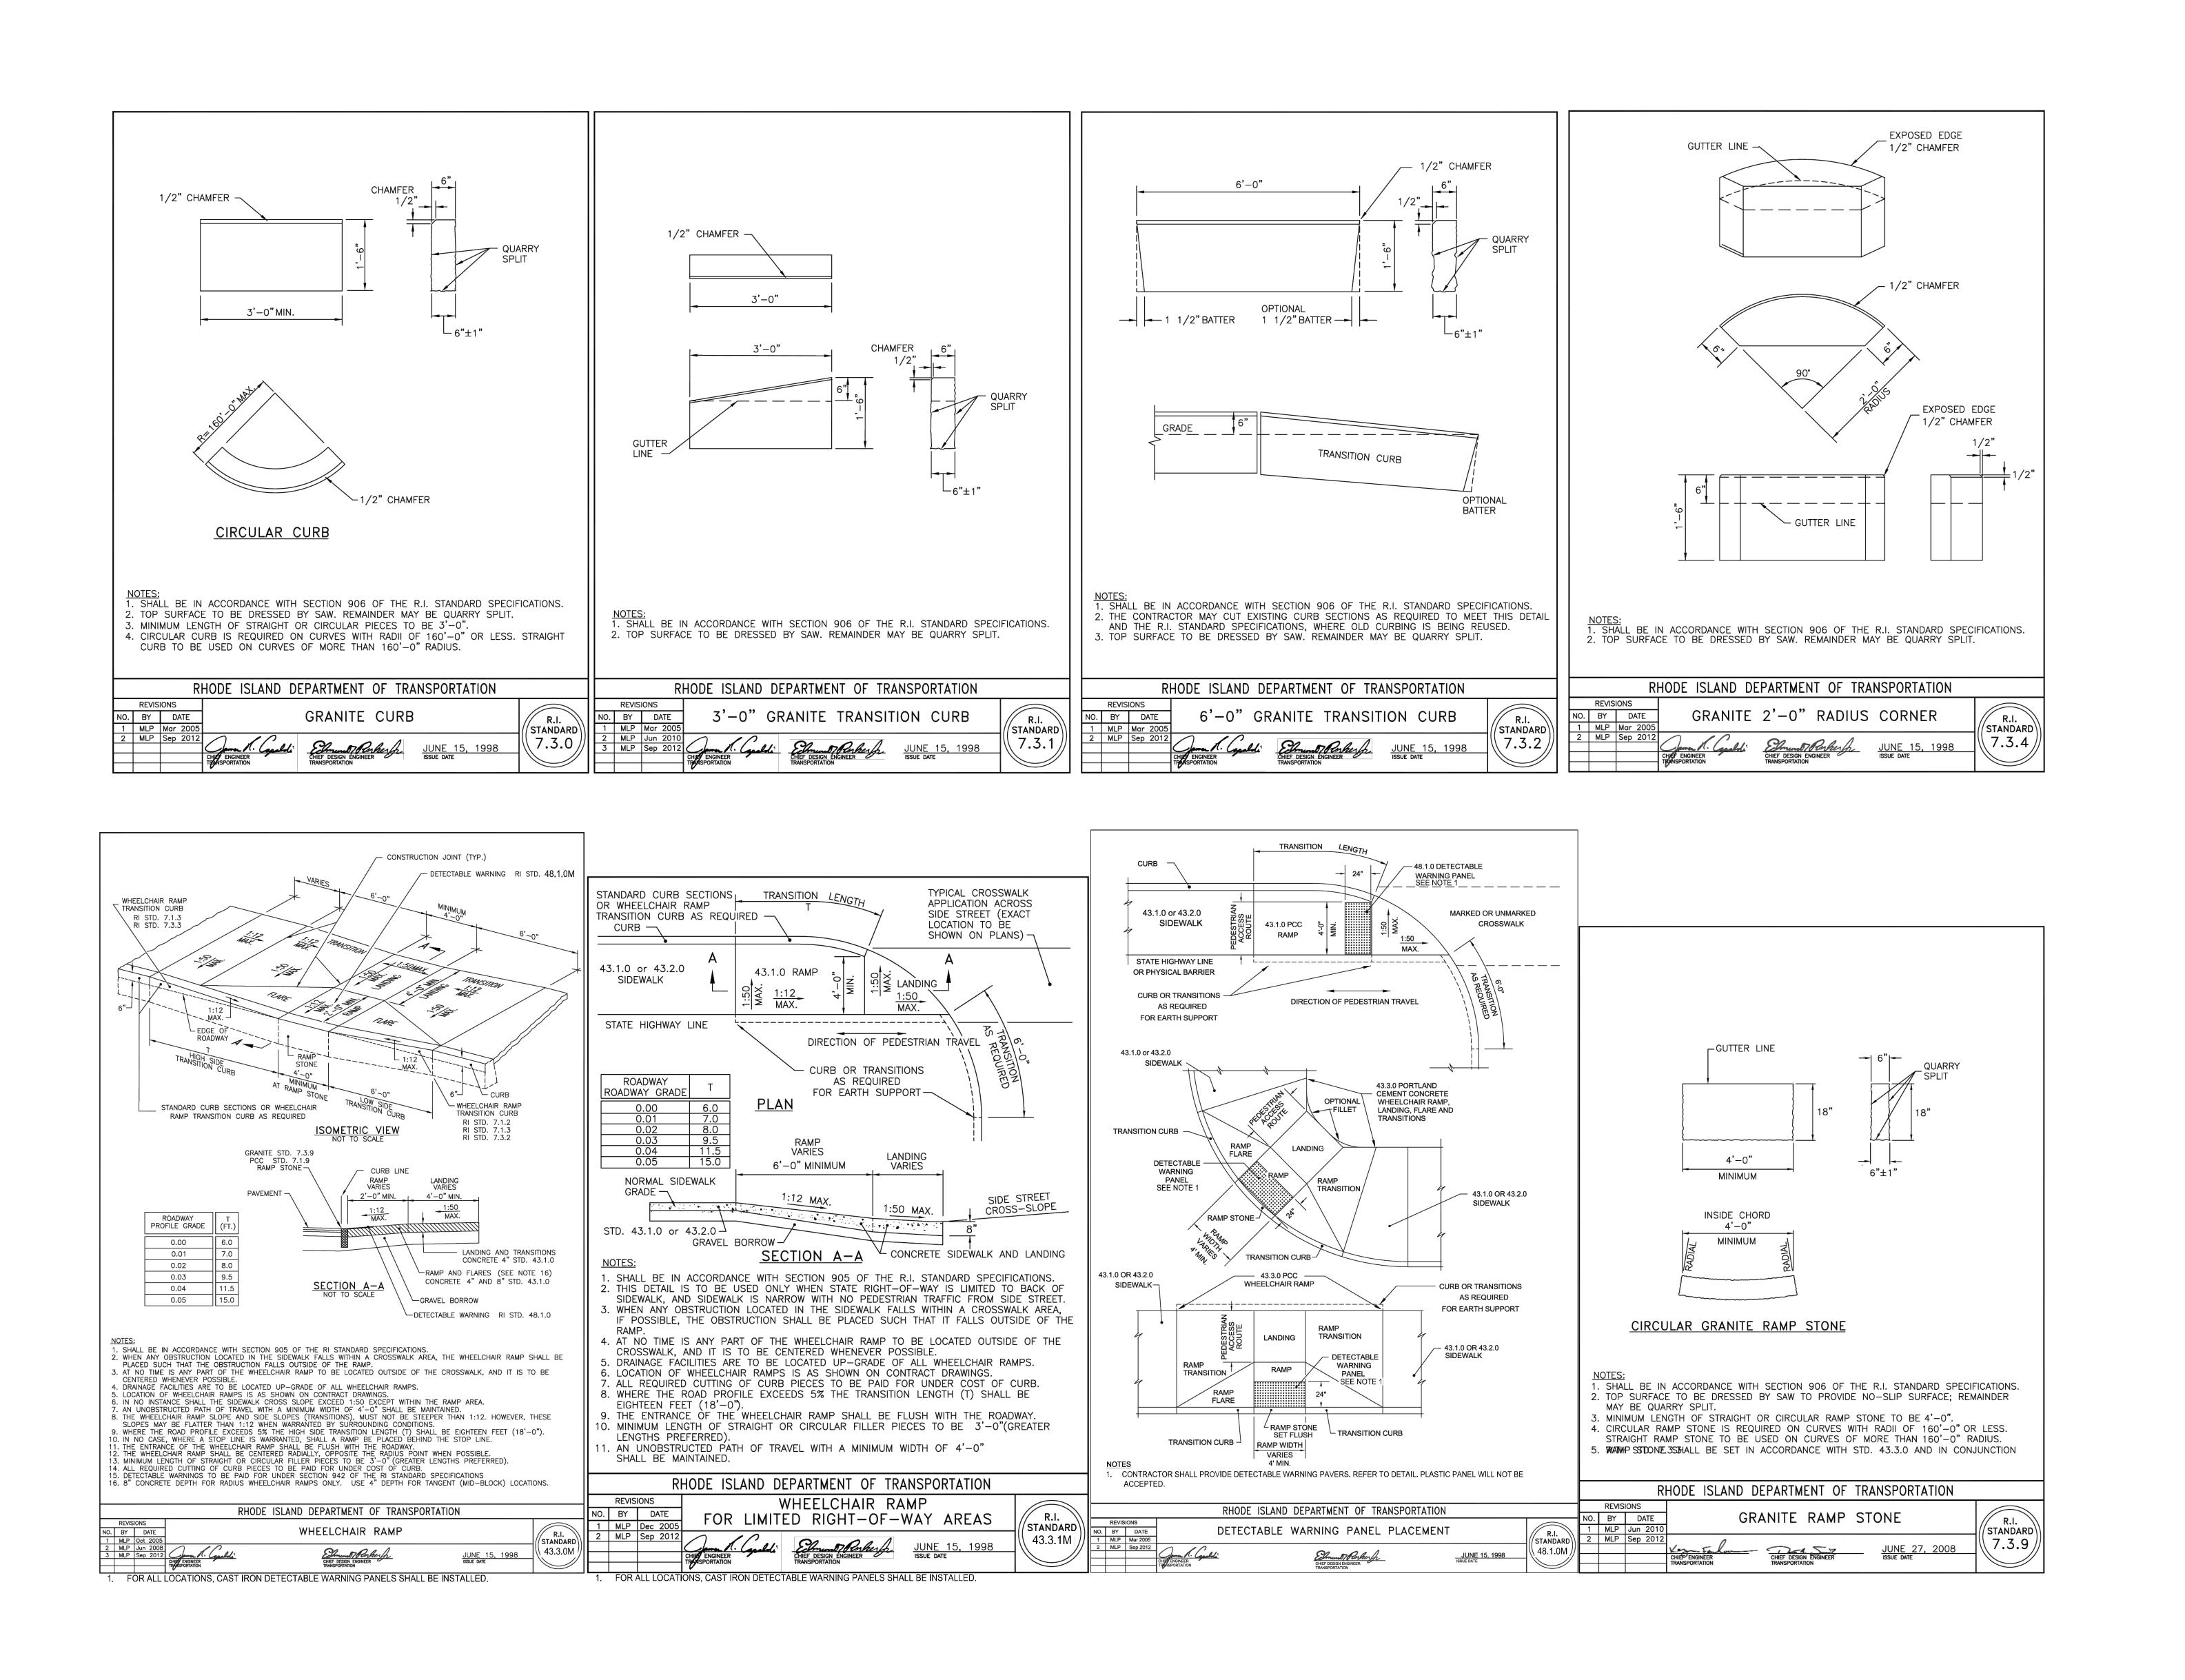

20 Ernest St, Providence, RI 02905

Owner:
Providence Department of Public Works
20 Ernest Street
Providence, RI 02905



400 Massasoit Avenue,
Suite 300, Second Floor
East Providence, Rhode Island
p. (401) 331-9200

2 Hampshire Street,
Suite 106, First Floor
Foxboro, Massachusetts
p. (774) 215-0290
rowse@rowsearchitects.com

OWNERSHIP AND USE OF DOCUMENTS, DRAWINGS AND SPECIFICATIONS AS INSTRUMENTS OF PROFESSIONAL SERVICE, ARE, AND SHALL REMAIN, THE PROPERTY OF THE ARCHITECT. THESE DOCUMENTS ARE NOT TO BE USED, IN WHOLE OR IN PART, FOR ANY OTHER PROJECTS OR PURPOSES, OR BY ANY OTHER PARTIES THAN THOSE PROPERLY AUTHORIZED BY CONTRACT WITHOUT THE EXPRESS AUTHORIZATION OF THE ARCHITECT.




GENERAL NOTES

1. CONTRACTOR SHALL VISIT SITE, PRIOR TO BID, AND CAREFULLY INVESTIGATE AND EXAMINE THE AREA OF WORK SO AS TO SATISFY HIMSELF AS TO THE NATURE AND LOCATION OF THE WORK. CONTRACTOR TO NOTE THE CHARACTER, QUALITY, QUANTITIES OF MATERIALS REQUIRED AND DIFFICULTIES TO BE ENCOUNTERED, THE KIND AND EXTENT OF EQUIPMENT AND FACILITIES NEEDED FOR PERFORMANCE OF THE WORK AND OTHER ITEMS WHICH MAY, IN ANY WAY, AFFECT THE WORK OR CONTRACTOR'S

DRAWINGS DO NOT INCLUDE NECESSARY COMPONENTS FOR

MAJOR LAND DEVELOPMENT APPLICATION SUBMISSION


NOT FOR CONSTRUCTION

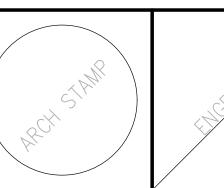


Date	: 01-17-202	25
Drav	vn by:	Proj. Mgr.:
Revi	sions	
No.	Date	Description

DETAILS 2

<u>C6.2</u>

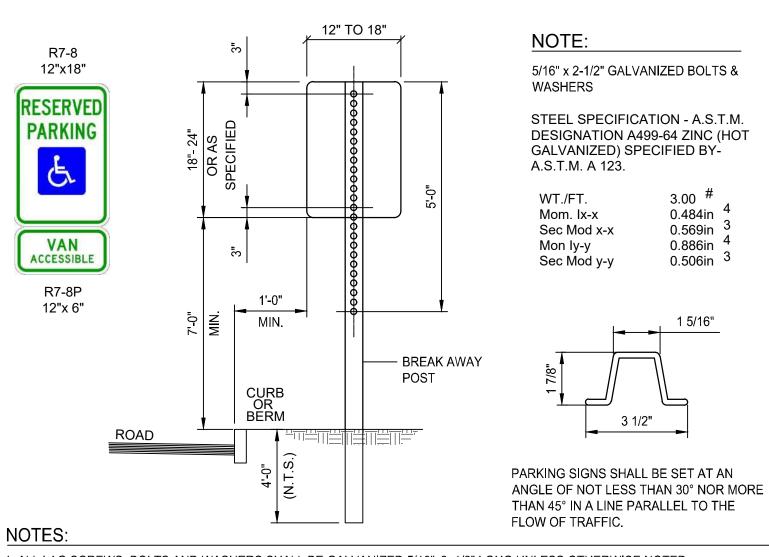

- 1. ALL LAG SCREWS, BOLTS AND WASHERS SHALL BE GALVANIZED 5/16"x2 1/2" LONG UNLESS OTHERWISE NOTED.
- 2. WASHERS SHALL BE 0.07" THICK.
- 3. ALL SIGN COLORS, RADII AND BORDERS AS SPECIFIED IN "MANUAL ON UNIFORM TRAFFIC CONTROL DEVICES."
- 4. SHALL BE IN ACCORDANCE WITH SECTION T.15 OF THE STANDARD SPECIFICATIONS.
- 5. PARKING SIGNS SHALL BE SET AT AN ANGLE OF NOT LESS THAN 30° NOT MORE THAN 45° WITH A LINE PARALLEL TO FLOW OF TRAFFIC, 1'-6" (1'-0" MIN.) FROM THE EDGE OF CURB FACE.
- 6. ALL ACCESSIBLE PARKING AND SIGNAGE SHALL BE IN CONFORMANCE WITH THE RULES & REGULATIONS AS SPECIFIED BY THE AMERICAN DISABILITIES ACT (ADA).
- 7. SIGN(S) SHALL BE LOCATED SO THEY CANNOT BE OBSCURED BY A VEHICLE PARKED IN THE SPACE.
- 8. FOR ACCESSIBLE VAN SPACE USE SIGN AS DETAILED.
- 9. FOR ACCESSIBLE SPACE FOR AUTOMOBILES USE ONLY HANDICAPPED PARKING SIGN. ACCESSIBLE SIGN MOUNTING

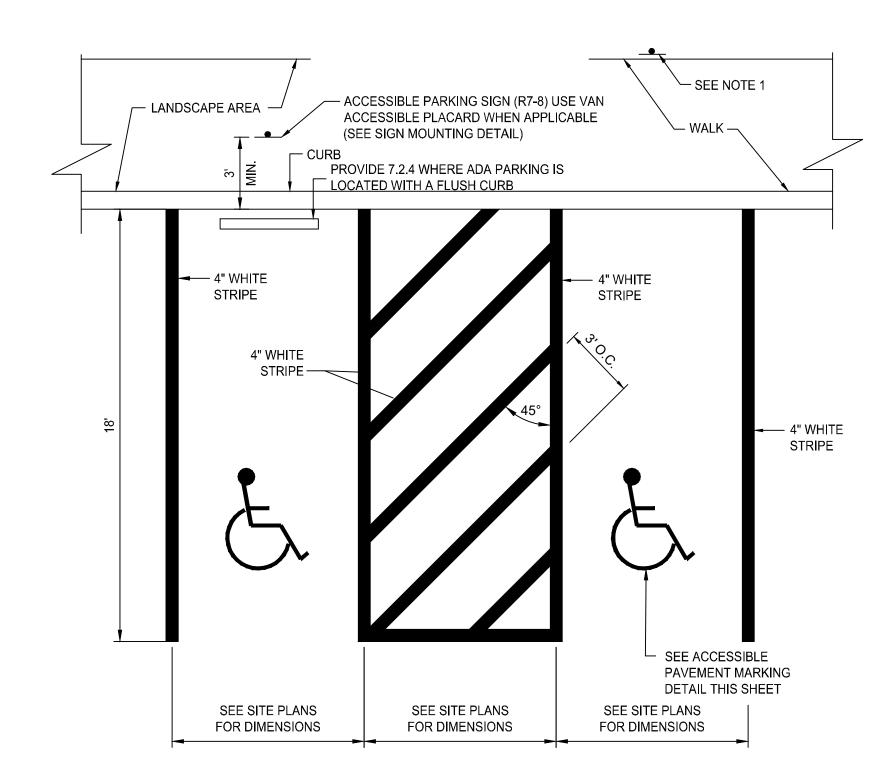

WHERE STALLS ABUT SIDEWALK, PARKING SIGNS SHOULD BE PLACED AT BACK EDGE OF SIDEWALK.

2. ALL PAVEMENT MARKINGS TO BE EPOXY RESIN.

ACCESSIBLE PARKING STALLS @ 90°

ACCESSIBLE PARKING AND SIGNAGE SHALL BE IN CONFORMANCE WITH THE RULES & REGULATIONS OF THE AMERICANS WITH DISABILITIES ACT. ACCESSIBLE PAVEMENT MARKING NOT TO SCALE CURB OR EDGE OF PAVEMENT 1. COORDINATE PAVEMENT MARKING COLORS WITH PLANS. 2. ALL PARKING PAVEMENT MARKINGS SHALL BE EPOXY RESIN, CONFORMING TO THE SPECIFICATIONS.


6" INSIDE DIA. STEEL PIPE, PIPE SHALL CONTINUE THE LENGTH OF FOOTING (FILL WITH CONCRETE) FURNISH AND INSTALL PLASTIC SLEEVE, COORDINATE COLOR WITH OWNER AND ARCHITECT PLASTIC SLEEVE AT EVCS SHALL BE GREEN --FINISHED GRADE COMPACTED SAND , GRAVEL FILL ---3,000 PSI CONCRETE FOOTING — 18"Ø SONOTUBE FORM—— 6" SAND GRAVEL FILL EXISTING SUBGRADE ----

BOLLARD DETAIL

NOT TO SCALE

TYPICAL PARKING STALL


NOT TO SCALE

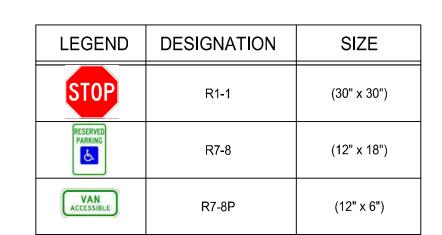

- NOTE:


 1. SIGNS SHALL BE CONSTRUCTED OF TYPE III REFLECTORIZED SHEETING AND IN ACCORDANCE WITH MUTCD REQUIREMENTS, LATEST REVISION.
- 2. THE CONTRACTOR SHALL SUBMIT SAMPLE SIGNS TO THE OWNER FOR APPROVAL PRIOR TO FURNISHING.
- 3. LETTERS, COLOR, AND FONT FOR NON-STANDARD SIGNS SHALL BE SELECTED BY THE OWNER.
- 4. R7-8 AND R7-8P SHALL CONFORM TO ACCESSIBLE SIGN MOUNTING DETAIL.


SIGN SCHEDULE

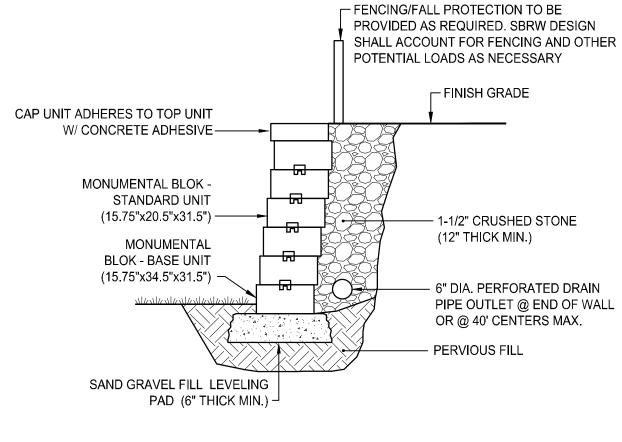


- 1. CONTRACTOR SHALL PROVIDE A DESIGN FOR THE PROPOSED WALL PREPARED AND STAMPED BY A PROFESSIONAL ENGINEER REGISTERED IN THE STATE OF RHODE ISLAND.
- 2. WALL DESIGN SHALL CONFORM TO MANUFACTURER'S REQUIREMENTS. WALL DESIGN SHALL INCORPORATE PROPOSED GUARDRAIL WHERE INDICATED ON PLANS.

SEGMENTAL BLOCK RETAINING WALL DETAIL

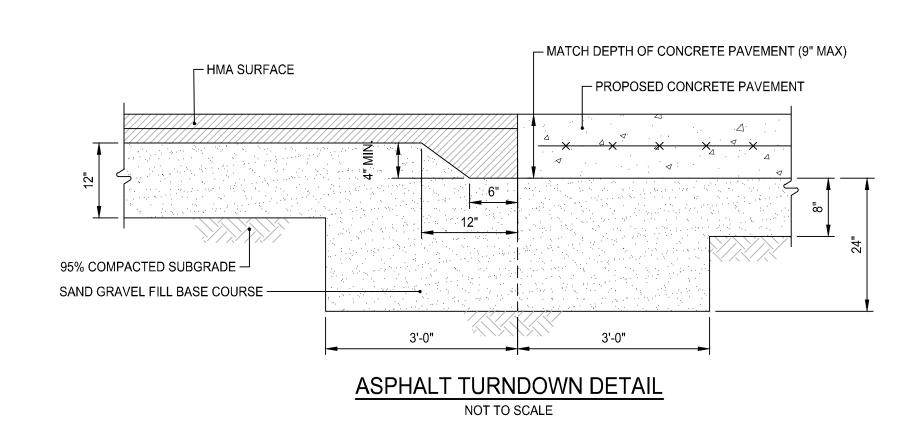

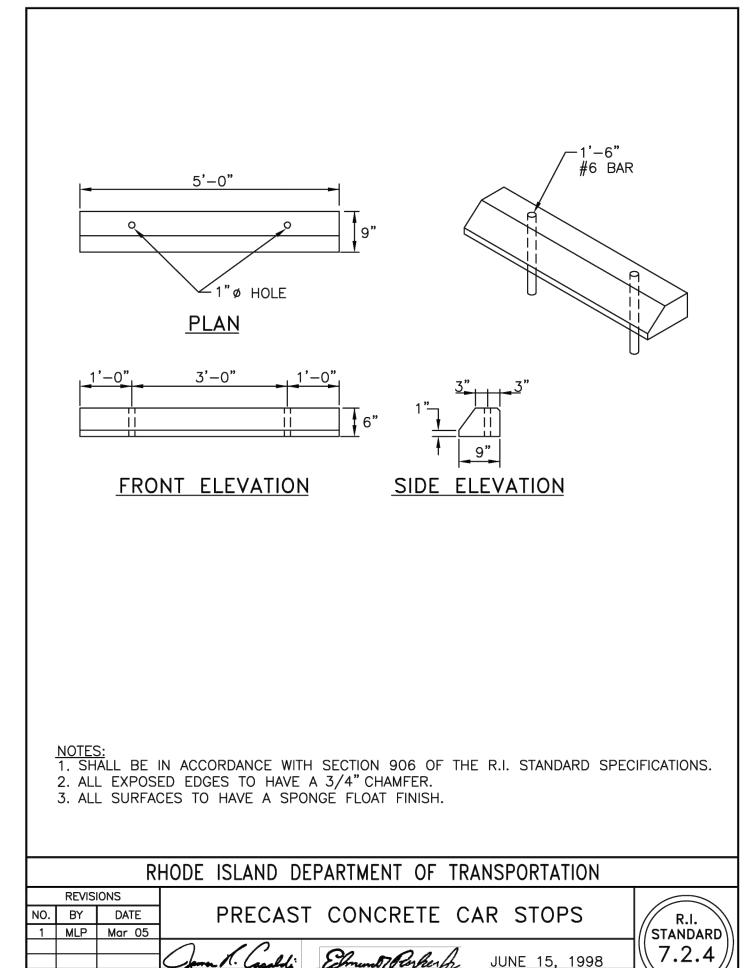

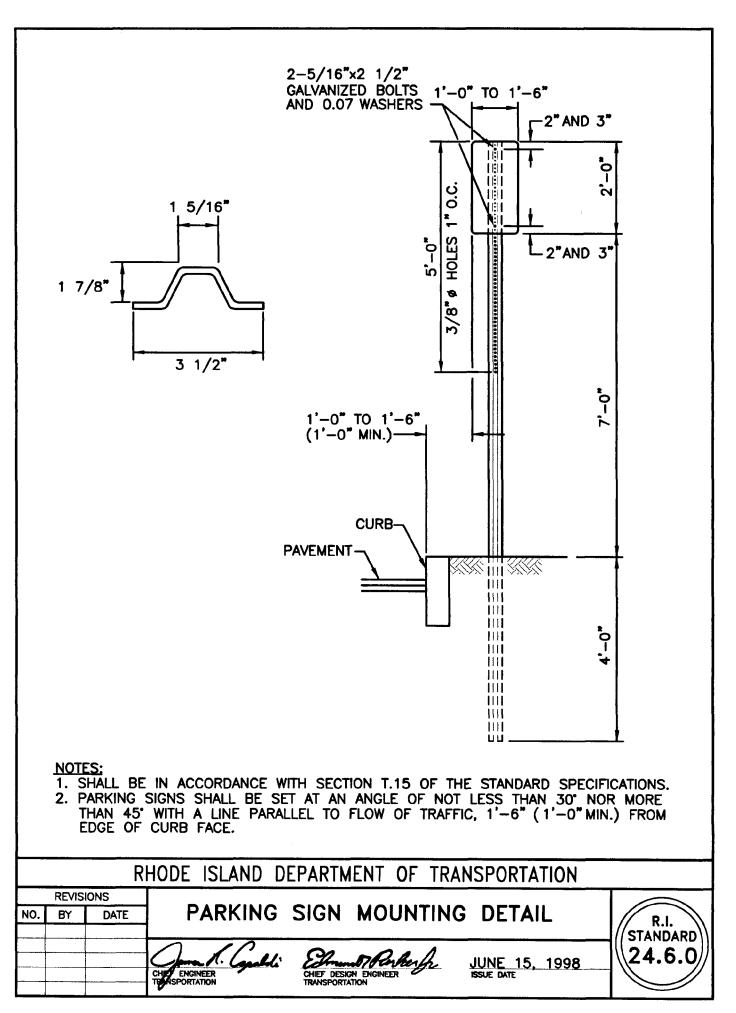

CITY OF PROVIDENCE -DEPT. OF PUBLIC **WORKS COMPLEX**

20 Ernest St, Providence, RI 02905

Owner: Providence Department of Public Works 20 Ernest Street Providence, RI 02905



OWNERSHIP AND USE OF DOCUMENTS, DRAWINGS AND SPECIFICATIONS AS INSTRUMENTS OF PROFESSIONAL SERVICE, ARE, AND SHALL REMAIN, THE PROPERTY OF THE ARCHITECT. THESE DOCUMENTS ARE NOT TO BE USED, IN WHOLE OR IN PART. FOR ANY OTHER PROJECTS OR PURPOSES, OR BY ANY OTHER PARTIES THAN THOSE PROPERLY AUTHORIZED BY CONTRACT

WITHOUT THE EXPRESS AUTHORIZATION OF THE ARCHITECT.




GENERAL NOTES

. CONTRACTOR SHALL VISIT SITE, PRIOR TO BID, AND CAREFULLY INVESTIGATE AND EXAMINE THE AREA OF WORK SO AS TO SATISFY HIMSELF AS TO THE NATURE AND LOCATION OF THE WORK. CONTRACTOR TO NOTE THE CHARACTER, QUALITY, QUANTITIES OF MATERIALS REQUIRED AND DIFFICULTIES TO BE ENCOUNTERED THE KIND AND EXTENT OF EQUIPMENT AND FACILITIES NEEDED FOR PERFORMANCE OF THE WORK AND OTHER ITEMS WHICH MAY, IN ANY WAY, AFFECT THE WORK OR CONTRACTOR'S


2. DRAWINGS DO NOT INCLUDE NECESSARY COMPONENTS FOR CONSTRUCTION SAFETY.


> MAJOR LAND DEVELOPMENT APPLICATION SUBMISSION


NOT FOR CONSTRUCTION

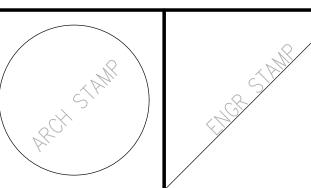



Proj. Mgr.: Drawn by: Revisions No. Date Description

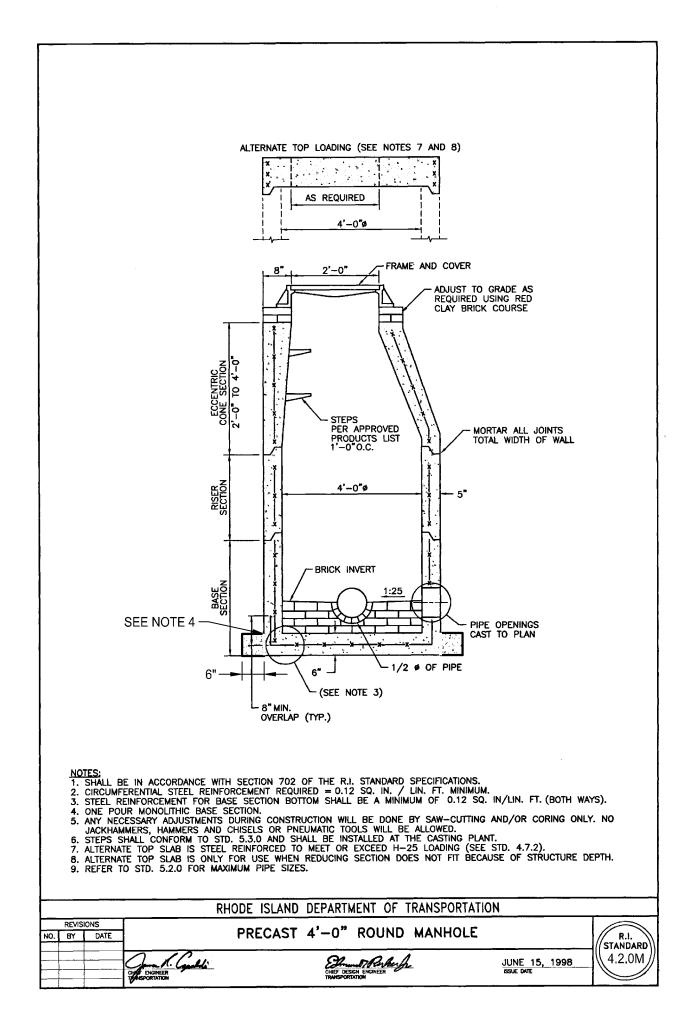


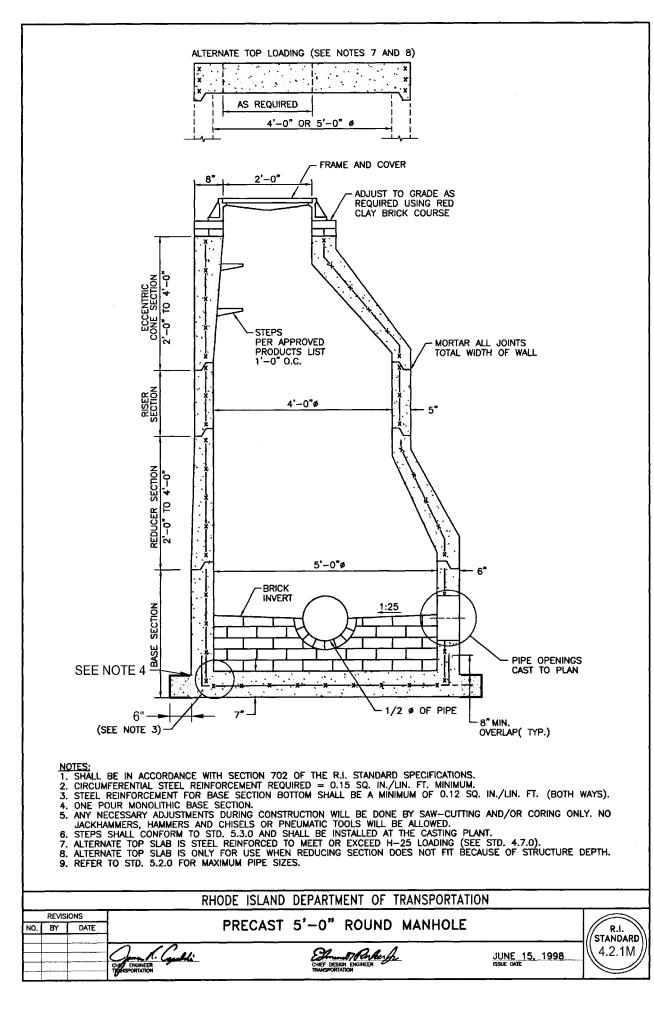


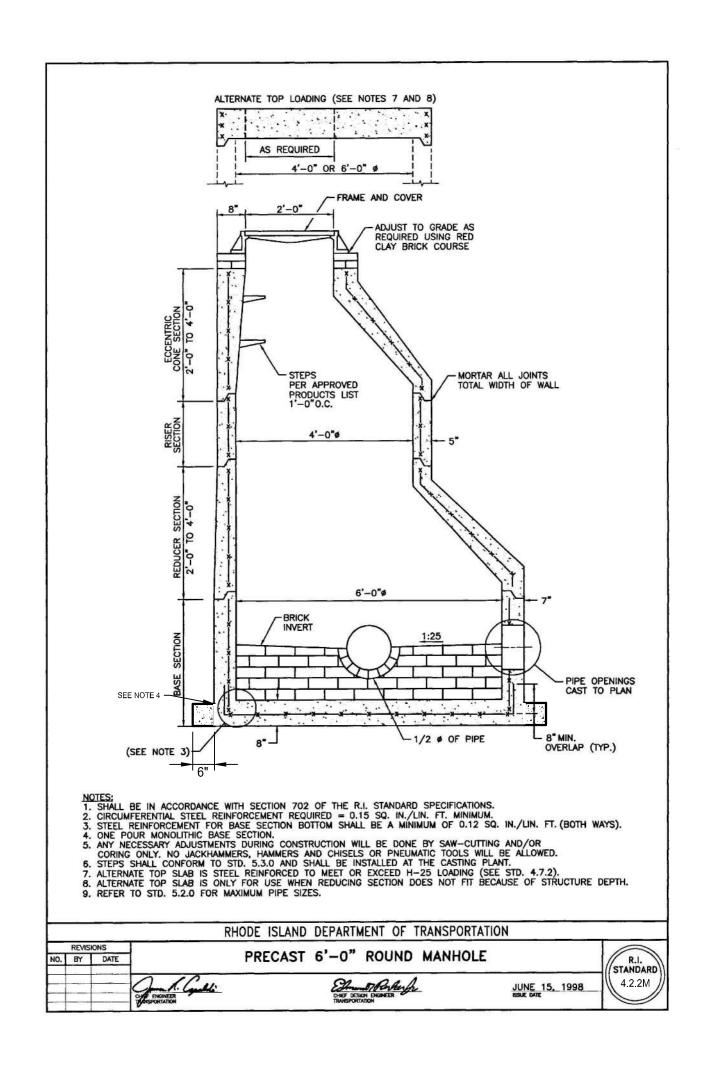

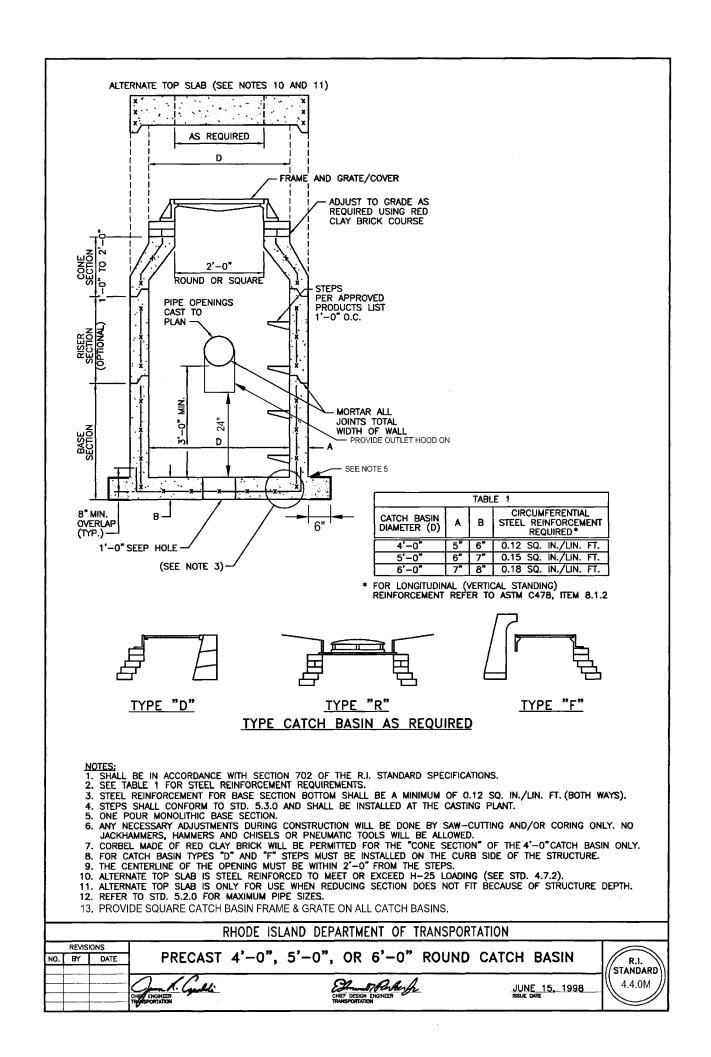

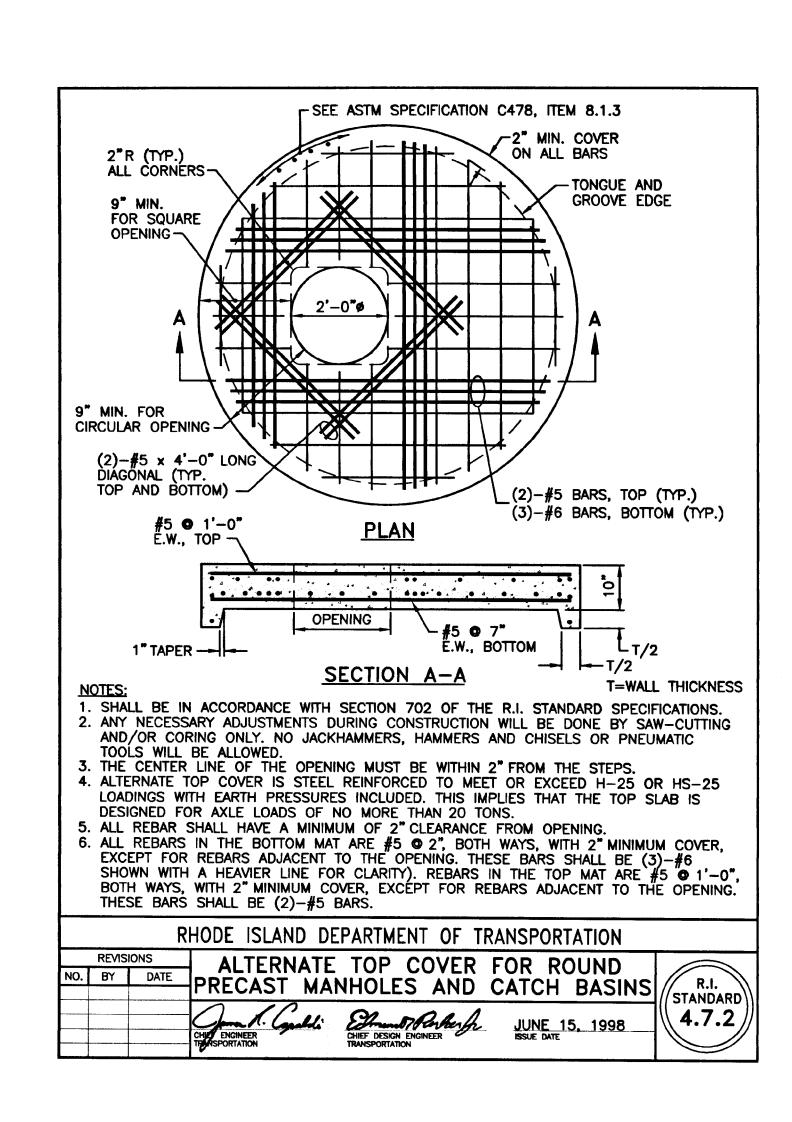


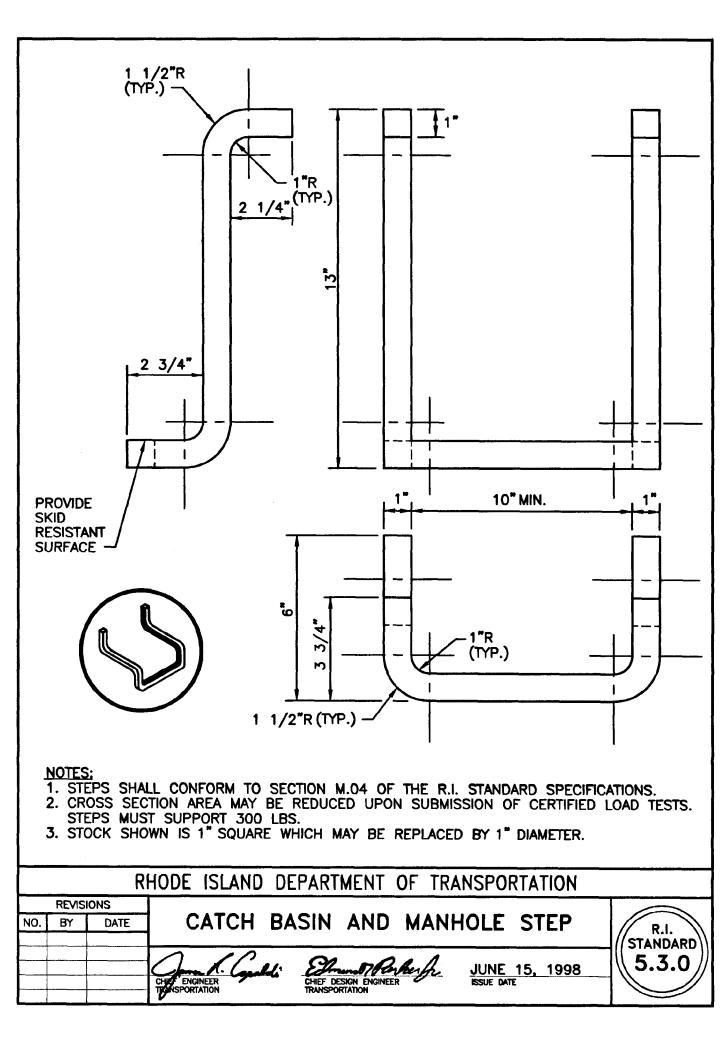

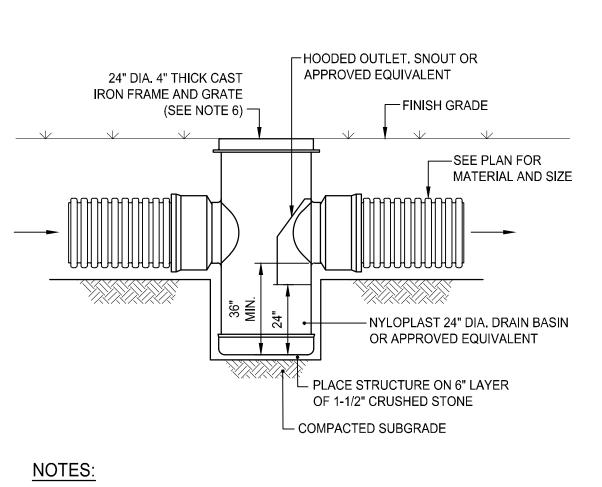


- 1. DRAIN BASIN SHALL BE CUSTOM MANUFACTURED FOR THE PROJECT WITH THE INLETS AND OUTLETS REQUIRED.
- 2. STRUCTURES SHALL BE CONSTRUCTED TO WITHSTAND LOADS IMPOSED BY CONSTRUCTION VEHICLES.
- 3. DRAIN BASIN SHALL BE CONSTRUCTED OF HIGH DENSITY POLYETHYLENE.
- 4. PROVIDE HOODED OUTLET ON ALL DRAIN BASINS
- 5. FRAME AND GRATE SHALL BE CONSTRUCTED OF DUCTILE IRON AND CONFORM TO ASTM A536 GRADE 70-50-05. PROVIDE NYLOPLAST S499CGS OR APPROVED EQUIVALENT.
- 6. PROVIDE DOME GRATE FOR ALL AREA DRAINS AS NOTED ON PLANS. PROVIDE NYLOPLAST 2499CGD OR APPROVED EQUIVALENT. SET TOP FRAME AT RIM ELEVATION

AREA DRAIN DETAIL NOT TO SCALE

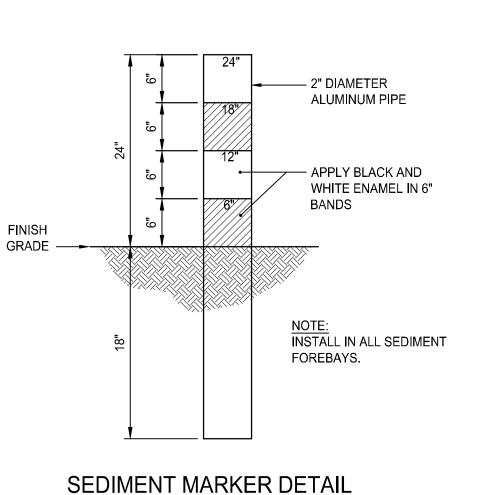

NOT TO SCALE

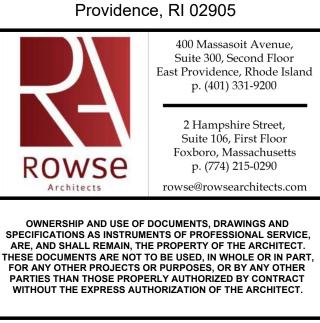

CITY OF

PROVIDENCE -

DEPT. OF PUBLIC

WORKS COMPLEX

20 Ernest St, Providence, RI 02905

Owner:

Providence Department of Public Works 20 Ernest Street




GENERAL NOTES

CONTRACTOR SHALL VISIT SITE, PRIOR TO BID, AND CAREFULLY INVESTIGATE AND EXAMINE THE AREA OF WORK SO AS TO SATISFY HIMSELF AS TO THE NATURE AND LOCATION OF THE WORK. CONTRACTOR TO NOTE THE CHARACTER, QUALITY, QUANTITIES OF MATERIALS REQUIRED AND DIFFICULTIES TO BE ENCOUNTERED THE KIND AND EXTENT OF EQUIPMENT AND FACILITIES NEEDED FOR PERFORMANCE OF THE WORK AND OTHER ITEMS WHICH MAY, IN ANY WAY, AFFECT THE WORK OR CONTRACTOR'S


2. DRAWINGS DO NOT INCLUDE NECESSARY COMPONENTS FOR CONSTRUCTION SAFETY.

> MAJOR LAND **DEVELOPMENT APPLICATION** SUBMISSION

NOT FOR CONSTRUCTION

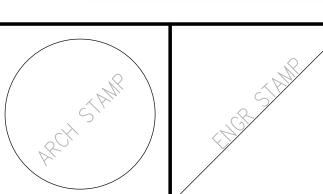


Date	: 01-17-202	5
Draw	n by:	Proj. Mgr.:
Revi	sions_	
No.	Date	Description
	1	

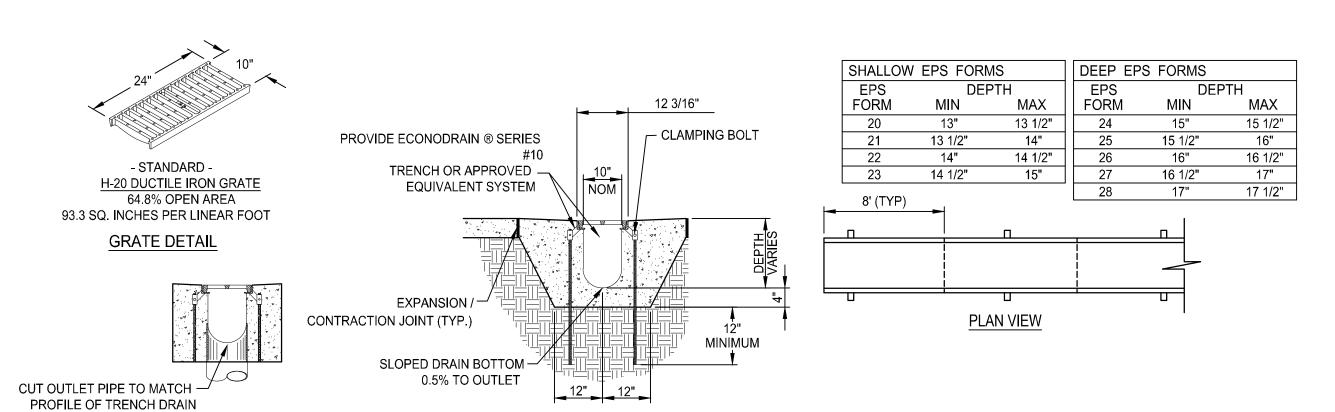


OUTLET FROM END OF TRENCH

- 1. INSTALLATION TO BE COMPLETED IN ACCORDANCE WITH
- MANUFACTURERS SPECIFICATIONS.
- 2. SECURE OUTLET PIPE PRIOR TO CONCRETING OPERATIONS. 3. TRENCH DRAIN AND GRATE SHALL BE RATED TO WITHSTAND
- H-20 LOADING CRITERIA.

TRENCH DRAIN DETAIL

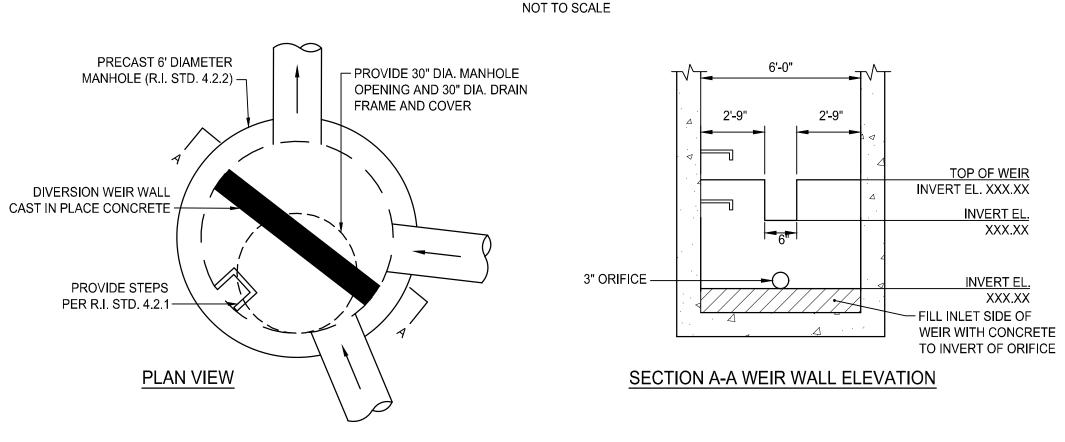


OUTLET CONTROL STRUCTURE (OCS) NOT TO SCALE

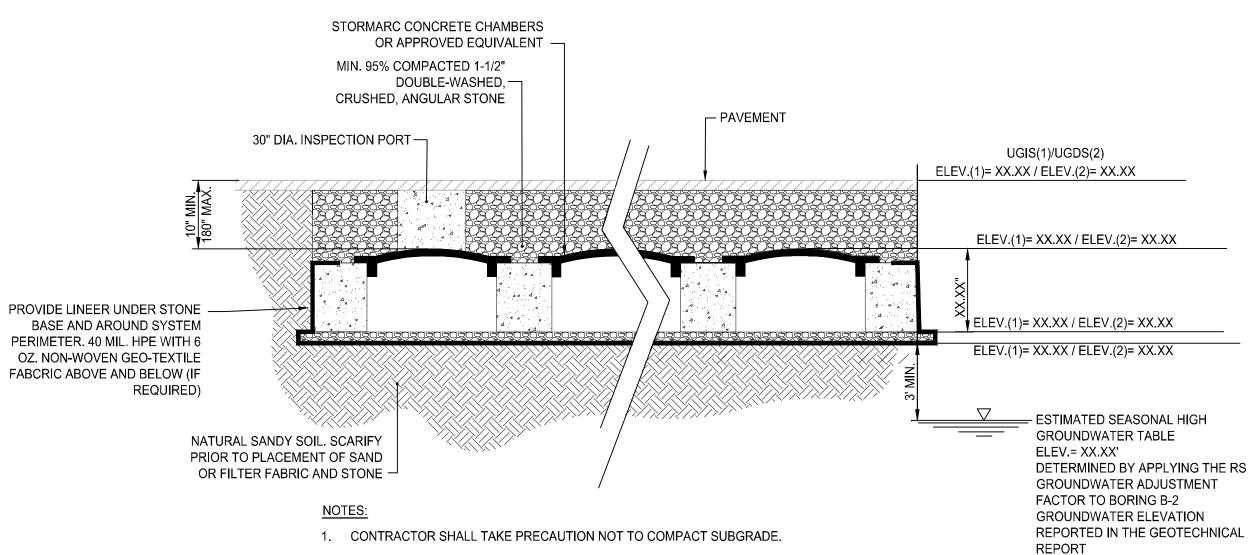


2. CONTRACTOR SHALL NOT PLACE OR OPERATE MACHINERY ON SUBGRADE.

- 3. CONTRACTOR SHALL NOTIFY ENGINEER (48 HRS MIN) PRIOR TO EXPOSING SUBGRADE TO SCHEDULE INSPECTION.
- 4. ONCE CONTRACTOR HAS SUBGRADE EXPOSED, THE ENGINEER SHALL BE CONTACTED FOR INSPECTION.
- 5. CONSTRUCTION OF THE SYSTEM SHALL NOT COMMENCE UNTIL ENGINEER INSPECTS SUBGRADE AND CRUSHED STONE AND GRANTS PERMISSION TO PROCEED.
- 6. CONTRACTOR SHALL INSTALL UNDERGROUND INFILTRATION SYSTEM PER MANUFACTURERS RECOMMENDATIONS.

UNDERGROUND INFILTRATION AND DETENTION SYSTEM DETAIL NOT TO SCALE

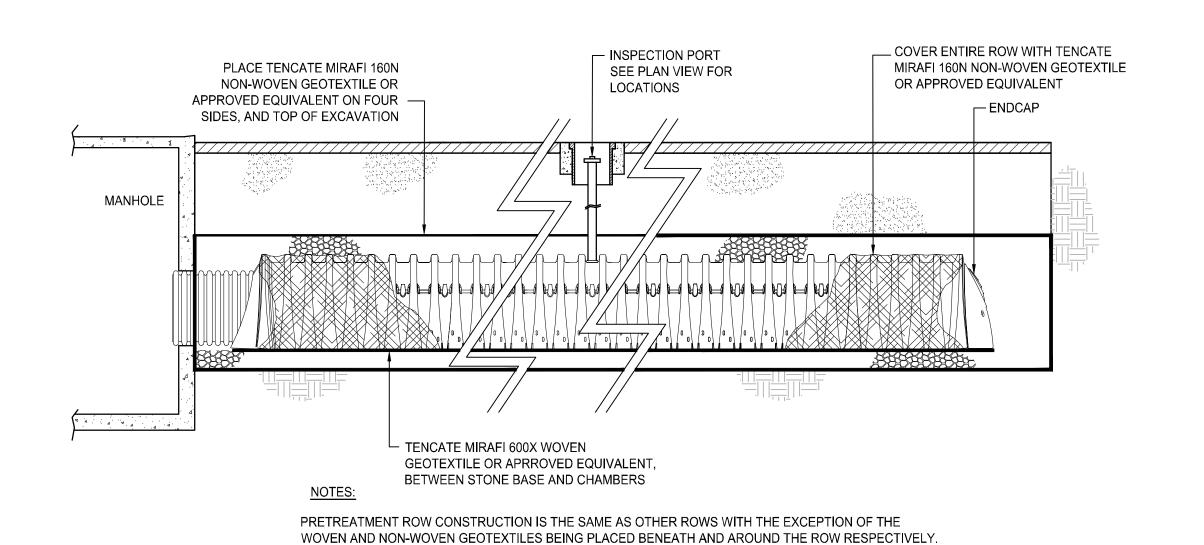


PRETREATMENT ROW DETAIL NOT TO SCALE

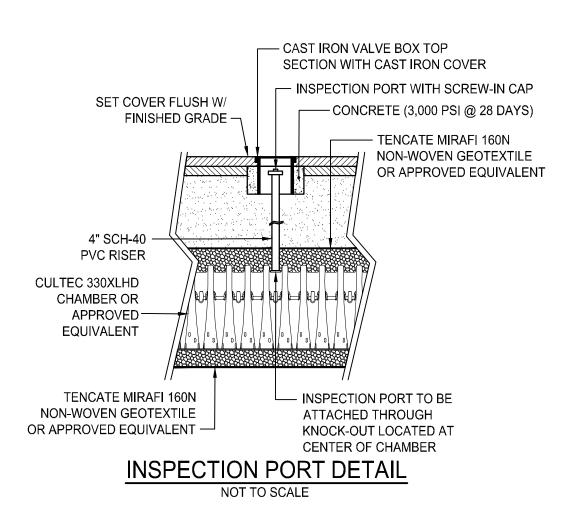

CITY OF PROVIDENCE -DEPT. OF PUBLIC **WORKS COMPLEX**

20 Ernest St, Providence, RI 02905

Owner: Providence Department of Public Works 20 Ernest Street Providence, RI 02905

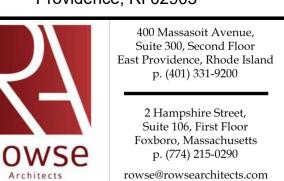

OWNERSHIP AND USE OF DOCUMENTS, DRAWINGS AND SPECIFICATIONS AS INSTRUMENTS OF PROFESSIONAL SERVICE, ARE, AND SHALL REMAIN, THE PROPERTY OF THE ARCHITECT. THESE DOCUMENTS ARE NOT TO BE USED, IN WHOLE OR IN PART, FOR ANY OTHER PROJECTS OR PURPOSES, OR BY ANY OTHER PARTIES THAN THOSE PROPERLY AUTHORIZED BY CONTRACT

WITHOUT THE EXPRESS AUTHORIZATION OF THE ARCHITECT.




GENERAL NOTES

. CONTRACTOR SHALL VISIT SITE, PRIOR TO BID, AND CAREFULLY INVESTIGATE AND EXAMINE THE AREA OF WORK SO AS TO SATISFY HIMSELF AS TO THE NATURE AND LOCATION OF THE WORK. CONTRACTOR TO NOTE THE CHARACTER, QUALITY, QUANTITIES OF MATERIALS REQUIRED AND DIFFICULTIES TO BE ENCOUNTERED, THE KIND AND EXTENT OF EQUIPMENT AND FACILITIES NEEDED FOR PERFORMANCE OF THE WORK AND OTHER ITEMS WHICH MAY, IN ANY WAY, AFFECT THE WORK OR CONTRACTOR'S


2. DRAWINGS DO NOT INCLUDE NECESSARY COMPONENTS FOR CONSTRUCTION SAFETY.

> MAJOR LAND DEVELOPMENT APPLICATION SUBMISSION


NOT FOR CONSTRUCTION

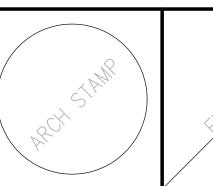


Proj. Mgr.: Drawn by: Revisions No. Date Description

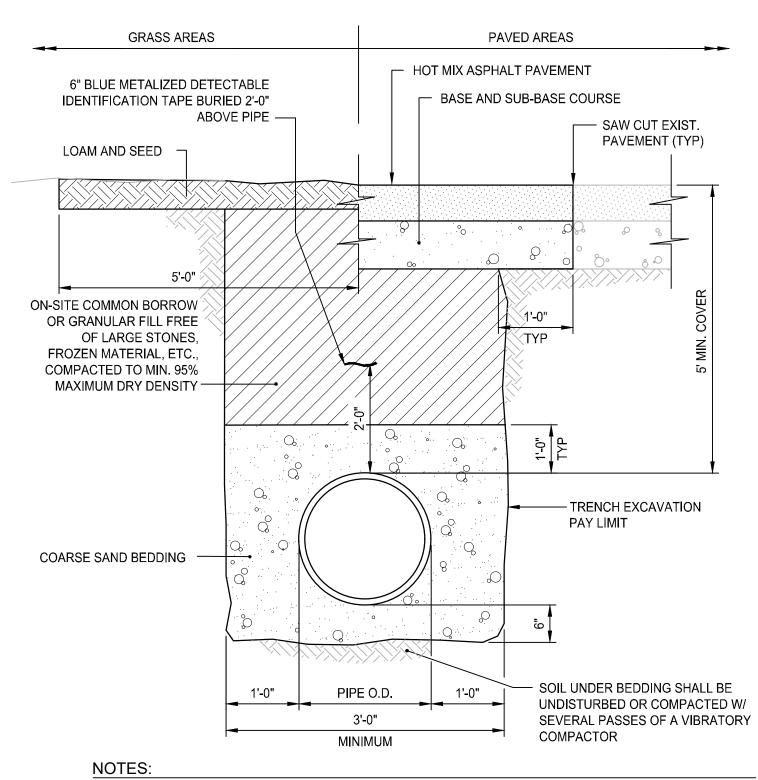

- 1. WHERE THE DISTANCE BETWEEN THE SAWCUT AND EDGE OF PAVEMENT IS 3' OR LESS, THE CONTRACTOR SHALL REPLACE THE PAVEMENT FROM THE TRENCH EDGE TO THE EXISTING EDGE OF PAVEMENT.
- 2. PIPE SHALL BE BEDDED IN 3/4-INCH CRUSHED STONE IF WITHIN GROUNDWATER. TYPICAL WATER MAIN TRENCH DETAIL NOT TO SCALE

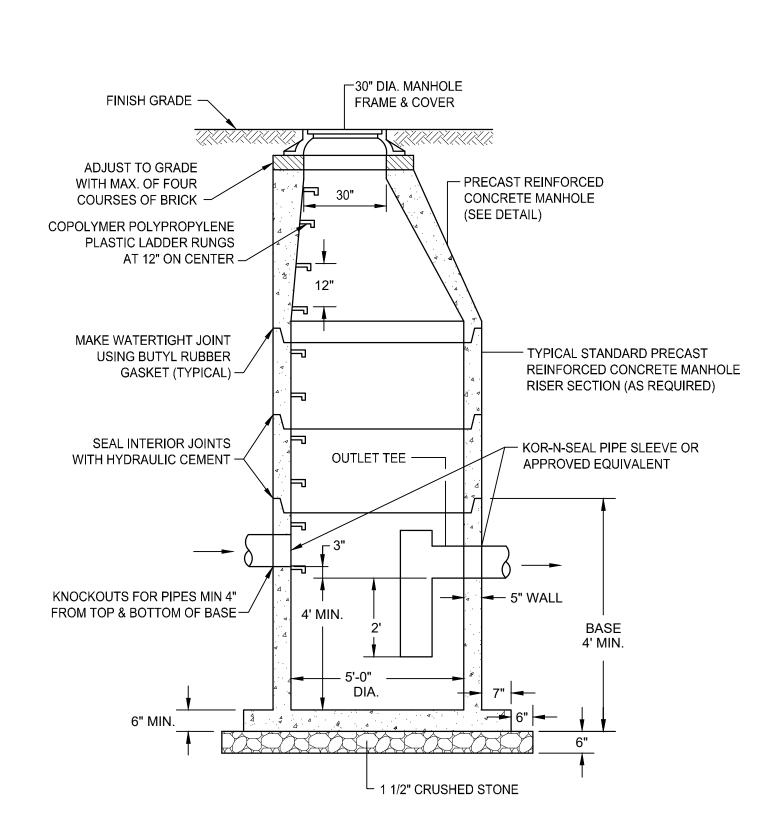


PRECAST CONCRETE OIL WATER SEPARATOR (OWS) NOT TO SCALE

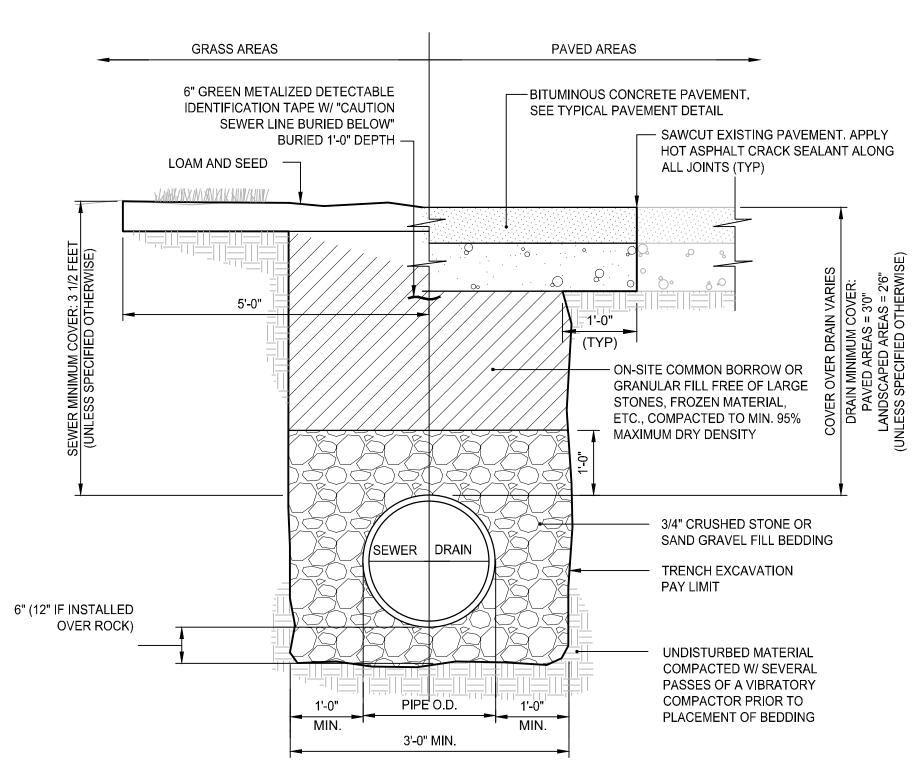

1. WHERE THE DISTANCE BETWEEN THE SAWCUT AND EDGE OF PAVEMENT IS 3' OR LESS, THE CONTRACTOR SHALL REPLACE THE PAVEMENT FROM THE TRENCH EDGE TO THE EXISTING EDGE OF PAVEMENT.

2. 3/4" DIA. CRUSHED STONE SHALL BE USED AS BEDDING WHERE TRENCH IS BELOW THE GROUND WATER TABLE.


GRAVITY SEWER/DRAIN TRENCH DETAIL NOT TO SCALE

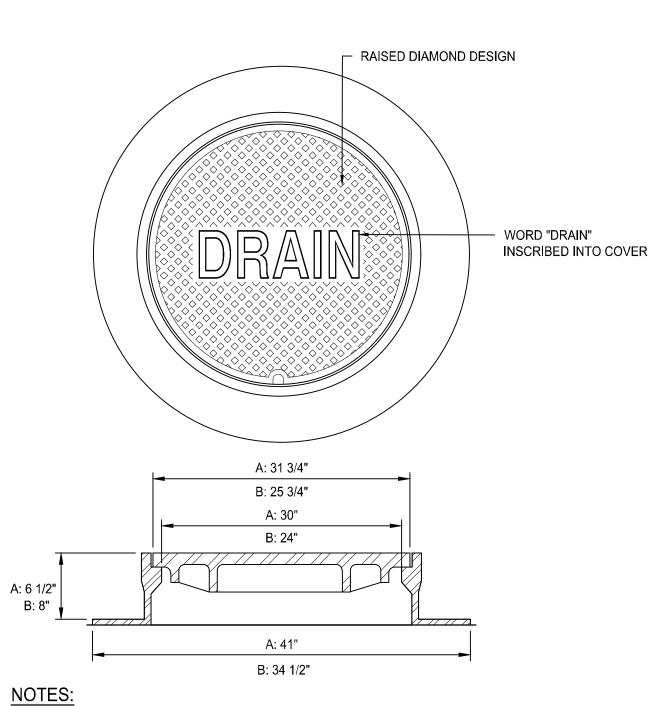


1. ALL FRAMES AND COVERS SHALL MEET H-20 LOADING CRITERIA.

- 2. PROVIDE: A: 30" DIA. DRAIN MANHOLE FRAME AND COVER SHALL BE NEENAH FOUNDRY, INC. MODEL #R-1557 OR APPROVED EQUIVALENT.
 - B: 24" DIA. DRAIN MANHOLE FRAME AND COVER SHALL BE NEENAH FOUNDRY, INC. MODEL #R-1556 OR APPROVED EQUIVALENT.
- 3. ALL DRAIN MANHOLES SHALL HAVE 24" DIA. DRAIN MANHOLE COVER UNLESS NOTED OTHERWISE.

DRAIN MANHOLE FRAME & COVER NOT TO SCALE

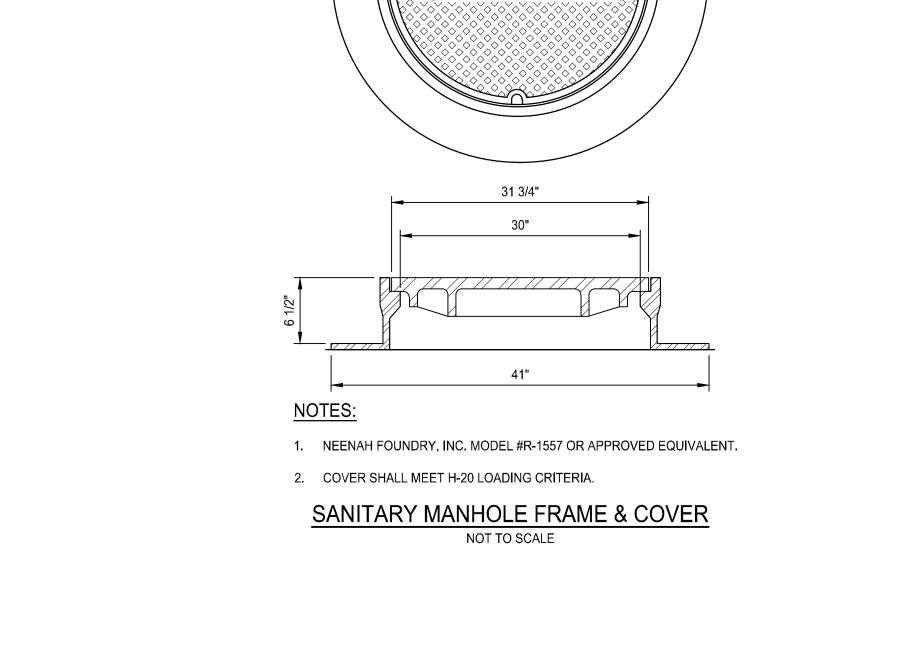

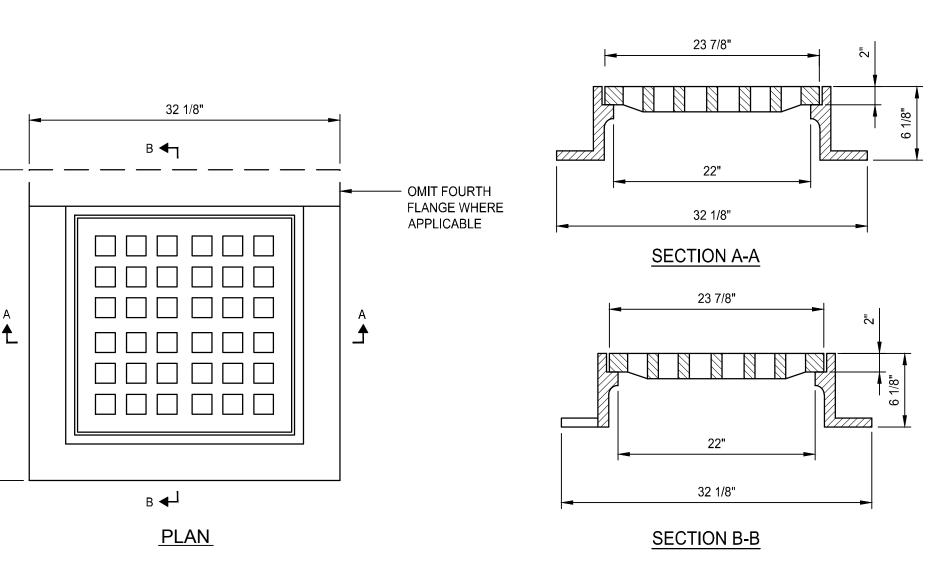

GENERAL NOTES: NEENAH FOUNDRY R-3405-A OR APPROVED EQUIVALENT.

- 2. FRAME AND GRATE SHALL MEET H-20 LOADING CRITERIA.

1. REINFORCING STEEL CONFORMS TO LATEST A.S.T.M. A 185 SPEC. 0.12 SQ. IN/LINEAL FT. AND 0.12 SQ. IN. (BOTH WAYS) BASE BOTTOM

- RAISED DIAMOND DESIGN


INSCRIBED INTO COVER

- WORD "SEWER"

- 2. CONC. MINIMUM COMPRESSIVE STRENGTH = 4000 PSI TYPE III CEMENT.
- 3. MANHOLE DESIGN SPECIFICATIONS CONFORM TO LATEST A.S.T.M. C 478 SPEC. FOR "PRECAST REINFORCED CONCRETE MANHOLE SECTIONS".
- 4. PROVIDE ONE POUR 6" THICK REINFORCED MONOLITHIC BASE SECTION.
- 5. MANHOLE SHALL MEET H-20 LOADING CRITERIA. 6. ALL LIFTING HOLES TO BE PLUGGED IN AND OUT WITH HYDRAULIC CEMENT
- 7. MANHOLES SHALL HAVE 6" THICK WALLS.

SQUARE CATCH BASIN FRAME & GRATE NOT TO SCALE

CITY OF PROVIDENCE -

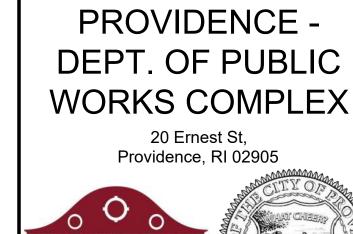

Owner: Providence Department of Public Works 20 Ernest Street Providence, RI 02905



OWNERSHIP AND USE OF DOCUMENTS, DRAWINGS AND SPECIFICATIONS AS INSTRUMENTS OF PROFESSIONAL SERVICE, ARE, AND SHALL REMAIN, THE PROPERTY OF THE ARCHITECT. THESE DOCUMENTS ARE NOT TO BE USED, IN WHOLE OR IN PART. FOR ANY OTHER PROJECTS OR PURPOSES, OR BY ANY OTHER PARTIES THAN THOSE PROPERLY AUTHORIZED BY CONTRACT

WITHOUT THE EXPRESS AUTHORIZATION OF THE ARCHITECT.



GENERAL NOTES


CONSTRUCTION SAFETY.

. CONTRACTOR SHALL VISIT SITE, PRIOR TO BID, AND CAREFULLY INVESTIGATE AND EXAMINE THE AREA OF WORK SO AS TO SATISFY HIMSELF AS TO THE NATURE AND LOCATION OF THE WORK. CONTRACTOR TO NOTE THE CHARACTER, QUALITY, QUANTITIES OF MATERIALS REQUIRED AND DIFFICULTIES TO BE ENCOUNTERED, THE KIND AND EXTENT OF EQUIPMENT AND FACILITIES NEEDED FOR PERFORMANCE OF THE WORK AND OTHER ITEMS WHICH MAY, IN ANY WAY, AFFECT THE WORK OR CONTRACTOR'S

2. DRAWINGS DO NOT INCLUDE NECESSARY COMPONENTS FOR

MAJOR LAND DEVELOPMENT **APPLICATION** SUBMISSION

NOT FOR CONSTRUCTION

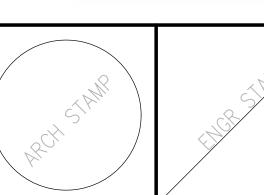


Drawn by: Proj. Mgr.: Revisions	: 01-17-2025	_ 5.00
Revisions	n by:	Draw
·	sions	Revis
No. Date Description	Date	No.



> 20 Ernest St, Providence, RI 02905



Owner: Providence Department of Public Works 20 Ernest Street Providence, RI 02905

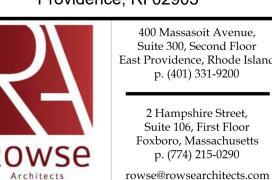

400 Massasoit Avenue, Suite 300, Second Floor East Providence, Rhode Island p. (401) 331-9200 2 Hampshire Street, Suite 106, First Floor Foxboro, Massachusetts p. (774) 215-0290

OWNERSHIP AND USE OF DOCUMENTS, DRAWINGS AND SPECIFICATIONS AS INSTRUMENTS OF PROFESSIONAL SERVICE, ARE, AND SHALL REMAIN, THE PROPERTY OF THE ARCHITECT. THESE DOCUMENTS ARE NOT TO BE USED, IN WHOLE OR IN PART, FOR ANY OTHER PROJECTS OR PURPOSES, OR BY ANY OTHER PARTIES THAN THOSE PROPERLY AUTHORIZED BY CONTRACT WITHOUT THE EXPRESS AUTHORIZATION OF THE ARCHITECT.



Smithfield, Rhode Island 02917 www.dianesouleandassociates.com 401.231.0736 email: diane@dcsa.ws

GENERAL NOTES

1. CONTRACTOR SHALL VISIT SITE, PRIOR TO BID, AND CAREFULLY INVESTIGATE AND EXAMINE THE AREA OF WORK SO AS TO SATISFY HIMSELF AS TO THE NATURE AND LOCATION OF THE WORK. CONTRACTOR TO NOTE THE CHARACTER, QUALITY, QUANTITIES OF MATERIALS REQUIRED AND DIFFICULTIES TO BE ENCOUNTERED, THE KIND AND EXTENT OF EQUIPMENT AND FACILITIES NEEDED FOR PERFORMANCE OF THE WORK AND OTHER ITEMS WHICH MAY, IN ANY WAY, AFFECT THE WORK OR CONTRACTOR'S

2. DRAWINGS DO NOT INCLUDE NECESSARY COMPONENTS FOR CONSTRUCTION SAFETY.

> MAJOR LAND DEVELOPMENT APPLICATION SUBMISSION

NOT FOR CONSTRUCTION

ate			
raw	n by:	Proj. Mgr.:	
evi	sions		
ο.	Date	Description	

LANDSCAPE PLAN 1





CITY OF PROVIDENCE -DEPT. OF PUBLIC WORKS COMPLEX 20 Ernest St,

Providence, RI 02905



Owner: Providence Department of Public Works 20 Ernest Street Providence, RI 02905



400 Massasoit Avenue, Suite 300, Second Floor East Providence, Rhode Island p. (401) 331-9200 2 Hampshire Street, Suite 106, First Floor Foxboro, Massachusetts p. (774) 215-0290

rowse@rowsearchitects.com

OWNERSHIP AND USE OF DOCUMENTS, DRAWINGS AND SPECIFICATIONS AS INSTRUMENTS OF PROFESSIONAL SERVICE, ARE, AND SHALL REMAIN, THE PROPERTY OF THE ARCHITECT.
THESE DOCUMENTS ARE NOT TO BE USED, IN WHOLE OR IN PART, FOR ANY OTHER PROJECTS OR PURPOSES, OR BY ANY OTHER PARTIES THAN THOSE PROPERLY AUTHORIZED BY CONTRACT WITHOUT THE EXPRESS AUTHORIZATION OF THE ARCHITECT.

1. CONTRACTOR SHALL VISIT SITE, PRIOR TO BID, AND CAREFULLY INVESTIGATE AND EXAMINE THE AREA OF WORK SO AS TO SATISFY HIMSELF AS TO THE NATURE AND LOCATION OF THE WORK. CONTRACTOR TO NOTE THE CHARACTER, QUALITY, QUANTITIES OF MATERIALS REQUIRED AND DIFFICULTIES TO BE ENCOUNTERED, THE KIND AND EXTENT OF EQUIPMENT AND FACILITIES NEEDED FOR PERFORMANCE OF THE WORK AND OTHER ITEMS WHICH MAY IN ANY WAY, AFFECT THE WORK OR CONTRACTOR'S

2. DRAWINGS DO NOT INCLUDE NECESSARY COMPONENTS FOR

MAJOR LAND DEVELOPMENT **APPLICATION** SUBMISSION

NOT FOR CONSTRUCTION

Date: 01-17-2025

Drawn by: JMB Proj. Mgr.: BEG No. Date Description

OVERALL FLOOR PLANS

30 of 191 2390 - A1.00



Providence, RI 02905



Providence Department of Public Works 20 Ernest Street Providence, RI 02905 400 Massasoit Avenue, Suite 300, Second Floor



OWNERSHIP AND USE OF DOCUMENTS, DRAWINGS AND SPECIFICATIONS AS INSTRUMENTS OF PROFESSIONAL SERVICE, ARE, AND SHALL REMAIN, THE PROPERTY OF THE ARCHITECT.
THESE DOCUMENTS ARE NOT TO BE USED, IN WHOLE OR IN PART, FOR ANY OTHER PROJECTS OR PURPOSES, OR BY ANY OTHER PARTIES THAN THOSE PROPERLY AUTHORIZED BY CONTRACT WITHOUT THE EXPRESS AUTHORIZATION OF THE ARCHITECT.

1. CONTRACTOR SHALL VISIT SITE, PRIOR TO BID, AND CAREFULLY INVESTIGATE AND EXAMINE THE AREA OF WORK SO AS TO SATISFY HIMSELF AS TO THE NATURE AND LOCATION OF THE WORK. CONTRACTOR TO NOTE THE CHARACTER, QUALITY, QUANTITIES OF MATERIALS REQUIRED AND DIFFICULTIES TO BE ENCOUNTERED, THE KIND AND EXTENT OF EQUIPMENT AND FACILITIES NEEDED FOR PERFORMANCE OF THE WORK AND OTHER ITEMS WHICH MAY, IN ANY WAY, AFFECT THE WORK OR CONTRACTOR'S PERFORMANCE

2. DRAWINGS DO NOT INCLUDE NECESSARY COMPONENTS FOR

MAJOR LAND DEVELOPMENT APPLICATION SUBMISSION


NOT FOR CONSTRUCTION

Drawn by: JMB	Proj. Mgr.: BEG	
Date: 01-17-2025		

OVERALL FLOOR PLANS

31 of 191



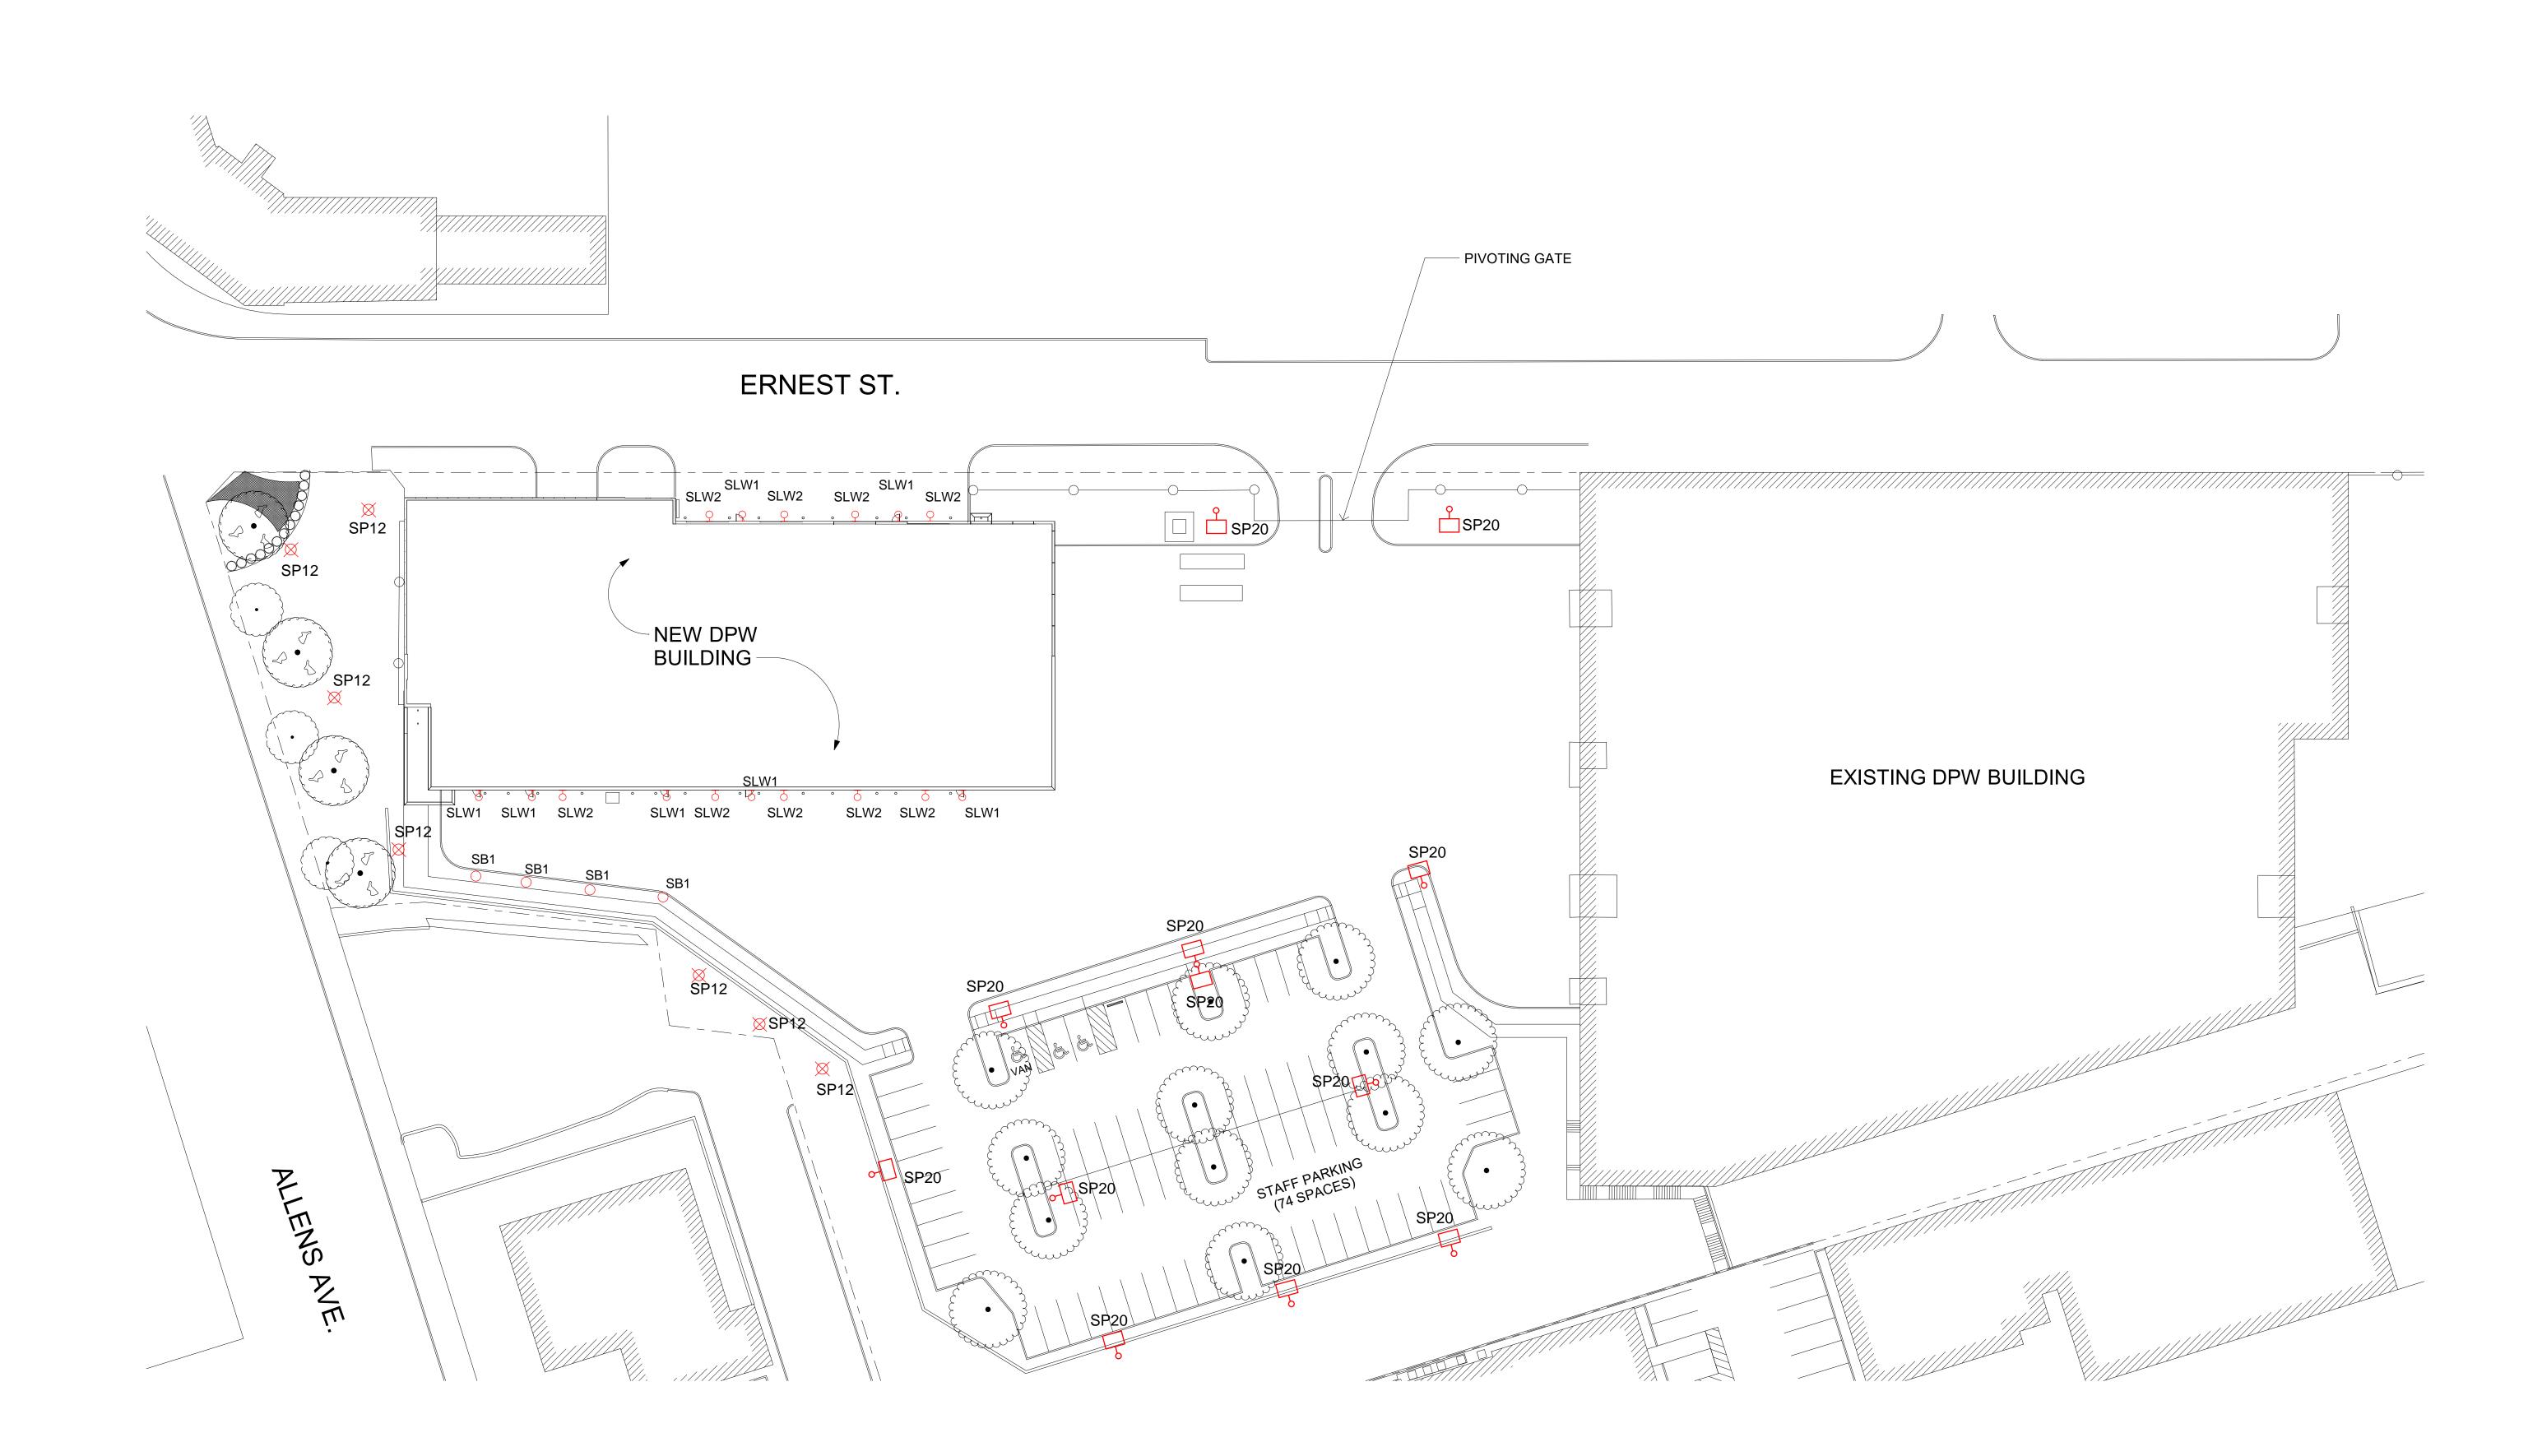

SITE LIGHTING PLAN AO.03 1" = 30'-0"

REFER TO CIVIL DWGS FOR MORE INFO

NOTE:

SITE LIGHTING PLAN

PROJECT NORTH

CITY PROVID DEPT. OF WORKS C	ENCE - PUBLIC
20 Erne Providence	•
PPBA PROVIDENCE PUBLIC BUILDINGS AUTHORITY Own	ner:
Providence Departme 20 Ernes Providence	st Street
	400 Massasoit Avenue, Suite 300, Second Floor East Providence, Rhode Island p. (401) 331-9200

OWNERSHIP AND USE OF DOCUMENTS, DRAWINGS AND SPECIFICATIONS AS INSTRUMENTS OF PROFESSIONAL SERVICE, ARE, AND SHALL REMAIN, THE PROPERTY OF THE ARCHITECT. THESE DOCUMENTS ARE NOT TO BE USED, IN WHOLE OR IN PART, FOR ANY OTHER PROJECTS OR PURPOSES, OR BY ANY OTHER PARTIES THAN THOSE PROPERLY AUTHORIZED BY CONTRACT WITHOUT THE EXPRESS AUTHORIZATION OF THE ARCHITECT.

2 Hampshire Street, Suite 106, First Floor Foxboro, Massachusetts p. (774) 215-0290

rowse@rowsearchitects.com

GENERAL NOTES

1. CONTRACTOR SHALL VISIT SITE, PRIOR TO BID, AND CAREFULLY INVESTIGATE AND EXAMINE THE AREA OF WORK SO AS TO SATISFY HIMSELF AS TO THE NATURE AND LOCATION OF THE WORK. CONTRACTOR TO NOTE THE CHARACTER, QUALITY, QUANTITIES OF MATERIALS REQUIRED AND DIFFICULTIES TO BE ENCOUNTERED, THE KIND AND EXTENT OF EQUIPMENT AND FACILITIES NEEDED FOR PERFORMANCE OF THE WORK AND OTHER ITEMS WHICH MAY, IN ANY WAY, AFFECT THE WORK OR CONTRACTOR'S PERFORMANCE.


2. DRAWINGS DO NOT INCLUDE NECESSARY COMPONENTS FOR

MAJOR LAND DEVELOPMENT APPLICATION SUBMISSION


NOT FOR CONSTRUCTION


Date: 02-13-2025	•
Date: 02-13-2025 Drawn by: JMB	Proj. Mgr.: BEG
	Proj. Mgr.: BEG
Drawn by: JMB Revisions	
Drawn by: JMB	Proj. Mgr.: BEG Description
Drawn by: JMB Revisions	

2390 - AO.03

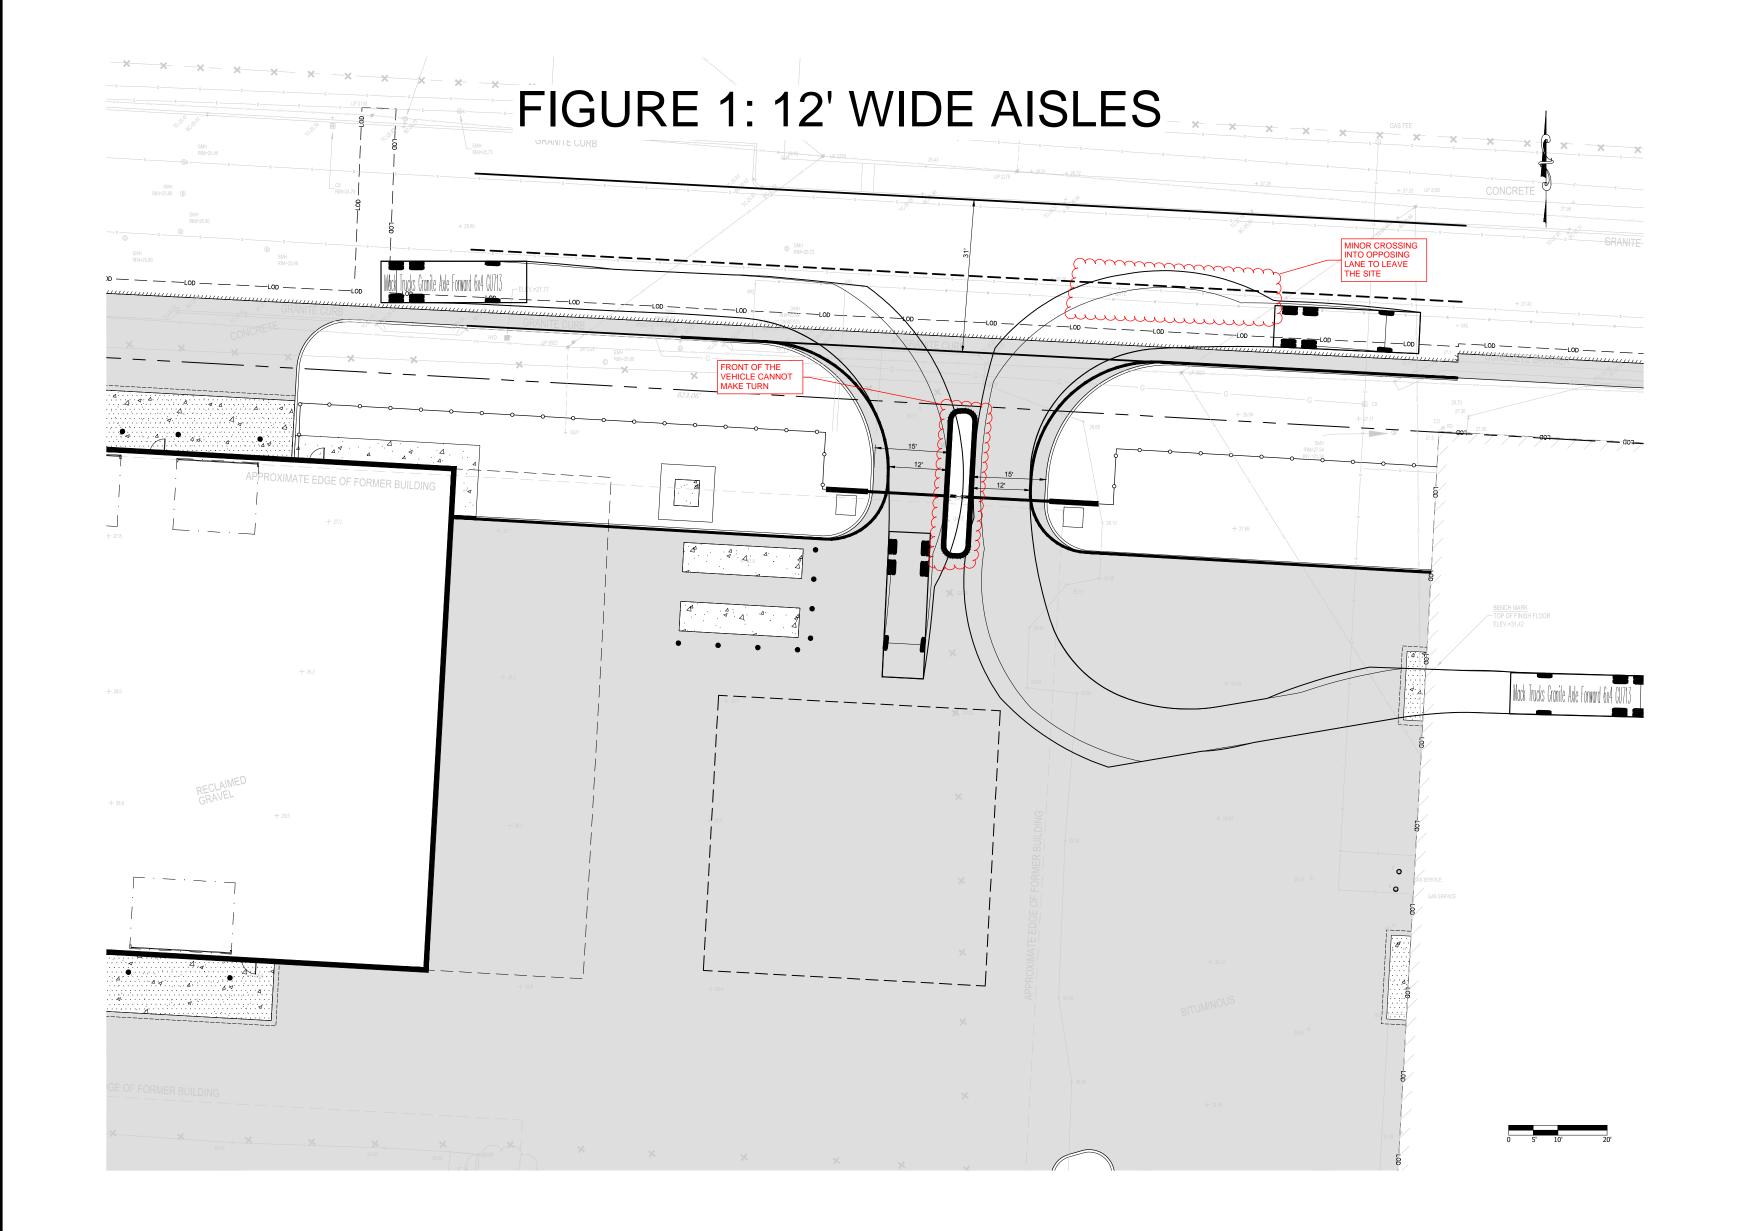



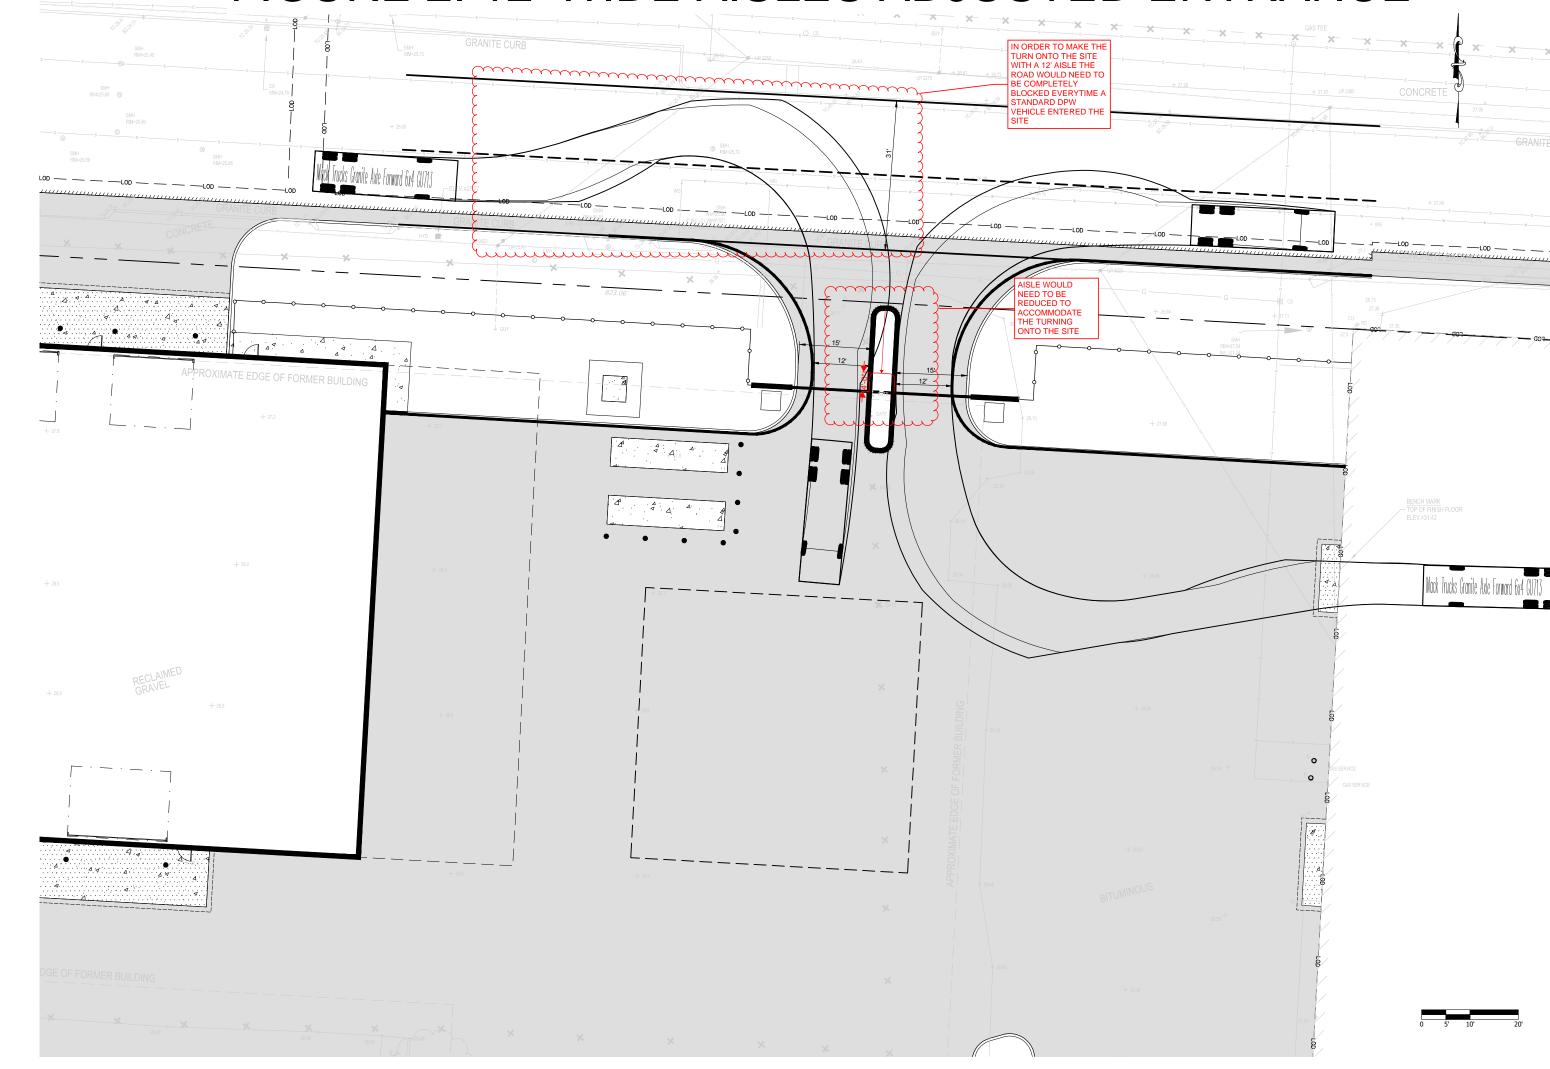

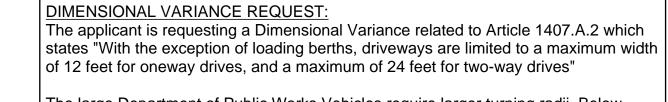


The large Department of Public Works Vehicles require larger turning radii. Below turning radius diagrams are calculated with a 6-wheel dump truck size (approx. 30' long), similar to the plow trucks operated by the DPW. during the winter seasons, the trucks will also have a plow mounted to the front. In addition, vehicles will be driving from the existing garage building, through the drive way access point.

Figure 1 demonstrates that with 12' drive isle access, the front end of vehicles cannot make the turn into the site, and when exiting from the existing building, the turn will be very tight and result in crossing over to the opposing traffic.


Figure 2 demonstrates that for entering traffic to avoid hitting a reduced footprint dividing isle, entering traffic would greatly cross into opposing traffic to make the turn. Figure 3 demonstrates that a 15' wide drive isle results in a safer path of travel in the roadway, as well as a into the site, for the size vehicles operated by the Department of

The applicant is asking for a Variance to allow 15' wide drive isles at the main

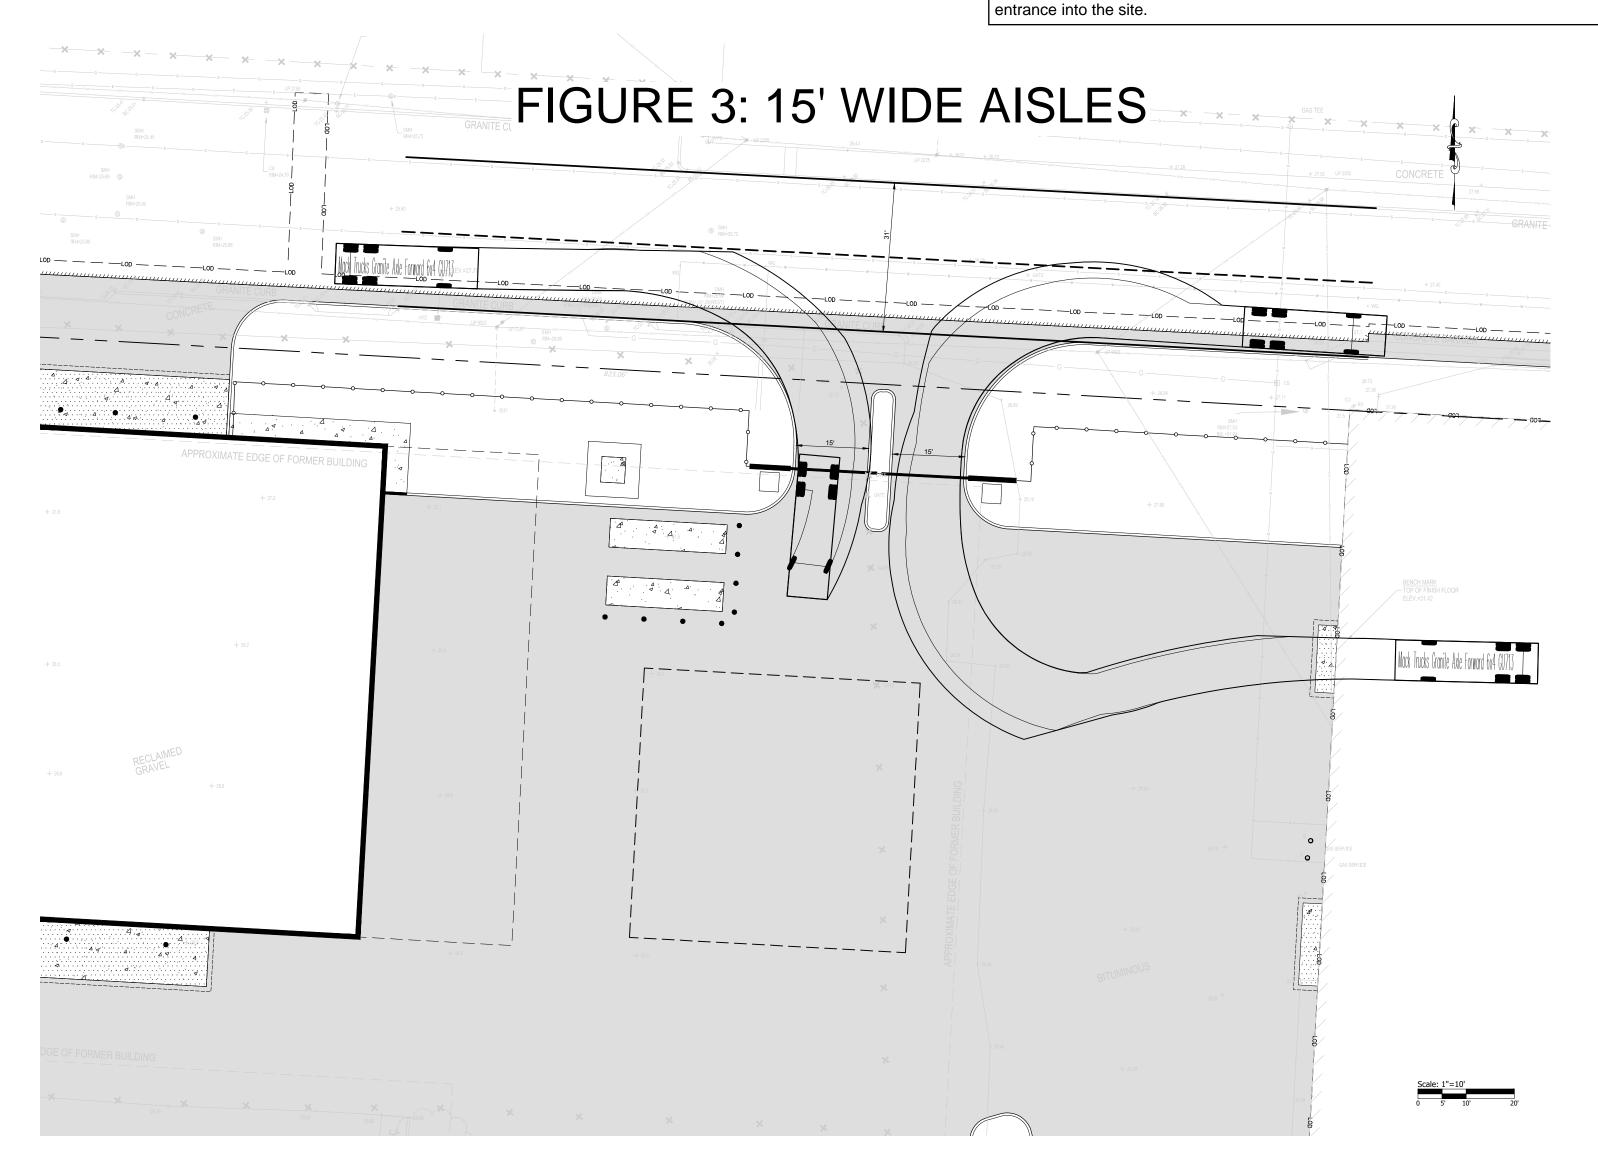




OVERLAY OF PROPOSED DRIVE ISLE OVER **EXISTING CONDITIONS**

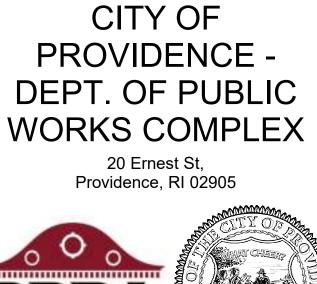

Providence Department of Public Works 20 Ernest Street Providence, RI 02905

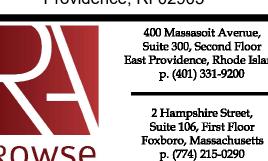

400 Massasoit Avenue, Suite 300, Second Floor East Providence, Rhode Island p. (401) 331-9200 Suite 106, First Floor

rowse@rowsearchitects.com

OWNERSHIP AND USE OF DOCUMENTS, DRAWINGS AND SPECIFICATIONS AS INSTRUMENTS OF PROFESSIONAL SERVICE, ARE, AND SHALL REMAIN, THE PROPERTY OF THE ARCHITECT. THESE DOCUMENTS ARE NOT TO BE USED, IN WHOLE OR IN PART, FOR ANY OTHER PROJECTS OR PURPOSES, OR BY ANY OTHER PARTIES THAN THOSE PROPERLY AUTHORIZED BY CONTRACT WITHOUT THE EXPRESS AUTHORIZATION OF THE ARCHITECT.

GENERAL NOTES

INVESTIGATE AND EXAMINE THE AREA OF WORK SO AS TO SATISFY HIMSELF AS TO THE NATURE AND LOCATION OF THE WORK. CONTRACTOR TO NOTE THE CHARACTER, QUALITY, QUANTITIES OF MATERIALS REQUIRED AND DIFFICULTIES TO BE ENCOUNTERED, THE KIND AND EXTENT OF EQUIPMENT AND FACILITIES NEEDED FOR PERFORMANCE OF THE WORK AND OTHER ITEMS WHICH MAY IN ANY WAY, AFFECT THE WORK OR CONTRACTOR'S

2. DRAWINGS DO NOT INCLUDE NECESSARY COMPONENTS FOR

MAJOR LAND DEVELOPMENT **APPLICATION** SUBMISSION

NOT FOR CONSTRUCTION

SITE PLAN - 15' ISLE DEMONSTRATION

PROJECT

NORTH

2390 - AO.03