

CITY OF PROVIDENCE, RHODE ISLAND

Department: Parks

RFP Title: Site Improvements at Miguel Luna Park

Opening Date: 04/21/2025

Addendum #: 2

Issue Date: 04/11/2025

The purpose of this addendum is:

See attached



WENDY NILSSON Superintendent of Parks

BRETT P. SMILEY Mayor

Addendum # 2

Site Improvements at Miguel Luna Park April 11, 2025

Total Pages Including Cover (46 Pages)

Acknowledge Addenda on Bid Form

** BID DUE DATE MONDAY, April 21, 2025, AT 2:15PM **

Attachments:

- 1. Addendum Cover Sheet (1 Page)
- 2. Pre-bid Conference Sign-in Sheet (1 Page)
- 3. RFP Bid Package Specifications pages 15-28 (14 Pages)
- 4. Plans Sheets L-1 to L-16 (17 Pages)
- 5. Plans Vortex Plumbing & Electrical (3 Pages)
- 6. Specifications 116840 Splashpad Play Equipment (6 Pages)
- 7. Specifications 323300 Site Furnishings (4 Pages)

Clarifications:

- Q: Can you please advise/confirm the requested quantities for the site furnishings?
 A: Please use information identified on Materials Plans L-5.1 and L-5.2 for quantities and types of furnishings.
- **2.** Q: Is there any concern for the water meter enclosure being non-heated?
 - A: Water service is only turned on during the warm months when the irrigation, the splashpad and bathrooms are operated.
- 3. Q: How is the remaining water released from the water meter to prevent winter damage?
 - A: Water is turned off at the curb stop at the sidewalk.
- **4.** Q: Are both waterlines entering the building?
 - A: The waterlines entering the building are the existing 1.5" line for bathroom use and the new 2" line designated for the splashpad. The existing 2" irrigation line is to remain as is.

Phone: 401-680-7201

Sign-In Sheet

Pre-Bid Meeting

Tuesday, April 8, 2025, at 10AM - On Site

Site Improvements at Miguel Luna Park

Name	Company	E-Mail	<u>Phone</u>
BILL BRYANT	SITE TECH	BILLBCSITETECHCORP. COM	401.490.7483
Mike Donatelli	Site Tech	M Donatelli@site tech corp.	on 401-490-7483
JON JALBORT	Ultiplay	jalbert@ultylagus.com	508-688-7007
	•)		

BID PACKAGE SPECIFICATIONS

Project Description:

Located in the Elmwood neighborhood of Providence, Miguel Luna Memorial Park is situated south of Sackett Street and north of Amos Early Park. The scope of work for this project includes improvements in accessibility and circulation; the installation of a new splashpad with low-flow water features along with infiltration areas, and upgrades to the play areas with equipment for children ages 2-12. Add Alts for this project include improvements to the baseball field and basketball court.

BASE BID: The Base Bid scope of work for this project shall include, but not be limited to the following:

- R&D existing and F&I and/or D&I new splashpad, spray features, controller and manifold
- R&D ex. Irrigation Cabinet and F&I new Water Meter and Cabinet; F&I Waterline for the new Splaspad and tie into ex. irrigation waterline
- R&D ex. and F&I new Asphalt Roadway Paving
- R&D ex. and D&I new Playground Play Features*

- F&I Trees and other plant material
- F&I Concrete Paving and Base
- R&D ex. and F&I new Play Equipment and Site Furnishings
- R&D ex. and F&I new Safety Surfacing
- D&I Granite Treads and Cobble

*The Awarded Bidder/General Contractor must coordinate delivery of playground equipment from the manufacturer to the construction site and install in accordance with the plans, specifications and manufacturer's instructions.

ADD ALTERNATES include:

- F&I Bleachers on Concrete Pad
- F&I Timber Retaining Walls
- R&D ex. and F&I new Dugouts with Concrete Pads and Metal Corrugated Roofs
- R&D ex. and F&I new Infield Mix and Sod

- F&I Batting Enclosure w/ Electric Power
- R&D ex. Path and F&I Loam Hydroseed
- R&D ex. and new F&I Basketball Court
- F&I Trees and Shrubs

In addition to stating the Total Base Bid, the bidder shall state Unit Prices for related work listed under each bid item which represents the work items included in the Total Base Bid. The Unit Prices are quoted for computing adjustments to the Base Bid prior to Contract award, as well as during the course of construction, based upon extra work ordered by the City or for work countermanded, reduced or omitted by the City in order to stay within the Project budget.

Base Bid Items and Unit prices are to be Completed prices to be added or deducted on the basis of quantities of work involved, for each item in place in the unit indicated.

All Work Included in this Project Shall be C	mpleted for the lump sum of:	
		Dollars
(\$), TOTAL BASE BID	
ALLOWANCE: \$45,000.00		
BASE BID W/ ALLOWANCE: \$		

BIDDEK:	

	<u>EVIATIONS</u>					
R&S	Remove & Stockpile	LS	Lump Sum		TN	Ton
R&D D&I	Remove & Dispose Deliver & Install, owner	EA LF	Each Linear Foot		TMR (oak)	Thermally Modified Red
provide		SF	Square Foot		R&R	Remove & Reinstall
F&I	Furnish & Install	CY	Cubic Yard			
ADD A	LTERNATES:					
1.	Add Alt #1 –Dugouts: R&D exis Roofs and Players Benches as po				ith Concr	rete Pads, Corrugated Metal
				LS	\$	
price in	writing					
2.	Add Alt #2 –Ballfield: R&D exist interior and exterior of infield ar				I 4'' Infie	ld Mix, Loam and Sod
				LS	\$	
price in						
3.	Add Alt #3 – Bleachers: Strip and	d dispose	turf and F&I 4 Row	Bleachers on Co	oncrete Pa	ad, complete Per Lump Sum
	_	_				•
price in				LS	\$	
4.	Add Alt #4 – Batting Enclosure: Mix and a 4' wide Pedestrian Ga				k Batting	Enclosure with a 4" Infield
price in	writing			LS	\$	
-	Add Alt #5 – Eastern Timber Re Timber Wall, complete Per Lu		all: F&I (6x6'' [5.5x5	_		nted Ground Contact rated
price in	writing			LS	\$	
6.	Add Alt #6 – Concrete Curb Step a. F&I (6x6" [5.5x5.5" non b. F&I PT GC Timber Step c. D&I salvaged Pre-cast C	n.]) Pressup and Gra	re Treated Ground (vel Path	Contact rated T	imber W	all
				LS	\$	
price in	writing					
7.	Add Alt #7 – Baseball Field Irrig ex. 2" waterline, complete Per			itilizing ex. Con	troller an	d Power source and tying into
				LS	\$	
price in	writing					
	ote that the list above is not intended to act prior to or after award – in the best			te the base bid sco	pe of work	but can and shall be used to adjust

Page **16** of **36**

BIDDER: _____

8.	Add Al	t #8 – R&D Asphalt Walk and Base, F&I Loam and Hydroseed	, complete 1	Per Lump Sum
			LS	\$
price in w	_			
9.	Add Al	t #9 – F&I Log Scramble – Balance Beams and Log Steppers, c	omplete Per	r Lump Sum
 			LS	\$
price in w	_			
10.	a. b.	t #10 – Basketball Court Renovation, complete. – Per lump sun R&D ex. and F&I new Asphalt Surface R&D ex. Posts, Backboards and Rims; F&I new Posts, Backb F&I Surface Sealant and Line Marking		ns
			LS	\$
price in w	riting			
	Add Al Lump S	t #11 – Granite Treads Seating in Slope: D&I salvaged Granite Sum	Treads with	Gravel Base, complete. – Po
			LS	\$
price in w	riting			
	a.b.c.d.	tt #12 – F&I Trees, Shrubs and Perennials, complete – Per Lum (10) #3 Clethra alnifolia 'Crystalina' – Summersweet (4) #3 Hydrangea quercifolia 'Pee Wee' – Oakleaf Hydrangea (8) #3 Hydrangea serrata 'Tuff Stuff Ah-Ha®' – Lacecap Hydrangea 'Nigra' - Inkberry (2) 2.5-3" cal. Nyssa sylvatica 'Wildfire' – Tupelo (1) 2.5-3" Cercis canadensis 'Forest Pansy' – Eastern Redbud	_	
price in w	ritina		LS	\$
UNIT PI	RICES	- BASE BID:		
1.	F&I Te	emporary Tree Protection, complete. – Per Linear Foot		
			T T2	ф
price in w	riting		LF	\$
		osion and Sedimentation Controls, complete. – Per Linear Foo	t	
			LF	\$
price in w	riting			
3.	R&D e	x. Asphalt and Base, complete. – Per Square Foot		
			SF	\$
price in w	riting		•	

4.	R&D ex. Concrete and Base, complete. – Per Square Foot			
		SF	\$	
price in	writing			
5.	R&D ex. Chain Link Fence, complete. – Per Linear Foot			
		LF	¢	
price in	writing	L/F	Φ	
6.	R&D ex. Splashpad Water Features, Benches and Trench Drains	, complete. – F	er Lump Sum	
		LS	\$	
price in	writing			
7.	R&D ex. Splashpad Manifold; R&S Backflow Preventers, Vortex Sum	c Controller ar	nd Power Box, complete	. – Per Lump
		LS	\$	
price in	writing			
8.	R&D ex. Hot Water Heater, complete. – Per Lump Sum			
		LS	\$	
price in	writing			
9.	F&I Patch and Seal the corner between wall and floor inside the opening at the bottom of the wall, complete. – Per Lump Sum	utility room of	the facilities building, i	ncluding the
		LS	\$	
price in	writing			
10.	R&D ex. Catch Basin, complete. – Per Lump Sum			
price in	writing	LS	\$	
-				
11.	R&D ex. Irrigation Cabinet; R&S Water Meter, Irrigation Contr – Per Lump Sum	coller, Power S	upply, Backflow Preve	nter, complete
		LS	\$	
price in	writing			
12.	R&D ex. Picnic Tables and Benches, complete. – Per Lump Sum			
		LS	\$	
price in	writing		Ψ	
13.	R&D ex. Play Equipment, complete. – Per Lump Sum			
		T G		
price in	writing	LS	\$	
-	·			
14.	R&D Plastic Playground Edging, complete. – Per Lump Sum			
	umiting.	LS	\$	
price in	wruing			

BIDDER: _____

15. R&S ex. Pre-cast Concrete Curb, complete. – Per Linear Foot		
	LF	\$
price in writing		
16. F&I 4" Concrete Pavement and Base, complete. – Per Square Foot		
	SF	\$
17. F&I Concrete Pavement with Haunch and Base, complete. – Per So	nuara Foot	
17. Text Concrete Lavement with Haunth and Dase, complete. – Fer St		
price in writing	SF	\$
18. F&I 4" Exposed Aggregate Concrete, complete. – Per Square Foot		
10. 1 to 14 Exposed rigging and Conference, complete. – 1 et 5 quart 1 out		
price in writing	SF	\$
19. F&I 3" Asphalt Pavement and Base, complete. – Per Square Foot		
17. Tet 3 Asphant Latement and Dase, complete. — Let Square Loot		
price in writing	SF	\$
20. F&I Boulder Wall, complete. – Per Linear Foot		
	LF	d)
price in writing	Lr	5
21. F&I 24-42"L x 24-36"W x 18-36"H Landscape Boulders as per pla	ns, complete	e. – Per Each
	EA	\$
price in writing		
22. D&I salvaged Pre-cast Concrete Curb, complete. – Per Linear Foot	t	
	LF	\$
price in writing		
23. D&I salvaged Granite Treads, complete. – Per Each		
	EA	\$
price in writing		
24. D&I salvaged Cobble, complete. – Per Square Foot		
	SF	\$
price in writing		
25. F&I Water Meter Enclosure on Concrete Pad, complete. – Per Eac	h	
	EA	\$
price in writing		

BIDDER:	

26.	F&I 2" Waterline for Splashpad and connect to ex. Water Se	rvice, complete. – 1	Per Linear Foot
		LF	\$
price in	writing		
27.	F&I 6" Perforated Sch. 40 PVC Pipe for Splashpad Infiltrati	on Area, complete	. – Per Linear Foot
		LF	\$
price in			
28.	F&I 6" Solid Sch. 40 PVC Pipe for Splashpad Infiltration Ar Foot	ea and connect to (Catch Basin, complete. – Per Lin
		LF	\$
price in	writing		
29.	F&I 6" PVC Pipe Risers with Atrium Grates for Splashpad I	nfiltration Area, c	omplete. – Per Each
		EA	\$
price in	writing		
30.	F&I 20" Area Drain, complete. – Per Each		
		EA	¢
price in	writing	EA	φ
31	F&I #6 Native Washed Stone for Infiltration Areas, complete	_ Per Cubic Vard	1
31.	Tet no realist washed stone for inintration rireas, complete	. – I ci cubic I ai c	•
price in	, with a	CY	\$
-			
32.	F&I #2 Open Graded Washed Stone to Infiltration Areas, con	mplete. – Per Cubi	c Yard
		CY	\$
price in	writing	<u> </u>	
33.	F&I Hydroseed Meadow Mix Seed, complete. – Per Square F	'oot	
		SF	\$
price in	writing		· · · · · · · · · · · · · · · · · · ·
34.	F&I Vortex Splashpad Activator, complete. – Per Each		
	• •	-	
price in	writing	EA	\$
_			
35.	D&I Vortex Aqua Dome, complete. – Per Each		
	••	EA	\$
price in	writing		
36.	F&I Vortex Spraylink Split, complete. – Per Each		
		EA	\$
price in	writing	13/11	Ψ

BIDDER:	

37. F&I Vortex Spraylink Fountain, complete. – Per Each		
	EA	\$
price in writing		
38. F&I Vortex Spray Loop, complete. – Per Each		
	EA	\$
price in writing		
39. F&I Vortex Spraylink Tunnel, complete. – Per Each		
	EA	\$
price in writing		
40. F&I Vortex Spraylink Jet, complete. – Per Each		
	EA	\$
price in writing		
41. F&I Vortex Spraylink Bloom, complete. – Per Each		
	EA	\$
price in writing		
42. F&I Vortex Twinsplash, complete. – Per Each		
	EA	\$
price in writing		
43. F&I Vortex MaestroPRO Controller, complete. – Per Each		
	EA	\$
price in writing		
44. F&I Vortex MaestroPRO Power Box, complete. – Per Each		
	EA	\$
price in writing		
45. F&I medium Goric Half-Spheres in Splashpad, complete. – Per Each		
	EA	\$
price in writing		
46. F&I large Goric Half-Spheres in Splashpad, complete. – Per Each		
	EA	\$
price in writing		
47. D&I Kompan Mini Dome with Slide, complete. – Per Lump Sum		
	LS	\$
price in writing	-	

BIDDER:	

48.	D&I Kompan Three Bay, Four Belt and One Nest Swing Set, comple	ete. – Per Lu	ımp Sum
		_LS	\$
price in	writing		
49.	D&I Kompan Universal Carousel, complete. – Per Lump Sum		
		_LS	\$
price in	writing		
50.	D&I Kompan One Bay, Two Bucket Swing Set, complete. – Per Lun	np Sum	
price in	writing	_LS	\$
- 51	E.I. 2/4!! Demands Cauched Stone Dogs for Synthesis Trust complete. Do	n Cubia Van	ad.
51.	F&I 3/4" Dynamic Crushed Stone Base for Synthetic Turf, complete. – Pe	r Cubic Tai	u
price in		_ CY	\$
-	<u> </u>		
52.	F&I Synthetic Turf Surfacing with SBR Cushion Layer, complete. –	Per Square	Foot
		_ SF	\$
price in	writing		
53.	D&I Berliner DNA Tower, complete. – Per Lump Sum		
		LS	\$
price in	writing	<u> </u>	
54.	F&I 8' TMR ADA Picnic Table surface mount, complete. – Per Each	1	
		EA	¢
price in	writing	EA	Φ
55.	F&I 6' TMR Picnic Table surface mount, complete. – Per Each		
		T. A	ф
price in	writing	EA	\$
56.	F&I 6' TMR Bench with Backrest surface mount, complete. – Per Ea	ach	
201	161 0 1 min Buch cost surface mount, complete. For Es		
price in	writing	_ EA	\$
•	·	т. 1	
57.	F&I 6' TMR Bench with Backrest inground mount, complete. – Per	Eacn	
		EA	\$
price in	-		
58.	F&I 6' TMR Backless Bench surface mount, complete. – Per Each		
		EA	\$
price in	writing		

BIDDER:	

59.	F&I 6' TMR Backless Bench inground mount, complete. – Per Each		
		EA	\$
price in	writing	_	
60.	F&I 4' height Welded Wire Mesh Fence, complete. – Per Linear Foot		
price in	writing	_LF	\$
_			
61.	F&I 5' wide WWM Pedestrian Gate, complete. – Per Each		
		_EA	\$
price in	writing		
62.	F&I 12'+ wide WWM Service Gate, complete. – Per Each		
		_EA	\$
price in	writing		
63.	F&I 55gal Trash Receptacle with Insert and Domed Lid and Cable As Each	ttachment Ki	t on Concrete Pad, complete. – Per
		_EA	\$
price in	writing		
64.	F&I Loam, complete. – Per Cubic Yard		
		_CY	\$
price in	writing		
65.	F&I Sandy Loam, complete. – Per Cubic Yard		
1		_CY	\$
price in	writing		
70.	F&I 80z Non-Woven Filter Fabric, complete. – Per Square Foot		
		_SF	\$
price in	writing	_	
71.	R&R Park Entry Sign and Pole in Concrete Footing, complete. – Per	Lump Sum	
		LS	\$
price in	writing	_	·
72.	R&R Park Rules & Advisories Sign, complete. – Per Lump Sum		
price in	writing	LS	\$
-	R&S "Miguel Luna" Gateway Sign, complete. – Per Lump Sum		
		_LS	\$
price in	writing		*

BIDDER:	

74. F&I Loam and Hydroseed Athletic Field, complete. – Per	Square Foot	
price in writing	SF	\$
	.	.
75. F&I Loam and Hydroseed All (other) Disturbed Turf Area	as, complete. – Per So	quare Foot
price in writing	SF	\$
76. F&I 2.5-3" cal. <i>Cornus kousa</i> – Asian Dogwood, complete.	– Per Each	
	EA	\$
price in writing		
77. F&I #5 Calycanthus raulstonii 'Hartlage Wine' – Carolina	Allspice, complete. –	Per Each
	EA	\$
price in writing		
78. F&I 4" Carex pensylvanica – Pennsylvania Sedge, complet	e. – Per Each	
	EA	\$
price in writing		
79. F&I #3 Ilex glabra 'Nigra' – Inkberry, complete. – Per Eac	ch	
	EA	\$
price in writing		
80. F&I #3 Clethra alnifolia 'Ruby Spice' – Summersweet, con	nplete. – Per Each	
	EA	\$
price in writing		Ψ
81. F&I 30-36"L x 24-30"W x 18-30"H Flat-topped Boulders,	complete. – Per Each	1
	TD A	ф
price in writing	EA	\$
<u>UNIT PRICES – ADD ALTS:</u>		
1. F&I Chain Link Dugout, with 4" Concrete Pad and Corru	igated Metal Roof, co	mplete – Per Each
	EA \$	
price in writing		
2. F&I 6' Player's Dugout Bench surface mount, complete –	Per Each	
price in writing	EA \$	
Please note that the list above is not intended to include all items required to c	omplete the base bid see	ne of work but can and shall i
the contract prior to or after award – in the best interest of the City of Provide.		oo o _j work om can ana snan t

BIDDER:

3.	R&D ex. Infield Mix, complete – Per Cubic Yard		
		CY	\$
price in	writing	•	
4.	F&I 4" Infield Mix, complete – Per Cubic Yard		
	94	CY	\$
price in	wrung		
5.	Strip and Remove Turf, complete – Per Square Foot		
		SF	\$
price in	writing		
6.	F&I Sod, complete – Per Square Foot		
		SF	¢
price in	writing		Ψ
7.	F&I 5' wide Chain Link Pedestrian Gate, complete – Per Each		
		EA	\$
price in	writing		
8.	F&I 6x6" (5.5x5.5" nom.) Pressure Treated, Ground Contact rated Ti	mber	, complete – Per Linear Foot
price in	sumité u a	LF	\$
_			
9.	F&I #4 Rebar, complete – Per Linear Foot		
		LF	\$
price in	writing		
10.	F&I ¾" Process Gravel, complete – Per Cubic Yard		
		CY	\$
price in	writing	•	
11.	R&D Basketball Posts, Backboards and Rims, complete – Per Lump S	Sum	
	5.	LS	\$
price in	writing		
12.	F&I Basketball Posts, Backboards and Rims, complete – Per Each Set		
		EA	\$
price in	writing		
13.	F&I 12' ht. Chain Link Fence, complete – Per Linear Foot		
		LF	\$
price in	writing		

BIDDER:	

	LF \$	
ice in writing		
15. D&I salvaged Granite Treads with Gravel Base, complete. –	Per Each	
	EA \$	
ce in writing		
16. F&I Log Scramble Balance Beam, complete. – Per Each		
	EA \$	
ice in writing		
17. F&I Log Scramble Log Stepper, complete. – Per Each		
	EA \$	
ice in writing	·	
18. F&I #3 Clethra alnifolia 'Crystalina' – Summersweet, comple	ete. – Per Each	
	EA \$	
ice in writing		
19. F&I #3 Hydrangea quercifolia 'Pee Wee' – Oakleaf Hydrange	ea, complete. – Per	Each
	EA \$	
ice in writing		
20. F&I #3 Hydrangea serrata 'Tuff Stuff Ah-Ha®' – Lacecap Hy	ydrangea, complete	e. – Per Each
	EA \$	
ice in writing		
21. F&I 2.5-3" cal. Nyssa sylvatica 'Wildfire' – Tupelo, complete.	. – Per Each	
	EA \$	



BOARD OF CONTRACT AND SUPPLYCITY OF PROVIDENCE, RHODE ISLAND

ADDITIONAL BID DOCUMENTS

The complete set of Bid Documents includes the pages above & the following:

- PREVAILING WAGE DECISION
- SAMPLE CONTRACT
- TECHNICAL SPECIFICATIONS:
 - 010000 GENERAL REQUIREMENTS
 - 015639 TEMPORARY TREE AND PLANT PROTECTION
 - 024119 SELECTIVE DEMOLITION
 - 033000 CAST-IN-PLACE CONCRETE
 - 116800 PLAY FIELD EQUIPMENT AND STRUCTURES
 - 116833 ATHLETIC FIELD EQUIPMENT
 - 312000 EARTH MOVING
 - 312213 ROUGH GRADING
 - 312316.13 TRENCHING
 - 312500 EROSION AND SEDIMENTATION CONTROLS
 - 321216 ASPHALT PAVING
 - 321313 CONCRETE PAVING
 - 323113 CHAIN LINK FENCES AND GATES
 - 323116.10 ORNAMENTAL WELDED WIRE FENCES AND GATES
 - 323300 SITE FURNISHINGS
 - 329200 TURF AND GRASSES
 - **329300 PLANTS**
 - 331413 PUBLIC WATER UTILITY DISTRIBUTION PIPING
- ATTACHMENT A: KOMPAN MINI DOME WITH SLIDE (CRP810201-0903)
 - FOOTING PLAN AND DETAILS
- O ATTACHMENT B: BERLINER DNA TOWER (L.03.01)
 - FOOTING PLAN AND DETAILS
- o **DRAWINGS**:
 - L-1 COVER
 - L-2 EXISTING CONDITIONS PLAN
 - L-3 DEMOLITION PLAN
 - L-4.1 GRADING & UTILITIES PLAN
 - L-4.2 GRADING, UTILITIES & IRRIGATION PLAN
 - L-5.1 MATERIALS PLAN
 - L-5.2 MATERIALS PLAN
 - L-6.1 LAYOUT PLAN
 - L-6.2 LAYOUT PLAN
 - L-7 SPLASHPAD ENLARGEMENTS AND DETAILS
 - L-8 PLANTING PLAN
 - L-9 BASKETBALL COURT RENOVATIONS
 - L-10 CONSTRUCTION DETAILS
 - L-11 CONSTRUCTION DETAILS
 - L-12 CONSTRUCTION DETAILS
 - L-13 CONSTRUCTION DETAILS

- L-14 CONSTRUCTION DETAILS
 L-15 CONSTRUCTION DETAILS
 L-16 CONSTRUCTION DETAILS
- PE-000 VORTEX PLUMBING & ELECTRICAL COVER SHEET
- PE-001 VORTEX PLUMBING & ELECTRICAL LAYOUT
- E-003 VORTEX BONDING LAYOUT

ADDITIONAL INFORMATION REQUIRED WITH BID:

- Qualifications to Perform Work See Form Below for Information Required
- Addenda (If Any) Must Be Acknowledged on Bid Form (Page 14)
- Product Information for Items Submitted as 'Or Equal' to Specified Materials

PROVISIONS OF THIS PROJECT:

- Upon the Issuance of the Award from the Board of Contract the City shall issue a Contract to be executed by the City and the vendor incorporating the bid specifications. All Provisions of the Specifications are binding.
- Any Permits Required by the City of Providence and/or State of Rhode Island Shall be Obtained by the Vendor –
 Permit Fees by the City of Providence Shall be Waived the State ADA Fee Must be Paid
- The Davis Bacon Act Applies (HUD Projects) Prevailing Wages Must Be Paid for On Site Hours On-Site
 Interviews will be Conducted During the Project Employees Shall be Advised of the Prevailing Wage Rates Prior
 to Mobilization on Site
- Certified payrolls Must be Submitted With Pay Requests Including Monthly Utilizations Form
- Performance and Payment Bonds (If Required) Must be Submitted within 10 Days of Award or Bid Bond Will be Forfeited
- An Insurance Certificate Shall be Submitted to the City Within 10 Days of Award
- A Copy of the Vendors Contractor's License Must be Submitted within 10 Days of Award
- All On-Site Personnel Shall be Licensed (If Required) and Shall have Proof of All Licenses Required by the State of Rhode Island to Perform the Work Required
- Pay Requests Must be Submitted on Approved AIA Billing Documents (City will Provide if Needed)
- All Subcontractors Shall be Listed on the Bid Form All Insurance & Payroll Requirements Apply
 - o General Contractor Shall be the Insurance Certificate Holder and the City Shall be Named as 'Additionally Insured' with Respect to Liability Insurance
- A Submittal Log Must be Submitted within 10 Days of Award

CLOSE OUT DOCUMENTS:

- Prior to Final Payment the Vendor Shall Provide the Following:
 - Copies of Permits Signed off and Approved (If Any)
 - o Operating Manuals and Warranties Shall Be Transferred and/or Delivered
 - o Full and Completed As-Built Drawings Shall be Submitted for Approval
 - o Training Shall be Provided to City Personnel (If Required)
 - o Certification by Manufactures Representative (If Required)

QUALIFICATIONS:

Qualifications will be evaluated on the basis of similar project experience for:

a. Completion of at least 3 similar projects within the past five years.

IMPROVEMENTS AT MIGUEL LUNA PARK

HONORABLE
BRETT P. SMILEY
MAYOR

WENDY NILSSON
SUPERINTENDENT OF PARKS

JUAN PICHARDO
CITY COUNCILOR

SHEET SCHEDULE

- L-1 COVER SHEET
- L-2 EXISTING CONDITIONS PLAN
- L-3 DEMOLITION PLAN
- L-4.1 GRADING & UTILITIES PLAN
- L-4.2 GRADING, UTILITIES & IRRIGATION PLAN
- L-5.1 MATERIALS PLAN
- L-5.2 MATERIALS PLAN
- L-6.1 LAYOUT PLAN
 L-6.2 LAYOUT PLAN
- L-7 SPLASH PAD ENLARGEMENTS & DETAILS
- L-8 PLANTING PLAN
- L-9 BASKETBALL COURT PLAN
- L-10 CONSTRUCTION DETAILS 1
- L-11 CONSTRUCTION DETAILS 2
- L-12 CONSTRUCTION DETAILS 3
- L-13 CONSTRUCTION DETAILS 4
- L-14 CONSTRUCTION DETAILS 5
- L-15 CONSTRUCTION DETAILS 6
- L-16 CONSTRUCTION DETAILS 7
 PE-000 VORTEX PLUMBING & ELECTRICAL COVER SHEET
- PE-001 VORTEX PLUMBING & ELECTRICAL LAYOUT
- E-003 VORTEX BONDING LAYOUT

DEMOLITION PLAN GENERAL NOTES

- 1. ALL SITE PREPARATION NECESSARY TO COMPLETE THIS PROJECT IS THE SOLE RESPONSIBILITY OF THE CONTRACTOR.
- 2. IT IS THE CONTRACTOR'S RESPONSIBILITY TO COORDINATE WITH PROVIDENCE PARKS DEPARTMENT STAFF TO DEVELOP A SUITABLE DEMOLITION PLAN, WHICH WILL MINIMIZE PARK DISTURBANCE AND ALLOW ALL FACILITIES TO REMAIN IN OPERATION DURING THE ENTIRETY OF CONSTRUCTION.
- 3. UNLESS OTHERWISE NOTED, THE CONTRACTOR IS RESPONSIBLE FOR THE RELOCATION, DEMOLITION, REMOVAL AND DISPOSAL, IN A LOCATION APPROVED BY ALL GOVERNING AUTHORITIES, OF ALL EXISTING SITE ELEMENTS AND STRUCTURES INCLUDING BUT NOT LIMITED TO BITUMINOUS CONCRETE, CEMENT CONCRETE, GRAVEL, CURBS, WALKWAYS, SIDEWALKS, BERMS, FENCES, BOLLARDS, POSTS, PLANTING BEDS, TREES, SHRUBS, UTILITIES, DRAINAGE STRUCTURES AND ALL OTHER STRUCTURES SHOWN WITHIN THE LIMITS, AND WHERE NEEDED, TO ALLOW FOR NEW CONSTRUCTION. ALL ELEMENTS TO BE REMOVED SHALL BE UNDERCUT TO SUITABLE MATERIAL AND BROUGHT TO GRADE WITH SUITABLE COMPACTED FILL MATERIAL PER SPECIFICATIONS.
- 4. THE CONTRACTOR IS RESPONSIBLE FOR REMOVING ALL DEBRIS FROM THE SITE AND DISPOSING OF THE DEBRIS IN A PROPER AND LEGAL MANNER.
- 5. THE CONTRACTOR IS SPECIFICALLY CAUTIONED THAT THE LOCATION AND.OR ELEVATION OF EXISTING UTILITIES AND STRUCTURES AS SHOWN ON THESE PLANS ARE BASED ON RECORDS OF VARIOUS UTILITY COMPANIES, AND WHEREVER POSSIBLE, MEASUREMENTS TAKEN IN THE FIELD. THIS INFORMATION IS NOT TO BE RELIED UPON AS BEING EXACT OR COMPLETE. THE LOCATION OF ALL UNDERGROUND UTILITIES AND STRUCTURES SHALL BE VERIFIED IN THE FIELD BY THE CONTRACTOR PRIOR TO THE START OF CONSTRUCTION. THE CONTRACTOR MUST CONTACT THE APPROPRIATE UTILITY COMPANY, ANY GOVERNING PERMITTING AUTHORITY IN THE CITY, AND "DIGSAFE" (1-800-344-7233) AT LEAST 72 HOURS PRIOR TO ANY EXCAVATION WORK IN PREVIOUSLY UNALTERED AREAS TO REQUEST EXACT FIELD LOCATION OF UTILITIES. IT SHALL BE THE RESPONSIBILITY OF THE CONTRACTOR TO RESOLVE CONFLICTS BETWEEN THE PROPOSED UTILITIES AND FIELD-LOCATED UTILITIES AND SHALL REPORT ANY DISCREPANCIES TO THE LANDSCAPE ARCHITECT IMMEDIATELY. THE OWNER ASSUMES NO RESPONSIBILITY FOR DAMAGES INCURRED AS A RESULT OF UTILITIES OMITTED, INCOMPLETELY OR INACCURATELY SHOWN. THE CONTRACTOR SHALL BE RESPONSIBLE FOR MAINTAINING ACCURATE RECORDS OF THE LOCATION AND ELEVATION OF ALL WORK INSTALLED AND EXISTING UTILITIES FOUND DURING CONSTRUCTION FOR THE PREPARATION OF THE AS-BUILT PLAN.
- 6. THE CONTRACTOR IS RESPONSIBLE FOR MAINTAINING ALL EXISTING UTILITIES IN WORKING ORDER AND FREE FROM DAMAGE DURING THE ENTIRE DURATION OF THE PROJECT. ALL COST RELATED TO THE REPAIR OF UTILITIES SHALL BE THE RESPONSIBILITY OF THE CONTRACTOR. EXCAVATION REQUIRED WITHIN THE PROXIMITY OF EXISTING UTILITY LINES SHALL BE DONE BY HAND. CONTRACTOR SHALL REPAIR ANY DAMAGE TO EXISTING UTILITY LINE OR STRUCTURES INCURRED DURING CONSTRUCTION OPERATIONS AT NO COST TO THE OWNER
- 7. THE CONTRACTOR SHALL MAINTAIN CONTINUOUS ACCESS AND OPERATION FOR SURROUNDING FACILITIES, AS DEEMED BY THE OWNER, AT ALL TIMES DURING DEMOLITION OF THE EXISTING FACILITIES.
- PRIOR TO DEMOLITION OCCURRING, ALL EROSION CONTROL DEVICES AND TREE
 PROTECTIVE MEASURES ARE TO BE INSTALLED.

EROSION & SEDIMENT CONTROL NOTES

- THE SITE CONSTRUCTION FOREMAN SHALL BE DESIGNATED AS THE ON-SITE PERSONNEL RESPONSIBLE FOR THE DAILY INSPECTION AND MAINTENANCE OF ALL ESC MEASURES AND SHALL IMPLEMENT ALL NECESSARY MEASURES TO CONTROL EROSION AND PREVENT SEDIMENT FROM LEAVING THE SITE.
- 2. THE CONTRACTOR SHALL INSTALL ALL ESC MEASURES AS SHOWN ON THE DESIGN PLANS AND AS DETERMINED NECESSARY IN THE FIELD BY OWNER'S REPRESENTATIVE BEFORE ANY CONSTRUCTION ACTIVITIES ARE TO BEGIN. THESE MEASURES SHALL BE CHECKED, MAINTAINED/REPLACED AS NECESSARY DURING THE ENTIRE CONSTRUCTION PERIOD OF THE PROJECT. SUCH MEASURES SHALL REPRESENT THE LIMIT OF WORK. WORKERS SHALL BE INFORMED THAT NO CONSTRUCTION ACTIVITY IS TO OCCUR BEYOND THE LIMIT OF WORK AT ANY TIME THROUGH THE
- 3. A MINIMUM SURPLUS OF 100 FEET OF EROSION CONTROL BARRIER (SILT FENCE&/OR SILT SOCK) SHALL BE STOCKPILED ONSITE AT ALL TIMES.
- 4. THE CONTRACTOR SHALL PROTECT THE ADJACENT AREA FROM SEDIMENTATION DURING PROJECT CONSTRUCTION OPERATIONS.
- 5. A CONSTRUCTION EXIT SHALL BE CONSTRUCTED TO SHED DIRT FROM CONSTRUCTION VEHICLE TIRES. THE CONSTRUCTION EXIT SHALL BE REPLACED/CLEANED AS NEEDED TO MAINTAIN ITS EFFECTIVENESS.
- 6. THE LIMIT OF ALL CLEARING, GRADING AND DISTURBANCES SHALL BE KEPT TO A MINIMUM WITHIN THE PROPOSED AREA OF CONSTRUCTION. THE CONTRACTOR SHALL PHASE THE SITE WORK IN A MANNER TO MINIMIZE AREAS OF EXPOSED SOIL.
- 7. IT IS THE CONTRACTOR'S RESPONSIBILITY TO MONITOR LOCAL WEATHER REPORTS DURING CONSTRUCTION AND PRIOR TO SCHEDULING EARTHMOVING OR OTHER CONSTRUCTION ACTIVITIES WHICH WILL LEAVE LARGE DISTURBED AREAS UNSTABILIZED. IF INCLEMENT WEATHER IS PREDICTED, THE CONTRACTOR SHALL USE THEIR BEST PROFESSIONAL JUDGEMENT AND SHALL BE RESPONSIBLE FOR ENSURING THAT NECESSARY EROSION CONTROL DEVICES ARE INSTALLED AND FUNCTIONING PROPERLY TO MINIMIZE EROSION FROM ANY IMPENDING WEATHER EVENTS.
- 8. SOIL ESC MEASURES SHALL BE INSPECTED AND MAINTAINED ON A WEEKLY BASIS AND AFTER EACH RAINFALL EVENT OF 0.25 INCH OR GREATER DURING CONSTRUCTION TO ENSURE THAT THE ESC MEASURES ARE INTACT AND FUNCTIONING PROPERLY. IDENTIFIED DEFICIENCIES SHALL BE CORRECTED IMMEDIATELY NO LATER THAN 24 HOURS AFTER IDENTIFICATION.

- 9. SOIL STOCKPILES LEFT OVERNIGHT SHALL BE SURROUNDED ON THEIR PERIMETERS WITH SILT SOCK.
- 10. DISTURBED AREAS AND SLOPES SHALL NOT BE LEFT UNATTENDED OR EXPOSED FOR EXCESSIVE PERIODS OF TIME SUCH AS THE INACTIVE WINTER SEASON. THE CONTRACTOR SHOULD PROVIDE APPROPRIATE STABILIZATION PRACTICES ON ALL DISTURBED AREAS AS SOON AS POSSIBLE BUT NOT MORE THAN 14 DAYS AFTER THE CONSTRUCTION ACTIVITY IN THAT AREA HAS TEMPORARILY OR PERMANENTLY CEASED. TEMPORARY AREAS HAVING A SLOPE GREATER THAN 3:1 SHALL BE REINFORCED WITH EROSION BLANKETS OR APPROVED EQUAL UNTIL THE SITE IS PROPERLY STABILIZED. TEMPORARY SWALES MAY ALSO BE REQUIRED IF DETERMINED NECESSARY IN THE FIELD BY OWNER'S REPRESENTATIVE.
- 11. THE CONTRACTOR SHALL CONTAIN ALL SEDIMENT ONSITE. ALL EXITS FROM THE SITE WILL BE SWEPT AS NECESSARY INCLUDING ANY SEDIMENT TRACKING. PAVED AREAS SHALL BE SWEPT AS NEEDED TO REMOVE SEDIMENT AND POTENTIAL POLLUTANTS WHICH MAY ACCUMULATE DURING SITE WORK.
- 12. ACCUMULATED SEDIMENT SHALL BE REMOVED FROM ALL ESC MEASURES AND DISPOSED OF IN A PRE-APPROVED LOCATION BY THE CONTRACTOR.
- 13. DUST SHALL BE CONTROLLED BY WATERING OR OTHER APPROVED METHODS AS NECESSARY.

GENERAL CONSTRUCTION NOTES

- 1. INFORMATION FOR THE EXISTING CONDITIONS PLAN WAS OBTAINED FROM GIS, AERIAL IMAGERY, AND FIELD OBSERVATION. ALL EXISTING CONDITIONS ARE TO BE CONSIDERED APPROXIMATE. THIS IS NOT A REGISTERED SURVEY.
- 2. ANY ERRORS OR DISCREPANCIES ON THE DRAWINGS, SHOP DRAWINGS, AND DETAILS ARE TO BE BROUGHT TO THE ATTENTION OF THE OWNER'S REPRESENTATIVE BEFORE THE WORK HAS COMMENCED.
- 3. THE CONTRACTOR IS RESPONSIBLE FOR FIELD VERIFICATION OF ALL LOCATIONS AND DIMENSIONS. DISCREPANCIES BETWEEN LAYOUT DIMENSIONS ON PLANS AND ACTUAL MEASUREMENTS IN FIELD ARE TO BE REPORTED TO THE OWNER'S REPRESENTATIVE BEFORE CONSTRUCTION BEGINS.
- 4. THE CONTRACTOR SHALL NOTIFY THE OWNER'S REPRESENTATIVE PRIOR TO DEMOLITION OR INSTALLATION OF ANY PORTION OF THE SITE WORK.
- 5. THE CONTRACTOR SHALL STAKE OUT ALL LAYOUTS OF PROPOSED WORK FOR APPROVAL BY THE OWNER'S REPRESENTATIVE PRIOR TO COMMENCING WORK.
- 6. THE CONTRACTOR SHALL BE RESPONSIBLE FOR ESTABLISHING AND MAINTAINING ALL CONTROL POINTS AND BENCHMARKS DURING CONSTRUCTION INCLUDING BENCHMARK LOCATIONS AND ELEVATIONS AT CRITICAL AREAS. THE LOCATION OF ALL CONTROL POINTS AND BENCHMARKS SHALL BE COORDINATED WITH THE OWNER'S REPRESENTATIVE.
- 7. UNLESS OTHERWISE SPECIFIED ON THE PLANS AND DETAILS/SPECIFICATIONS, ALL SITE CONSTRUCTION MATERIALS AND METHODOLOGIES ARE TO CONFORM TO THE MOST RECENT VERSION OF THE RHODE ISLAND DEPARTMENT OF TRANSPORTATION STANDARD SPECIFICATIONS (THE RHODE ISLAND DEPARTMENT OF TRANSPORTATION STANDARD SPECIFICATIONS FOR ROAD AND BRIDGE CONSTRUCTION 2015 EDITION).
- 8. CONSTRUCTION SHALL BE PERFORMED IN ACCORDANCE WITH APPLICABLE LAWS AND REGULATIONS REGARDING NOISE, VIBRATION, DUST, SEDIMENTATION CONTAINMENT, AND TRENCH WORK.
- 9. THE CONTRACTOR SHALL RESTORE ALL SURFACES EQUAL TO THEIR ORIGINAL CONDITION AFTER CONSTRUCTION IS COMPLETE. AREAS NOT DISTURBED BY CONSTRUCTION SHALL BE LEFT NATURAL. THE CONTRACTOR SHALL TAKE CARE TO PREVENT DAMAGE TO SHRUBS, TREES, AND OTHER LANDSCAPING OR NATURAL FEATURES, WHEREAS THE PLANS DO NOT SHOW ALL LANDSCAPING FEATURES. EXISTING CONDITIONS MUST BE VERIFIED BY THE CONTRACTOR IN ADVANCE OF THE WORK.
- 10. ALL UNPAVED AREAS DISTURBED BY THE WORK SHALL HAVE A MINIMUM OF 4-INCHES OF LOAM INSTALLED AND SEEDED WITH GRASS SEED AS SHOWN ON THE PLAN AND/OR DIRECTED BY THE LANDSCAPE ARCHITECT. THE CONTRACTOR SHALL BE RESPONSIBLE FOR WATERING ANY LOAM AND SEEDED AREAS UNTIL LAWN GROWTH IS ESTABLISHED AND APPROVED BY THE LANDSCAPE ARCHITECT AND/OR OWNER'S REPRESENTATIVE.
- 11. THE CONTRACTOR SHALL REGULARLY INSPECT THE PERIMETER OF THE PROPERTY TO CLEAN UP AND REMOVE ANY LOOSE CONSTRUCTION DEBRIS BEFORE IT LEAVES THE SITE. ALL DEMOLITION DEBRIS SHALL BE PROMPTLY REMOVED FROM THE SITE TO AN APPROVED DUMP SITE. ALL TRUCKS LEAVING THE SITE SHALL BE COVERED.
- 12. CONCRETE TRUCKS SHALL NOT BE WASHED ONSITE. ANY CEMENT OR CONCRETE DEBRIS LEFT IN THE DISTURBED AREA SHALL BE REMOVED BY HAND AT THE CONTRACTOR'S EXPENSE.
- 13. IF ANY DEVIATION OR ALTERATION OF THE WORK PROPOSED ON THESE DRAWINGS IS REQUIRED, THE CONTRACTOR IS TO IMMEDIATELY CONTACT AND COORDINATE WITH THE LANDSCAPE ARCHITECT AND THE OWNER'S REPRESENTATIVE.
- 14. AT THE END OF CONSTRUCTION, THE CONTRACTOR SHALL REMOVE ALL CONSTRUCTION DEBRIS AND SURPLUS MATERIAL FROM THE SITE. A THOROUGH INSPECTION OF THE WORK PERIMETER IS TO BE MADE AND ALL DISCARDED MATERIALS, BLOWN OR WATER CARRIED DEBRIS, SHALL BE COLLECTED AND REMOVED FROM THE SITE.
- 15. THE CONTRACTOR IS RESPONSIBLE FOR SECURING THE SITE FOR THE SAFETY OF THE GENERAL PUBLIC AND TO PROTECT PROPERTY AGAINST VANDALISM AND THEFT.
- 16. THE CONTRACTOR MUST OBTAIN ALL REQUIRED CITY, STATE AND FEDERAL PERMITS.
- 17. THE PROVIDENCE PARKS DEPARTMENT ASSUMES NO RESPONSIBILITY IF THE WORK IS NOT INSTALLED AS PER THE PLANS OR IF FIELD CHANGES ARE MADE WITHOUT THE KNOWLEDGE AND APPROVAL OF THE OWNER'S REPRESENTATIVE.

LAYOUT NOTES

- 1. ALL LINES AND DIMENSIONS ARE PARALLEL OR PERPENDICULAR TO THE LINES FROM WHICH THEY ARE MEASURED UNLESS OTHERWISE INDICATED.
- 2. STORAGE AREAS FOR CONTRACTOR'S EQUIPMENT AND MATERIALS SHALL BE ON AND WITHIN LIMITS OF WORK AS SHOWN ON THE PLANS AND AS APPROVED BY THE OWNER'S REPRESENTATIVE.
- CONTRACTOR SHALL VERIFY ALL EXISTING CONDITIONS IN THE FIELD AND REPORT ANY DISCREPANCIES IN THE PLAN TO THE OWNER'S REPRESENTATIVE PRIOR TO STARTING WORK.
- 4. ALL LAYOUTS FOR WALKS AND PATHS SHALL BE ADEQUATELY STAKED BY THE CONTRACTOR AND APPROVED BY THE OWNER'S REPRESENTATIVE PRIOR TO CONSTRUCTION.
- 5. ALL PLACEMENT OF SITE FURNISHINGS, BOULDERS, PLAY STRUCTURES AND OUTDOOR FITNESS EQUIPMENT TO BE APPROVED BY LANDSCAPE ARCHITECT PRIOR TO INSTALLATION.

PLANTING NOTES


- 1. ALL NEW PLANT MATERIALS SHALL CONFORM TO THE MINIMUM GUIDELINES ESTABLISHED FOR NURSERY STOCK PUBLISHED BY THE AMERICAN ASSOCIATION OF NURSERYMEN, INC. IN ADDITION, ALL NEW PLANT MATERIAL FOR THE PROJECT SHALL BE OF SPECIMEN QUALITY.
- 2. ALL NEW PLANTS TO BE BALLED AND BURLAPPED OR CONTAINER GROWN, UNLESS OTHERWISE NOTED ON THE PLANT LIST.
- 3. THE CONTRACTOR SHALL SUPPLY ALL NEW PLANT MATERIAL IN QUANTITIES SUFFICIENT TO COMPLETE THE PLANTING SHOWN ON THE DRAWINGS.
- 4. ANY PROPOSED SUBSTITUTIONS OF PLANT SPECIES SHALL BE MADE WITH PLANTS OF EQUIVALENT OVERALL FORM, HEIGHT, BRANCHING HABIT, FLOWER, LEAF, COLOR, FRUIT AND CULTURE, AND ONLY AFTER WRITTEN APPROVAL OF THE LANDSCAPE ARCHITECT.
- 5. ALL NEW PLANTS SHALL BE TAGGED AND APPROVED BY THE LANDSCAPE ARCHITECT AT THE NURSERY PRIOR TO DIGGING OR DELIVERY TO THE SITE.6. CONTRACTOR SHALL LOCATE AND VERIFY ALL EXISTING UTILITY LINES PRIOR TO PLANTING
- AND SHALL REPORT ANY CONFLICTS TO THE LANDSCAPE ARCHITECT.

 7. STAKE LOCATIONS OF ALL PROPOSED PLANTING FOR APPROVAL BY THE LANDSCAPE ARCHITECT PRIOR TO THE COMMENCEMENT OF PLANTING. INDIVIDUAL STAKES SHALL BE
- ARCHITECT PRIOR TO THE COMMENCEMENT OF PLANTING. INDIVIDUAL STAKES SHALL BE PLACED FOR TREES AND SHRUBS. EDGE OF PLANTING BEDS SHALL BE PAINTED. NOTIFY LANDSCAPE ARCHITECT 24 HOURS PRIOR TO DESIRED APPROVAL.
- 8. ALL NEW PLANTS SHALL BE SUPPLIED AND INSTALLED DURING THE PERIODS OF APRIL 1 JUNE 15 AND/OR SEPTEMBER 1 NOVEMBER 15 PER SPECIFICATIONS.
- 9. PREPARE ALL INDIVIDUAL TREE PITS AND SHRUB PLANTING BEDS TO A MINIMUM DEPTH OF EIGHTEEN INCHES (18") WITH SPECIFIED PLANTING MIX: 50% SCREENED TOPSOIL, 40% EXISTING SOIL AND 10% COMPOST. BLEND COMPOST INTO TOP 4" OF SOIL. PLANTING MIX SHALL BE FREE OF LUMPS, STONES, PLANTS, ROOTS, AND OTHER FOREIGN MATTER.
- 10. ALL SHRUB BEDS AND INDIVIDUAL TREE PITS SHALL RECEIVE THREE (3) INCHES OF BARK MULCH PER SPECIFICATIONS. PERENNIAL AND GROUNDCOVER BEDS SHALL RECEIVE TWO INCHES (2"). PROVIDE LANDSCAPE ARCHITECT WITH SAMPLE FOR APPROVAL.
- 11. ALL BURLAP, TWINE AND WIRE SHALL BE COMPLETELY REMOVED OR CUT AWAY AT TIME OF INSTALLATION.
- 12. PRUNE TREES IN ACCORDANCE WITH THE SPECIFICATIONS.
- 13. PLANT WARRANTY SHALL BE FOR ONE FULL GROWING SEASON FROM THE TIME OF SUBSTANTIAL COMPLETION.
- 14. LANDSCAPE CONTRACTOR SHALL BE RESPONSIBLE FOR REPLACING ALL DAMAGED, STOLEN, DEAD, DECLINING OR LOST MATERIAL UNTIL COMPLETION OF MAINTENANCE PERIODS OR GUARANTEE PERIODS.
- 15. IF NO IRRIGATION SYSTEM IS PLANNED, AN APPROPRIATE WATERING SCHEDULE SHALL BE ESTABLISHED BY THE LANDSCAPE CONTRACTOR FOR ALL PLANT MATERIAL BASED UPON PLANT SPECIES REQUIREMENTS AND PROVIDED IN WRITING TO THE LANDSCAPE ARCHITECT AND OWNER FOR REVIEW AND APPROVAL. THE APPROVED SCHEDULE SHOULD BE FOLLOWED UNTIL COMPLETION OF PLANT MAINTENANCE PERIODS OR WARRANTY PERIODS.
- 16. ALL VEGETATION AND DEBRIS SHALL BE REMOVED FROM PROPOSED PLANTING AREAS PRIOR TO PLANTING AND BACKFILLING. CONTRACTOR SHALL REMOVE ALL WEEDS AND DEBRIS FROM SITE AS WORK PROGRESSES AND UNTIL COMPLETION OF PLANT MAINTENANCE PERIODS OR WARRANTY PERIODS.
- 17. ALL AREAS TO BE SEEDED OR SODDED SHALL RECEIVE SIX INCHES (6") OF LOAM, MEASURED AFTER INSTALLATION, PRIOR TO SEEDING.
 18. ALL EXISTING LAWN AREAS DESIGNED TO REMAIN SHALL BE AERATED, FERTILIZED AND
- OVERSEEDED, AS DIRECTED BY THE LANDSCAPE ARCHITECT.

 19. IN ADDITION TO LOCATIONS DEFINED FOR SEED ON THE PLANTING PLAN, THE CONTRACTOR
- SHALL BE RESPONSIBLE FOR SEEDING ANY DISTURBED AREAS.

 20. A DETAILED PLANT MAINTENANCE MANUAL SHALL BE ESTABLISHED BY THE LANDSCAPE

 CONTRACTOR FOR ALL PLANT MATERIAL PASED LIBOUR PLANT CRECIES REQUIREMENTS AND
- CONTRACTOR FOR ALL PLANT MATERIAL BASED UPON PLANT SPECIES REQUIREMENTS AND PROVIDED IN WRITING TO THE LANDSCAPE ARCHITECT AND OWNER FOR REVIEW AND APPROVAL. INFORMATION THEREIN SHALL INCLUDE REQUIRED PRUNING SCHEDULE, FERTILIZING AND PROPOSED INTEGRATED PEST MANAGEMENT (IPM) AS NECESSARY. THE APPROVED MAINTENANCE SHOULD BE FOLLOWED UNTIL COMPLETION OF PLANT MAINTENANCE PERIODS OR WARRANTY PERIODS.
- 21. LANDSCAPE CONTRACTOR IS RESPONSIBLE FOR MAINTAINING CLOSE COORDINATION WITH OWNER, GENERAL CONTRACTOR, RELATED SUBCONTRACTORS, LANDSCAPE ARCHITECT, AND ALL SITE WORK RELATED ITEMS.

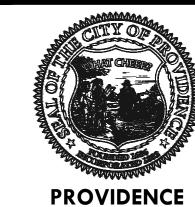

PROVIDENCE
PARKS DEPARTMENT
DALRYMPLE BOATHOUSE
ROGER WILLIAMS PARK

PROVIDENCE, RI 02905



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STAMP

PROJECT:

Site Improvements at Miguel Luna Park

110 Sackett St Providence, RI

REVISIONS:

2 4/8/2025 Addendum #2 - -

Issued For:

NORTH ARROW

SCALE

DRAWING INFO

DATE ISSUED: 03/24/25

PROJECT NO: MIGU.22.01


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SHEET TITLE


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Cover Sheet


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1 OF 22





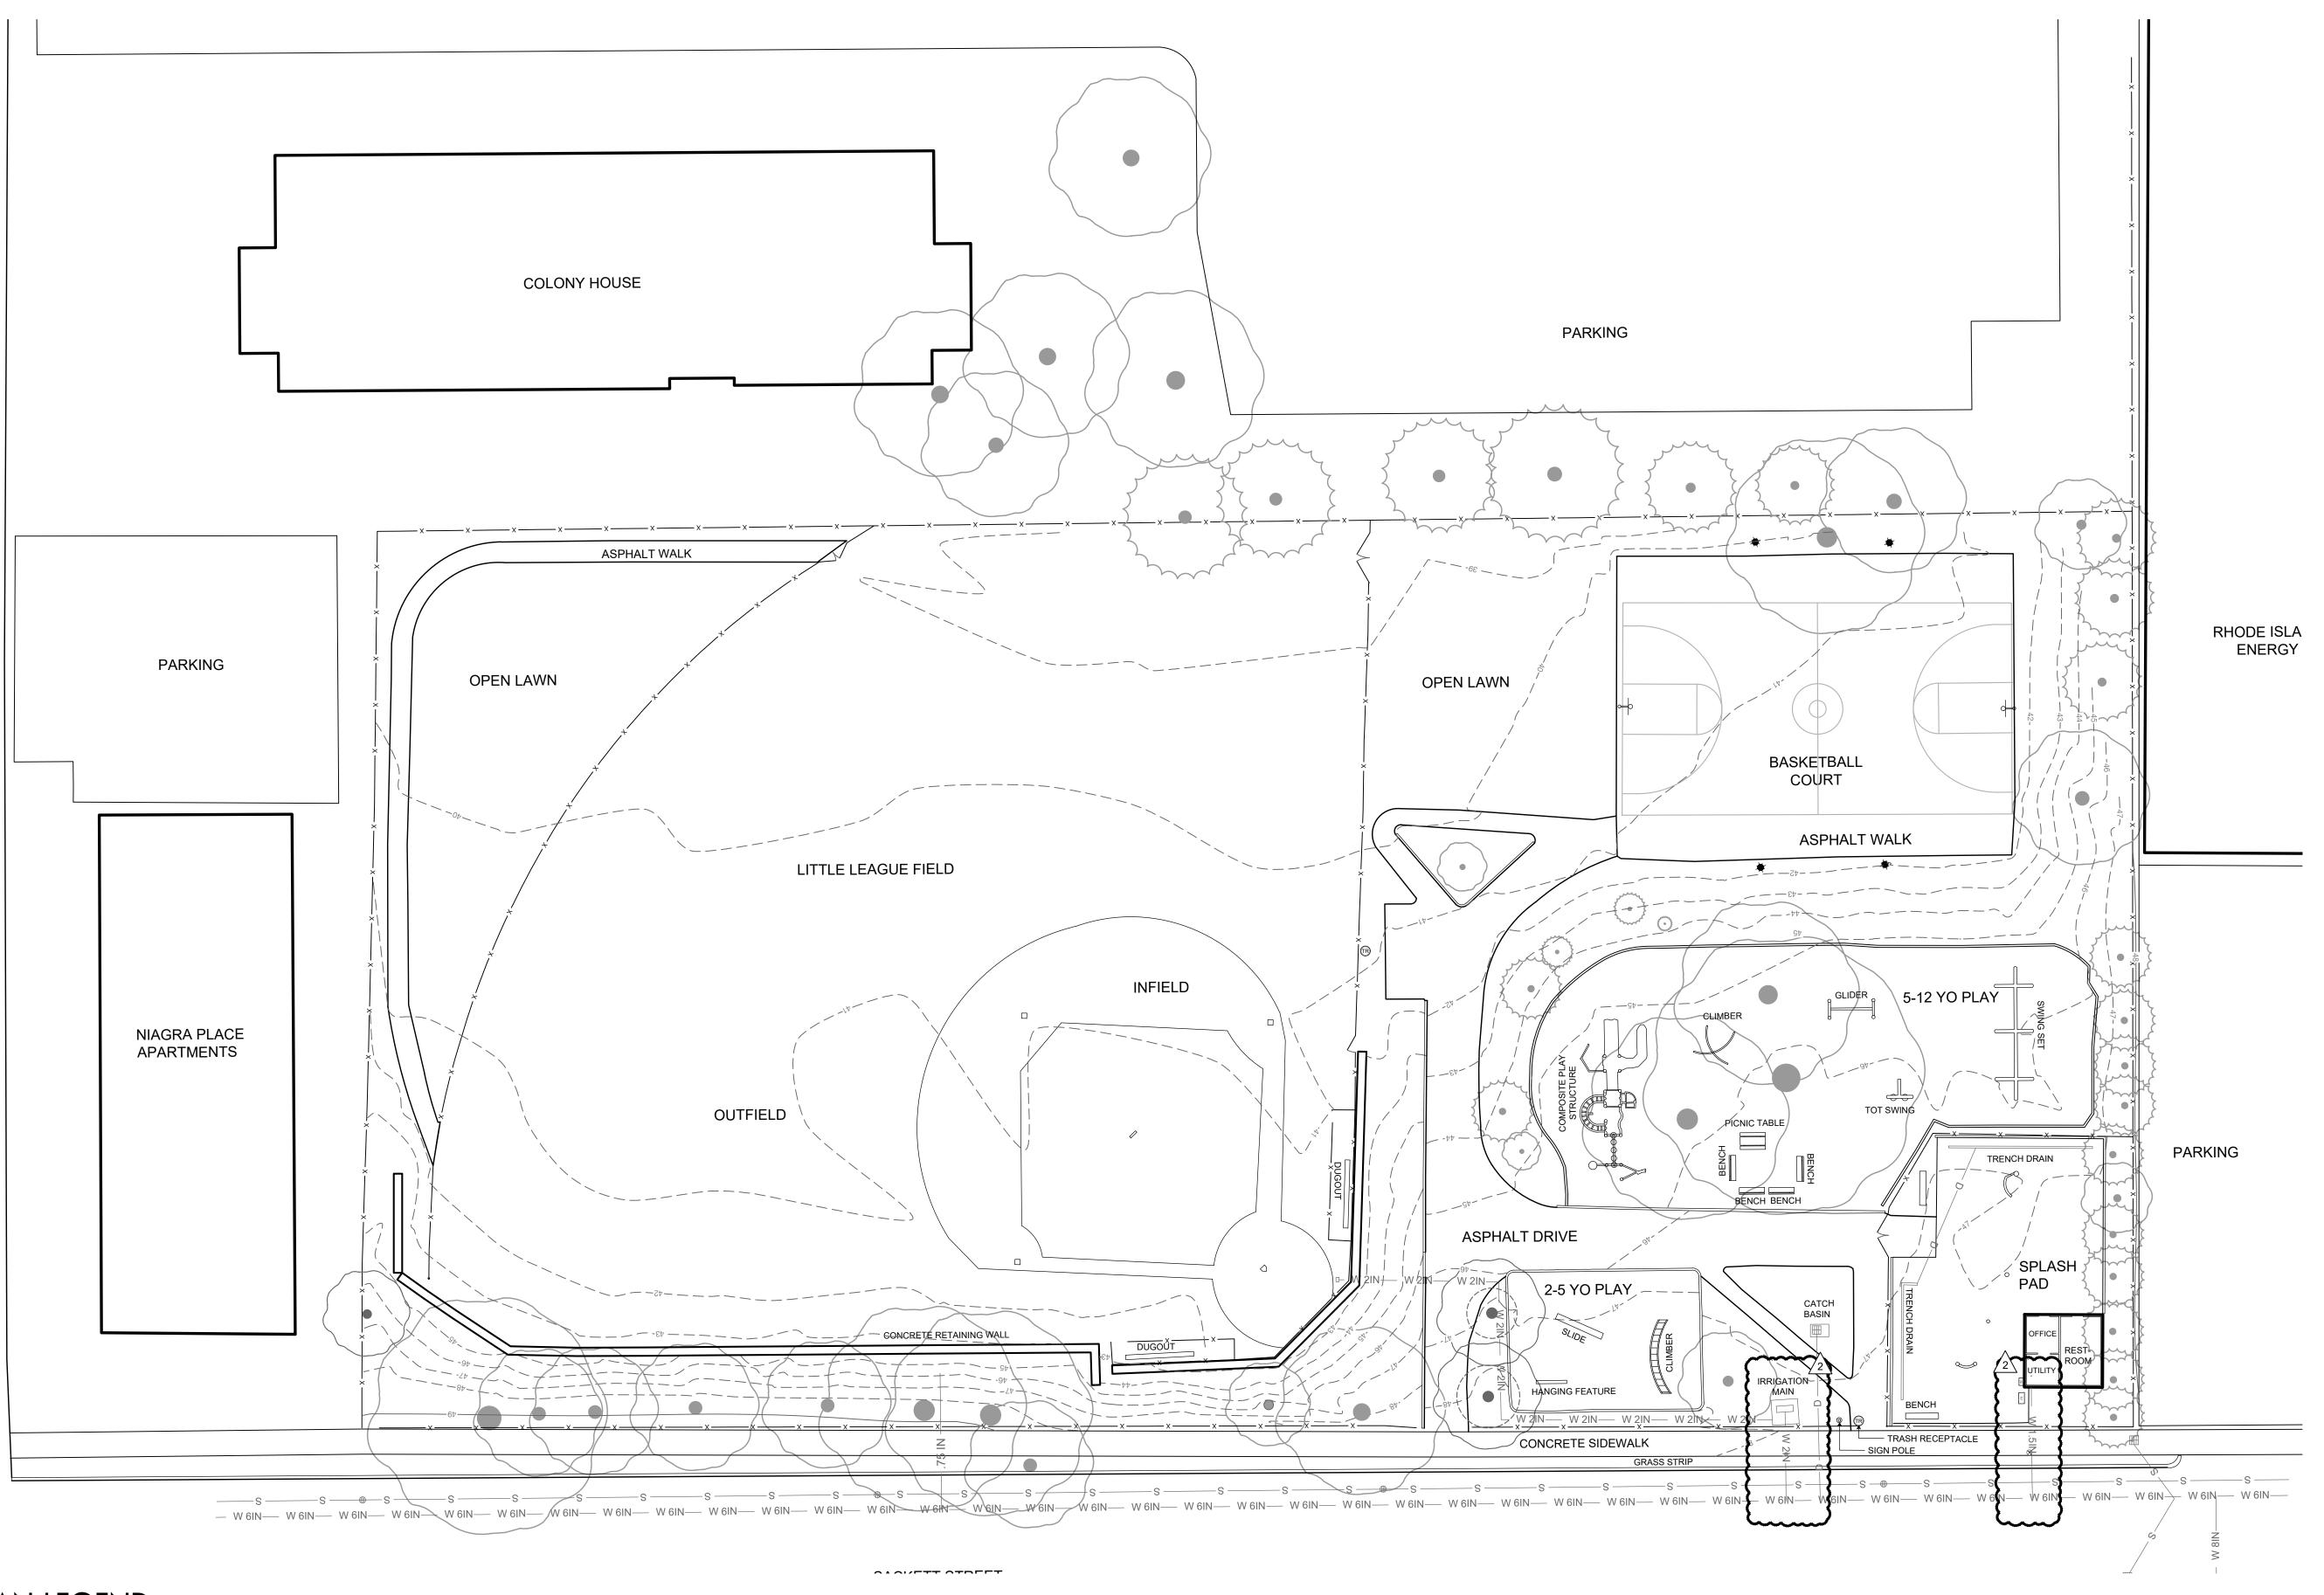

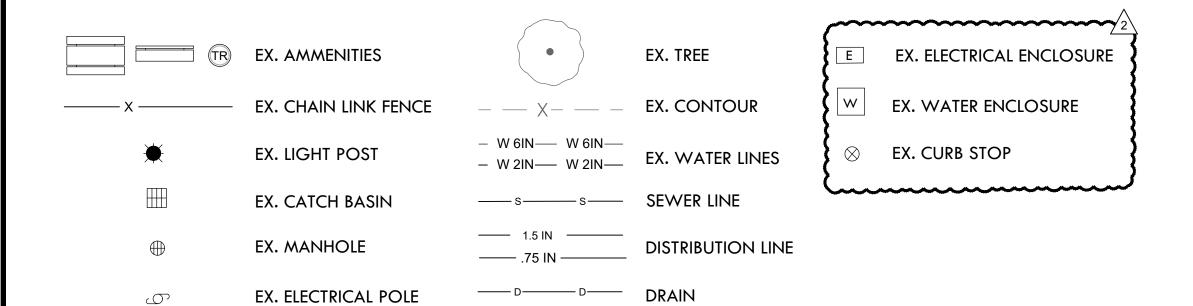PROVIDENCE

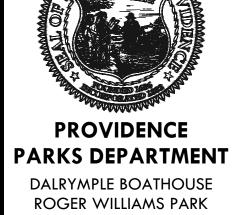



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PROJECT:


Site Improvements at Miguel Luna Park

110 Sackett St Providence, RI


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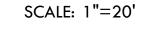
 $\sqrt{2}$ 4/8/2025 Addendum #2

NORTH ARROW

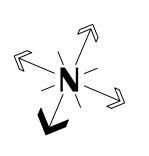

SCALE



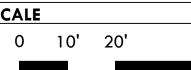


DRAWING INFO

DATE ISSUED: **03/24/25** PROJECT NO: MIGU.22.01 DRAWN BY: AN, II, SG CHECKED BY: MG

SHEET TITLE Existing Conditions

L-2 2 OF **22**

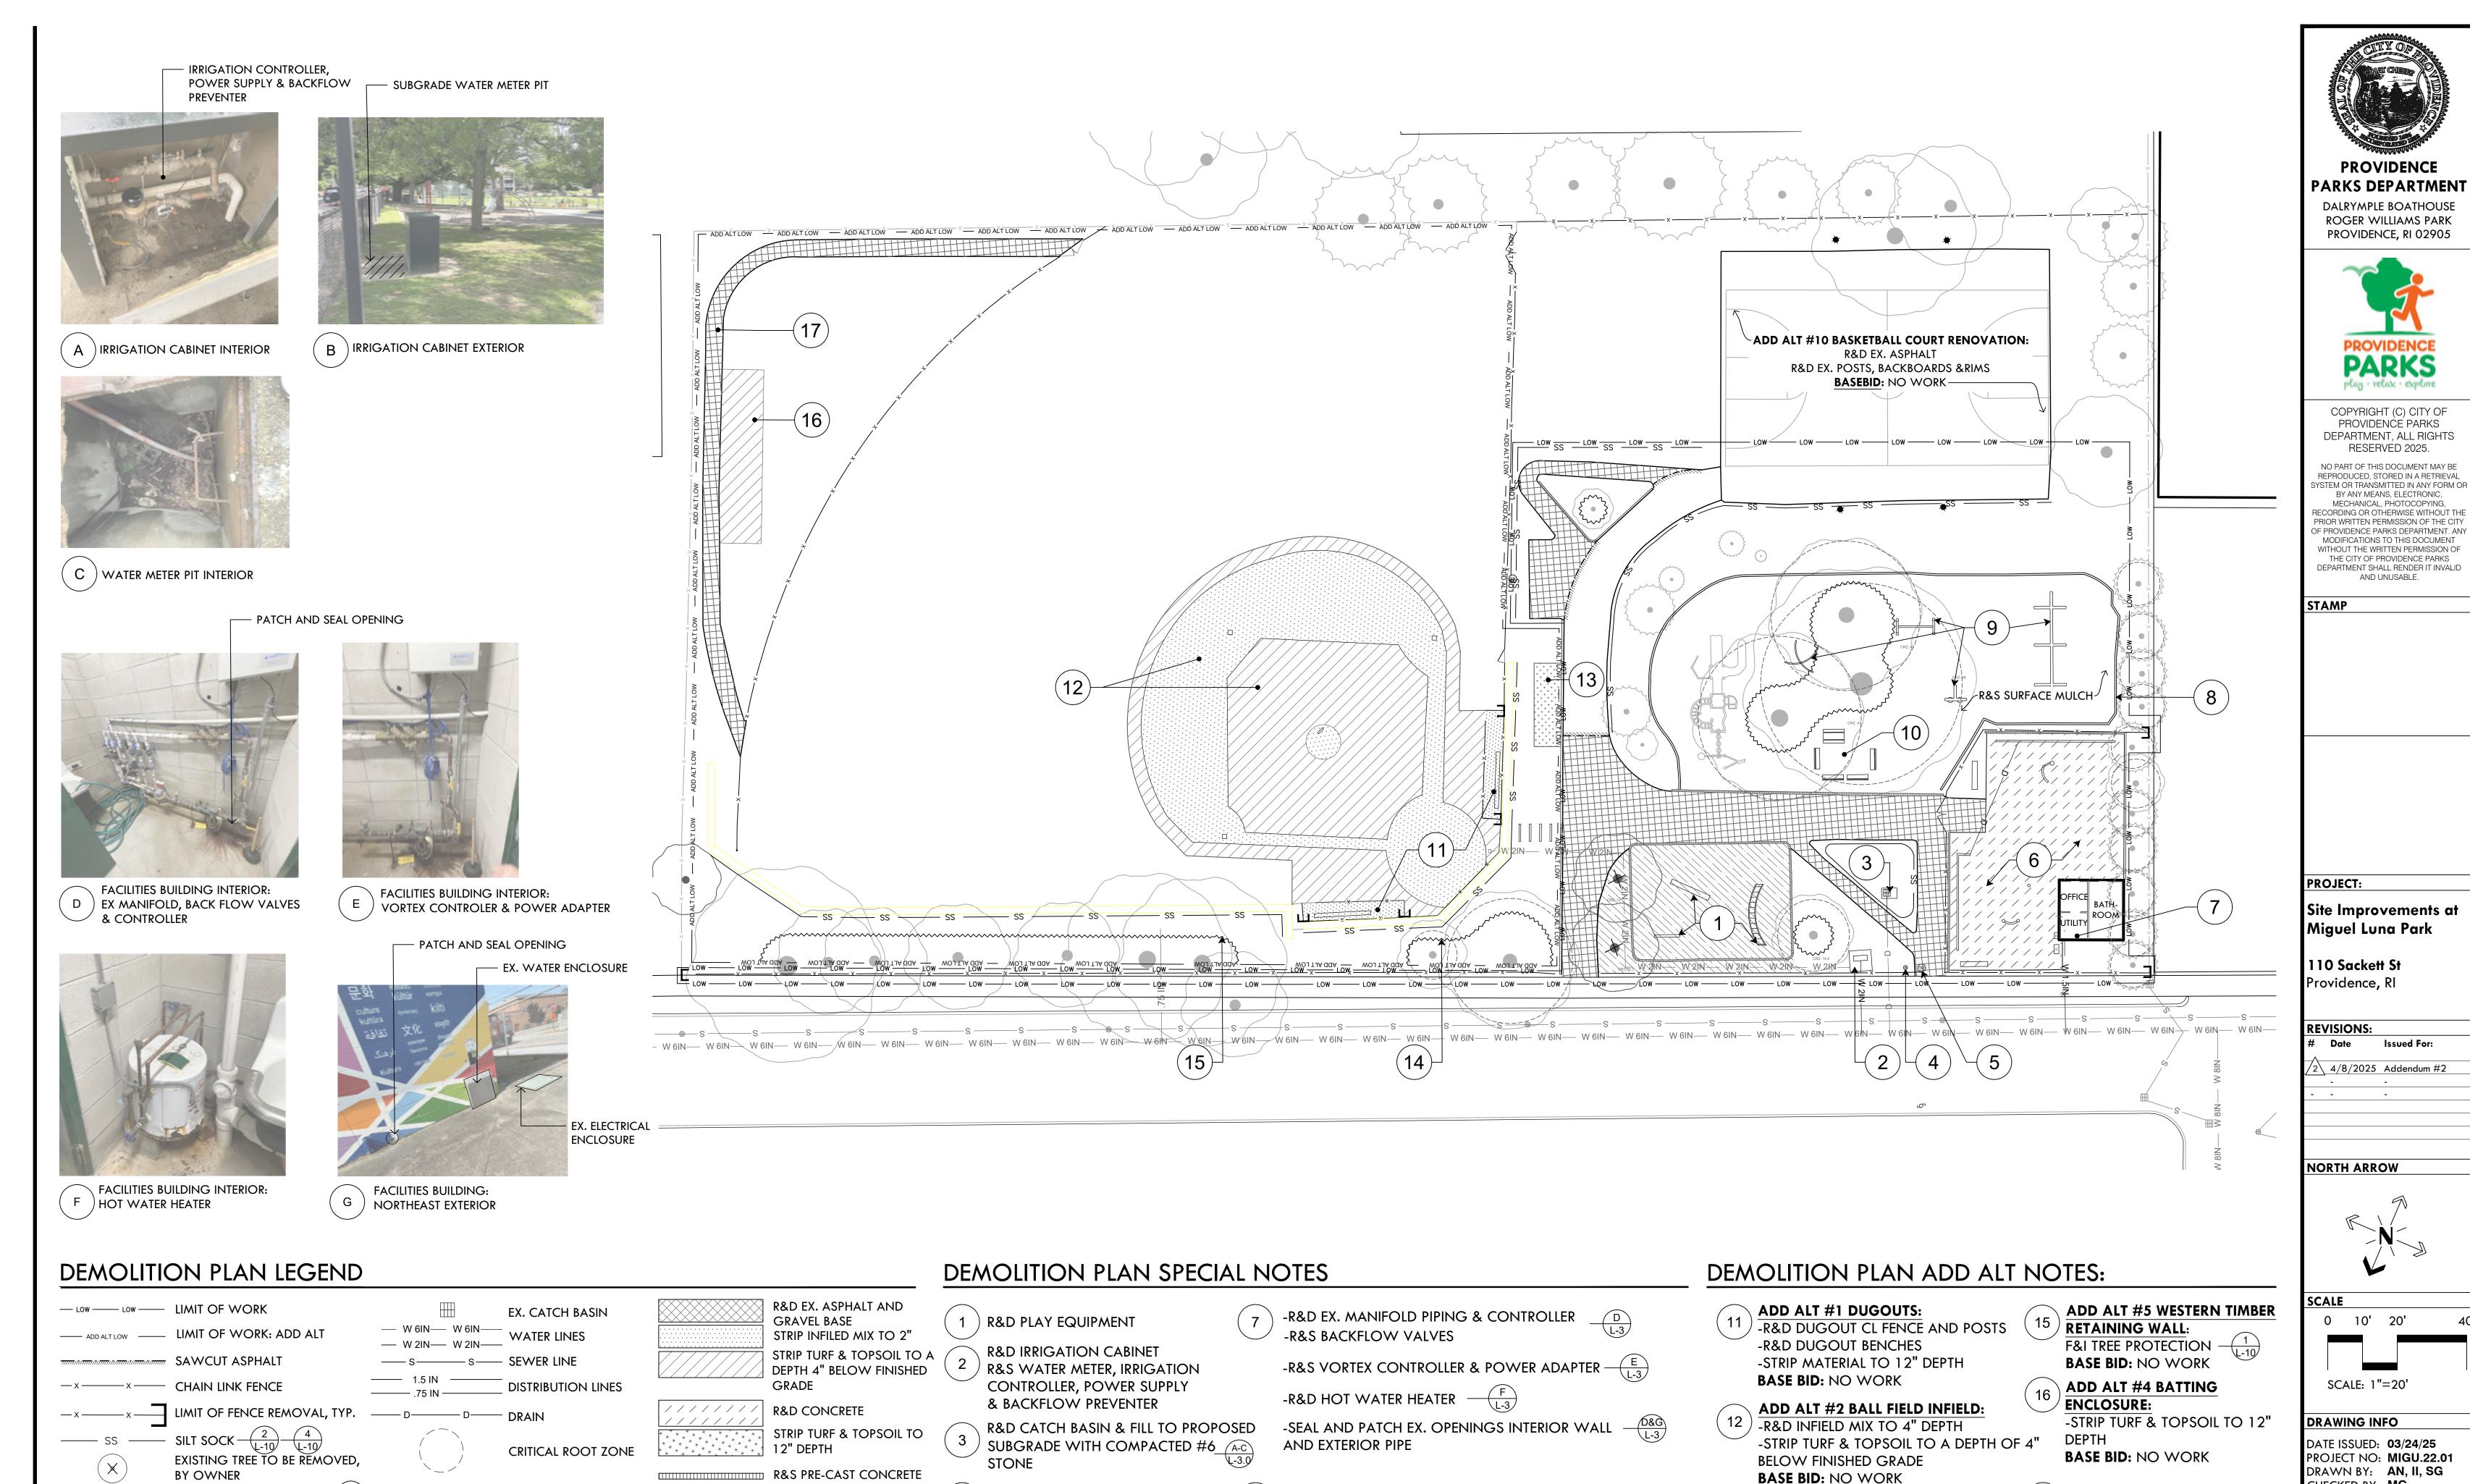

R&S MIGUEL LUNA GATEWAY

R&D ALL SPLASH PAD FEATURES,

TRENCH DRAINS, & BENCHES

SIGN & POLE

(5) R&S TRASH DRUMS

R&D PLASTIC EDGING

(10) R&D BENCHES AND PICNIC TABLE

R&D PLAY EQUIPMENT, HAND REMOVAL TO PROTECT ROOTS

CURB

SURFACING

REMOVE MATERIAL TO 12"

DEPTH, SALVAGE EWF ON

SITE TO REUSE AS MULCH,

NOT FOR USE AS SAFETY

REMOVE AND DISPOSE

REMOVE AND STOCKPILE

R&S

 \sim TREE PROTECTION FENCE $\frac{1}{L-10}$

EX. LIGHT POST

EX. POWER POLE

3 OF 22

SHEET TITLE **Demolition Plan**

CHECKED BY: MG

ADD ALT #8 ASPHALT WALK:

 $\sqrt{\mathsf{R&D}}$ ASPHALT WALK AND BASE

BASE BID: NO WORK

ADD ALT #3 BASEBALL BLEACHER:

-STRIP TURF & TOPSOIL TO 6" DEPTH

ADD ALT #5 EASTERN TIMBER


F&I TREE PROTECTION 1-10

BASE BID: NO WORK

RETAINING WALL:

BASE BID: NO WORK

L-3

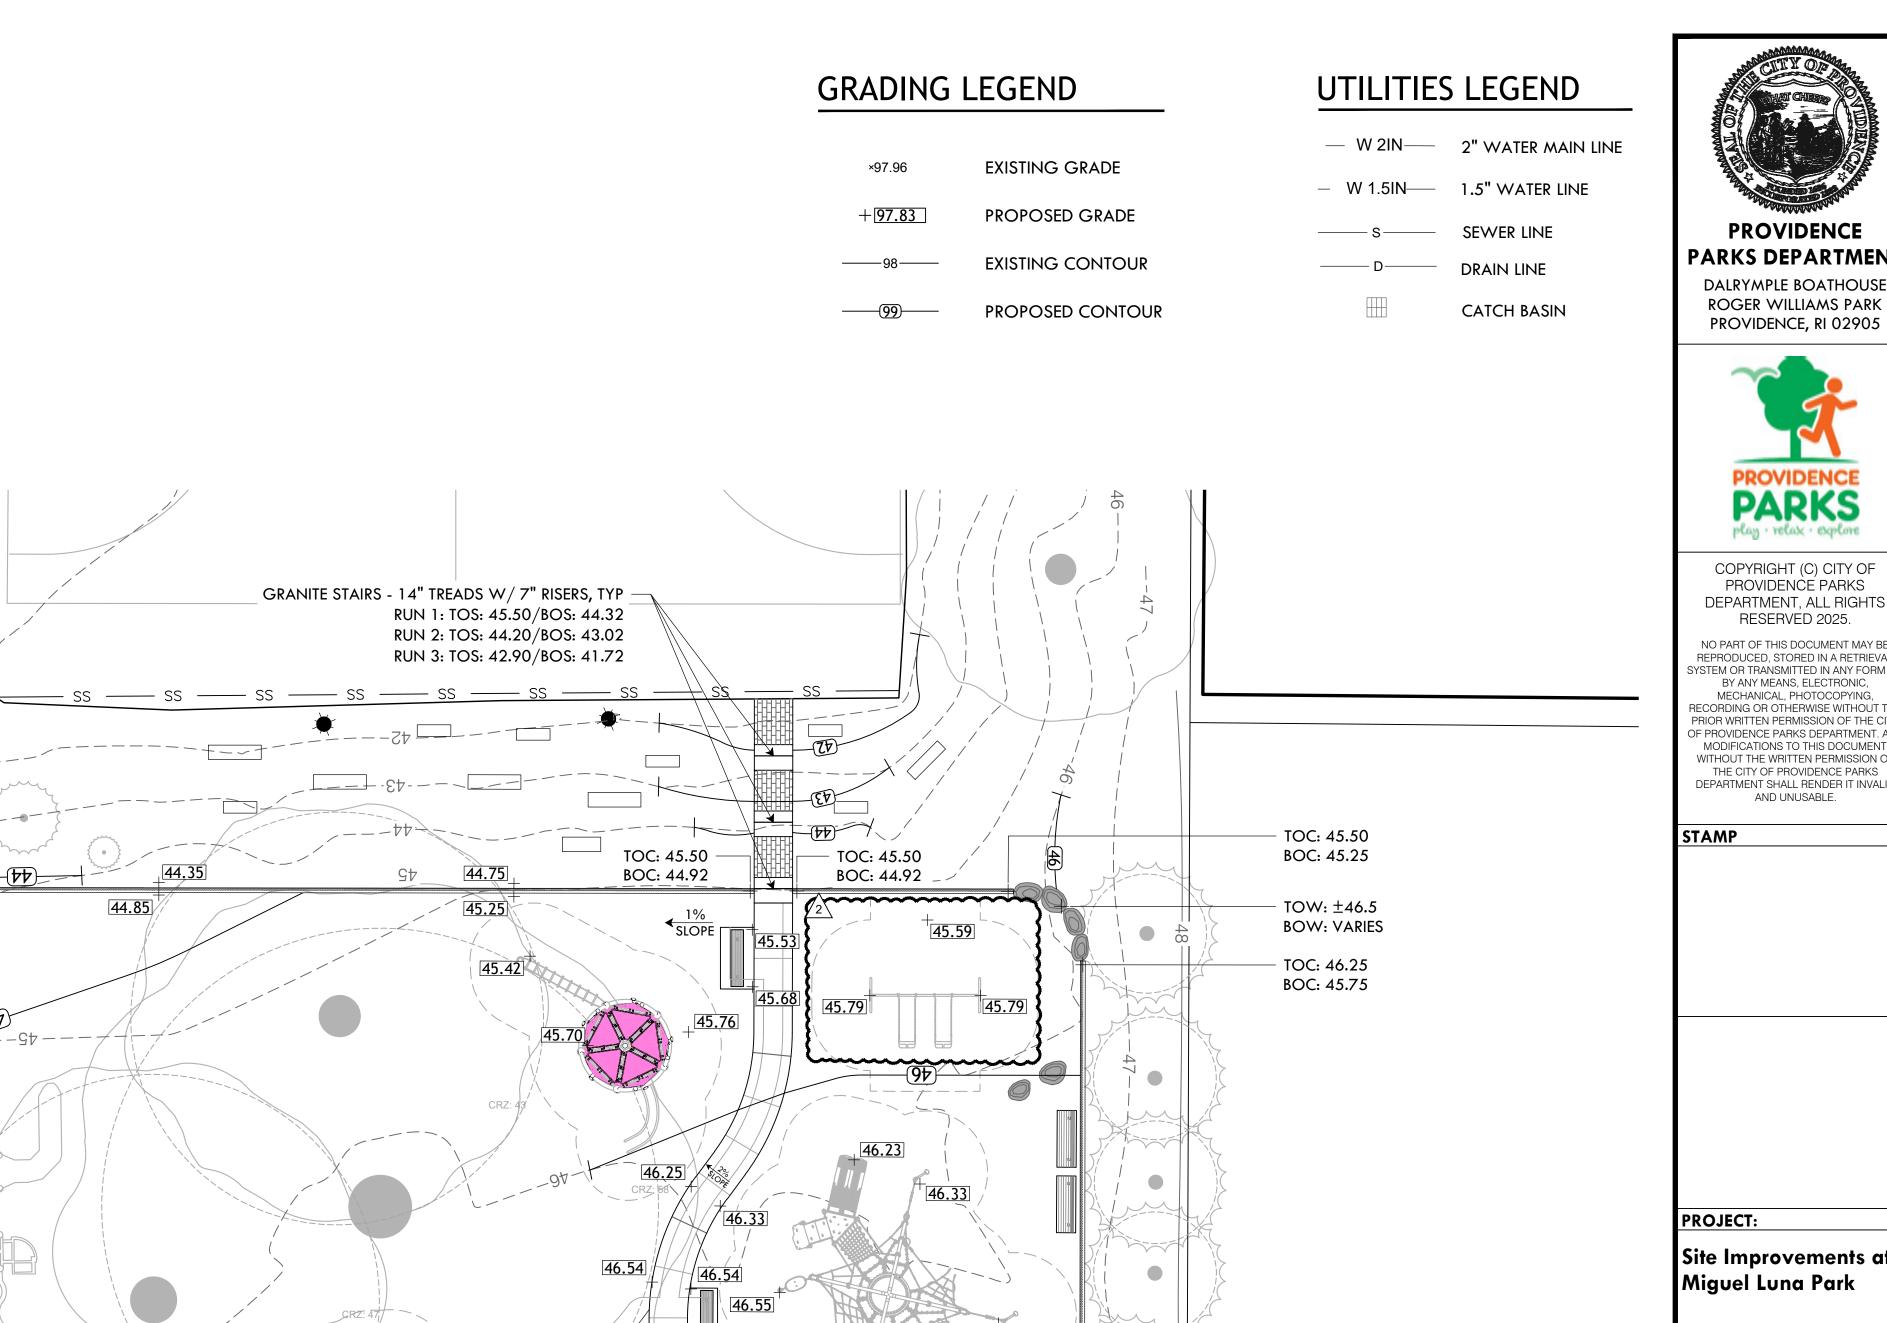

TOP BERM: 49.00 <

47.30

47.48

TOP BERM:

48.50

←1% + 47.24

47.38

6 DIG TRENCH FOR 2"
WATER LINE TO FACILITIES

BUILDING

\$100 47.48 P

47.92 CURB STOP

RECONNECT 2" LINE TO

FEED IRRIGATION

BENCHMARK

46.90

46.34

47.16

- TOC 48.08

BOC: 47.58

46.86

46.71

TOC: 44.65

BOC: 44.15

45.30

TOC: 46.26 BOC: 45.75

TOC: 47.05

BOC-1: 46.75

BOC-2: 45.55 Since 2:5%

- TOC: 47.81

- BOC: 47.38 -----S

TOC: 47.75

BOC-1: 47.23

BOC-2: 47.76

- TOC: 47.75

BOC: 47.25

TOC: 45.60

BOC: 45.50

- - + $\frac{+}{46.56}$

1% SLQPE TOC 47.30

BOC: 47.05

TOC: 46.42

BOC; 46.42

46.57

TOW: ±45.0

BOW: ±44.0/

BOC: 44.30

CAREFULLY GRADE

DAMAGING ROOTS


TOP OF

-¶ BOULDERS -

-0-0-0-0-0-

AROUND TREES

TO AVOID

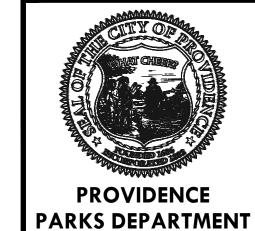



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Site Improvements at Miguel Luna Park

110 Sackett St Providence, RI

REVISIONS: Date Issued For:

HIGH POINT: 47.05

F&I 6" DRAIN W/ ATRIUM GRATE

F&I 6" DRAIN W/ ATRIUM GRATE

TOC: 47.45

BOC: 46.95

RIM: 46.75

INV IN: 45.77

A2 F&I 6" SCH 40 PVC

A1 F&I 20" CATCH BASIN CB RIM: 46.50

INV IN: 45.30

INV OUT: 45. 28

(A1) CONNECT TO EXISTING L-7 DRAINLINE W/ 6" SCH

40 PVC DRAIN PIPE

L-7 DRAIN PIPE

47.38

47.62 CURB STOP

--- BENCHMARK

BATH-

ROOM

OFFICE

UTILITY


47.43


INV OUT: 45.77

INV OUT: 45.67

L-7 RIM: 46.75

/2\ 4/8/2025 Addendum #2

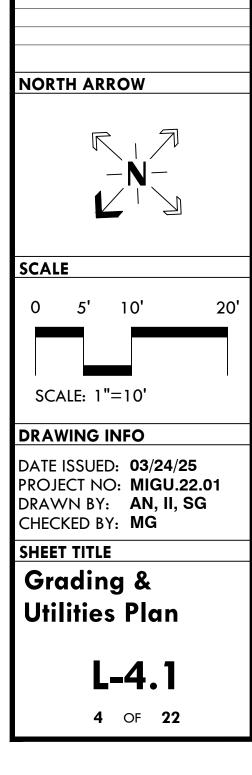

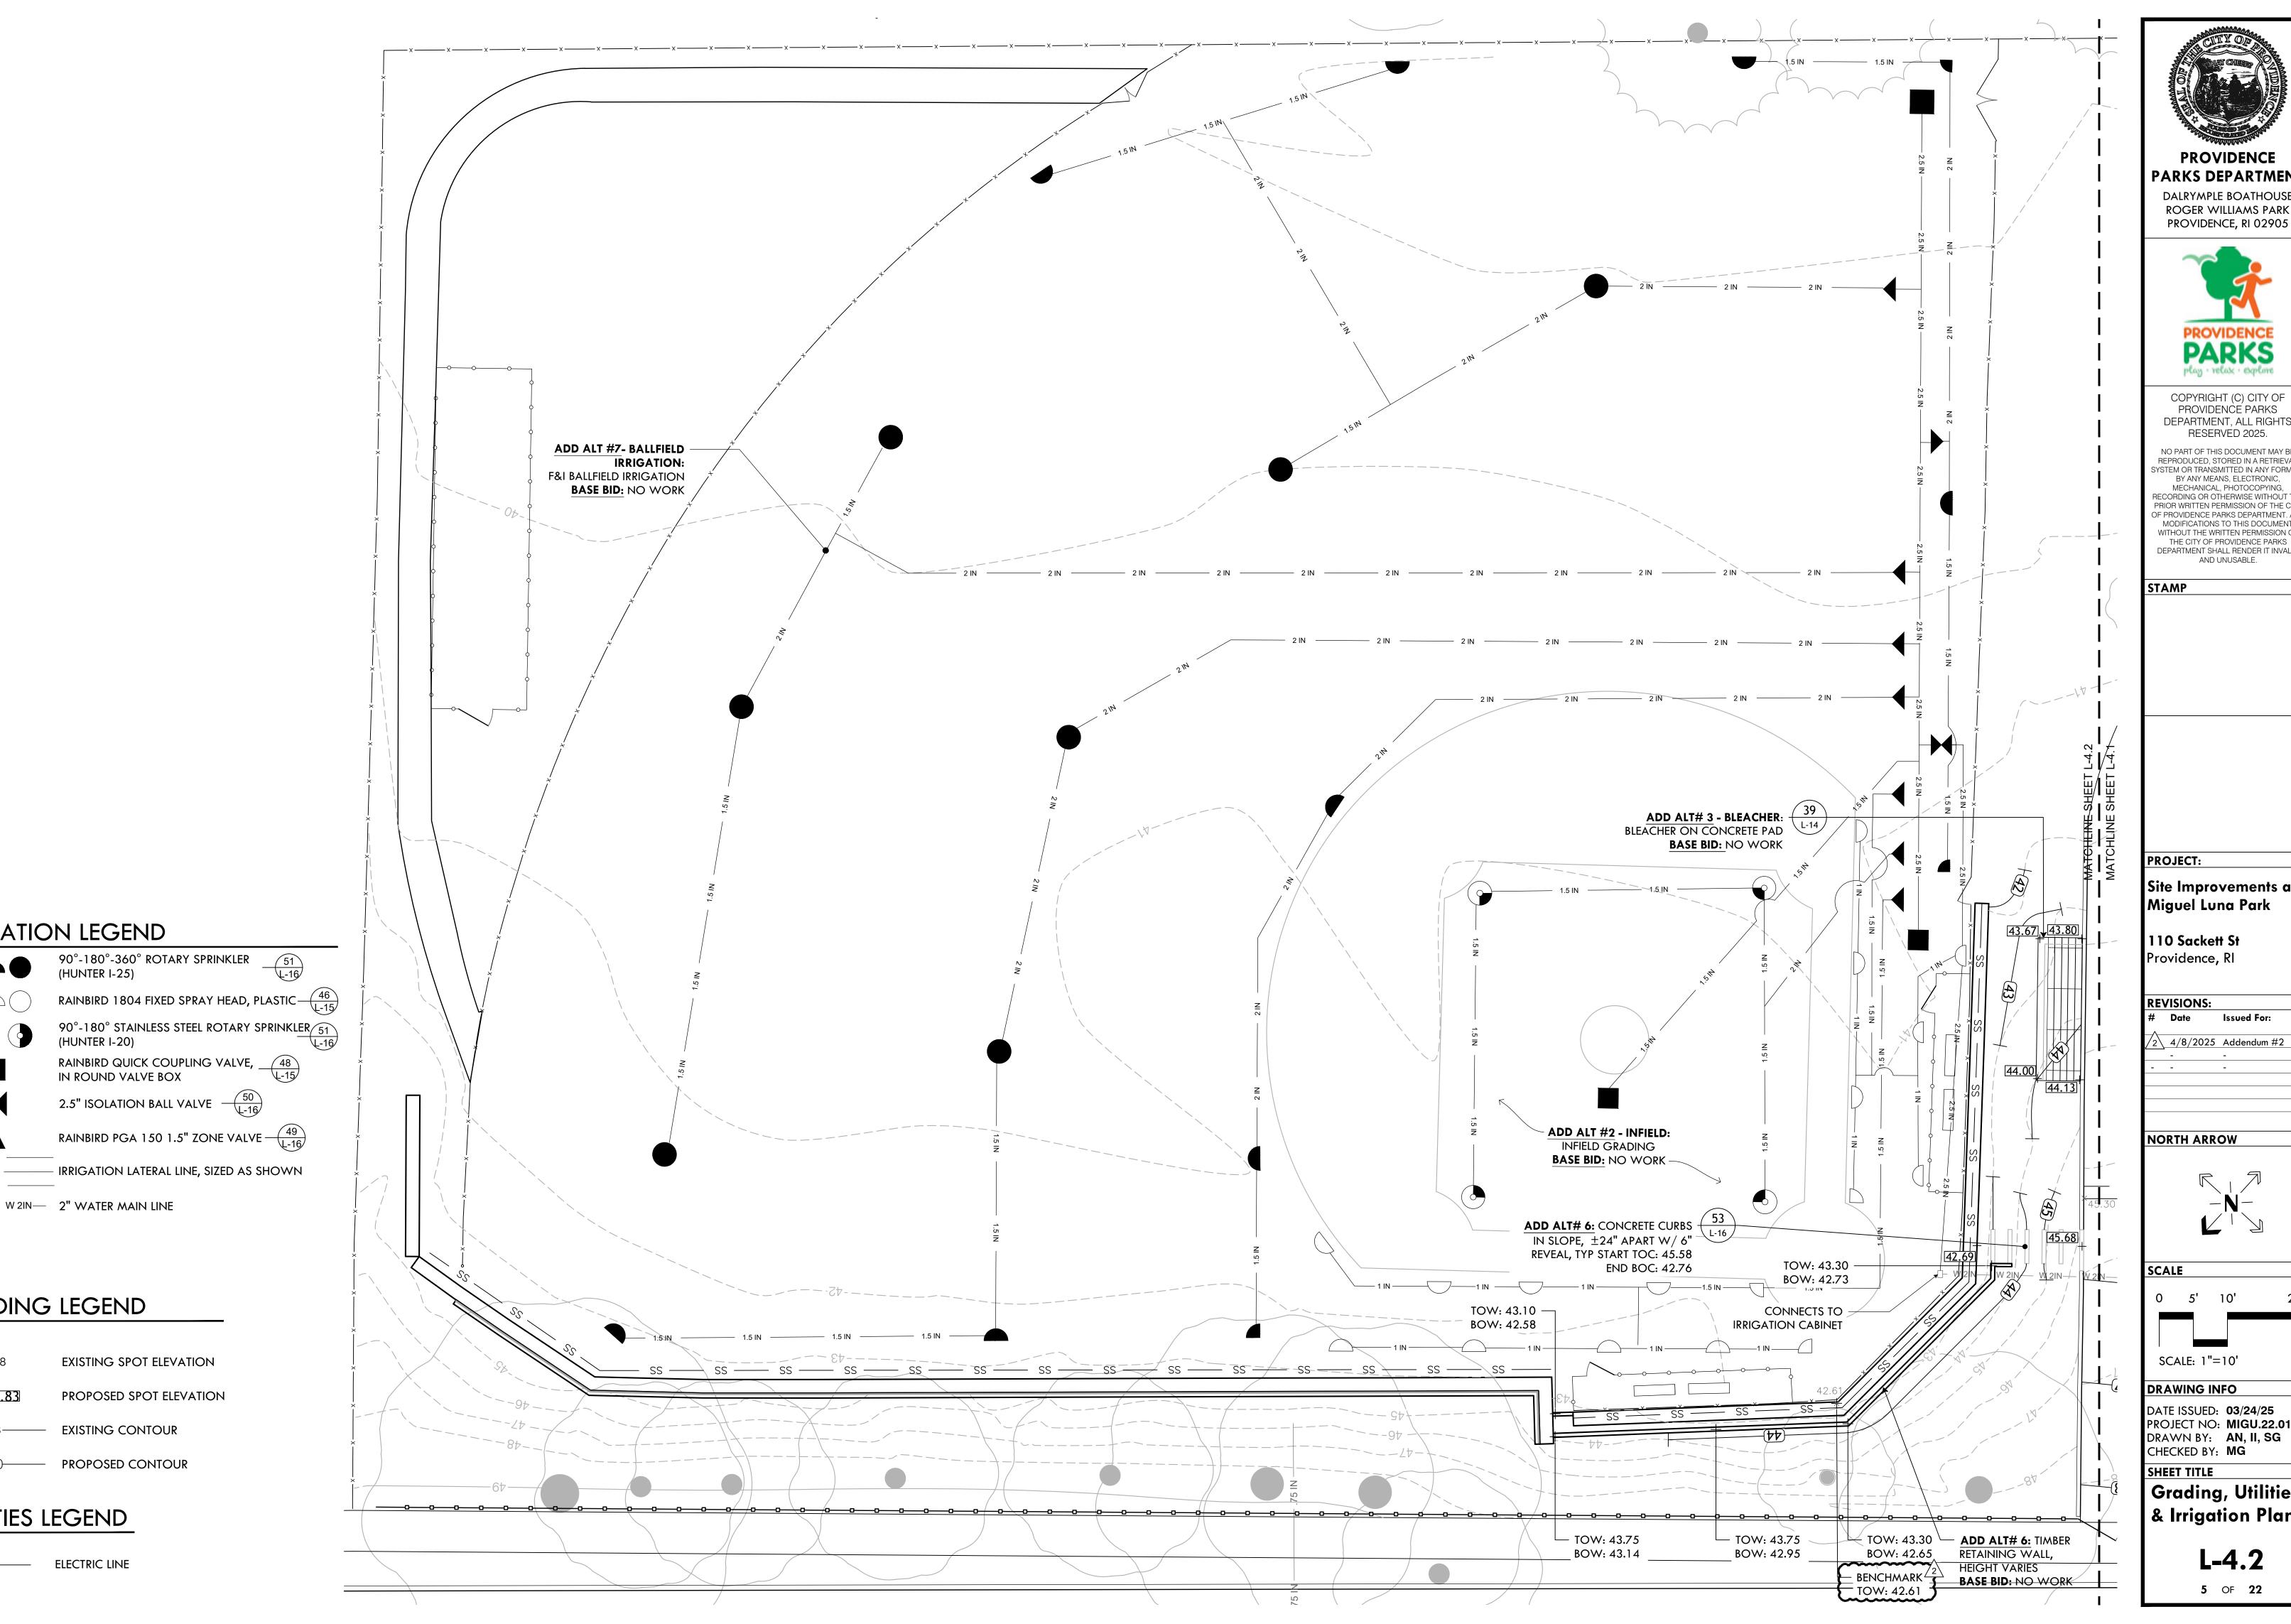

IRRIGATION LEGEND

- W 2IN- W 2IN- 2" WATER MAIN LINE

GRADING LEGEND

UTILITIES LEGEND

ELECTRIC LINE

---- 2.5 IN -----

+97.83

(HUNTER I-20)

90°-180°-360° ROTARY SPRINKLER (HUNTER I-25)

2.5" ISOLATION BALL VALVE (50)

EXISTING SPOT ELEVATION

PROPOSED SPOT ELEVATION

EXISTING CONTOUR

PROPOSED CONTOUR

PROVIDENCE PARKS DEPARTMENT DALRYMPLE BOATHOUSE

ROGER WILLIAMS PARK



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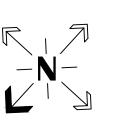
Site Improvements at Miguel Luna Park

110 Sackett St Providence, RI

REVISIONS:

Issued For: 2\ 4/8/2025 Addendum #2

NORTH ARROW



SCALE


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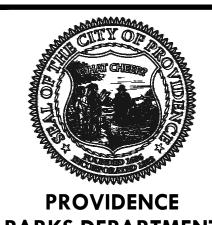
DRAWING INFO

DATE ISSUED: 03/24/25
PROJECT NO: MIGU.22.01
DRAWN BY: AN, II, SG CHECKED BY: MG

Grading, Utilities & Irrigation Plan

L-4.2



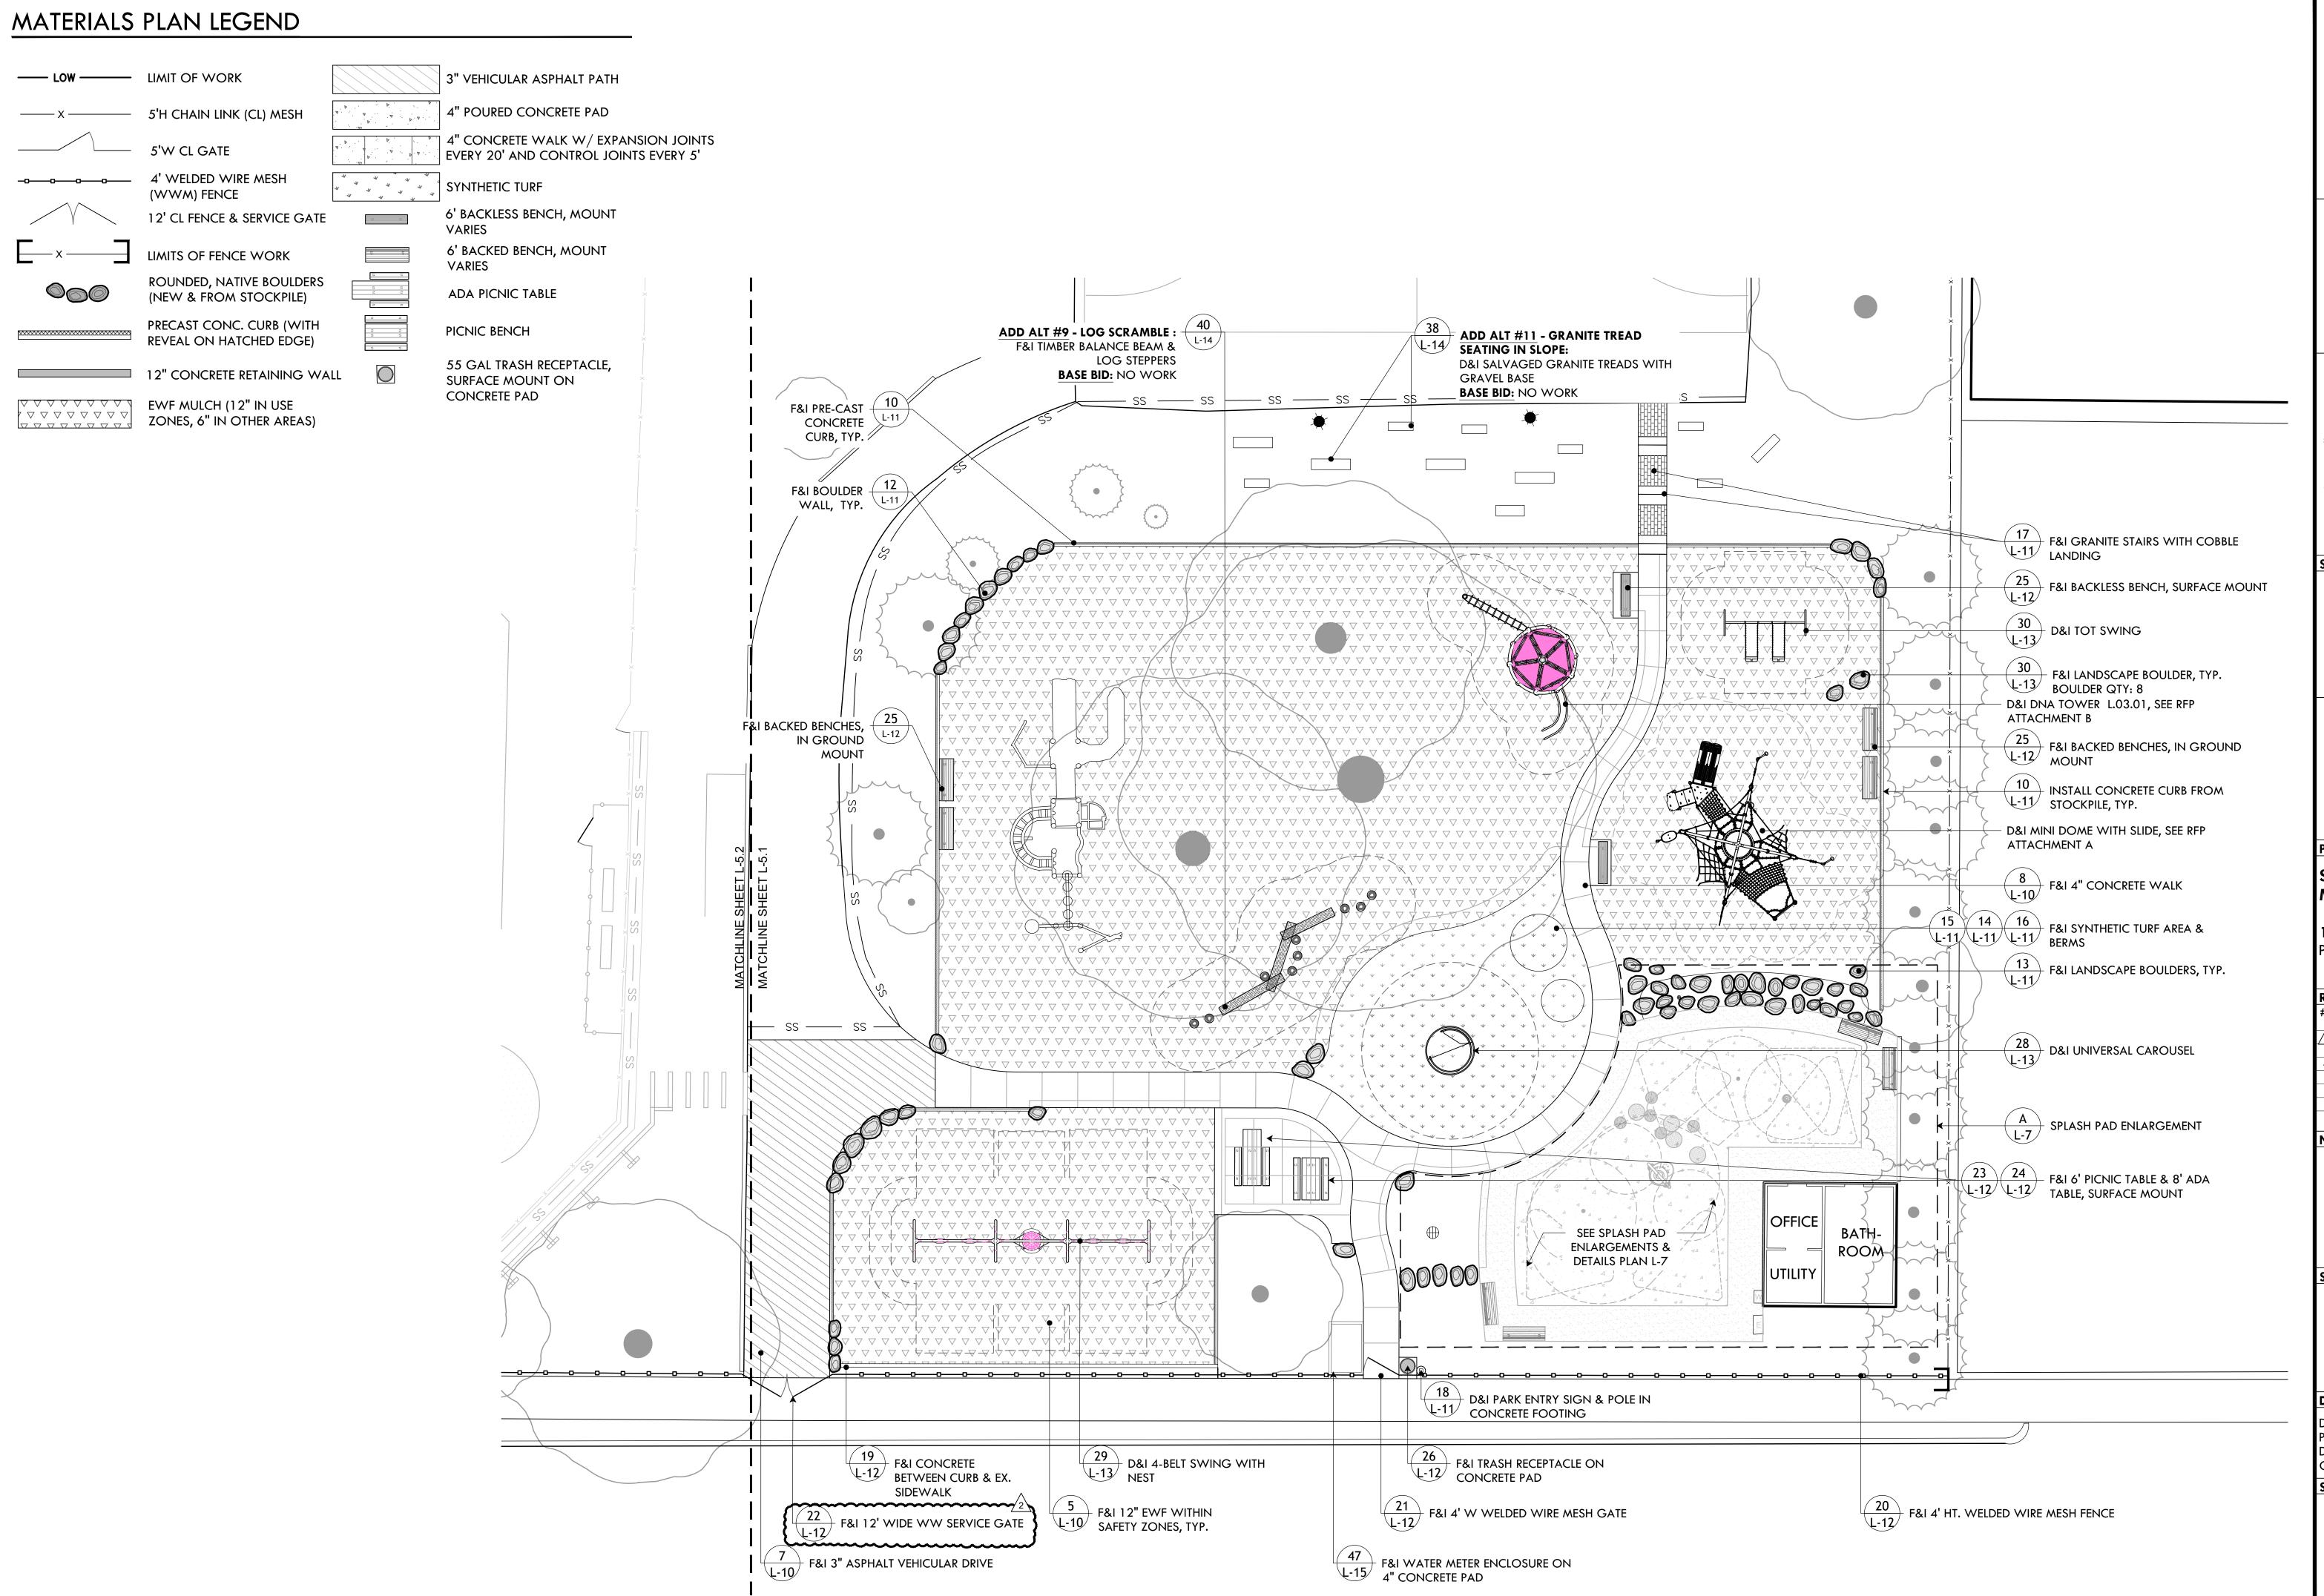

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PROVIDENCE, RI 02905



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PROJECT:


Site Improvements at Miguel Luna Park

110 Sackett St Providence, RI


REVISIONS: Date Issued For:

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SCALE

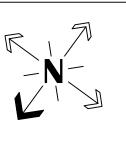


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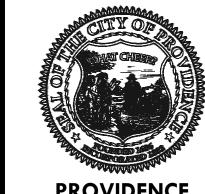
DATE ISSUED: **03/24/25** PROJECT NO: MIGU.22.01 DRAWN BY: AN, II, SG CHECKED BY: MG

SHEET TITLE

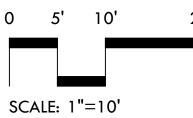Materials Plan

L-5.1



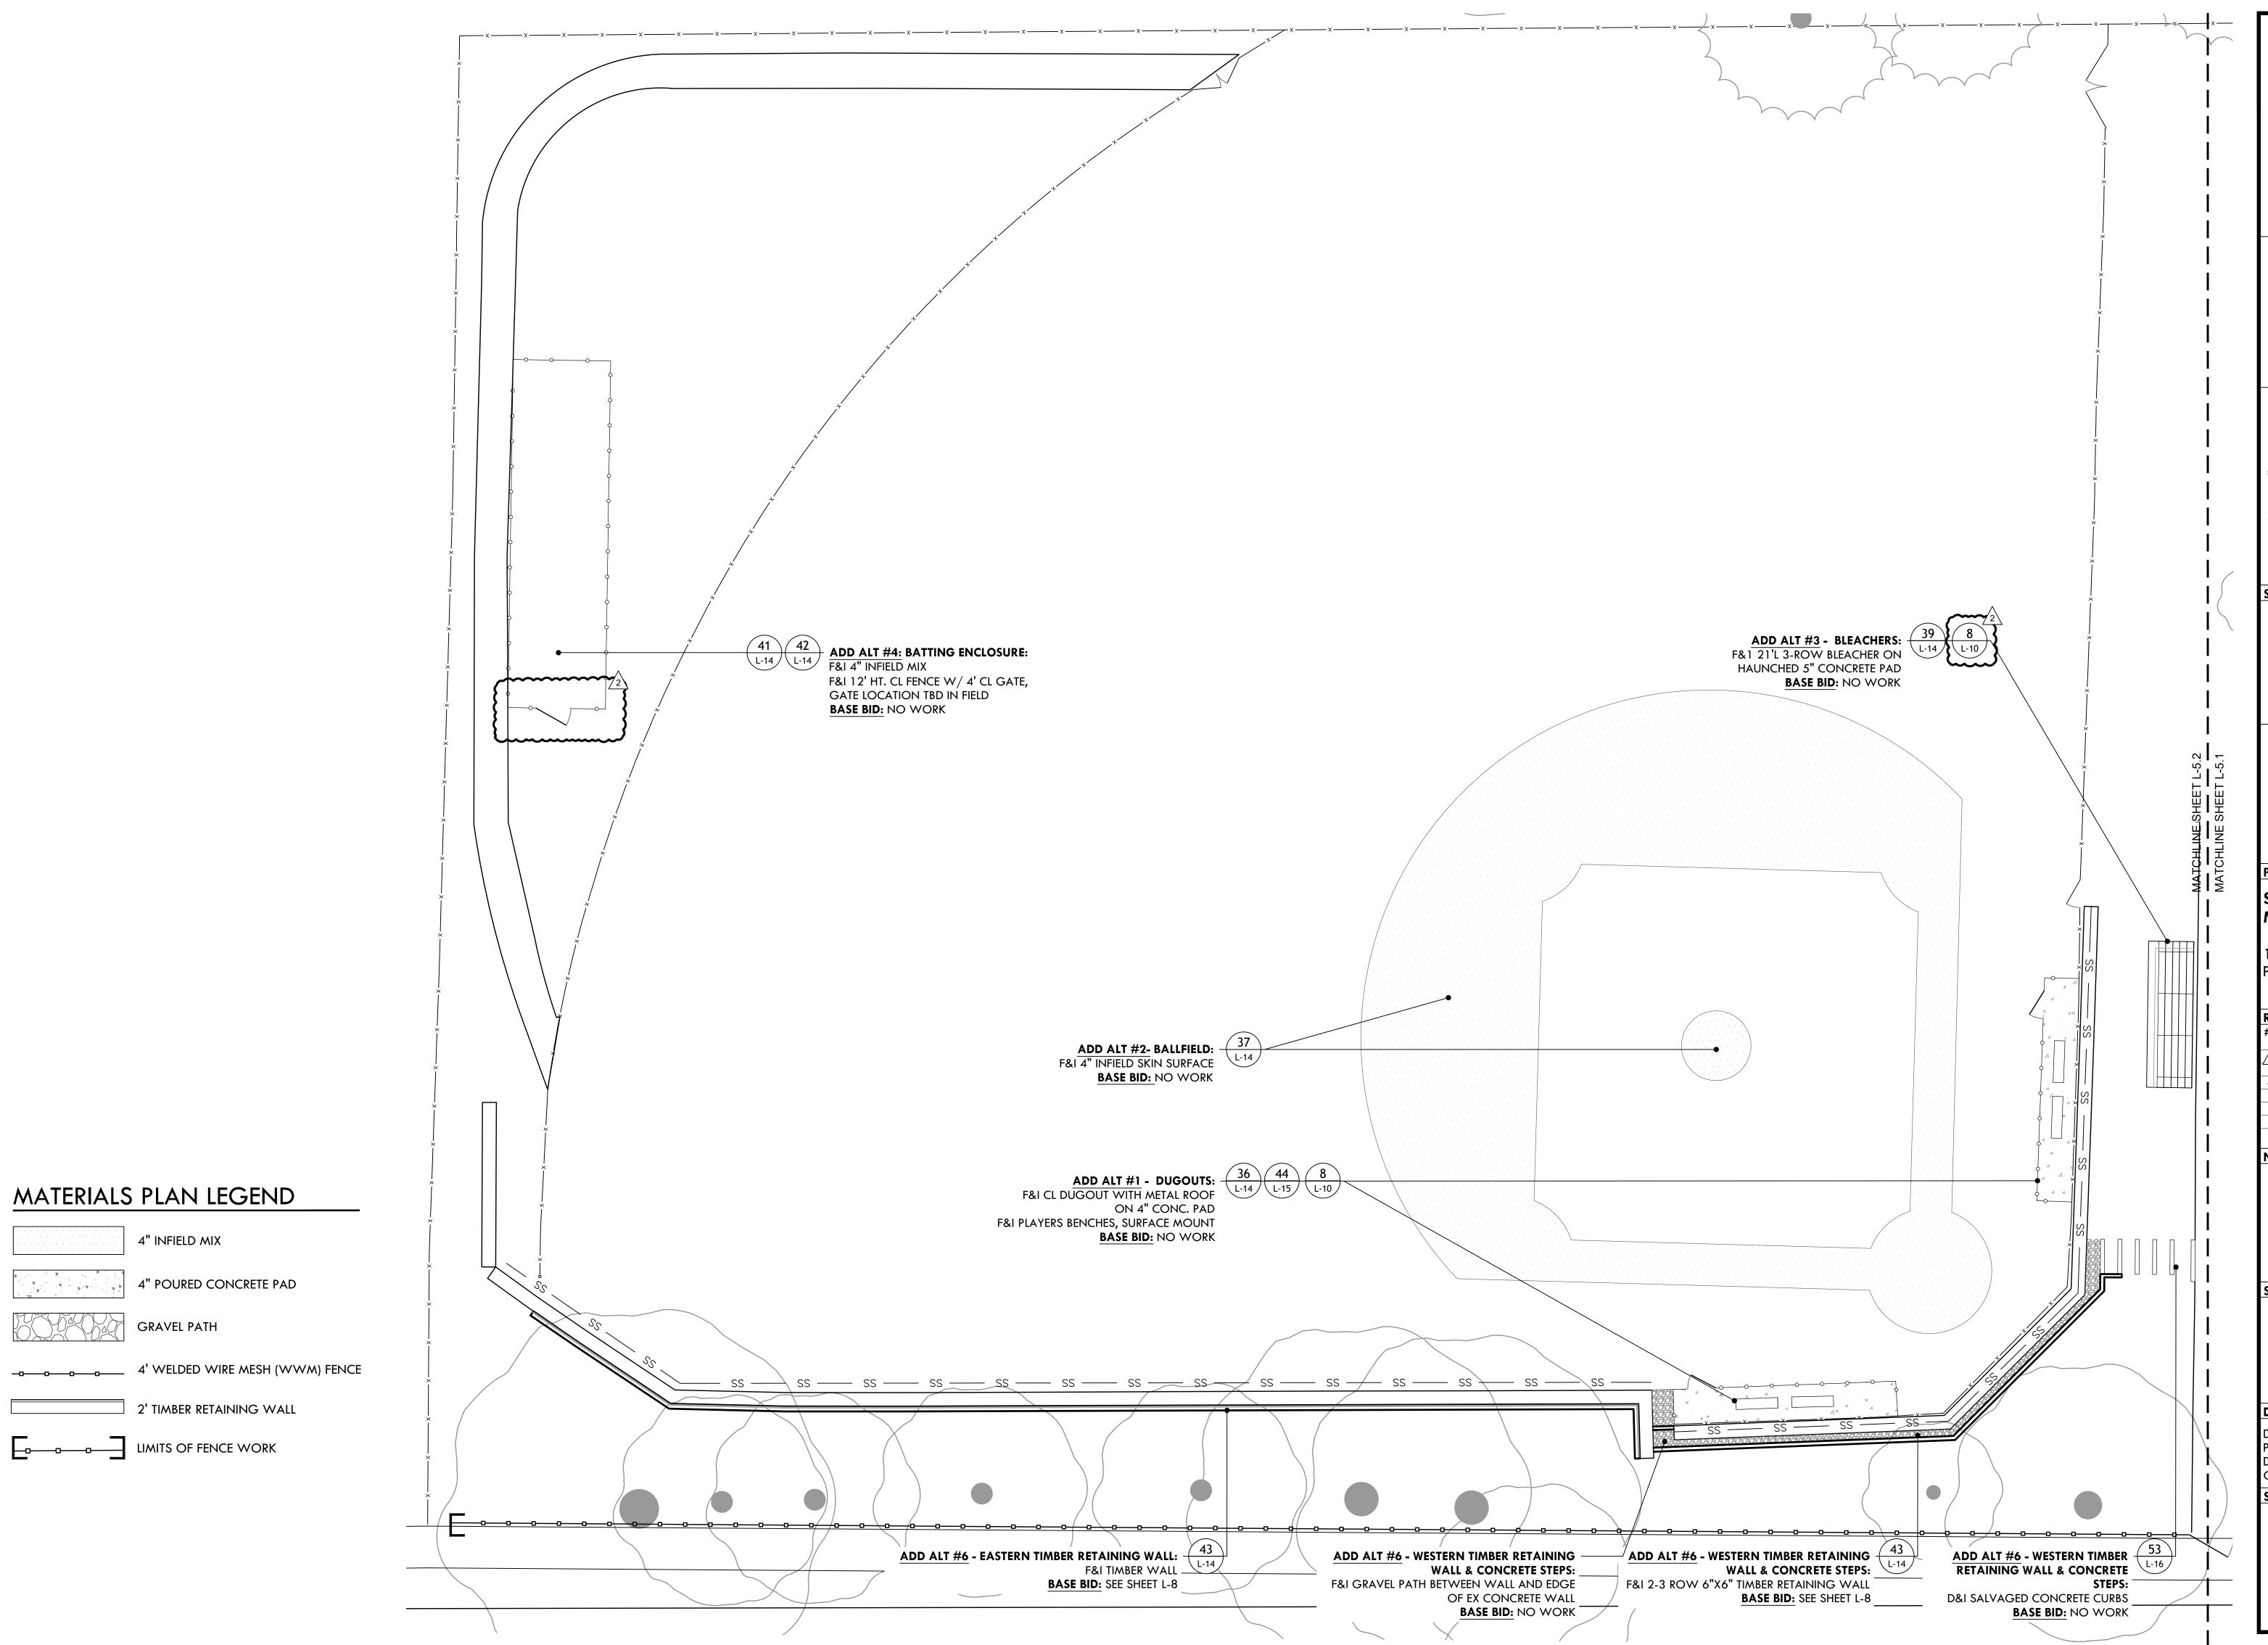

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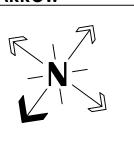
Site Improvements at Miguel Luna Park

110 Sackett St Providence, RI


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SCALE




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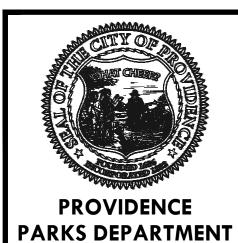
DATE ISSUED: 03/24/25
PROJECT NO: MIGU.22.01
DRAWN BY: AN, II, SG CHECKED BY: MG

SHEET TITLE **Materials Plan**

L-5.2

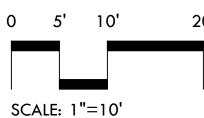

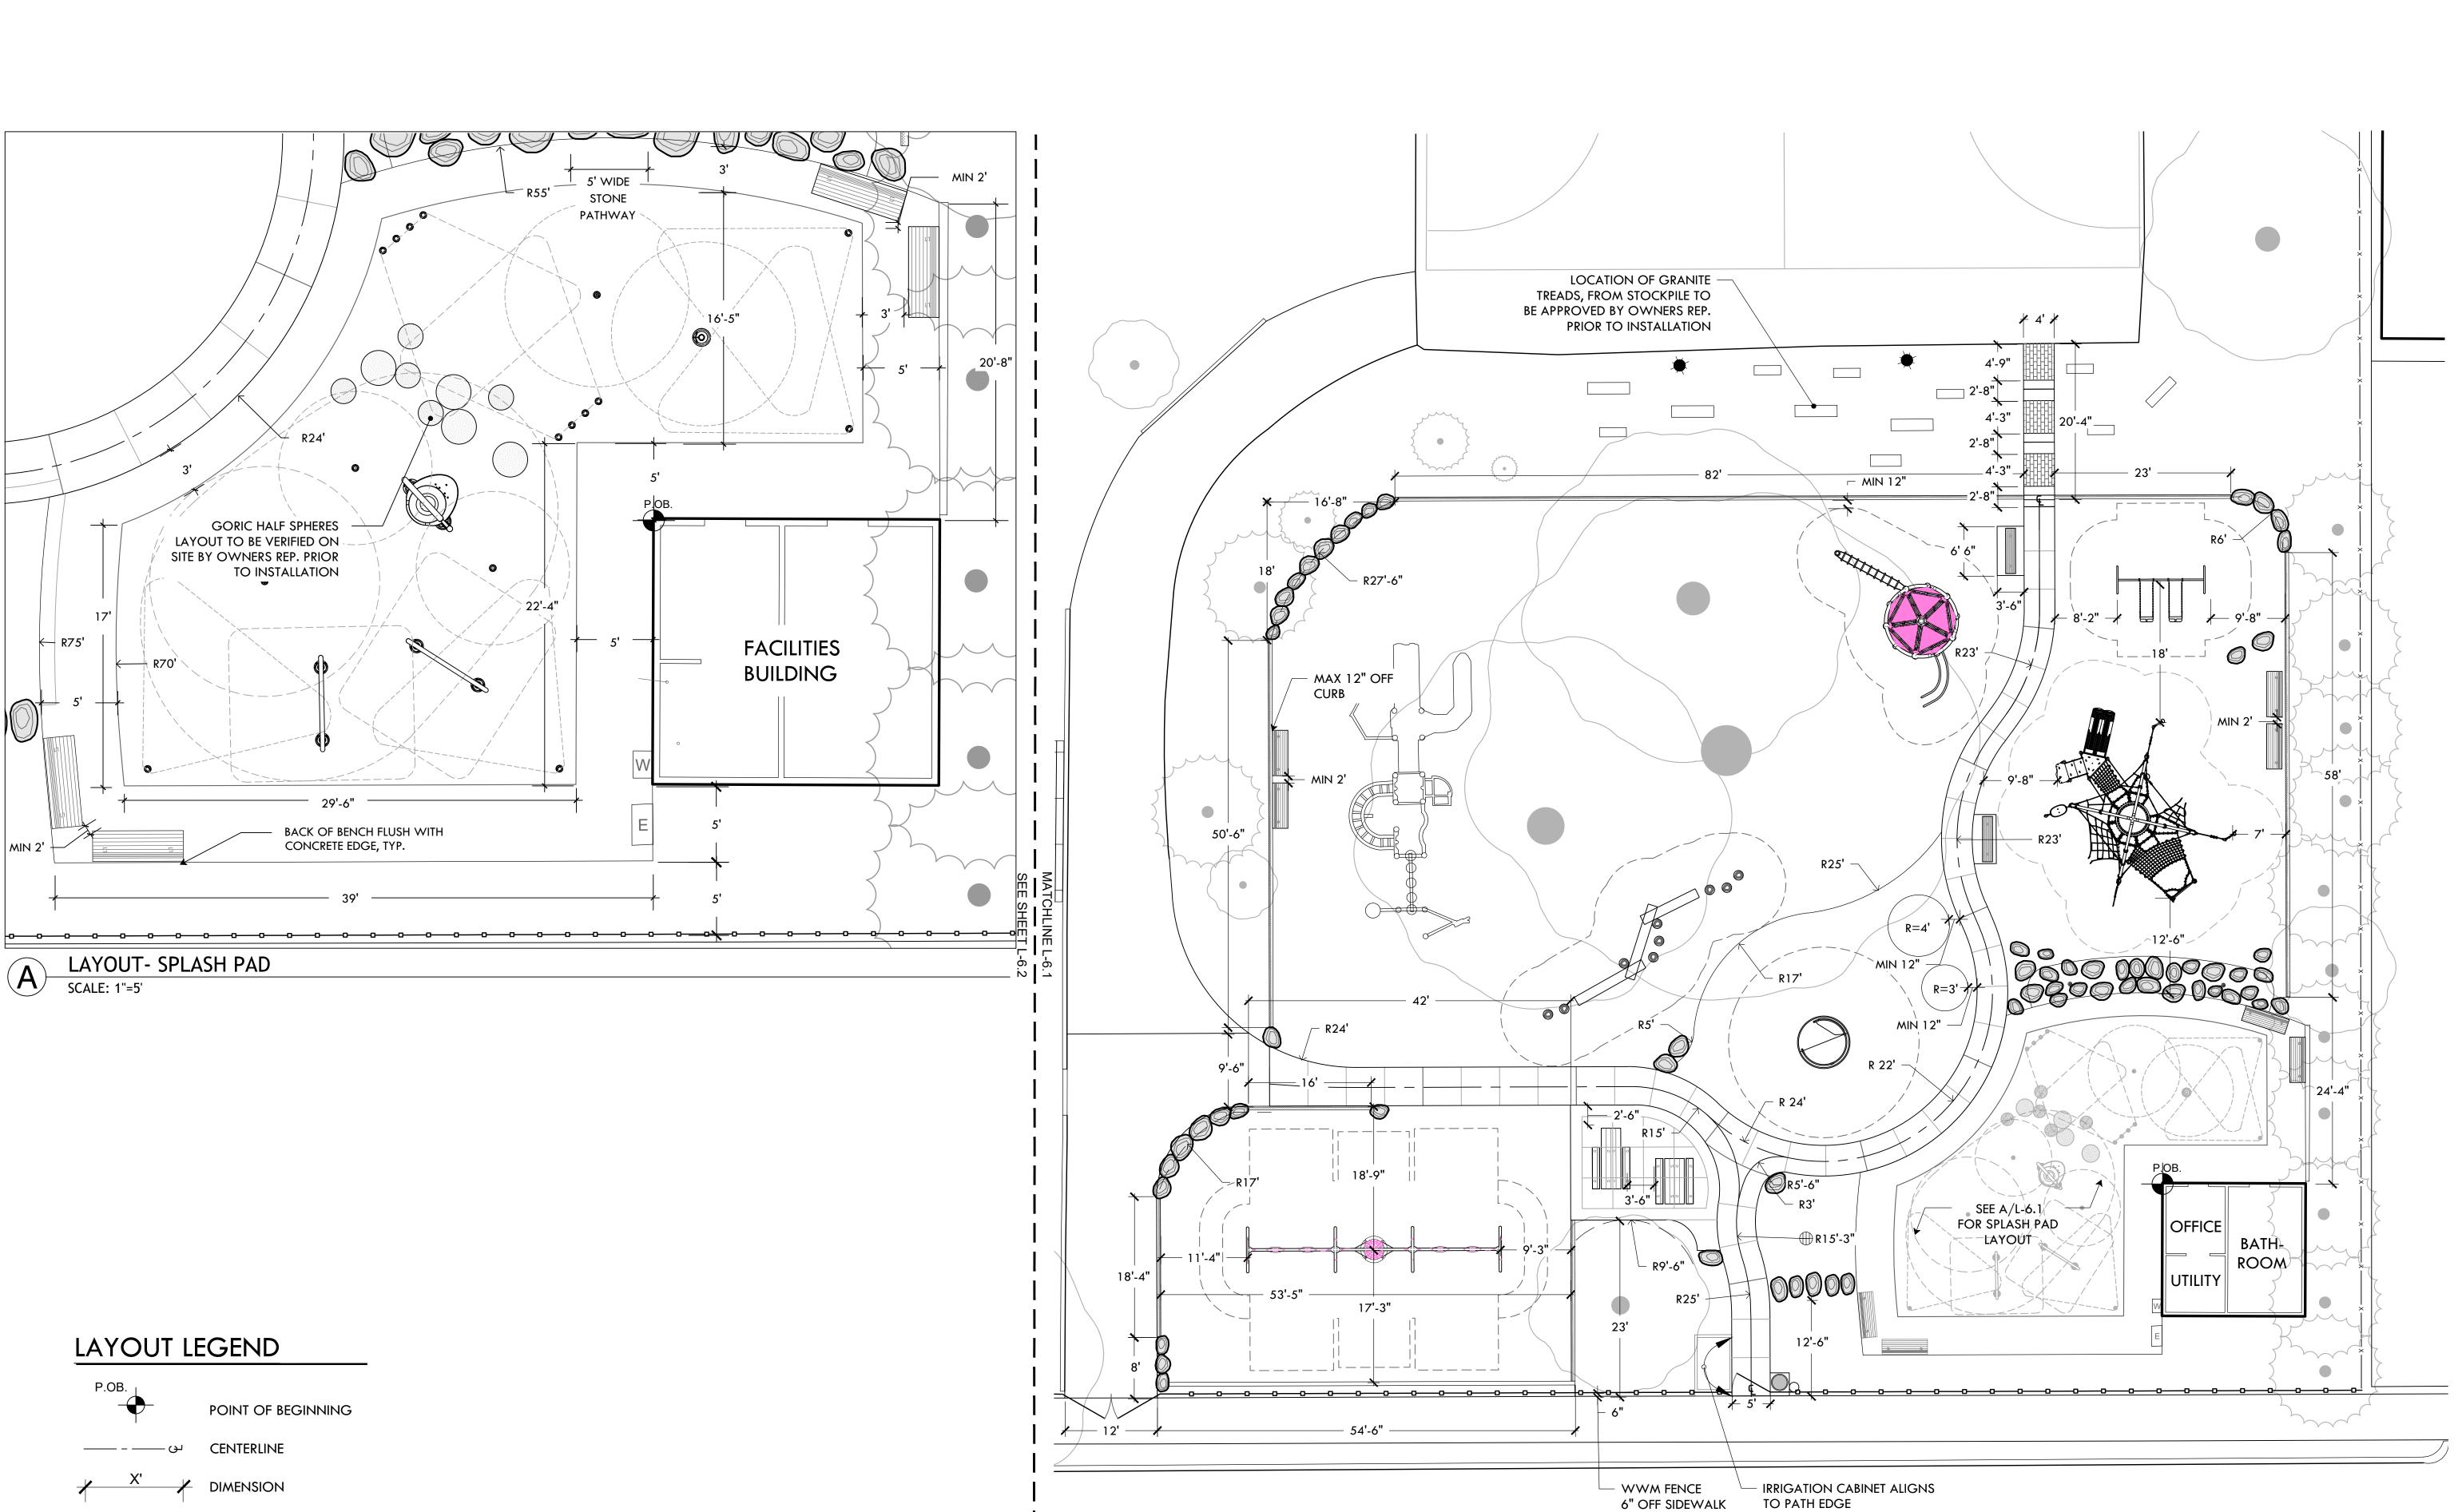ALIGN EDGES OR FACES



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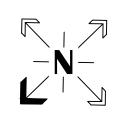
Site Improvements at Miguel Luna Park

110 Sackett St Providence, RI


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Date Issued For:
2 4/8/2025 Addendum #2

NORTH ARROW



SCALE

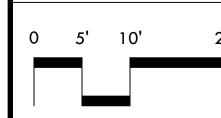

SCALE: 1"=10'


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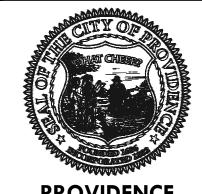
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DATE ISSUED: 03/24/25
PROJECT NO: MIGU.22.01
DRAWN BY: AN, II, SG

Layout Plan

L-6.1



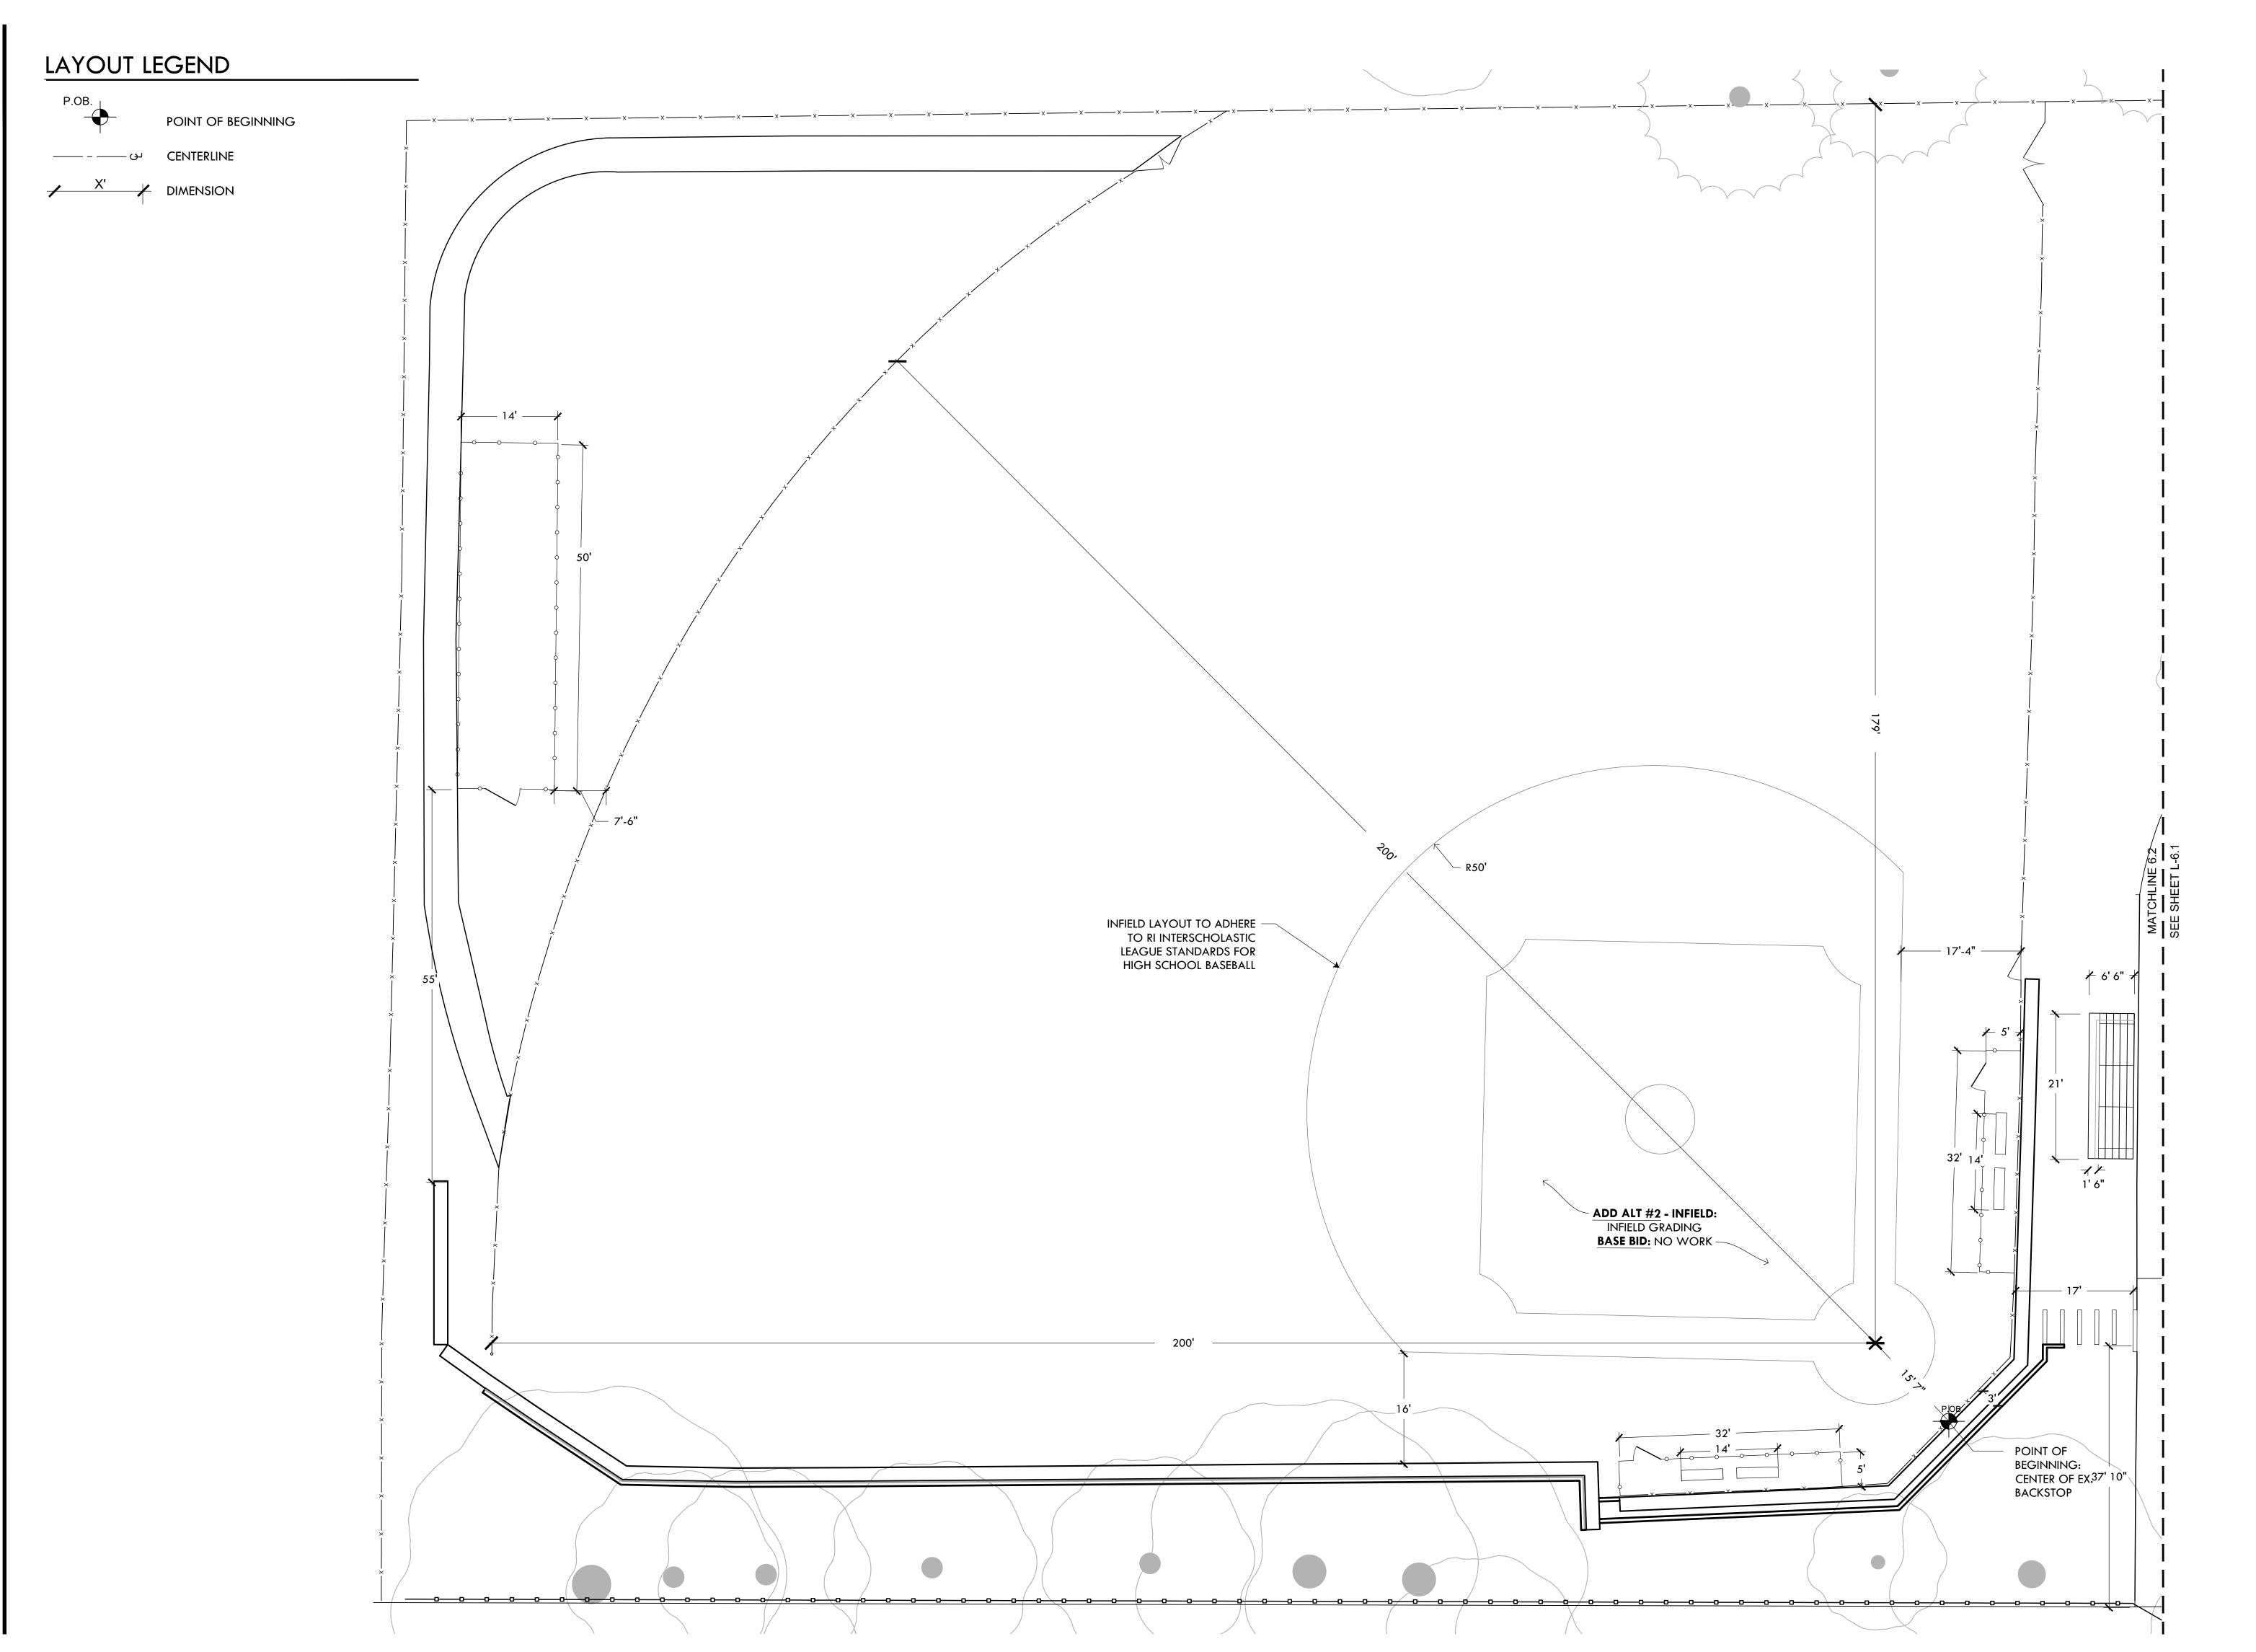

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DALRYMPLE BOATHOUSE

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PROJECT:

Site Improvements at Miguel Luna Park


110 Sackett St Providence, Rl

REVISIONS:


Date Issued For:

4/8/2025 Addendum #2 - -

NORTH ARROW

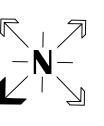

SCALE

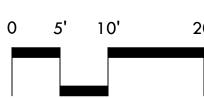

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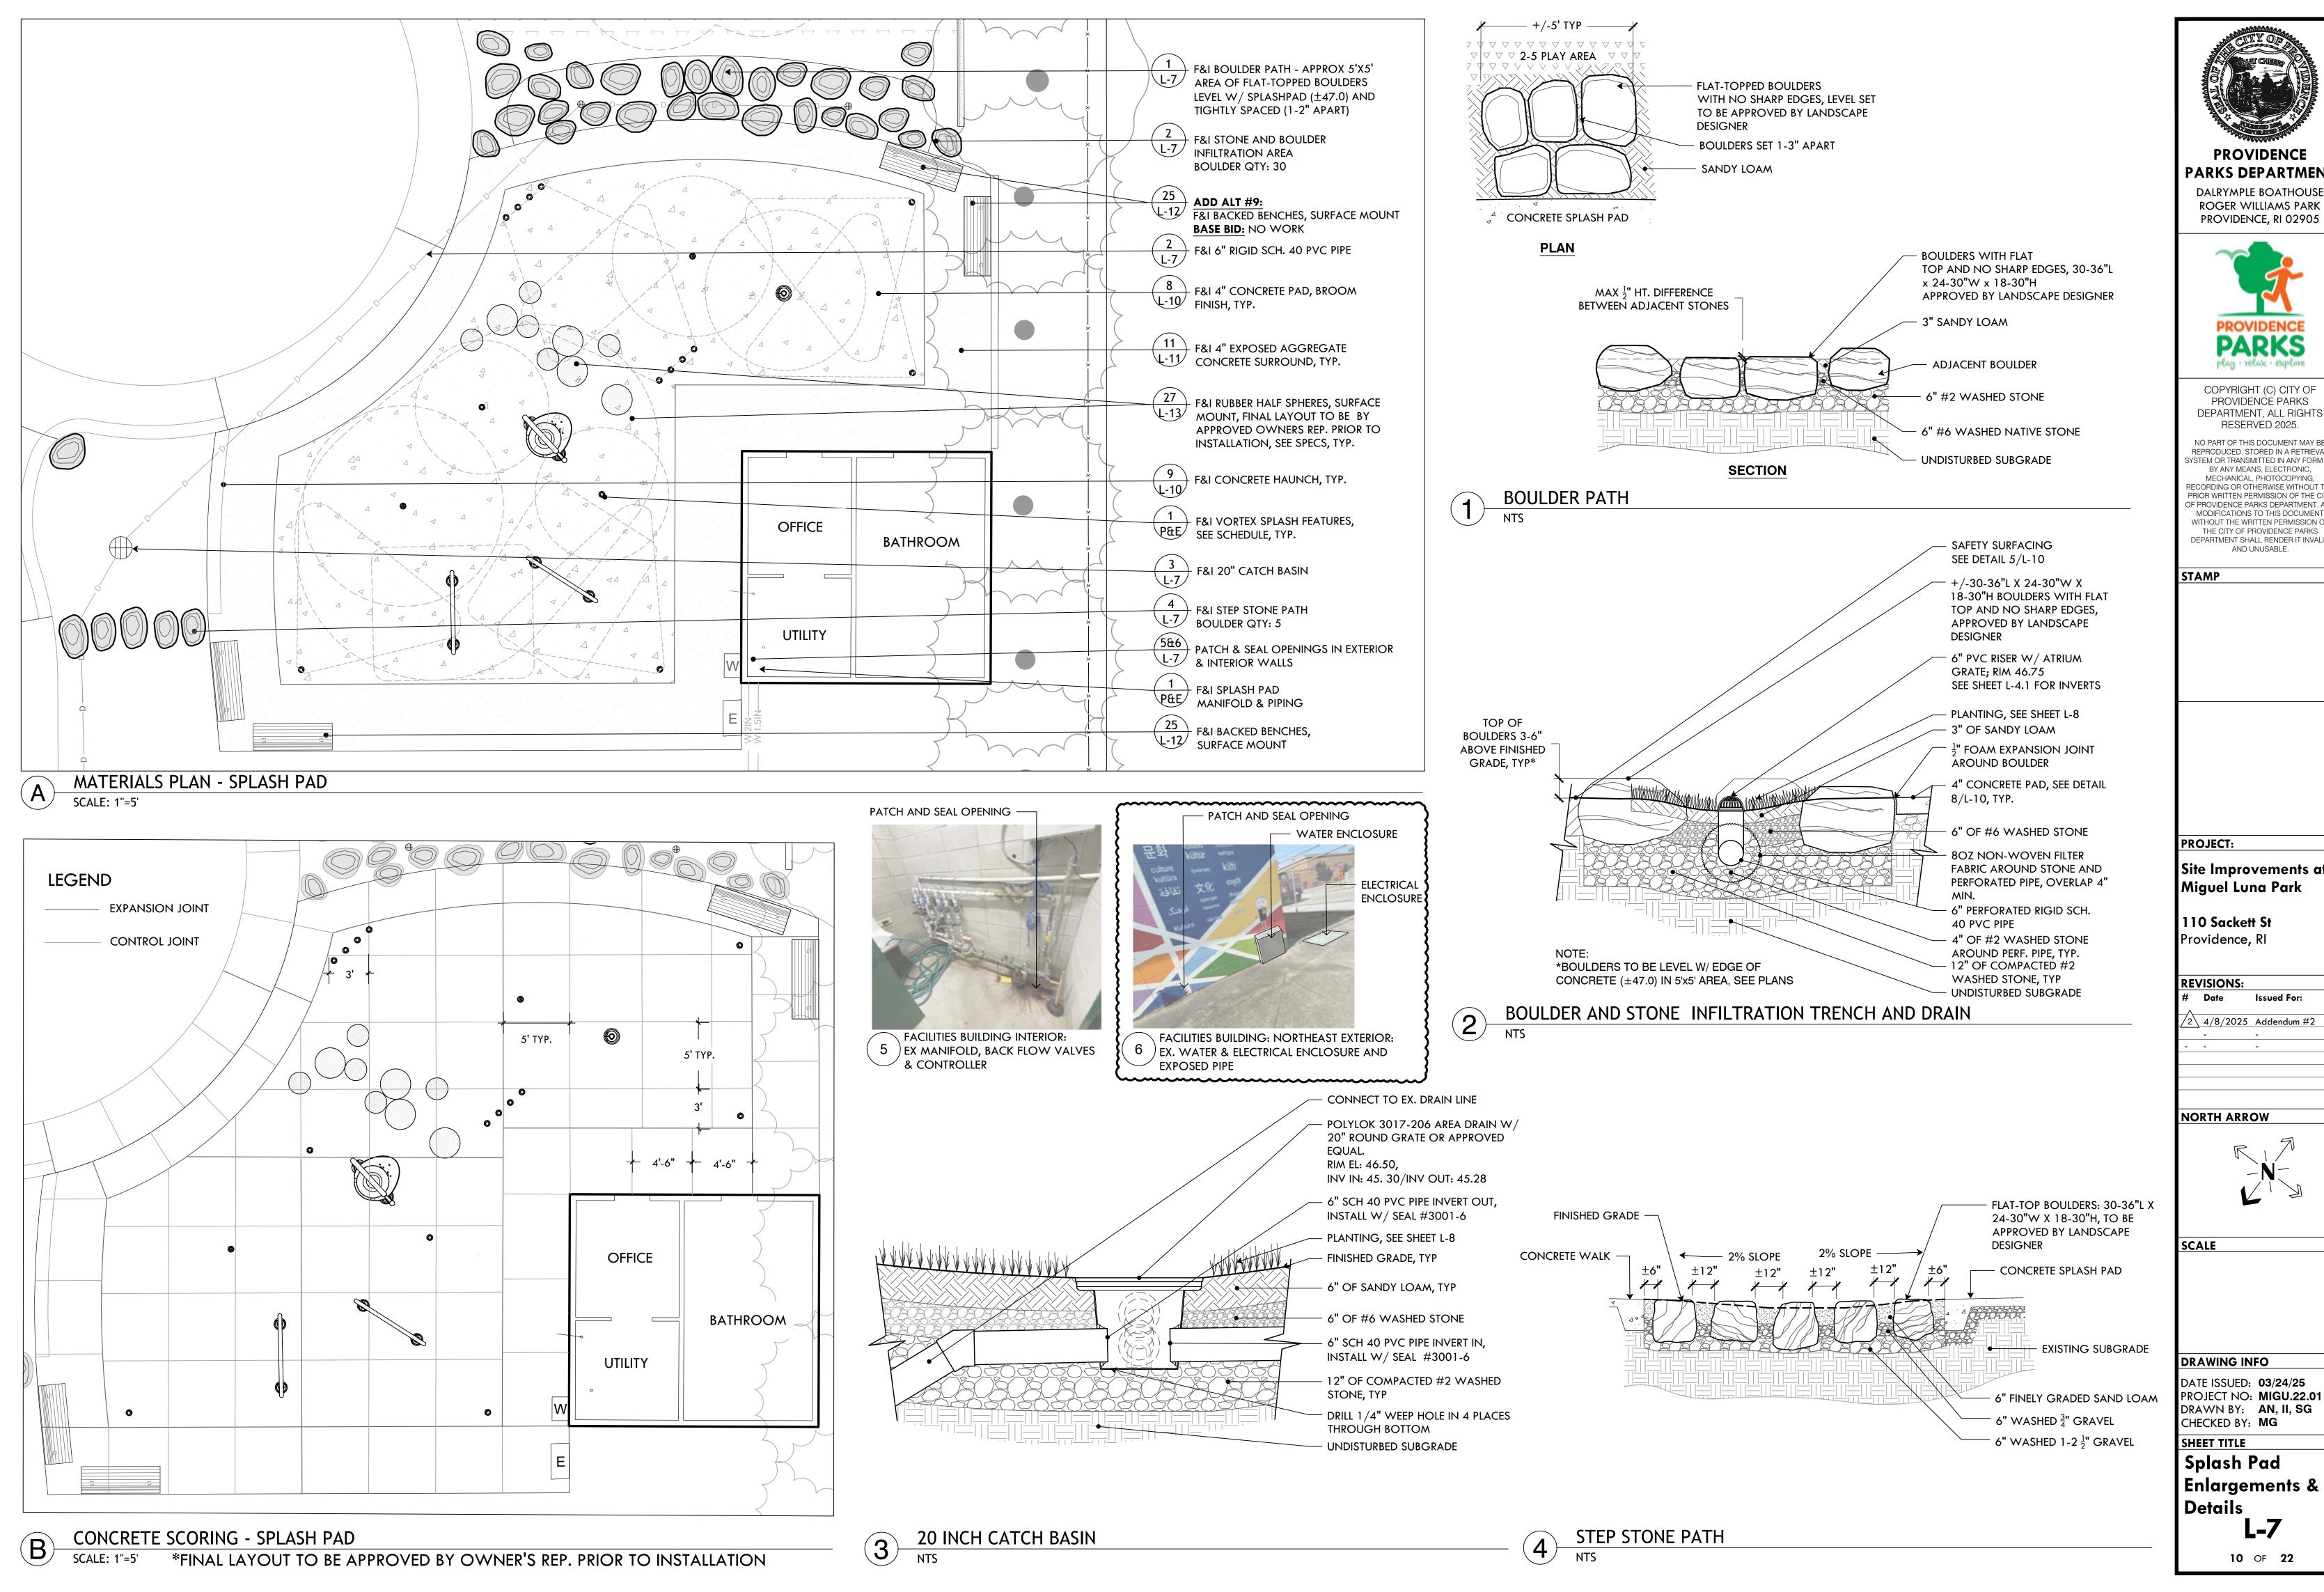
DRAWING INFO

DATE ISSUED: 03/24/25
PROJECT NO: MIGU.22.01
DRAWN BY: AN, II, SG
CHECKED BY: MG

SHEET TITLE

Layout Plan

L-6.2



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PROVIDENCE, RI 02905 PROVIDENCE

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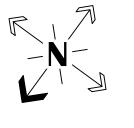
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NORTH ARROW



DATE ISSUED: **03/24/25**

PROJECT NO: MIGU.22.01 DRAWN BY: AN, II, SG CHECKED BY: MG

Splash Pad Enlargements &

		PLANT SCHEDULE		
KEY	QTY	BOTANICAL NAME COMMON NAME	SIZE	NOTES
		TREES		
CK	1	Cornus kousa ASIAN DOGWOOD	2.5-3" cal.	-
СС	1	Cercis canadensis 'Forest Pansy' EASTERN REDBUD	2.5-3" cal.	-
		SHRUBS & VINES		
CA	5	Clethra alnifolia 'Ruby Spice' SUMMERSWEET CLETHRA	# ₃ CONT.	48" O.C.
IG	13	llex glabra 'Nigra' NIGRA INKBERRY	# ₃ CONT.	48" O.C.
CR	1	Calycanthus raulstonii 'Hartlage Wine' CALIFORNIA ALLSPICE	#5 CONT.	
		PERENNIALS, GROUNDCOVERS,	& GRASSES	
СР	500	Carex pennsylvanica PENNSYLVANIA SEDGE	4"	10" O.C.

L-13 LOAM & HYDROSEED DISTURBED AREAS

L-13 LOAM & HYDROSEED DISTURBED AREAS

SS SS

*HQ 1 *HS

*IG 4 *CA 1 *HS 1 OOO *IG 3

*CA /*HS 1

*HS / 1 *HQ /

ADD ALT #2 - BALLFIELD: LOAM &
HYDROSEED DISTURBED AREAS
BASEBID: NO WORK

ADD ALT #2 - BALLFIELD:

F&I SOD INFIELD EDGE

BASE BID: NO WORK

F&I 4' SOD STRIP AT INFIELD EDGE


BASE BID: NO WORK


F&I LOAM & HYDROSEED
WITH MEADOW MIX; F&I
EROSION CONTROL
BLANKET

ADD ALT #4- BATTING GAGE:

LOAM & HYDROSEED
DISTURBED AREAS
BASEBID: NO WORK

		ADD ALT #12 - PLANT SC	HEDULE	
KEY	QTY	BOTANICAL NAME COMMON NAME	SIZE	NOTES
		TREES		
*CK	2	Nyssa sylvatica 'Wildfire' WILDFIRE TUPELO	2.5-3" cal.	-
*CC	1	Cercis canadensis 'Forest Pansy' EASTERN REDBUD	2.5-3" cal.	-
		SHRUBS & VINES		
*CA	5	Clethra alnifolia 'Crystalina' COMPACT SUMMERSWEET	#3 CONT.	48" O.C.
*IG	13	llex glabra 'Nigra' NIGRA INKBERRY	# ₃ CONT.	48" O.C.
*HQ	4	Hydrangea quercifolia 'Pee Wee' PEE WEE OAKLEAF HYDRANGEA	# ₃ CONT.	6o" O.C.
*HS	8	Hydrangea serrata 'Tuff Stuff Ah-Ha' TUFF STUFF LACECAP HYDRANGEA	# ₃ CONT.	6o" O.C.

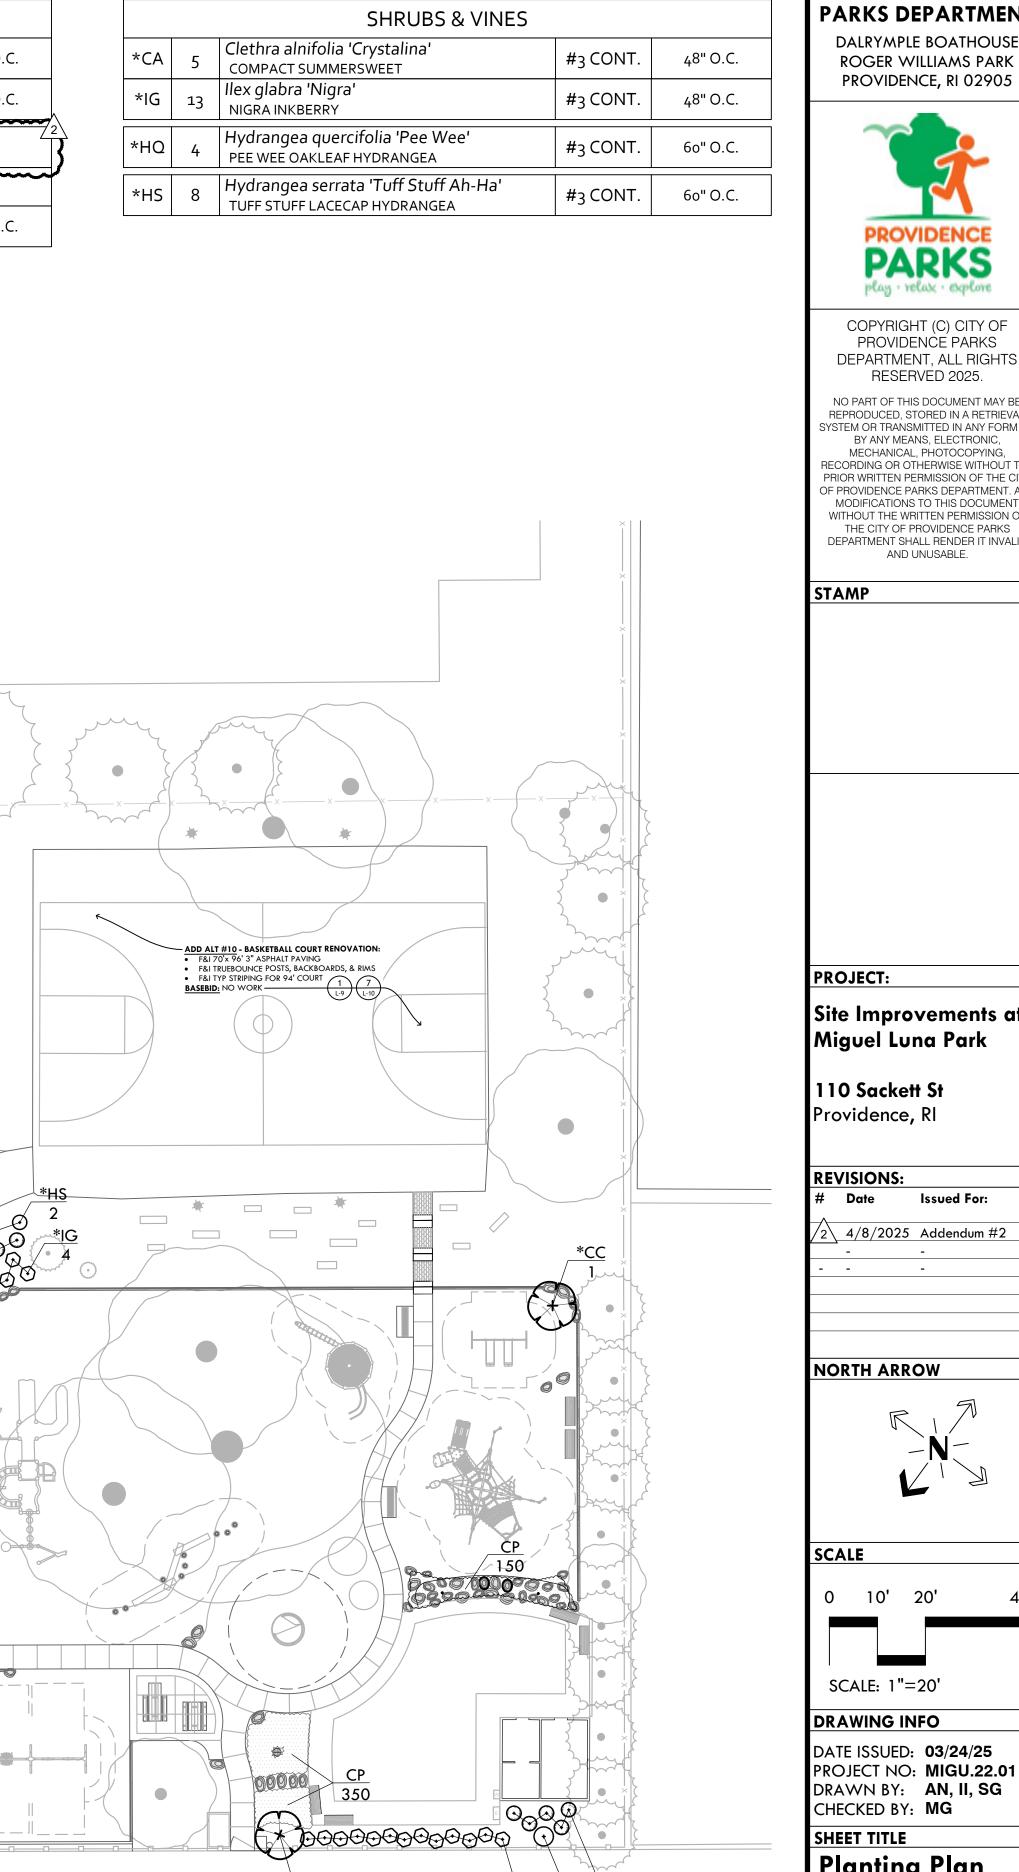

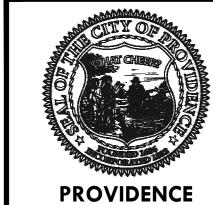

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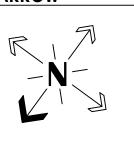
Site Improvements at Miguel Luna Park

110 Sackett St Providence, RI

REVISIONS: Issued For:


2 4/8/2025 Addendum #2

NORTH ARROW



| IG | CR | CA | 13 | 1 | 5

CC

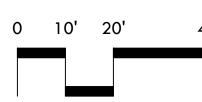



DRAWING INFO

DATE ISSUED: 03/24/25
PROJECT NO: MIGU.22.01
DRAWN BY: AN, II, SG
CHECKED BY: MG

Planting Plan

L-8

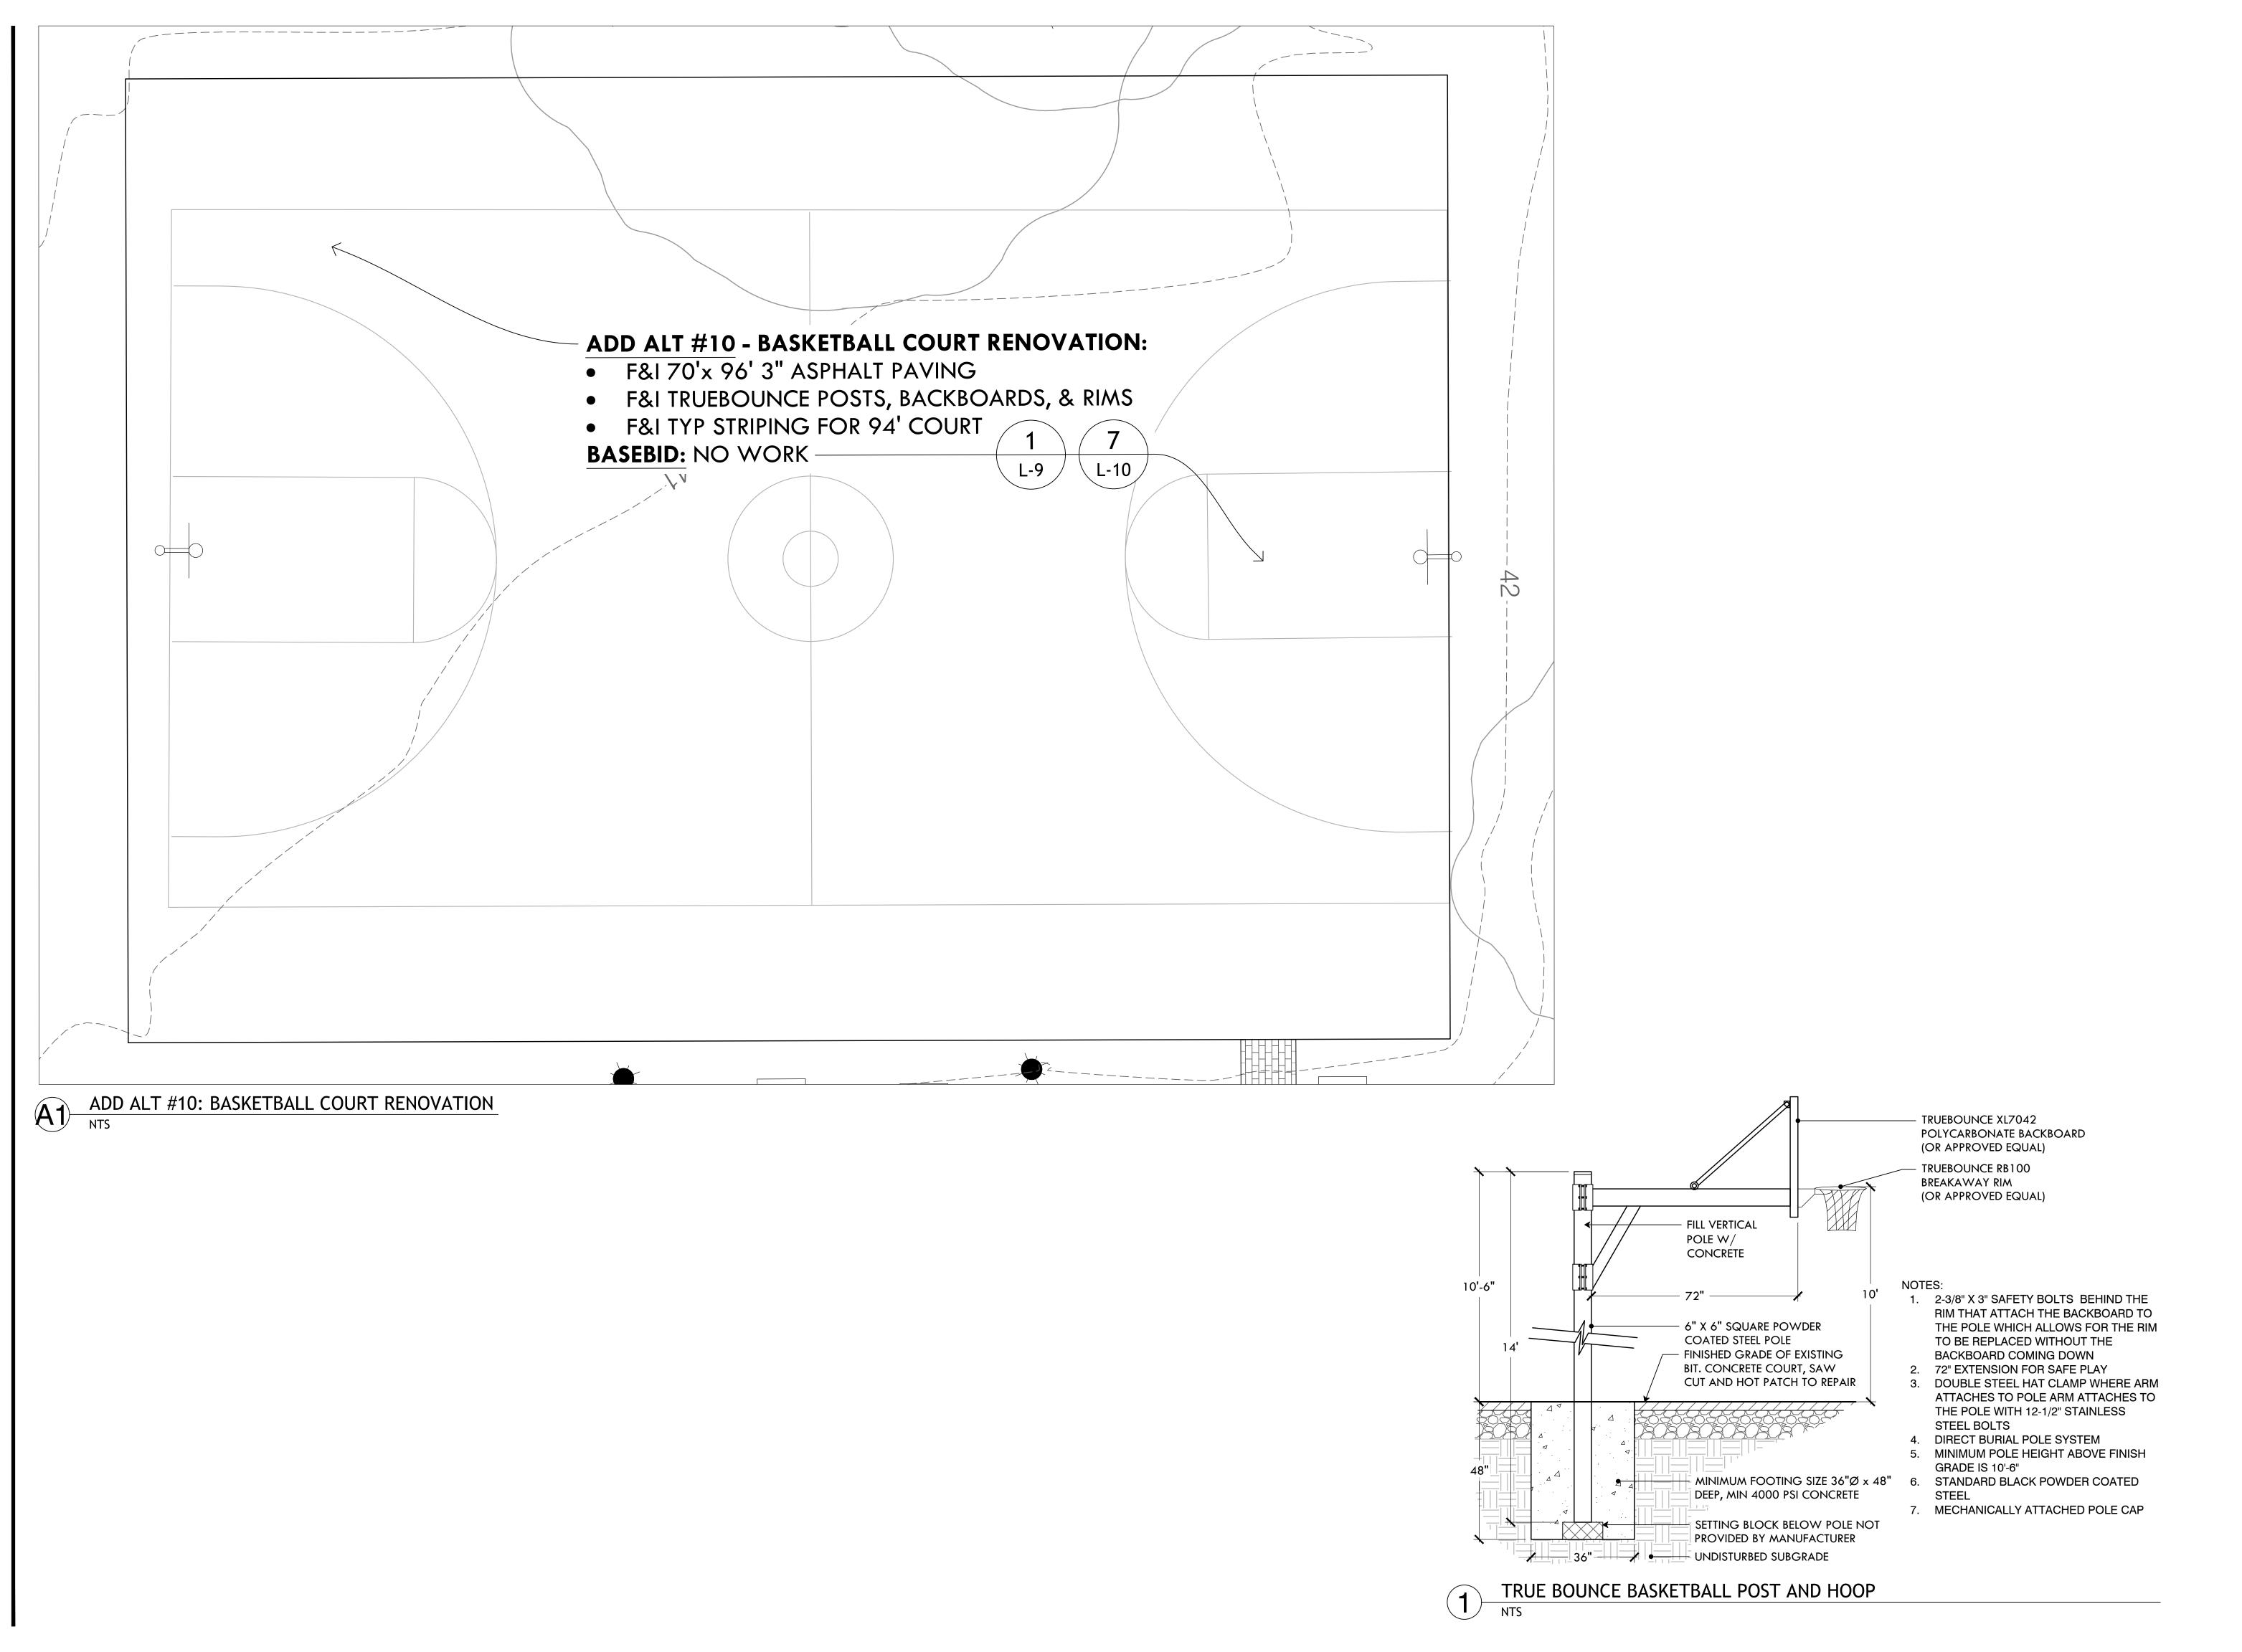

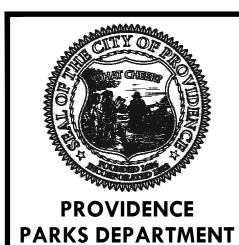

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PROJECT:

Site Improvements at Miguel Luna Park


110 Sackett St Providence, RI

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NORTH ARROW



SCALE

5' 10'

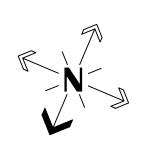
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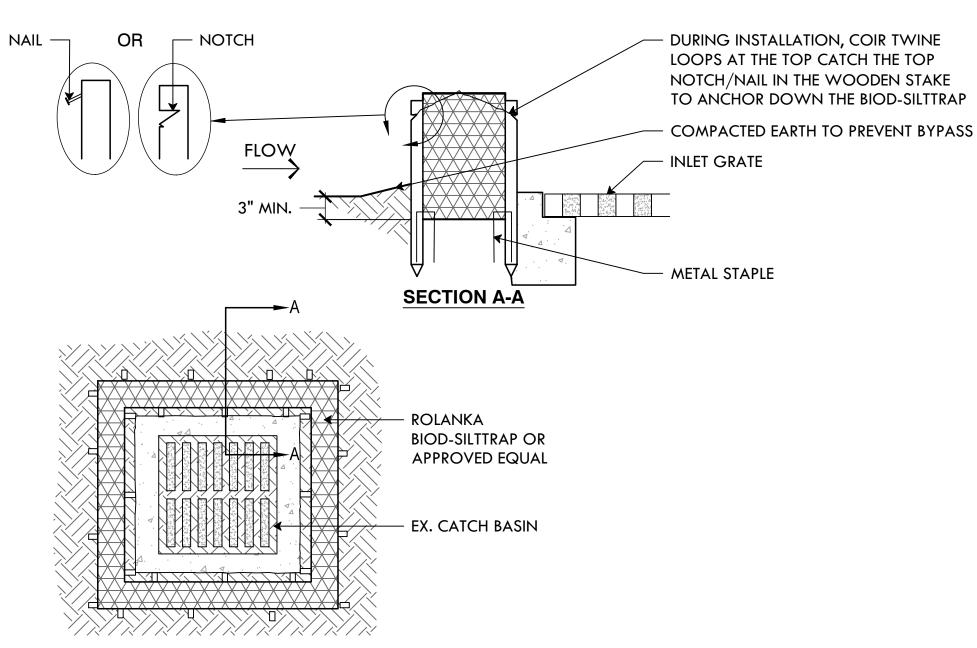
DATE ISSUED: 03/24/25
PROJECT NO: MIGU.22.01
DRAWN BY: AN, II, SG
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Basketball Court
Renovation Plan


L-9




TREE PROTECTION COMBINED

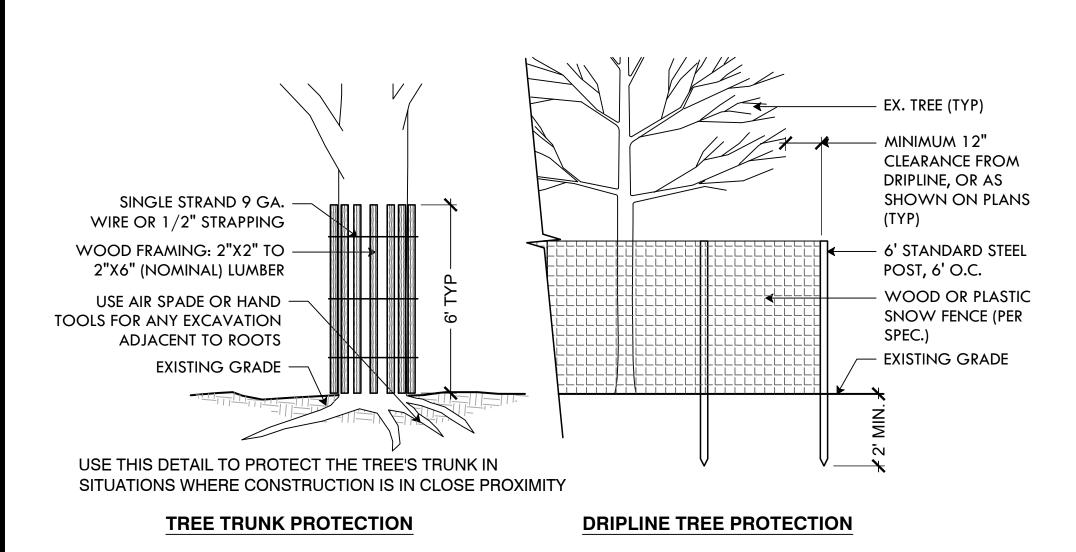

CATCH BASIN SILT SOCK

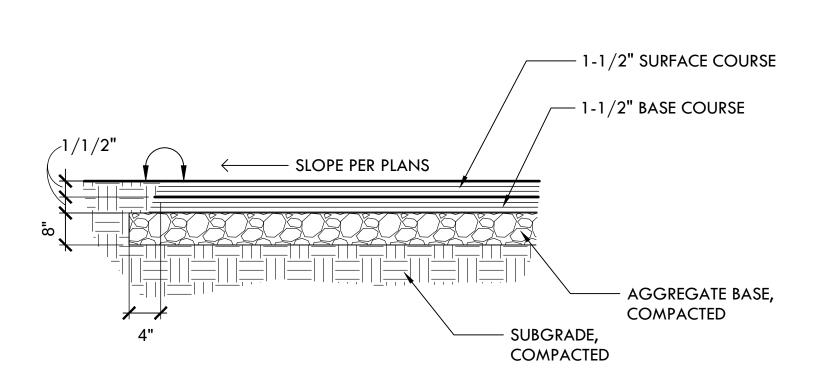

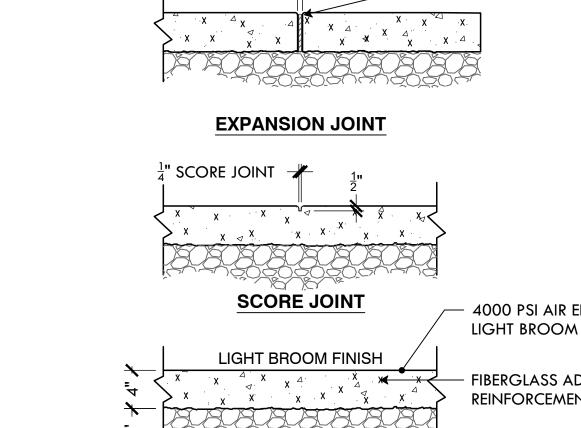


¹/₂" PREMOLDED


18" MIN OVERLAP 2"x2"x36" -HARDWOOD STAKE WATER FLOW 12" COMPOST-FILLED - 12" SILTSOXX SILTSOXX SILT SOCK AREA TO BE / WORK ✓ AREA ✓ PROTECTED WORK AREA TO BE / ✓ AREA ✓ PROTECTED - 2"x2"x36" HARDWOOD STAKE **PLAN VIEW SECTION VIEW**

- SILT SOCK SHALL BE SILTSOXX BY FILTREXX OR LANDSCAPE ARCHITECT APPROVED EQUAL.
- 2. FILL MATERIAL TO MEET MANUFACTURER'S SPECIFICATIONS.
- 3. FOLLOWING CONSTRUCTION AND SITE STABILIZATION, COMPOST MATERIAL SHALL BE DISPERSED ON SITE, IN LOCATION SELECTED BY THE LANDSCAPE ARCHITECT

EDGE OF USE ZONE 🖊 TRANS- 🧏 FINISHED GRADE ITION ENGINEERED WOOD FIBER MULCH, MUST COMPLY WITH ASTM STANDARDS: FI292 FOR IMPACT ABSORBPTION, F2075 FOR MATERIAL PURITY AND F1951 FOR WHEELCHAIR UNDISTURBED SUBGRADE

ENGINEERED WOOD FIBER (EWF) SAFETY SURFACING **(5**)

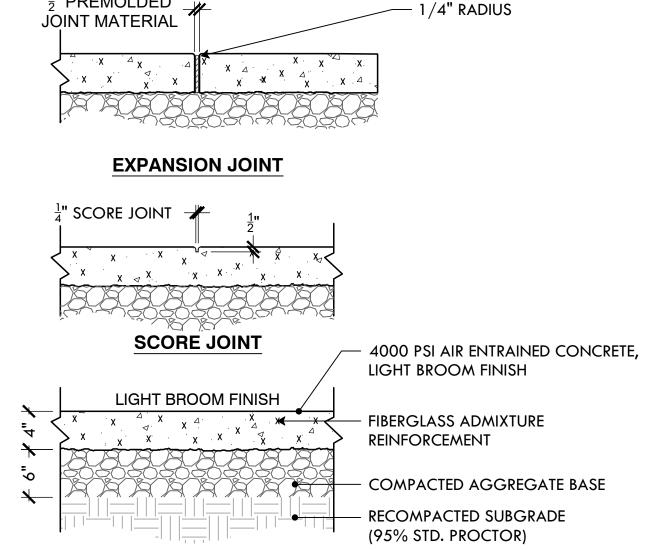

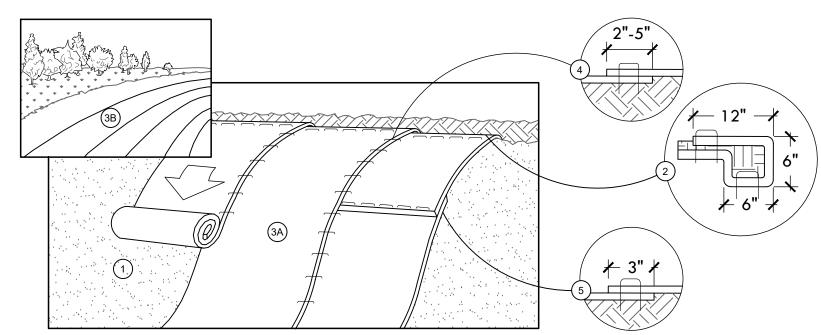

SLOPE INSTALLATION

PREPARE SOIL BEFORE INSTALLING BLANKETS, INCLUDING ANY NECESSARY APPLICATION OF LIME, FERTILIZER, AND SEED.

BEGIN AT THE TOP OF THE SLOPE BY ANCHORING THE BLANKET IN A 6" DEEP X 6" WIDE TRENCH WITH APPROXIMATELY 12" OF BLANKET EXTENDED BEYOND THE UP-SLOPE PORTION OF THE TRENCH. ANCHOR THE BLANKET WITH A ROW OF STAPLES/STAKES APPROXIMATELY 12" APART IN THE BOTTOM OF THE TRENCH. BACKFILL AND COMPACT THE TRENCH AFTER STAPLING. APPLY SEED TO COMPACTED SOIL AND FOLD REMAINING 12" PORTION OF BLANKET BACK OVER SEED AND COMPACTED SOIL. SECURE BLANKET OVER COMPACTED SOIL WITH A ROW OF STAPLES/STAKES SPACED APPROXIMATELY 12" APART ACROSS THE WIDTH OF THE BLANKET.


ROLL THE BLANKETS (A.) DOWN OR (B.) HORIZONTALLY ACROSS THE SLOPE. BLANKETS WILL UNROLL WITH APPROPRIATE SIDE AGAINST THE SOIL SURFACE. ALL BLANKETS MUST BE SECURELY FASTENED TO SOIL SURFACE BY PLACING STAPLES/ STAKES IN APPROPRIATE LOCATIONS AS SHOWN IN THE STAPLE PATTERN GUIDE. WHEN USING OPTIONAL DOT SYSTEM, STAPLES/STAKES SHOULD BE PLACED THROUGH EACH OF

THE COLORED DOTS CORRESPONDING TO THE APPROPRIATE STAPLE PATTERN. 4. THE EDGES OF PARALLEL BLANKETS MUST BE STAPLED WITH APPROXIMATELY 2"-5" OVERLAP DEPENDING ON BLANKET TYPE. TO ENSURE PROPER SEAM ALIGNMENT, PLACE THE EDGE OF THE OVERLAPPING BLANKET (BLANKET BEING INSTALLED ON TOP) EVEN WITH THE COLORED SEAM STITCH ON THE PREVIOUSLY INSTALLED BLANKET.


CONSECUTIVE BLANKETS SPLICED DOWN THE SLOPE MUST BE PLACED END OVER END (SHINGLE STYLE) WITH AN APPROXIMATE 3" OVERLAP. STAPLE THROUGH OVERLAPPED AREA, APPROXIMATELY 12" APART ACROSS ENTIRE BLANKET WIDTH.

INSTALLATION TO BE COMPLETED IN ACCORDANCE WITH MANUFACTURER'S SPECIFICATIONS. IN LOOSE SOIL CONDITIONS THE USE OF STAPLE OR STAKE LENGTHS GREATER THAN 6" (15CM) MAY BE NECESSARY TO PROPERLY SECURE THE

EROSION CONTROL BLANKET

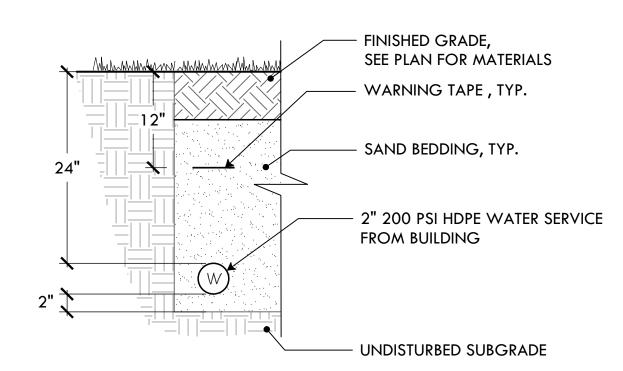

WATER LINE TRENCH

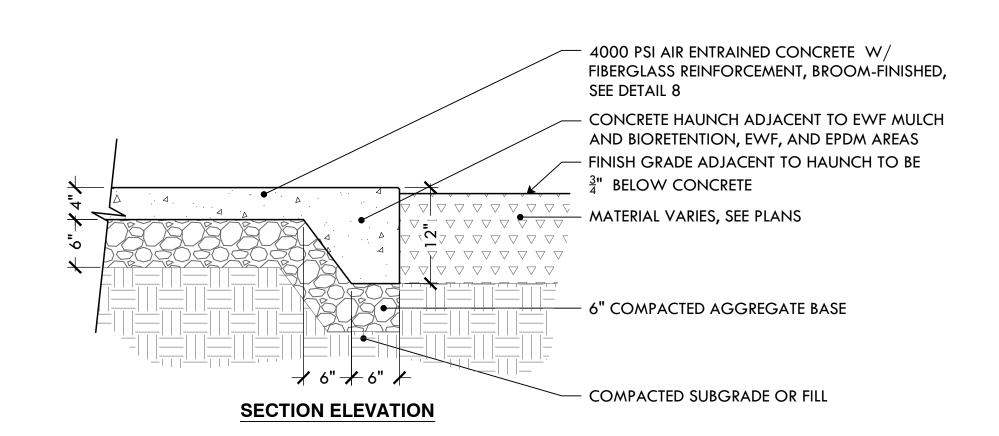

12" CONCRETE HAUNCH

PROVIDENCE PARKS DEPARTMENT

> DALRYMPLE BOATHOUSE ROGER WILLIAMS PARK PROVIDENCE, RI 02905

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PROJECT:

Site Improvements at Miguel Luna Park

110 Sackett St Providence, RI

REVISIONS: Issued For:

2\ 4/8/2025 Addendum #2

NORTH ARROW

SCALE

CHECKED BY: MG

DRAWING INFO DATE ISSUED: 03/24/25 PROJECT NO: MIGU.22.01 DRAWN BY: AN, II, SG

SHEET TITLE Construction

Details


L-10

13 OF 22

3" VEHICULAR ASPHALT PAVING

N.T.S.

MIGU.22.01-DETAILS.dwg

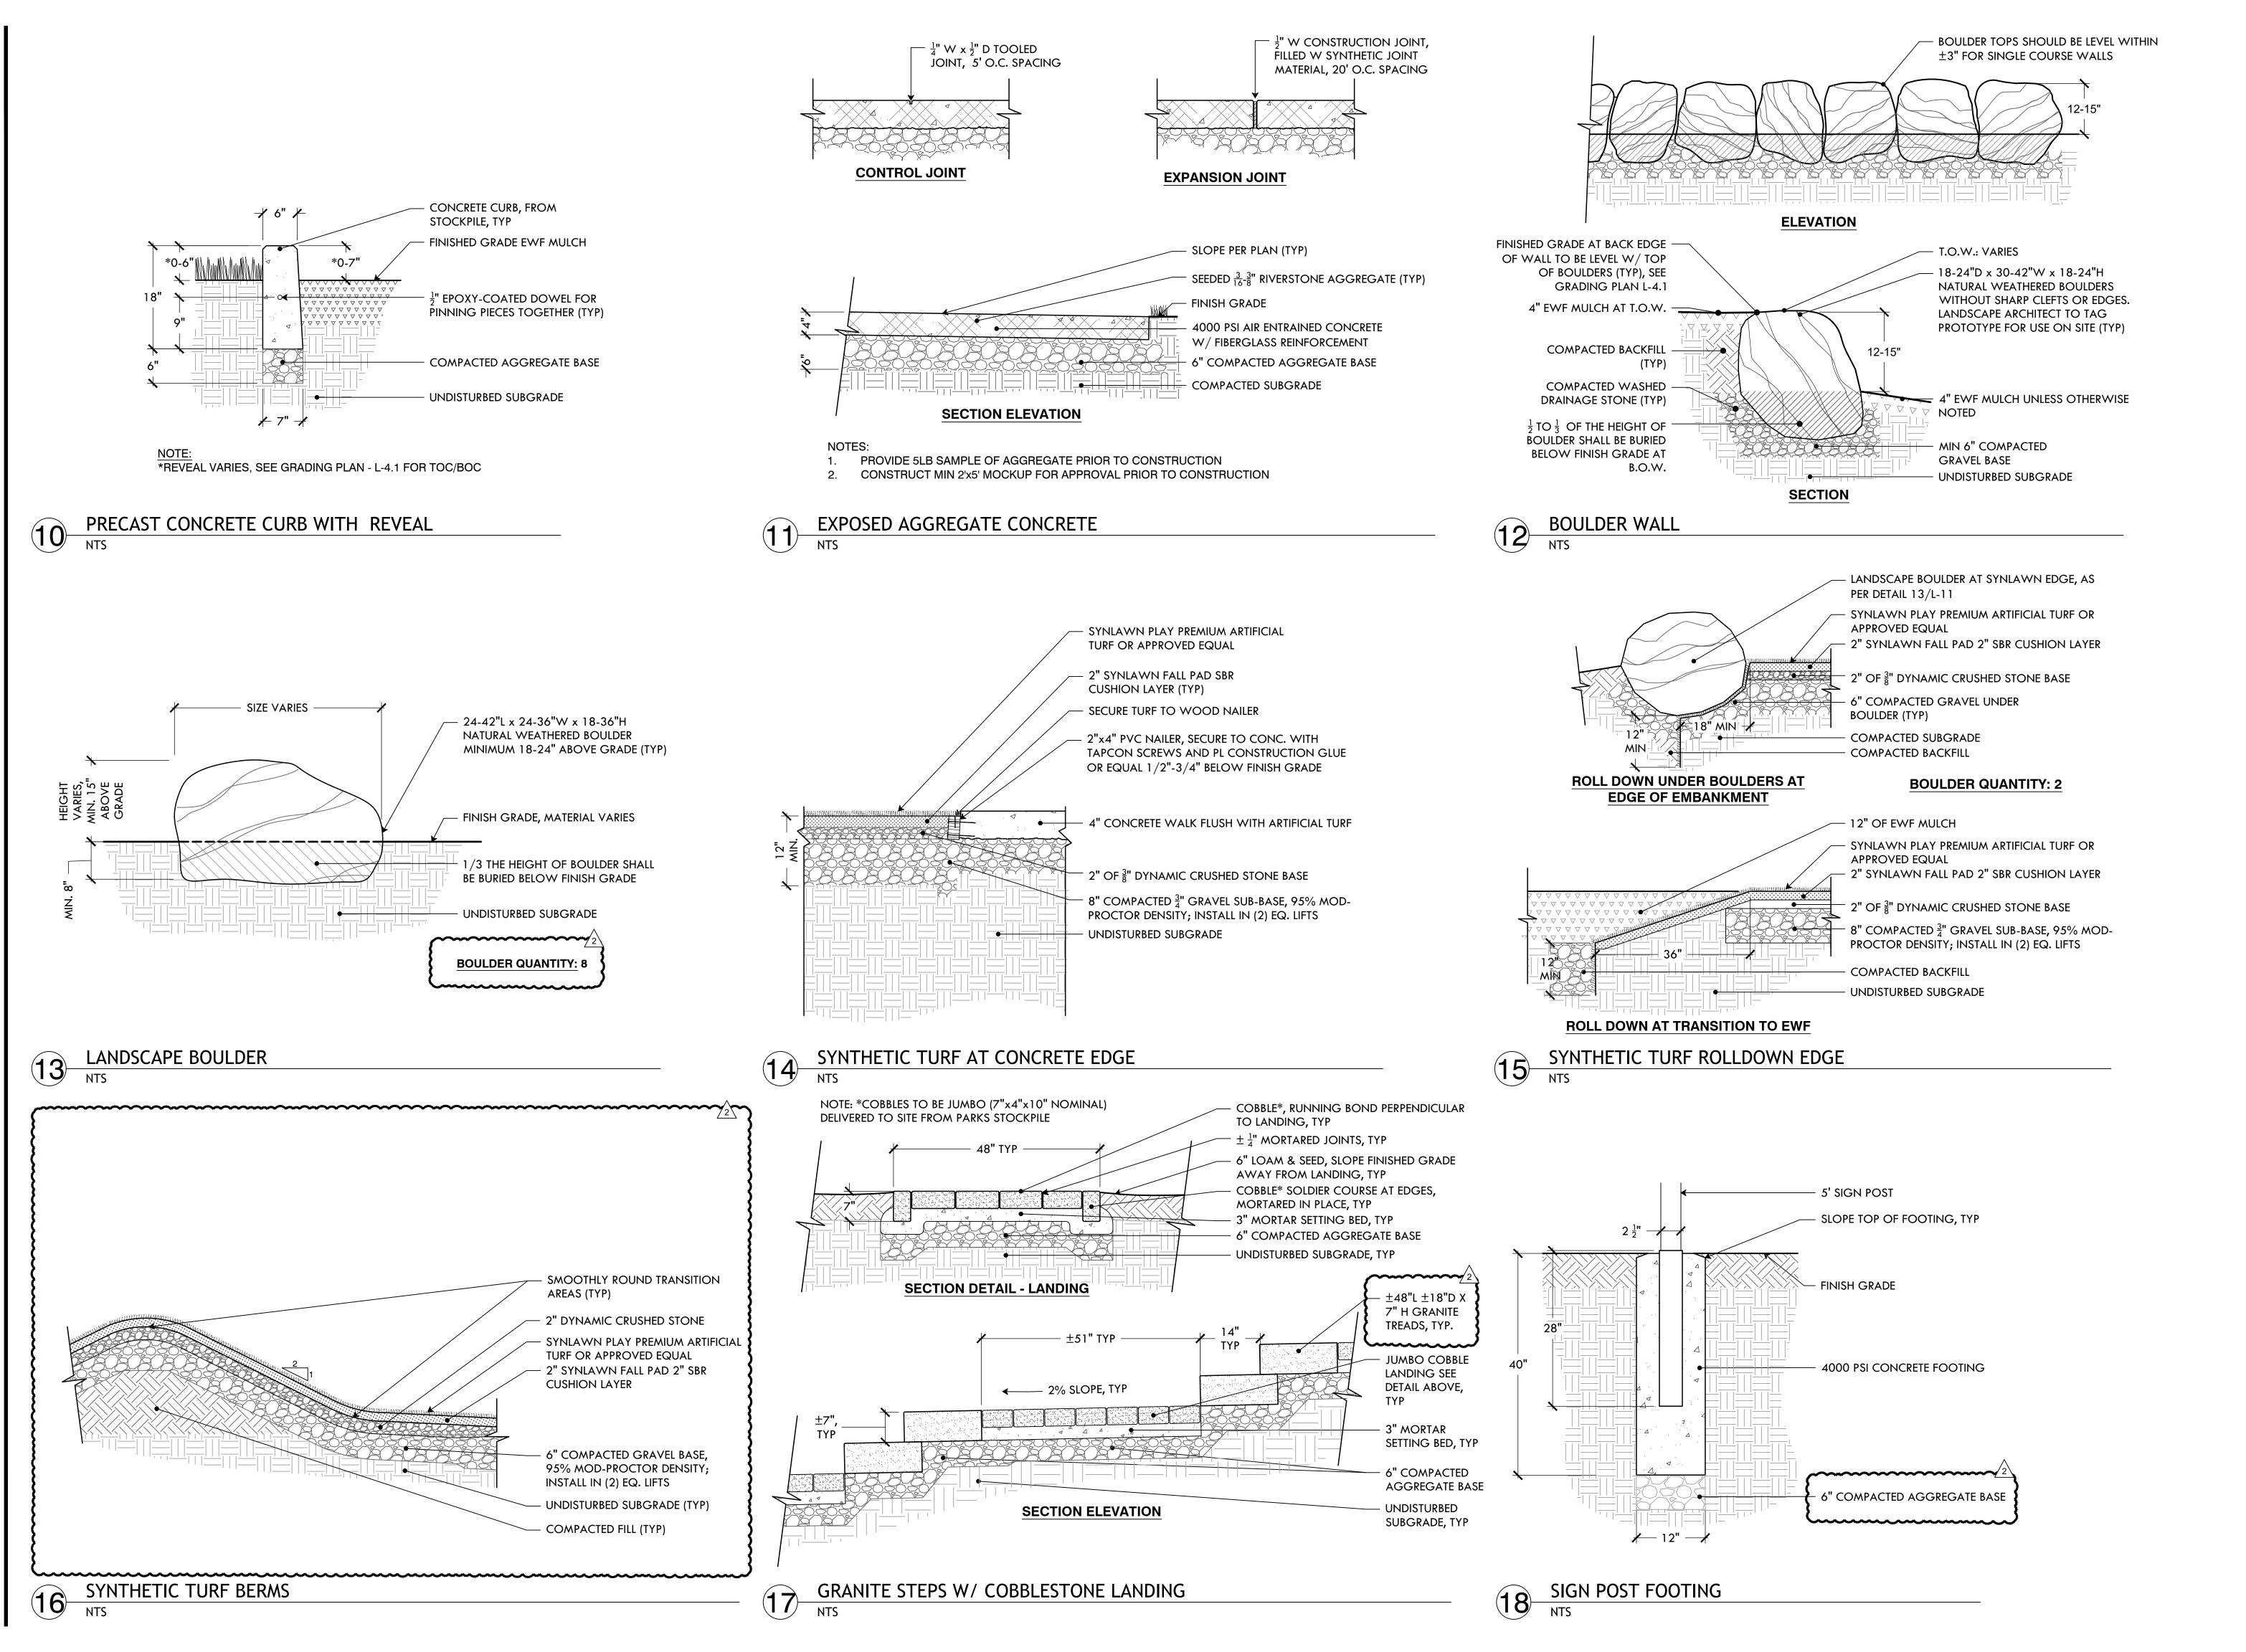

PROVIDENCE

PROVIDENCE
PARKS DEPARTMENT

DALRYMPLE BOATHOUSE
ROGER WILLIAMS PARK



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PROJECT:

Site Improvements at Miguel Luna Park

110 Sackett St Providence, RI

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NORTH ARROW

SCALE


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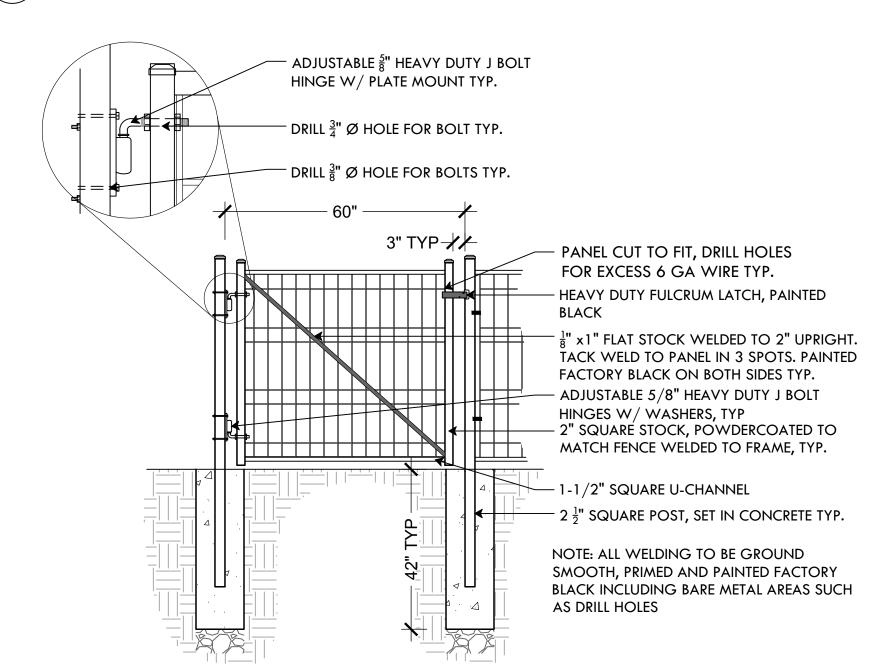
SHEET TITLE

Construction


Details
L-11



FENCE AT SIDEWALK

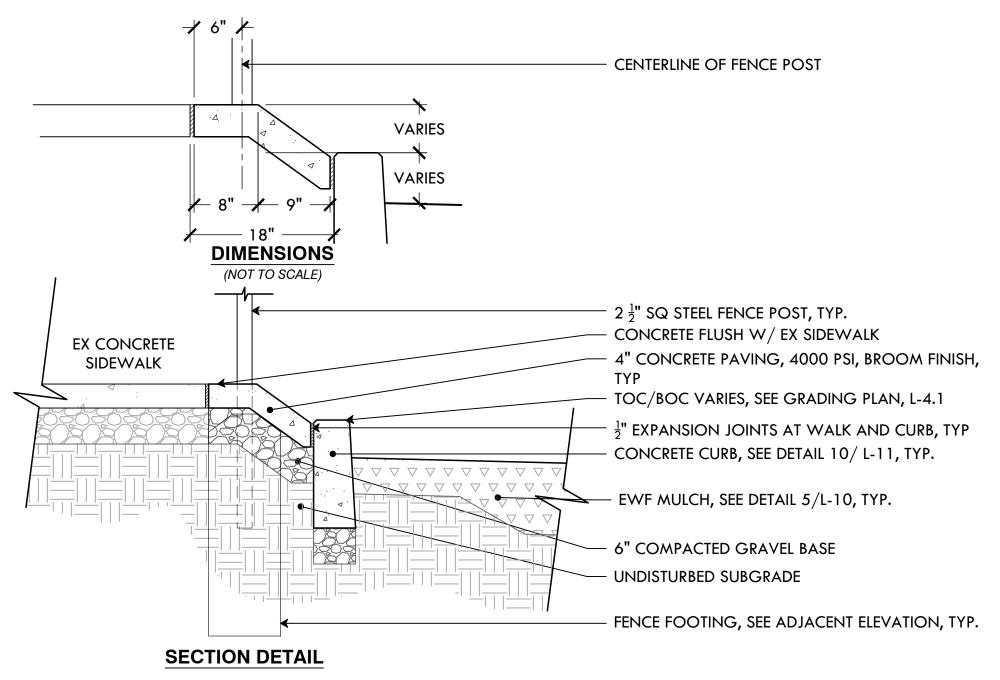

5' WIDE WELDED WIRE MESH GATE

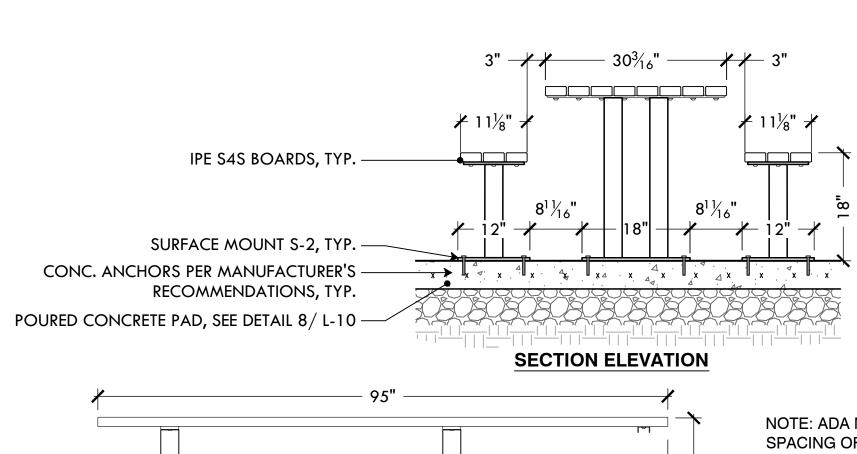

NOTE: ADA MODEL SHOWN, SPACING OF BOLTS DIFFERS ON STANDARD MODEL, SEE MANUFACTURER'S DETAIL SURFACE MOUNT S-2 (TYP) 🖊 12" 🕌 SIDE ELEVATION


ADA PICNIC TABLE, SURFACE MOUNT

ADJUSTABLE 5/8" HEAVY NOTE: ALL WELDING TO BE GROUND DUTY J BOLT HINGE W/ PLATE SMOOTH, PRIMED AND PAINTED MOUNT TYP. FACTORY BLACK INCLUDING BARE - DRILL 3/4" Ø HOLE FOR BOLT METAL AREAS SUCH AS DRILL HOLES DRILL 3/8" Ø HOLE FOR BOLTS TYP. - HEAVY DUTY STRONG PANEL CUT TO FIT, DRILL HOLES FOR EXCESS 6 GA WIRE TYP. ARM LATCH - ADJUSTABLE 5/8" HEAVY 1 x1" FLAT STOCK WELDED TO DUTY J BOLT HINGES W/ 2" UPRIGHT. TACK WELD TO PANEL IN 3 SPOTS. PAINTED WASHERS, TYP FACTORY BLACK ON BOTH 2" SQUARE STOCK, POWDERCOATED TO MATCH SIDES TYP. FENCE WELDED TO FRAME, - 1-1/2" SQUARE U-CHANNEL — 1" LOCKABLE DROP ROD $-2\frac{1}{2}$ " SQUARE POST, TYP.


12' WELDED WIRE MESH SERVICE GATE

IN-GROUND MOUNT: EWF MOUNTED IN CONCRETE - UNTREATED THERMALLY **MODIFIED RED** OAK S4S EE SLATS (TYP.) ALL METAL **COMPONENTS** PAINTED BLACK (TYP.) — 4" EWF MULCH S-2 SURFACE MOUNT, INSTALL PER MANUFACTURER'S S-1 EMBEDMENT, INSTALL SPECIFICATIONS. PER MANUFACTURER'S 4" CONCRETE PAD SPECIFICATIONS. 4000 PSI POURED **CONCRETE FOOTING** NOTES: ₩ 12" Ø 🔐 - 6" COMPACTED **GRAVEL BASE** 1. SEE PLAN FOR PLACEMENT OF BACKED AND BACKLESS BENCH MODELS. - UNDISTURBED SUBGRADE

6' BENCH (IN GROUND & SURFACE MOUNT)

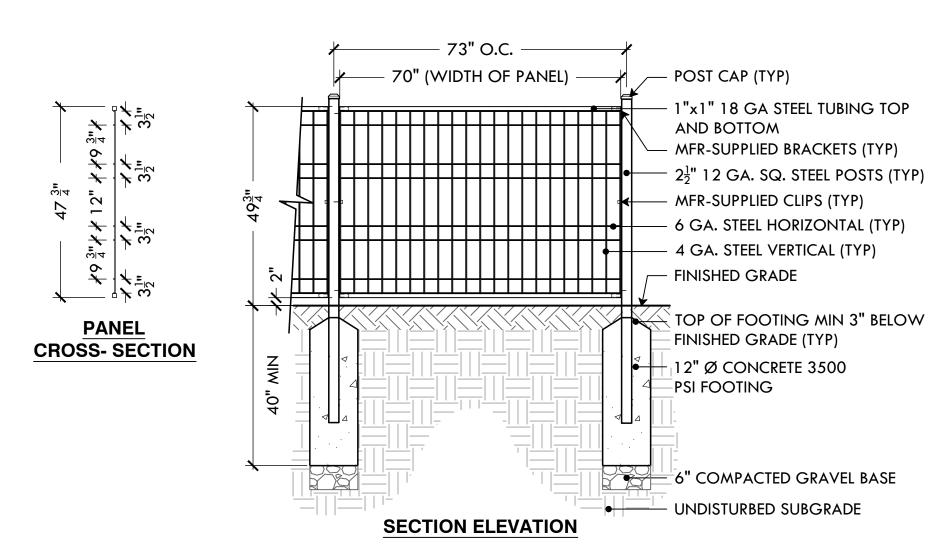

4' HT WELDED WIRE MESH FENCE

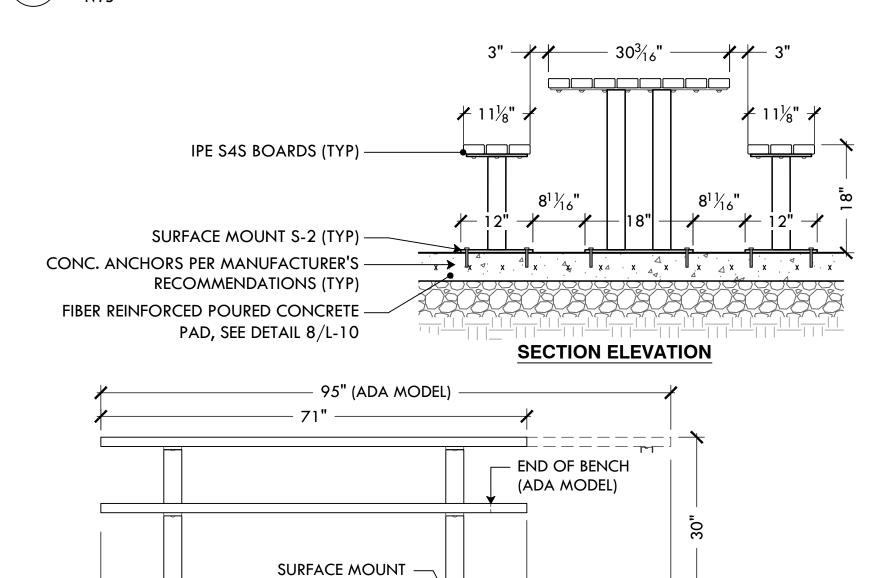


S-2 (TYP)

SIDE ELEVATION

PICNIC TABLE, SURFACE MOUNT

/ 12" /

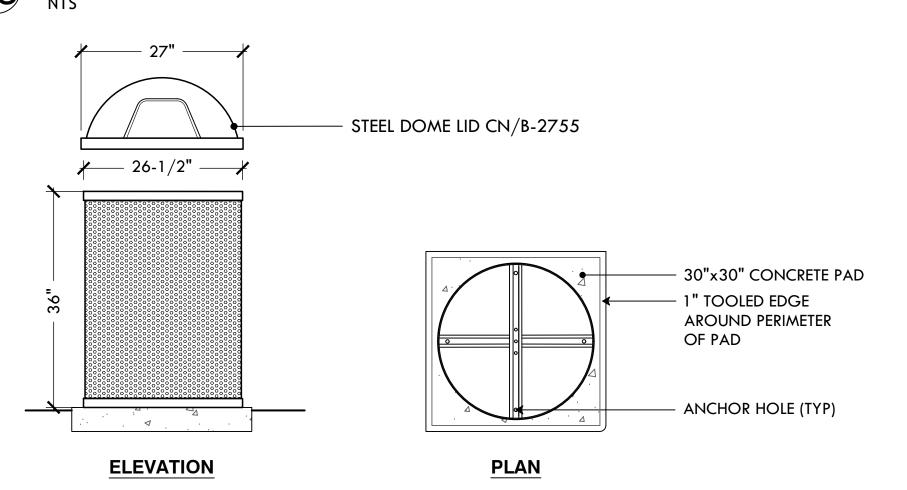


12" 🖈 30"

(ADA)

- SEE DETAIL 8/L-10 FOR CONCRETE PAD. 2. UNIT SHOULD BE SECURED TO CONCRETE PAD USING THE FOUR (4) ANCHOR HOLES.
- 3. 55 GAL. ROUND PERFORATED STEEL TRASH RECEPTACLE. COLOR: BLACK, MATERIAL: STEEL.
- 4. 27" O.D. DOME LID. COLOR: BLACK, MATERIAL: STEEL
- 55 GAL. 23-5/8" O.D. X 35" HT., HEAVY DUTY RIGID PLASTIC LINER. 1 KIT CONTAINS (2) 36" X 1 STEEL CABLES W/ ALUMINUM SLEEVES

TRASH RECEPTACLE ON CONCRETE PAD

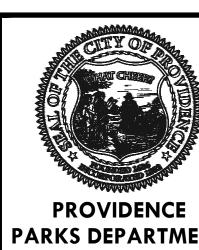

PARKS DEPARTMENT DALRYMPLE BOATHOUSE ROGER WILLIAMS PARK PROVIDENCE, RI 02905



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STAMP

PROJECT:

Site Improvements at Miguel Luna Park

110 Sackett St Providence, RI

REVISIONS: Issued For:

2\ 4/8/2025 Addendum #2

NORTH ARROW

SCALE


DRAWING INFO DATE ISSUED: 03/24/25

PROJECT NO: MIGU.22.01 DRAWN BY: AN, II, SG CHECKED BY: MG

SHEET TITLE Construction Details

L-12

HALF SPHERE QUANTITY (5) MEDIUM (4) LARGE

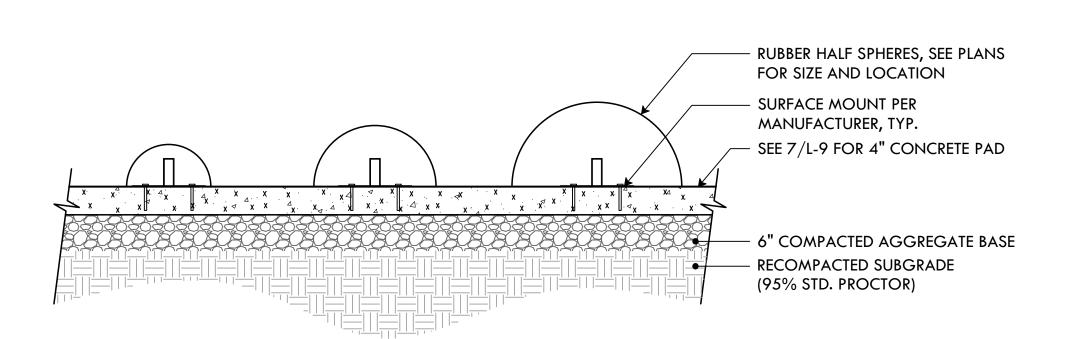

FINISHED GRADE (TYP)

EQUIPMENT POST (TYP)

12" EWF MULCH (TYP)

COMPACTED FILL (TYP)

18"x26"x20" 4000 PSI POURED CONCRETE FOOTING (TYP)

- UNDISTURBED SUBGRADE (TYP)

6" COMPACTED GRAVEL BASE (TYP)


GORIC SPHERES AND HALF SPHERES


18"

FOOTING SECTION

— 11**'-6"** ——

KOMPAN-TOT SWING FOOTING LAYOUT

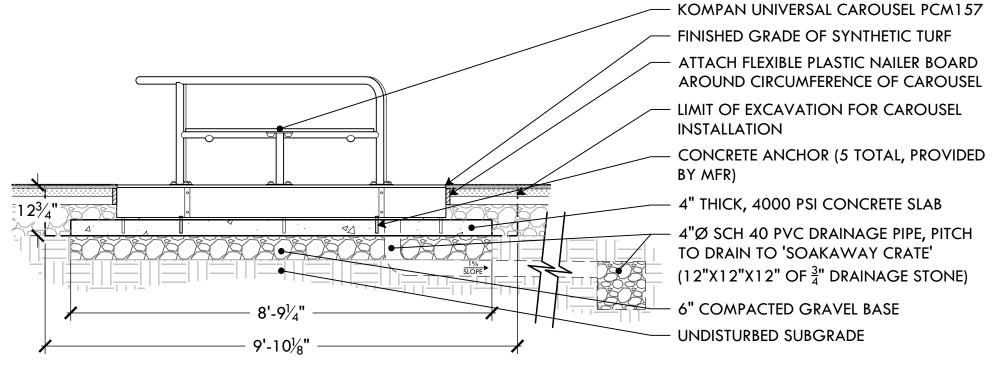

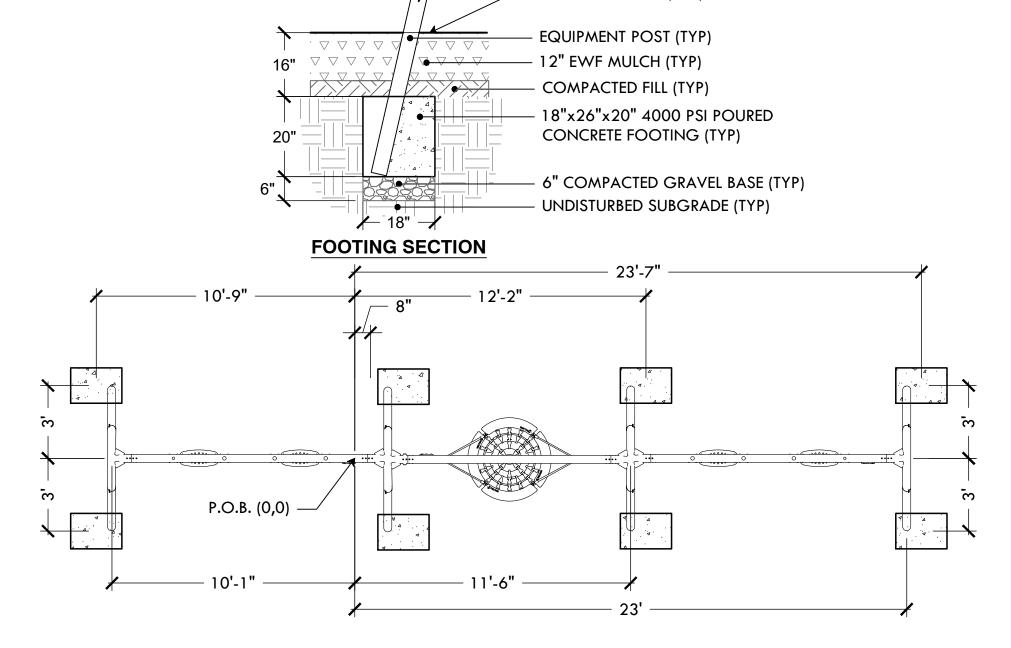

FINISHED GRADE (TYP)

PERENNIAL OR GROUNDCOVER

AS NOTED ON PLANTING PLAN

3" AGED PINE BARK MULCH

- PLANTING SOIL AS SPECIFIED

UNDISTURBED SUBGRADE

(DARK BROWN)

KOMPAN- 3 BAY SWING WITH NEST FOOTING LAYOUT

SPACING


★ PER PLANT →

SCHEDULE

12" MIN.

KOMPAN-UNIVERSAL CAROUSEL FOOTING LAYOUT


GRASS SEED MIX	
30%	IMPROVED PERENNIAL RYE
30%	TURF TYPE TALL FESCUE
35%	CHEWINGS FESCUE
5%	MINIATURE OR DUTCH WHITE CLOVER

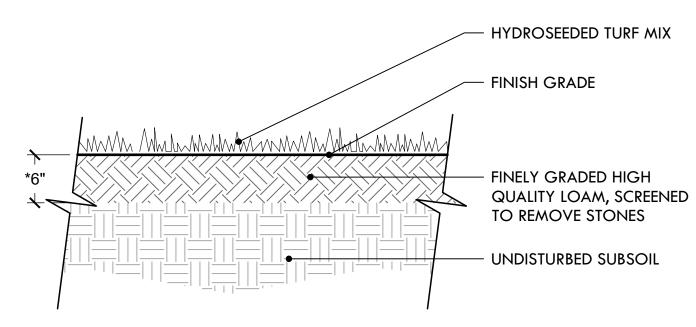


- USE A PROCESSED WOOD FIBER MULCH OR WOOD/PAPER BLEND
- ADD DOLOMITIC LIME AND 18-24-12 STARTER FERTILIZER TO LOAM PRIOR TO
- *DEPTH OF LOAM MAY BE LESS THAN 6" IN AREAS OF TRANSITION (FEATHERING) TO

PERENNIAL AND GROUNDCOVER PLANTING EXISTING LAWN AND FOR REPAIR TO DISTURBED AREAS. LIGHTLY DISTURBED AREAS TO BE AERATED, TOP-DRESSED W/ LOAM & SLICE-SEEDED.




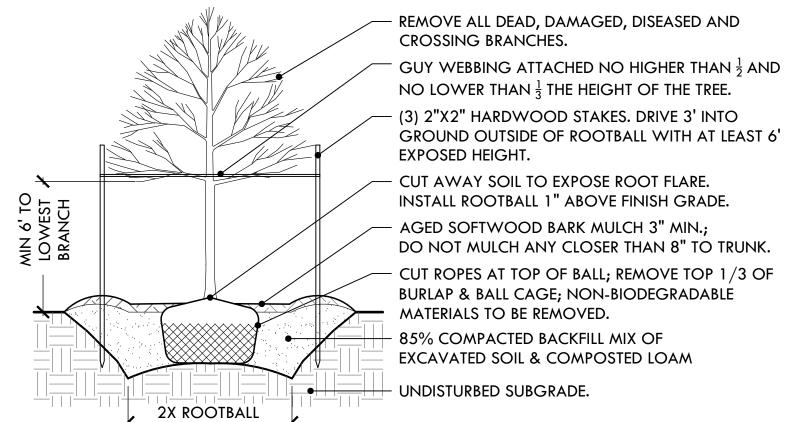


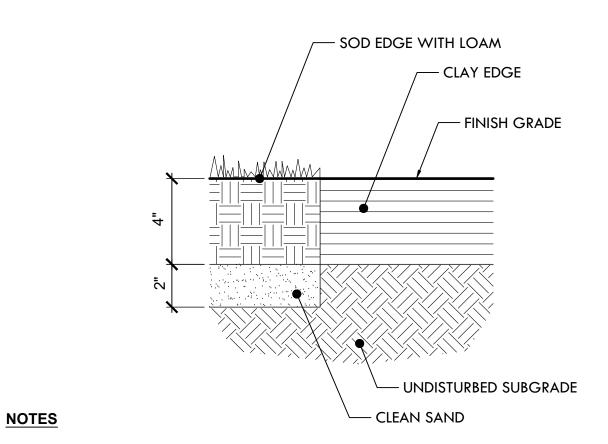

- SAND: 65% TO 69% OF THE TOTAL SAND CONTENT, 45% TO 50% SHALL BE COMPOSED OF MEDIUM, COARSE, AND VERY COARSE SAND PARTICLES.
- 2. SILT & CLAY: THE COMBINED AMOUNT OF SILT AND CLAY SHALL BE BETWEEN 31% AND 35%. THE SILT-TO-CLAY RATIO. SHALL BE BETWEEN 0.5 AND 1.0.



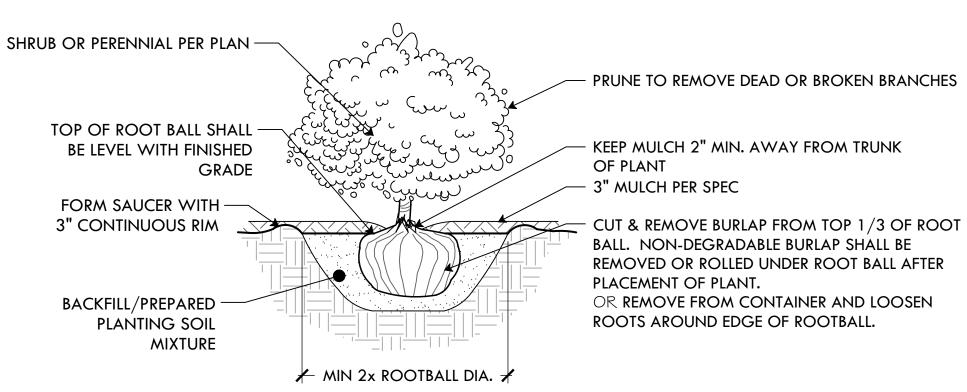

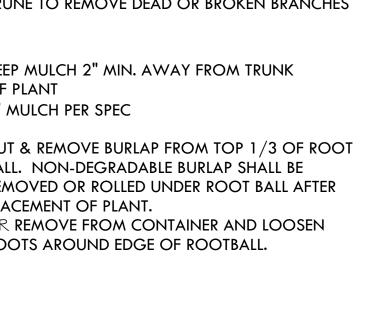

DECIDUOUS TREE PLANTING

DIA. MIN.

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PROVIDENCE

PARKS DEPARTMENT

DALRYMPLE BOATHOUSE

ROGER WILLIAMS PARK

PROVIDENCE, RI 02905


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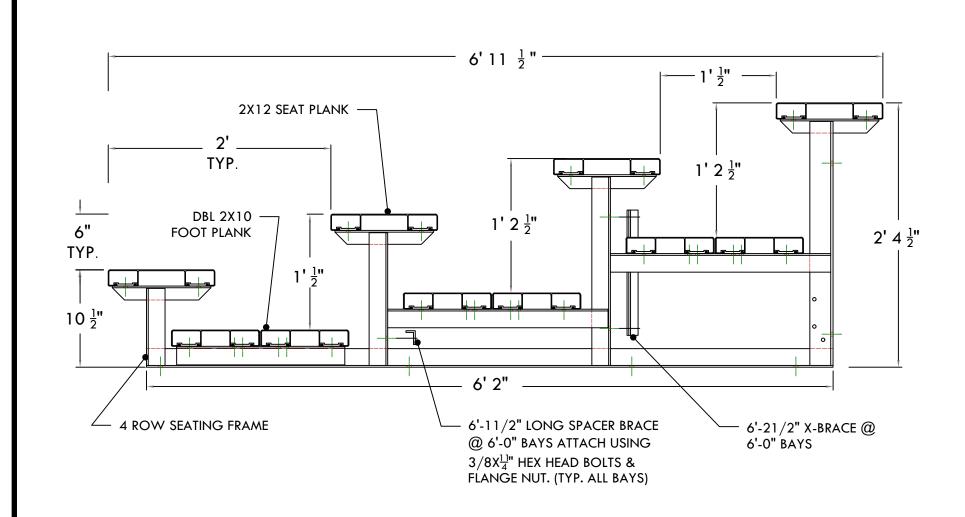
SCALE

DATE ISSUED: **03/24/25** PROJECT NO: MIGU.22.01 DRAWN BY: AN, II, SG CHECKED BY: MG


SHEET TITLE Construction Details

L-13



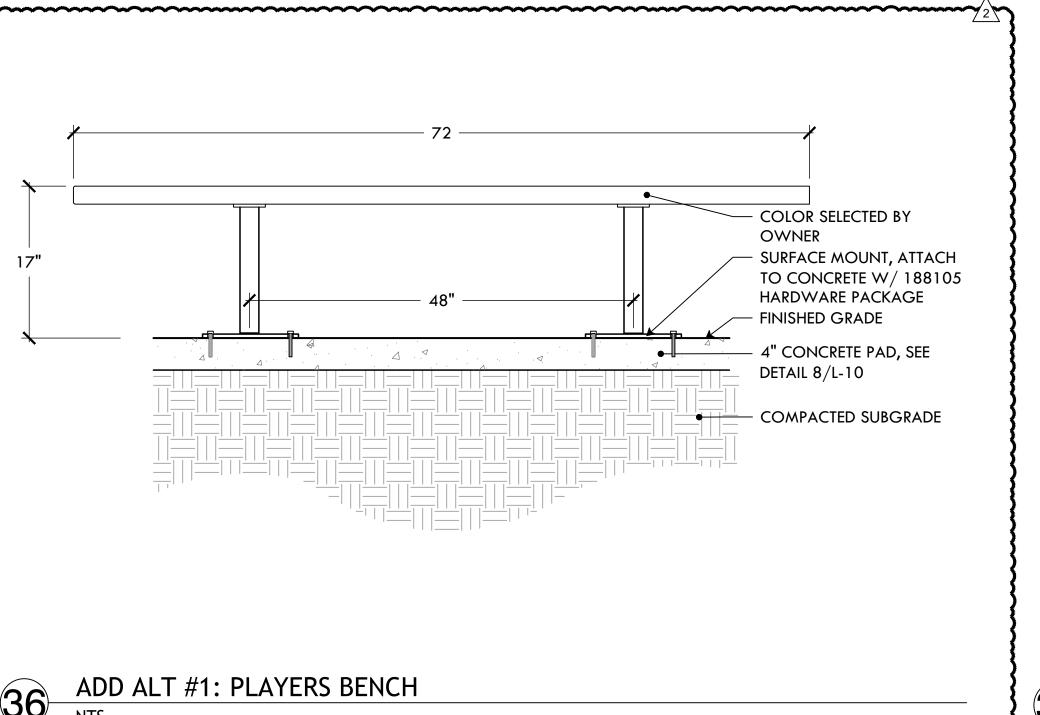

ADD ALT #3: 3 ROW BLEACHER ON CONCRETE PAD

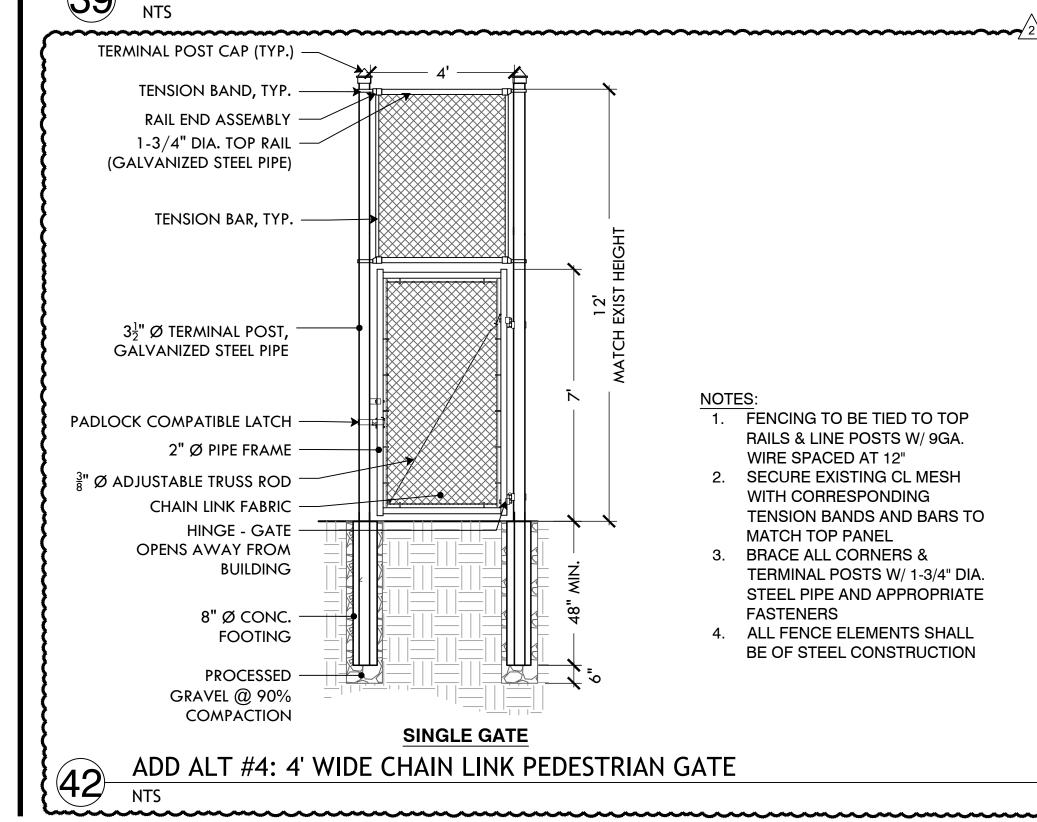


 4" FINAL COMPACTED DEPTH PLACE PRODUCT IN 2 TO 3" LIFTS SCARIFY THE SURFACE BETWEEN LIFTS TO FACILITATE BONDING OF THE NEXT LIFT AND REPEAT UNTIL FINISH GRADE ELEVATION IS ACHIEVED ACHIEVE 85% TO 90% COMPACTION BASED ON A STANDARD PROCTOR TEST (ASTM D 689-07) 1/2" TO 1% SLOPE ON FINAL GRADE COMPACTED SUB-BASE: 90% COMPACTION OR GREATER. IF THAT COMPACTION CANNOT BE ACHIEVED THEN SELECTED GRANULAR FILL MUST BE IMPORTED AND PLACED THAT WILL FULFILL THE COMPACTION REQUIRED. THE COMPACTION SUB-GRADE SHOULD MIRROR FINISHED GRADE TO ENSURE THAT AN EVEN DEPTH OF MATERIAL HAS BEEN PLACED.

INFIELD SKIN SURFACE:


- SAND: 70% TO 75% OF THE TOTAL SAND CONTENT, 50% SHALL BE COMPOSED OF MEDIUM, COARSE, AND VERY COARSE SAND PARTICLES.
- 2. SILT & CLAY: THE COMBINED AMOUNT OF SILT AND CLAY SHALL BE BETWEEN 25% AND 30%. THE SILT-TO-CLAY RATIO. SHALL BE BETWEEN 0.5 AND 1.0.

ADD ALT #2: INFIELD MIX

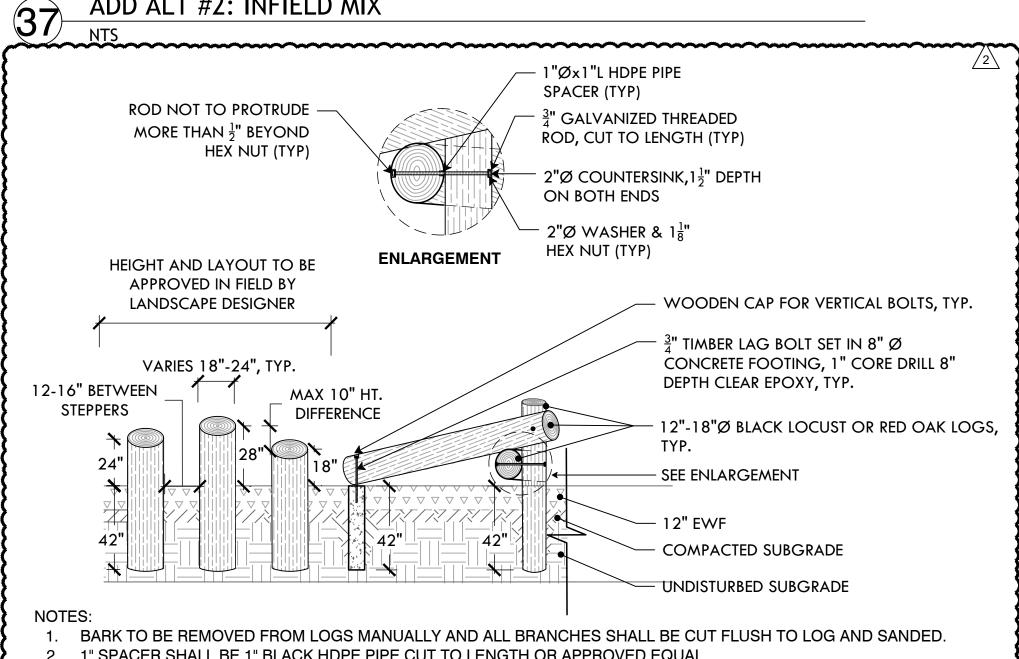


- 2. 1" SPACER SHALL BE 1" BLACK HDPE PIPE CUT TO LENGTH OR APPROVED EQUAL
- 3. 1½" COUNTERSINK ALL TIMBER BOLT CONNECTIONS (BOTH ENDS), NO METAL SHALL PROTRUDE FROM SURFACE.
- 4. USE $\frac{3}{4}$ " x 24"-30" GALVANIZED TIMBER BOLTS W/ ASSOCIATED GALV. NUT & LOCK WASHER
- 5. TREAT ALL EXPOSED SANDED WOOD SURFACES WITH HOWARD SUNSHIELD CONDITIONER

ADD ALT #9: LOG SCRAMBLE

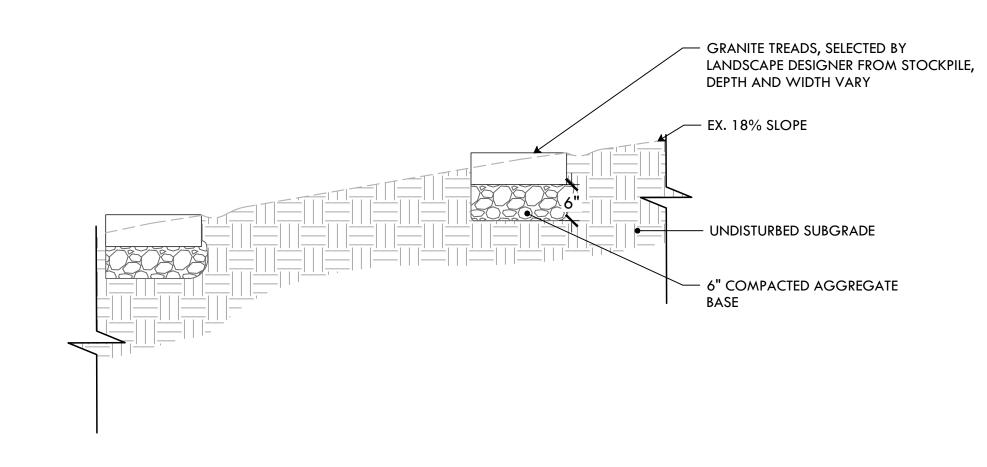

ADD ALT #11 :SALVAGED GRANITE TREADS WITH GRAVEL BASE

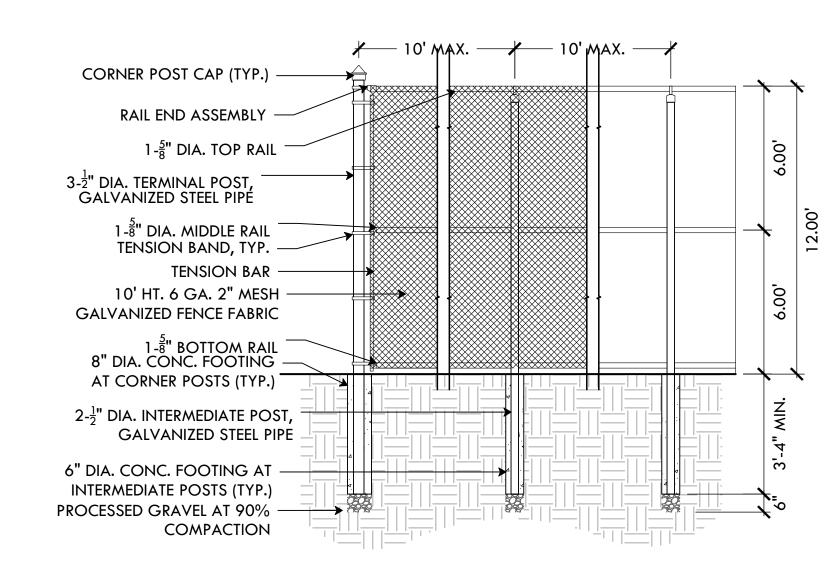


NOTES:

FENCING TO BE TIED TO ALL RAILS & LINE POSTS W/ 9GA. WIRE SPACED AT 12" BRACE ALL CORNERS & TERMINAL POSTS W/ 1-3/4" DIA. GALV. STEEL PIPE AND APPROPRIATE FASTENERS

ADD ALT #4: 12' CHAIN LINK FENCE

10" #4 REBAR, PREDRILLED AND STAKED 4' O.C. IN ALL ROWS, TYP. TOW/BOW VARIES, SEE GRADING PLAN L-4.2 FINISHED GRADE VARIES, SEE GRADING PLAN, L-4.2 4" COMPACTED GRAVEL FIRST COURSE SET BELOW GRADE 36" #4 REBAR TO SET **SUBGRADE** FIRST ROW OF TIMBER, 4' O.C. 1" WEEP HOLES BETWEEN TIMBERS ON FIRST AND SECOND ROW. STAGGER, 4' O.C. BETWEEN ROWS, TYP.

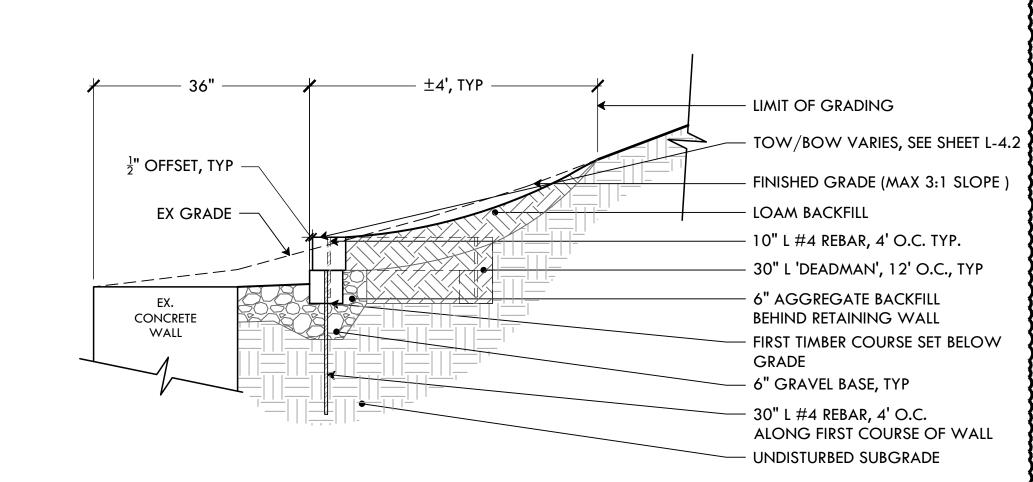

ADD ALT #5 & #6: TIMBER RETAINING WALL- ELEVATION & SECTION

43

PROVIDENCE

PARKS DEPARTMENT DALRYMPLE BOATHOUSE ROGER WILLIAMS PARK

PROVIDENCE, RI 02905



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STAMP

PROJECT:

Site Improvements at Miguel Luna Park

110 Sackett St Providence, RI

REVISIONS: Issued For:

2\ 4/8/2025 Addendum #2

NORTH ARROW

SCALE


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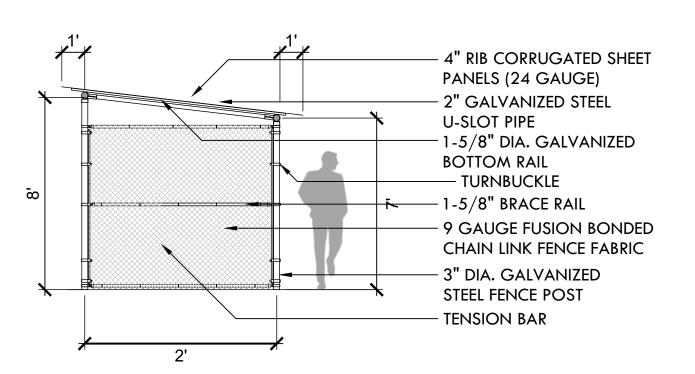
DATE ISSUED: 03/24/25 PROJECT NO: MIGU.22.01 DRAWN BY: AN, II, SG CHECKED BY: MG


SHEET TITLE Construction

Details


L-14




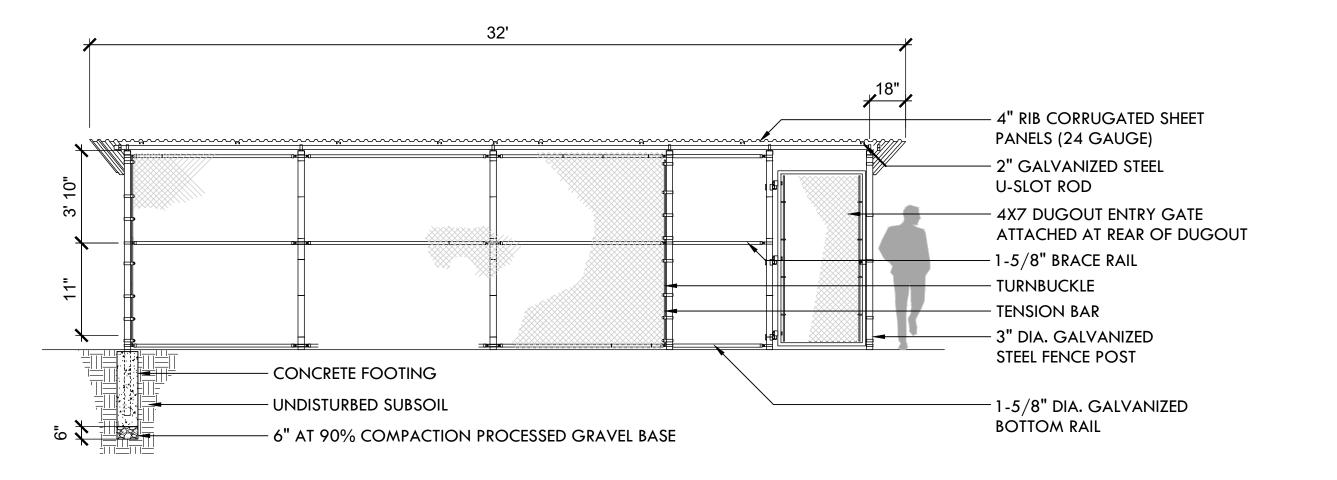

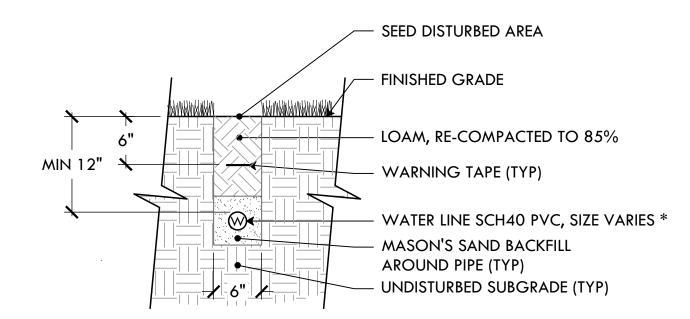


*NOTE: SEE GRADING & UTILITIES PLAN L-4.2

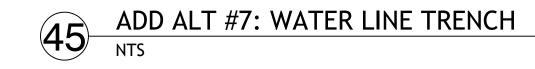

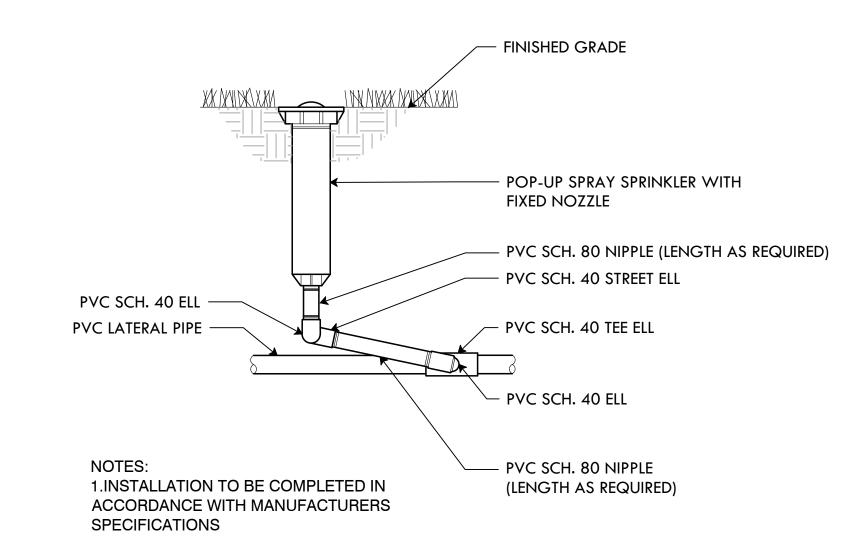

ADD ALT #7: FIXED SPRAY HEAD

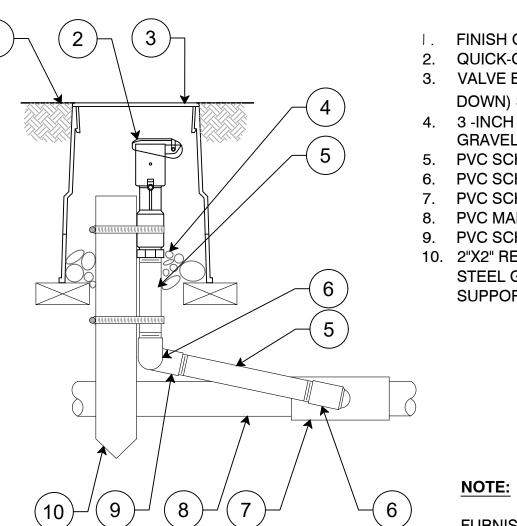

FINISH GRADE/TOP OF MULCH

QUICK-COUPLING VALVE 3. VALVE BOX WITH COVER: 10" ROUND (BOLT DOWN) SET ON 3 STONE

4. 3 -INCH MINIMUM DEPTH OF 3/4 -INCH WASHED GRAVEL

5. PVC SCH 80 NIPPLE (LENGTH AS REQUIRED) 6. PVC SCH 40 STREET ELL


7. PVC SCH 40 TEE OR ELL 8. PVC MAINLINE PIPE

9. PVC SCH40 ELL STEEL GEAR CLAMPS OR EQUIVALENT

10. 2"X2" REDWOOD STAKE WITH STAINLESS SUPPORT SYSTEM

FURNISH FITTING AND PIPING NORMALLY SIZED IDENTICAL TO NORMAL QUICK COUPLING VALVE INLET SIZE.

ADD ALT #7: QUICK COUPLING VALVE, IN ROUND BOX

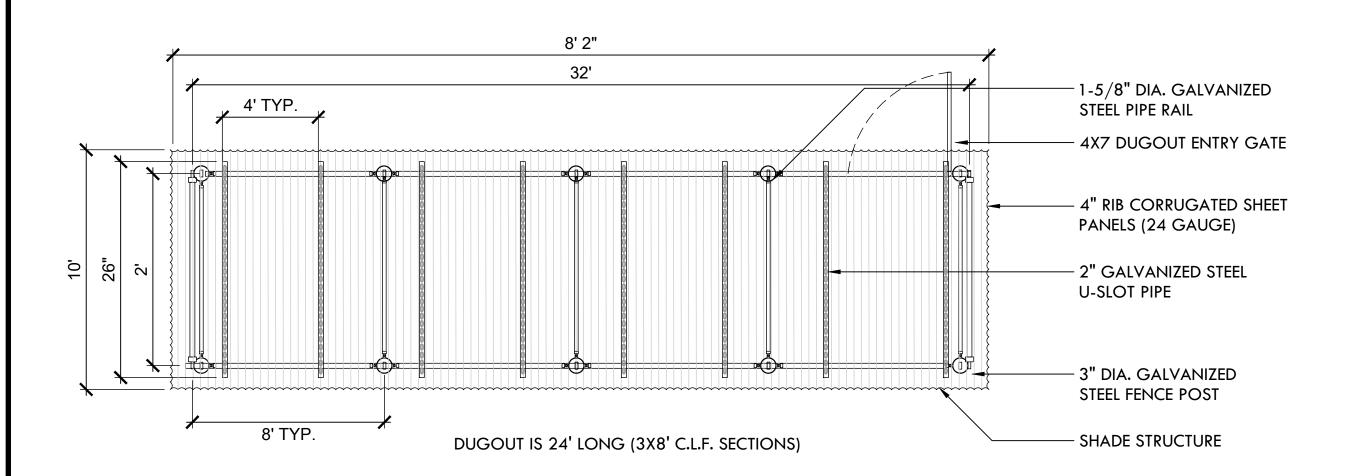

CONSTRUCTION NOTES:

FOOTING WIDTH TO BE (4)X POST WIDTH, MINIMUM DEPTH 36"

DUGOUT WILL BE 24' IN LENGTH WITH POST 8' O/C=3" SCHEDULE 40 GALVANIZED. HEIGHT IN FRONT OF DUGOUT WILL BE 8' ABOVE GRADE ELEVATION

ALL POSTS, RAILS, BRACES AND ACCESSORIES SHALL BE GALVANIZED STEEL WITH A PROTECTED ZINC COATING

ADD ALT #1: DUGOUT

NTS

NOTES:


1. METER AND BACK FLOW MUST BE ACCESSIBLE AT ALL TIMES.

2. CONTRACTOR SHALL CARRY ALL COST FOR FEES AND CHARGES BY PROVIDENCE WATER SUPPLY BOARD.

3. COST ASSOCIATED WITH TRAFFIC CONTROL SHALL BE PAID FOR BY THE CONTRACTOR.

4. WATER TURNED OFF BY PROVIDENCE WATER **BOARD AT CURB STOP**

*PER PROVIDENCE BOARD GUIDELINES

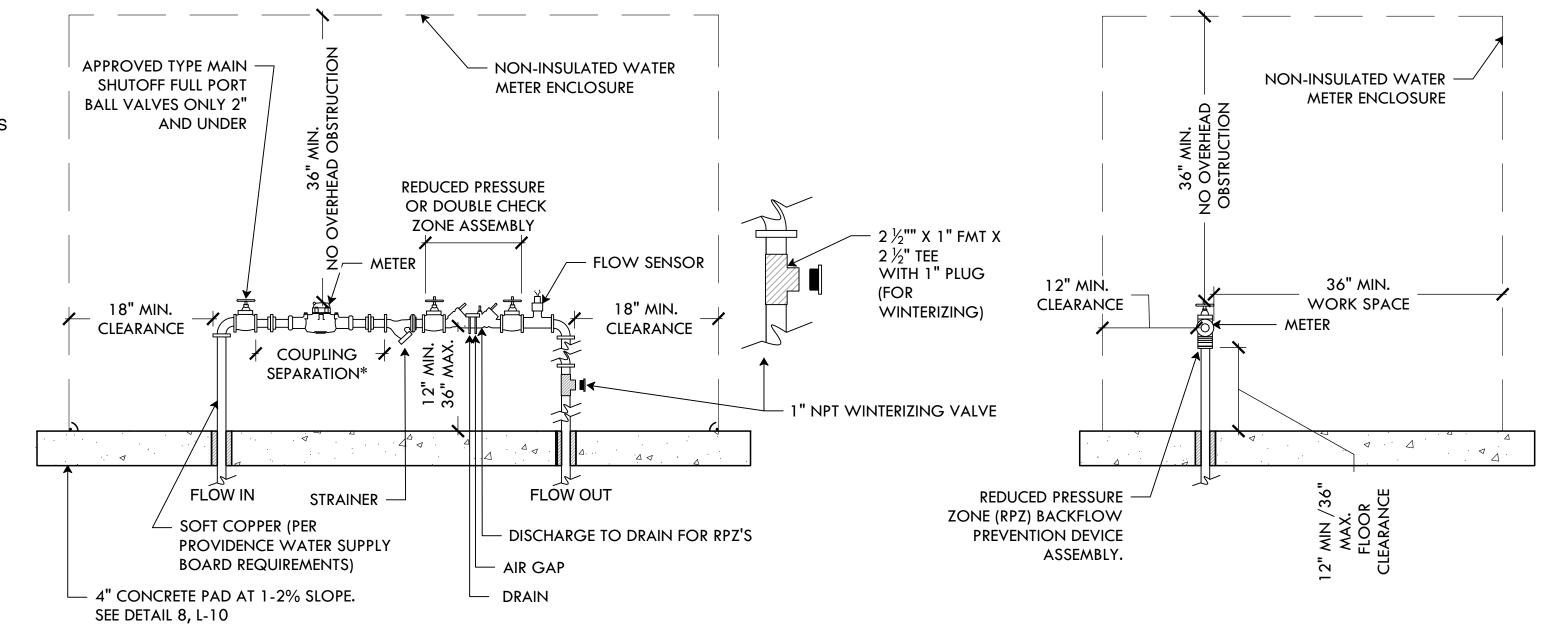

WATER METER ENCLOSURE



18 OF 22

DRAWING INFO DATE ISSUED: **03/24/25** PROJECT NO: MIGU.22.01 DRAWN BY: AN, II, SG CHECKED BY: MG

PROVIDENCE

PARKS DEPARTMENT

DALRYMPLE BOATHOUSE

ROGER WILLIAMS PARK

PROVIDENCE, RI 02905

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STAMP

PROJECT:

Site Improvements at

Issued For:

⁷2\ 4/8/2025 Addendum #2

Miguel Luna Park

110 Sackett St

Providence, RI

REVISIONS:

NORTH ARROW

SCALE


SHEET TITLE

Details


Construction

BY ANY MEANS, ELECTRONIC, MECHANICAL, PHOTOCOPYING,

L-15

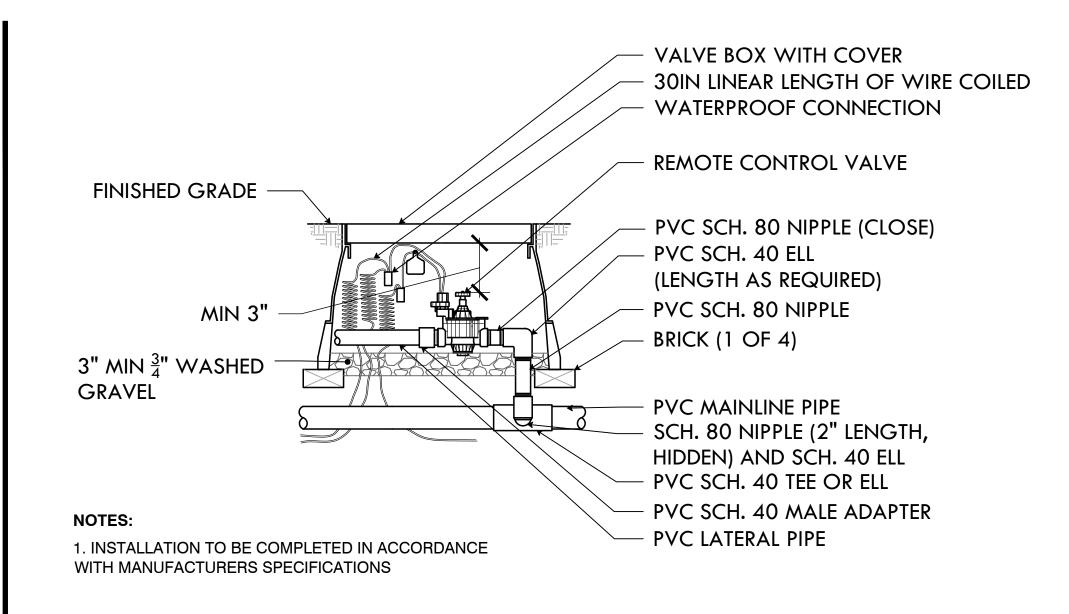


ADD ALT #7: 1.5" ZONE VALVE

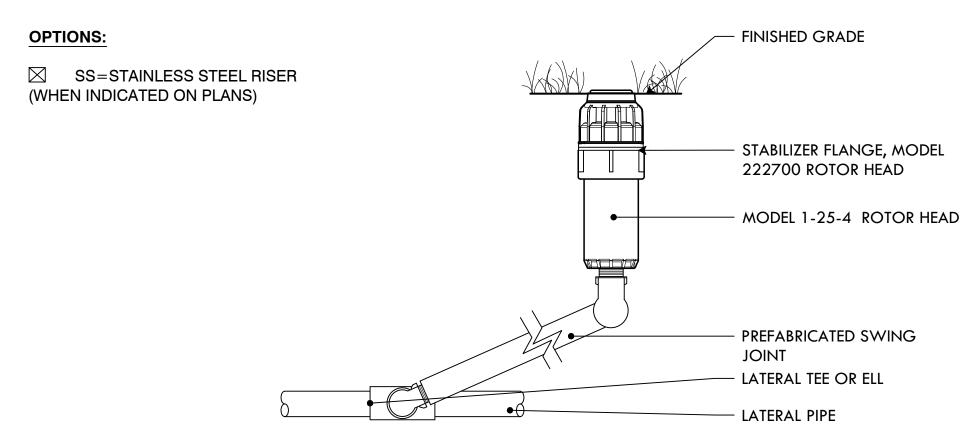

NOTE:

- 1. INSTALLATION TO BE COMPLETED IN ACCORDANCE WITH MANUFACTURER'S SPECIFICATIONS.
- 2. DO NOT SCALE DRAWINGS.
- 3. ALL DIMENSIONS ARE CONSIDERED TRUE AND REFLECT MANUFACTURER'S SPECIFICATIONS.
- 4. FOR PRODUCT AND COMPANY INFORMATION VISIT WWW.HUNTERINDUSTRIES.COM

ADD ALT #7: HUNTER I-25-4 ROTOR NTS

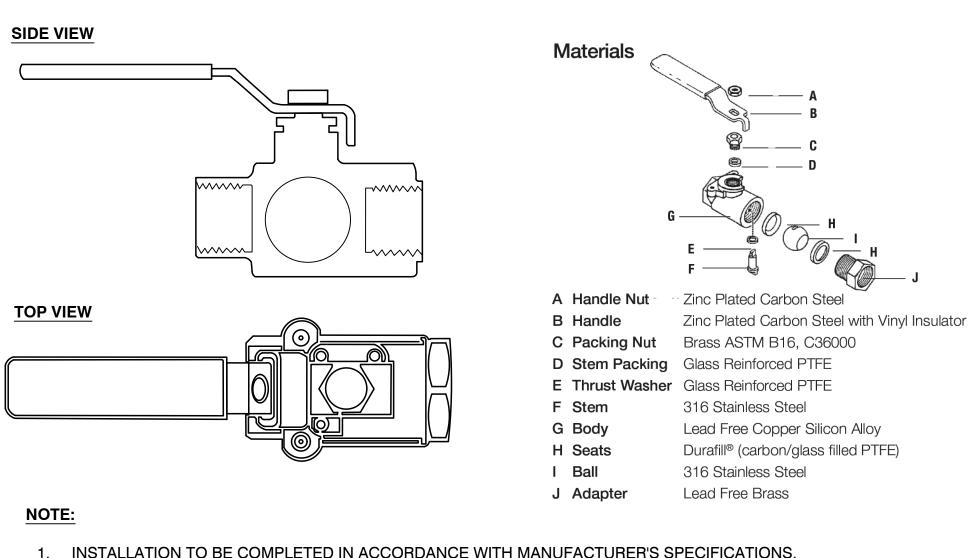


1. INSTALLATION TO BE COMPLETED IN ACCORDANCE WITH MANUFACTURER'S SPECIFICATIONS.

2. DO NOT SCALE DRAWINGS.

3. ALL DIMENSIONS ARE CONSIDERED TRUE AND REFLECT MANUFACTURER'S SPECIFICATIONS.

4. FOR PRODUCT AND COMPANY INFORMATION VISIT WWW.WATTS.COM

ADD ALT #7: 2.5" ISOLATION BALL VALVE

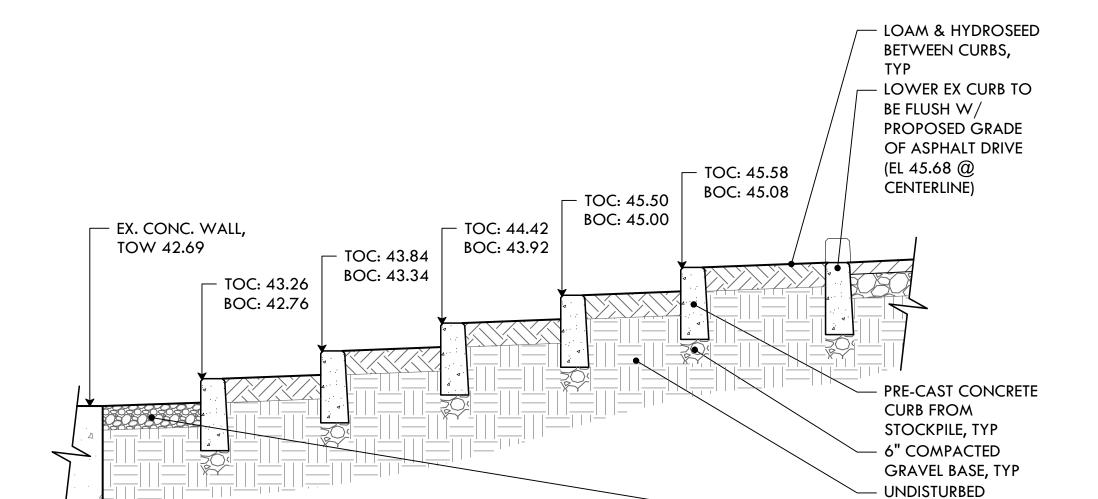


SUBGRADE, TYP

- 6" COMPACTED


X, TYP

GRAVEL, SEE DETAIL

ADD ALT #6: CONCRETE CURB STEPS

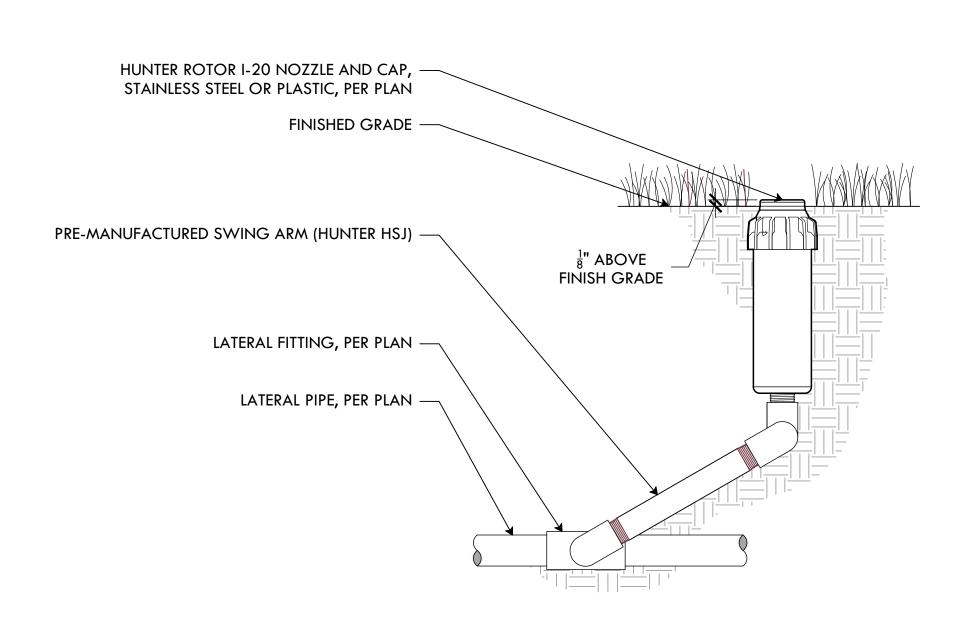

ADD ALT #7: HUNTER I-20 ROTOR

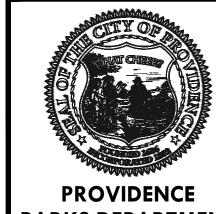

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PROJECT:

Site Improvements at Miguel Luna Park

110 Sackett St Providence, RI

REVISIONS: Date Issued For:

 $/_{2}$ \ 4/8/2025 Addendum #2

NORTH ARROW

SCALE

DRAWING INFO

DATE ISSUED: **03/24/25** PROJECT NO: MIGU.22.01 DRAWN BY: AN, II, SG CHECKED BY: MG

SHEET TITLE Construction

Details

L-16 **19** OF **22**

SPECIFICATIONS FOR CONSTRUCTION

1 GENERAL NOTES

- 1.1 THESE DESIGN DOCUMENTS WERE PREPARED BY 'VORTEX AQUATIC STRUCTURES INTERNATIONAL' FOR THE USE OF THEIR CLIENT ONLY. THE MATERIAL USED AND IDENTIFIED IN THEM REFLECTS VORTEX AQUATIC STRUCTURES INTERNATIONAL'S BEST JUDGMENT IN LIGHT OF THE INFORMATION AVAILABLE AT THE TIME OF PREPARATION. FOR THE PURPOSE OF THESE DESIGN DOCUMENTS, 'VORTEX AQUATIC STRUCTURES INTERNATIONAL' IS SYNONYMOUS WITH 'VORTEX'.
- 1.2 VORTEX ACCEPTS NO RESPONSIBILITY FOR DAMAGES, IF ANY, SUFFERED BY ANY THIRD PARTY AS A RESULT OF DECISIONS MADE OR ACTIONS BASED ON THESE DESIGN DOCUMENTS WITHOUT THE PREVIOUS CONSULTATION TO VORTEX.
- 1.3 ALL WORK, MATERIALS AND THEIR ASSEMBLIES SHALL CONFORM TO THE STANDARDS, REGULATIONS AND CODES CURRENTLY IN FORCE FOR ALL TRADES, AISC, ACNOR, EN, OR IBC.
- 1.4 THESE DESIGN DOCUMENTS DO NOT INDICATE THE METHOD OR MEANS OF CONSTRUCTION. WHEN APPLICABLE, THE CONTRACTORS SHALL SUPERVISE AND DIRECT ALL THE WORK AND SHALL BE SOLELY RESPONSIBLE FOR ALL CONSTRUCTION MEANS, METHODS, PROCEDURES AND SEQUENCES AS PER STANDARD BEST PRACTICES.
- 1.5 DO NOT SCALE DRAWINGS.
- 1.6 USE ONLY THOSE MARKED "ISSUED FOR CONSTRUCTION".
- 1.7 THE CONTRACTOR SHALL REVIEW THESE DESIGN DOCUMENTS AND REPORT ANY CONFLICTS OR OMISSIONS TO THE VORTEX IMMEDIATELY.
- 1.8 TEMPORARY SUPPORTS, WHICH WILL BE REQUIRED DURING CONSTRUCTION, SUCH AS FORMWORK, BRACING, SHORING, ETC. ARE NOT SHOWN ON THESE DRAWINGS AND ARE THE RESPONSIBILITY OF THE CONTRACTOR. THE CONTRACTOR IS RESPONSIBLE TO ENSURE THAT ALL SAFE CONSTRUCTION PROCEDURES ARE FOLLOWED.
- 1.9 THE FOLLOWING SPECIFICATIONS ARE VORTEX'S MINIMUM RECOMMENDATIONS TO OBTAIN A QUALITY PRODUCT. THE CONTRACTOR SHALL FOLLOW THE LOCAL CODES IF MORE RESTRICTIVE.
- 1.10 ALL SEEFLOW COMPONENTS TO BE SNUG-TIGHT ONLY. USING POWER TOOLS OR TIGHTEN HARDWARE FULLY-TENSIONED CAN PRODUCE CRACKING ON THE PLASTIC.

2 EXCAVATION

- 2.1 ANY SHORING OR TEMPORARY SHORING NOT SHOWN ON DRAWINGS WILL BE EXECUTED, IN A SAFE MANNER, BY THE GENERAL CONTRACTOR.
- 2.2 IT IS THE RESPONSIBILITY OF OTHERS TO VERIFY THE EXISTENCE OF ANY UNDERGROUND SERVICES ETC.
- 2.3 IF AVAILABLE, REFER TO SOIL REPORT FOR BACKFILL REQUIREMENTS. ALL BACKFILL (FOR SLAB ON GRADE, ETC.) MUST BE DONE IN ACCORDANCE WITH THE RECOMMENDATIONS OF A QUALIFIED PROFESSIONAL. USE ONLY FREE DRAINING, GRANULAR, MINERAL, INERT AND NON- REACTIVE FILL.

3 FOUNDATIONS

- 3.1 REFER TO SOIL REPORT FOR RECOMMENDATIONS
- 3.2 ALL FOOTINGS SHALL REST ON A HOMOGENEOUS LAYER OF UNDISTURBED SOIL OR ENGINEERED BACKFILL WITH A MINIMUM ALLOWABLE BEARING CAPACITY OF 100KPA (2000 PSF) AND MAXIMUM DIFFERENTIAL SETTLEMENT OF 19 MM (0.75"). ALL ORGANIC MATERIAL SHALL BE REMOVED.
- 3.3 IT IS THE CONTRACTOR'S RESPONSIBILITY TO ENSURE THAT THE SOIL AT ALL FOOTING LOCATIONS BE VERIFIED BY A QUALIFIED SOILS EXPERT BEFORE POURING FOOTINGS TO ENSURE FOOTINGS REST ON APPROPRIATE STRATA.
- 3.4 WHEN APPLICABLE, FOLLOW GEOTECHNICAL EXPERT RECOMMENDATIONS FOR ALL EXTERIOR FOOTINGS TO ENSURE FROST PROTECTION.

4 CONCRETE

- 4.1 ALL CONCRETE MATERIALS, PROCEDURES, TOLERANCES & WORKMANSHIP SHALL CONFORM TO THE LATEST ISSUES OF ACI-318 AND ACI 317 OR ACNOR CAN3-A23.1 & A23.2, DEPENDING ON PROJECT LOCATION.
- 4.2 CONCRETE THAT HAS BEEN IN THE TRUCKS LONGER THAN 2 HOURS SHALL BE REJECTED. DO NOT ADD WATER TO THE CONCRETE IN THE TRUCKS OR ON THE SITE HADDER ANY CIRCUMSTANCES.
- 4.3 USE MAXIMUM 76mm (3") SLUMP, 19mm (3/4") AGGREGATE, UNLESS
- OTHERWISE-NOTED. USE 5-7% AIR ENTRAINMENT FOR CONCRETE EXPOSED TO WEATHER ONLY.
- 4.4 ALL GROUT SHALL BE NON-SHRINK TYPE WITH A MINIMUM 28 DAYS STRENGTH OF 35.0 MPA (5000 PSI). USE 25 MM (1") GROUT UNDER ALL STEEL COLUMN BASE PLATES.
- 4.5 CONCRETE STRENGTH @ 28 DAYS TO BE:
- 4.5.1 FOUNDATIONS (FOOTINGS): 25.0 MPA (3500 PSI), UNLESS OTHERWISE NOTED.
- 4.5.2 INTERIOR SLAB ON GRADE: 25.0 MPa (3500 PSI), UNLESS OTHERWISE NOTED.
- 4.5.3 EXTERIOR SLAB ON GRADE: 32.0 MPa (4500 PSI), UNLESS OTHERWISE NOTED.
 4.6 MINIMAL RE-BAR COVER:
- 4.6.1 CONCRETE POURED ON-GRADE = 76mm (3") COVER
- 4.6.2 CONCRETE POURED INTO FORMWORK BUT EXPOSED TO SOIL AND WEATHER FOR REBAR 15m (#4) AND UNDER = 50mm (2") COVER

5 REINFORCING STEEL

5.1 DEPENDING ON PROJECT LOCATION, ALL REINFORCING STEEL SHALL CONFORM TO ASTM A615 (BARS 15m (#4) TO BE GRADE 60 WITH SUPPLEMENTARY REQUIREMENTS ON

BARS SMALLER THAN 15m (#4), TO BE GRADE 40); OR TO ACNOR GRADE G30.12 [FY = 400MPA (60,000 PSI), UNLESS OTHERWISE NOTED].

- 5.2 USE CONCRETE, PLASTIC OR STEEL SUPPORT BARS, AS PER ACI (MANUAL OF STANDARD PRACTICE FOR DETAILING CONCRETE STRUCTURES). THE RE-BAR PLACER MUST REMAIN ON-SITE DURING POURS TO VERIFY CORRECT POSITIONING OF RE-BARS. SLANT UPPER REINFORCING STEEL IN LINE WITH THE SLOPE OF THE SLAB, IF APPLICABLE.
- 5.3 BARS SHALL BE SECURELY WIRED PER LATEST EDITION OF CRSI (RECOMMENDED PRACTICE FOR PLACING REINFORCING BARS).
- 5.4 ALL REINFORCING STEEL IS TO BE KEPT CLEAN AND FREE OF MUD, SNOW, ICE, AND ANY CONTAMINANTS.
- 5.5 VERTICAL AND CONTINUOUS REBAR SHALL BE LAPPED TO DEVELOP FULL TENSILE CAPACITY OF THE BAR. FOR 15M (#4) BARS MINIMUM LAP OF 610mm (24").

6 EXTERIOR / INTERIOR SLAB ON GRADE

- 6.1 FOLLOW THE GEOTECHNICAL EXPERT RECOMMENDATIONS FOR PREPARATION OF SOIL BEFORE POURING THE CONCRETE. ALL GRANULAR MATERIAL SHALL BE MOISTENED IMMEDIATELY BEFORE POURING THE CONCRETE. WATER AS NEEDED. DO NOT USE A VAPOR BARRIER.
- 6.2 NO TRUCKS ARE PERMITTED ON THE CONSTRUCTION SITE (OF THE SLAB) AFTER THE FINAL COMPACTION, EITHER BEFORE OR DURING, THE POUR.
- 6.3 SLAB TO BE MINIMUM 6" THICK, REINFORCED WITH 10m (#3) @ 300mm (12") C/C REBAR PLACED IN BOTH DIRECTIONS AT MID-HEIGHT OF THE SLAB, UNLESS OTHERWISE NOTED ON PLANS. FOR ELEVATION/PLAYNUK REQUIREMENT OF THICKENED SLAB/MANIFOLD LOCATION, REFER TO ELEVATION INSTALLATION PACKAGE FOR DETAILS.
 6.4 REFER TO CONCRETE SECTION FOR MINIMUM COMPRESSIVE STRENGTH AND AIR-ENTRAINMENT REQUIREMENTS.

6.5 FINISHING WILL BE MEDIUM BROOM.

- 6.6 CONTROL JOINTS (SAW-CUTS) TO BE LOCATED IN EACH DIRECTION, AT REGULAR INTERVALS, WITH A MAXIMUM DISTANCE OF 3 METERS (10 FEET). SHALL BE MINIMUM 3 MM (1/8") WIDE AND SHALL PENETRATE THE SLAB TO A MINIMUM DEPTH OF 1/3 OF THE THICKNESS OF THE SLAB. CONTROL JOINTS SHOULD BE DONE AS SOON AS POSSIBLE WITHOUT DAMAGING THE CONCRETE, BUT NO LATER THAN 18 HOURS AFTER POURING.
- 6.7 WHEN POSSIBLE AND TO AVOID SHRINKAGE CRACKING, HUMIDITY SHALL BE MAINTAINED FOR 7 DAYS DURING THE CURING PERIOD OF THE SLAB. WATER AND USE POLYETHYLENE CLOTH OR BAG. THE CONCRETE MUST DRY UNIFORMLY.
- 7 CONCRETE WORK IN COLD OR HOT WEATHER (MINIMUM REQUIREMENTS)
- 7.1 COLD WEATHER REQUIREMENTS APPLY WHEN THE MEAN AIR IS LESS THAN 5 DEGREES CELSIUS (40 DEGREES FAHRENHEIT).
- 7.2 GENERAL REQUIREMENTS FOR COLD WEATHER CONCRETE WORK SHALL BE AS PER ACI 306R-88; OR AS PER THE NBC'S LATEST REQUIREMENTS INCLUDING THE LATEST ISSUE OF CSA STANDARD CAN3-A23.1.
- 7.3 ALL SNOW AND ICE SHALL BE REMOVED FROM FORMS AND REBAR WITH STEAM AND COMPRESSED AIR BEFORE POURING. DO NOT USE DE-ICING SALT (CALCIUM CHLORIDE) OR ANY OTHER SALTS UNDER ANY CIRCUMSTANCES.
- 7.4 CONCRETE SHALL HAVE A MINIMUM TEMPERATURE OF 20 DEGREES CELSIUS AND A MAXIMUM TEMPERATURE OF 25 DEGREES CELSIUS WHILE POURING. IT IS THE CONTRACTOR'S RESPONSIBILITY TO ENSURE THAT THESE REQUIREMENTS ARE SATISFIED. ANY CONCRETE THAT DOES NOT CONFORM MUST BE REJECTED.
- 7.5 THE SURFACE OF POURED CONCRETE SHALL BE PROTECTED BY MEANS OF SUITABLE COVERINGS AND INSULATION (TO BE DETERMINED BY TEMPERATURE) DURING THE CURING PROCESS.
- 7.6 GENERAL REQUIREMENTS FOR HOT WEATHER CONCRETE WORK SHALL BE AS PER ACI 305R-99; OR AS PER LOCAL CODE REQUIREMENTS.
- 8 PIPING
- 8.1 WDS CONFIGURATION ARE SCHEMATIC AND MAY BE MOVED OR ADJUSTED ON SITE BY VORTEX CERTIFIED INSTALLER TO ADJUST FOR SITE CONDITIONS
- 8.2 ANY REQUIRED BACKFLOW PREVENTER AND WATER METER ON THE CITY WATER MAIN SHALL BE PROVIDED BY OTHER. PRESSURE REGULATOR WILL BE PROVIDED BY
- 8.3 ALL PIPE LINES TO FEATURES TO HAVE A 1% MINIMUM RECOMMENDED SLOPE
- 8.4 ALL LINE SIZING (FEATURE CONNECTION TABLE) ASSUMES A MAXIMUM DISTANCE OF 100 FEET BETWEEN THE WATER DISTRIBUTION MANIFOLD AND THE FURTHEST PLAY PRODUCT. DISTANCES ABOVE 100 FEET MAY REQUIRE AN INCREASE IN LINE SIZING. PLEASE CONTACT VORTEX.
- 8.5 QUANTITY AND LOCATION OF DRAINS BASED ON MAXIMUM FLOW FOR THE INDICATED PIPE DIAMETER AT 1% SLOPE. MODIFICATIONS MAY BE REQUIRED DUE TO SPECIFIC SITE CONDITIONS AND LOCAL CODE.
- 8.6 PRESSURE LINES ARE RECOMMENDED TO BE SCHEDULE 80 PVC OR PEX, AND NON-PRESSURE LINES TO BE SCHEDULE 40, UNLESS OTHERWISE REQUESTED BY LOCAL
- 8.7 DRAINAGE LINES ARE RECOMMENDED TO BE SDR 35, UNLESS OTHERWISE REQUESTED BY LOCAL CODE.
- 8.8 PIPING SHOULD BE INSPECTED AFTER TRANSPORTATION FOR CUTS, SCRATCHES, GOUGES OR SPLITS; DAMAGED SECTIONS MUST BE DISCARDED OR CUT OUT.
- 8.9 PIPE SHALL BE INSTALLED BELOW THE FROST LEVEL NOT LESS THAN 12" (ASTM F-645) UNLESS OTHERWISE REQUESTED BY LOCAL CODE.
- 8.10 PIPE INSTALLATION MINIMUM COVER SHOULD BE EVALUATED ACCORDING TO ASTM D-2774, UNLESS OTHERWISE REQUESTED BY LOCAL CODE.
- 8.11 SPECIAL CONSIDERATIONS SHOULD BE TAKEN FOR THERMAL CONDITIONS, EXPANSION AND CONTRACTIONS DUE TO TEMPERATURE SHOULD BE EVALUATED BEFORE THE INSTALLATION BY THE CONTRACTOR.
- 8.12 VALVE NUMBER 1 IS LOCATED TO THE LEFT OF THE MANIFOLD FACING THE
- 8.13 MINIMUM 50 PSI REQUIRED AT THE INLET OF THE BACKFLOW PREVENTER AND
- PRESSURE REGULATING DEVICE.
 8.14 MAXIMUM FLOW CAPACITY OF MANIFOLD IS 72 GPM.

8.15 TOTAL FLOW OF FEATURE IS 78 GPM.

8.16 FACTORY MAXIMUM SEQUENCING FLOW IS 50 GPM ACTUAL FLOW MAY VARY DUE TO SITE CONDITIONS.

9 ELECTRICAL

- 9.1 EQUIPMENT BONDING; FEATURES SHALL BE CONNECTED TO AN EQUIPOTENTIAL BONDING GRID WITH A SOLID RIGID COPPER CONDUCTOR, THE MINIMUM SIZE OF BONDING CONDUCTORS NOT BE SMALLER THAN #6 AMERICAN WIRE GAUGE (AWG) (16mm²) COPPER. BOND TO ALL METALLIC PARTS LOCATED IN THE SPLASHPAD/POOL AND TO THE REBAR, TO RUN CONTINUOUS TO THE WATER PUMP AND ELECTRICAL SUPPLY PANELS. SEE ELEVATION INSTALLATION DRAWING FOR BONDING DETAILS (BY OTHER).SPRAYLINKS FEATURE DO NOT REQUIRE BONDING.
- 9.2 <u>GRID STRUCTURE</u>; THE EQUIPOTENTIAL BONDING GRID SHALL COVER THE CONTOUR OF THE WATER BODY AREA AND ANY DECK EXTENDING 3FT (1m). HORIZONTALLY FROM THE INSIDE WALLS OF THE SPLASHPAD/WATER BODY. THE EQUIPOTENTIAL BONDING GRID SHALL BE ARRANGED IN A 12 IN (300mm). BY 12 IN (300mm). NETWORK OF CONDUCTORS IN A UNIFORMLY SPACED PERPENDICULAR GRID PATTERN WITH TOLERANCE OF 4 IN (100mm). A J-JUNCTION BOND CLAMP (DIRECT BURIAL CERTIFIED) CLAMPED TO A REBAR WITH WIRE LOOPED THROUGH CONNECTOR AND CLAMPED TO STEEL AND TO THE SPLASHPAD/POOL PUMP WATER.
- 9.3 ALL ELECTRICAL EQUIPMENT SHALL BE GROUNDED; THE FOLLOWING EQUIPMENT SHALL BE GROUNDED. ALL ELECTRICAL EQUIPMENT LOCATED WITHIN 5FT (1.5 m) OF THE INSIDE WALL OF THE SPECIFIED BODY OF WATER." THIS EQUIPMENT ALSO INCLUDES (BUT NOT LIMITED TO): FEATURES, ELEVATIONS, DRAIN, REBAR, WATER INLET, SKIMMER, LADDER, SLIDES, DIVING STRUCTURE, UNDERWATER LIGHTING, JUNCTION BOXES, AND WATER CIRCULATING/HEATING EQUIPMENT.
- ALL BONDING AND GROUNDING MUST COMPLY WITH NEC, CEC, AND LOCAL CODES.
- 9.4 <u>ALTERNATE MEANS</u>; WHERE STRUCTURAL REINFORCING STEEL IS NOT AVAILABLE OR IS ENCAPSULATED IN A NONCONDUCTIVE COMPOUND, A COPPER CONDUCTOR(S) SHALL BE UTILIZED WHERE THE FOLLOWING REQUIREMENTS ARE MET: (1) AT LEAST ONE MINIMUM 6 AWG BARE SOLID COPPER CONDUCTOR SHALL BE PROVIDED. (2) THE CONDUCTORS SHALL FOLLOW THE CONTOUR OF THE PERIMETER SURFACE. (3) ONLY LISTED SPLICES SHALL BE PERMITTED. (4) THE REQUIRED CONDUCTOR SHALL BE 450 TO 18 TO 24 IN (600mm) FROM THE INSIDE WALLS OF THE POOL. (5) THE REQUIRED CONDUCTOR SHALL BE SECURED WITHIN OR UNDER THE PERIMETER SURFACE (4 IN TO 6 IN (100mm TO 150mm). BELOW THE SUBGRADE.
- 9.5 <u>SPLASHPAD/POOL WATER</u>; WHERE NONE OF THE BONDED PARTS IS IN DIRECT CONNECTION WITH THE POOL WATER, THE POOL WATER SHALL BE IN DIRECT CONTACT WITH AN APPROVED CORROSION-RESISTANT CONDUCTIVE SURFACE THAT EXPOSED NOT LESS THAN 9 IN.2 (5800mm²) OF SURFACE AREA TO THE POOL WATER AT ALL TIMES. THE CONDUCTIVE SURFACE SHALL BE LOCATED WHERE IT IS NOT EXPOSED TO PHYSICAL DAMAGE OR DISLODGEMENT DURING USUAL POOL ACTIVITIES, AND IT SHALL BE BONDED IN ACCORDANCE WITH NEC, CEC, AND LOCAL CODES.
- 9.6 WIRING FROM THE CONTROLLER TO EACH ACTIVATOR SHALL BE #22 AWG. A TOTAL OF TWO (2) CONDUCTORS PER ACTIVATOR.CABLE LENGTH UP TO 300' (100m), PROVIDED BY OTHER.





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Abbreviations

9.7 ALL CONNECTIONS TO THE CONTROLLER AND OTHER VORTEX ELECTRICAL PANEL

SHALL BE PERFORMED USING AN APPROVED NEMA 4X CONNECTOR.

9.8 WIRE FROM MAIN POWER TO VORTEX PANEL TO BE DETERMINED BY OTHERS RESPECTING THE LOCAL CODE.

9.9 MAINTAIN A MINIMUM CLEARANCE ZONE OF 36" IN FRONT OF ELECTRICAL PANEL, UNLESS OTHERWISE REQUESTED BY LOCAL CODE.

9.10 AS PER ELECTRICAL CONSTRUCTION AND SAFETY CODES: CONTROLLER AND ANY OTHER ELECTRICAL ENCLOSURES MUST BE HARD-WIRED TO A GROUND FAULT CIRCUIT INTERRUPTER (GFCI) FROM THE INPUT POWER SOURCE.

9.11 ALL ELECTRICAL WORK SHOULD BE PERFORMED BY A LICENCE ELECTRICIAN IN

ACCORDANCE TO LOCAL ELECTRICAL CONSTRUCTION AND SAFETY CODES.

9.12 THE MAESTROPRO CONTROL PANEL IS POWERED THROUGH A MAESTROPRO POWER BOX.

9.13 THE POWER CABLE TO MAESTROPRO POWER BOX IS SUPPLIED BY OTHER.


9.14 THE MAESTROPRO CONTROL PANEL INTEGRATES 24 DIGITAL OUTPUTS WITH 24 VAC AND 12 DIGITAL INPUTS.


9.15 FOR REMOTE ACCESS ABILITY, A HARD CONNECTION TO AN EXISTING NETWORK

IS REQUIRED USING A CAT 5 CABLE OR A CELLULAR NANO-SIM CARD WITH DATA-PLAN. 9.16
IT IS THE CUSTOMER/INSTALLER RESPONSIBILITY TO MAKE THE FIELD INSTALLATION

IT IS THE CUSTOMER/INSTALLER RESPONSIBILITY TO MAKE THE FIELD INSTALLATION	
NEMA 4 COMPLIANT - THE INSTALLATION MUST COMPLY WITH LOCAL ELECTRICAL CODE REQUIREMENTS AND BE APPROVED BY LOCAL ELECTRICAL INSPECTION AUTHORITIES.	
CONTROLLER AND/OR CONTROL PANEL NOT TO BE INSTALLED IN DIRECT SUNLIGHT.	

			7.55.51.65.5		
			Α	Architectural	
			С	Civil Work	
			Р	Plumbing Layout	
Drawing #	Drawing Name	Rev#	PD	Plumbing Details	
PE-001	Plumbing & Electrical Layout	00	Е	Electrical Layout	
	Layout		ED	Electrical Details	
E-003	Bonding Layout	00	FT	Feature Drawings	
<u>'</u>	<u> </u>				

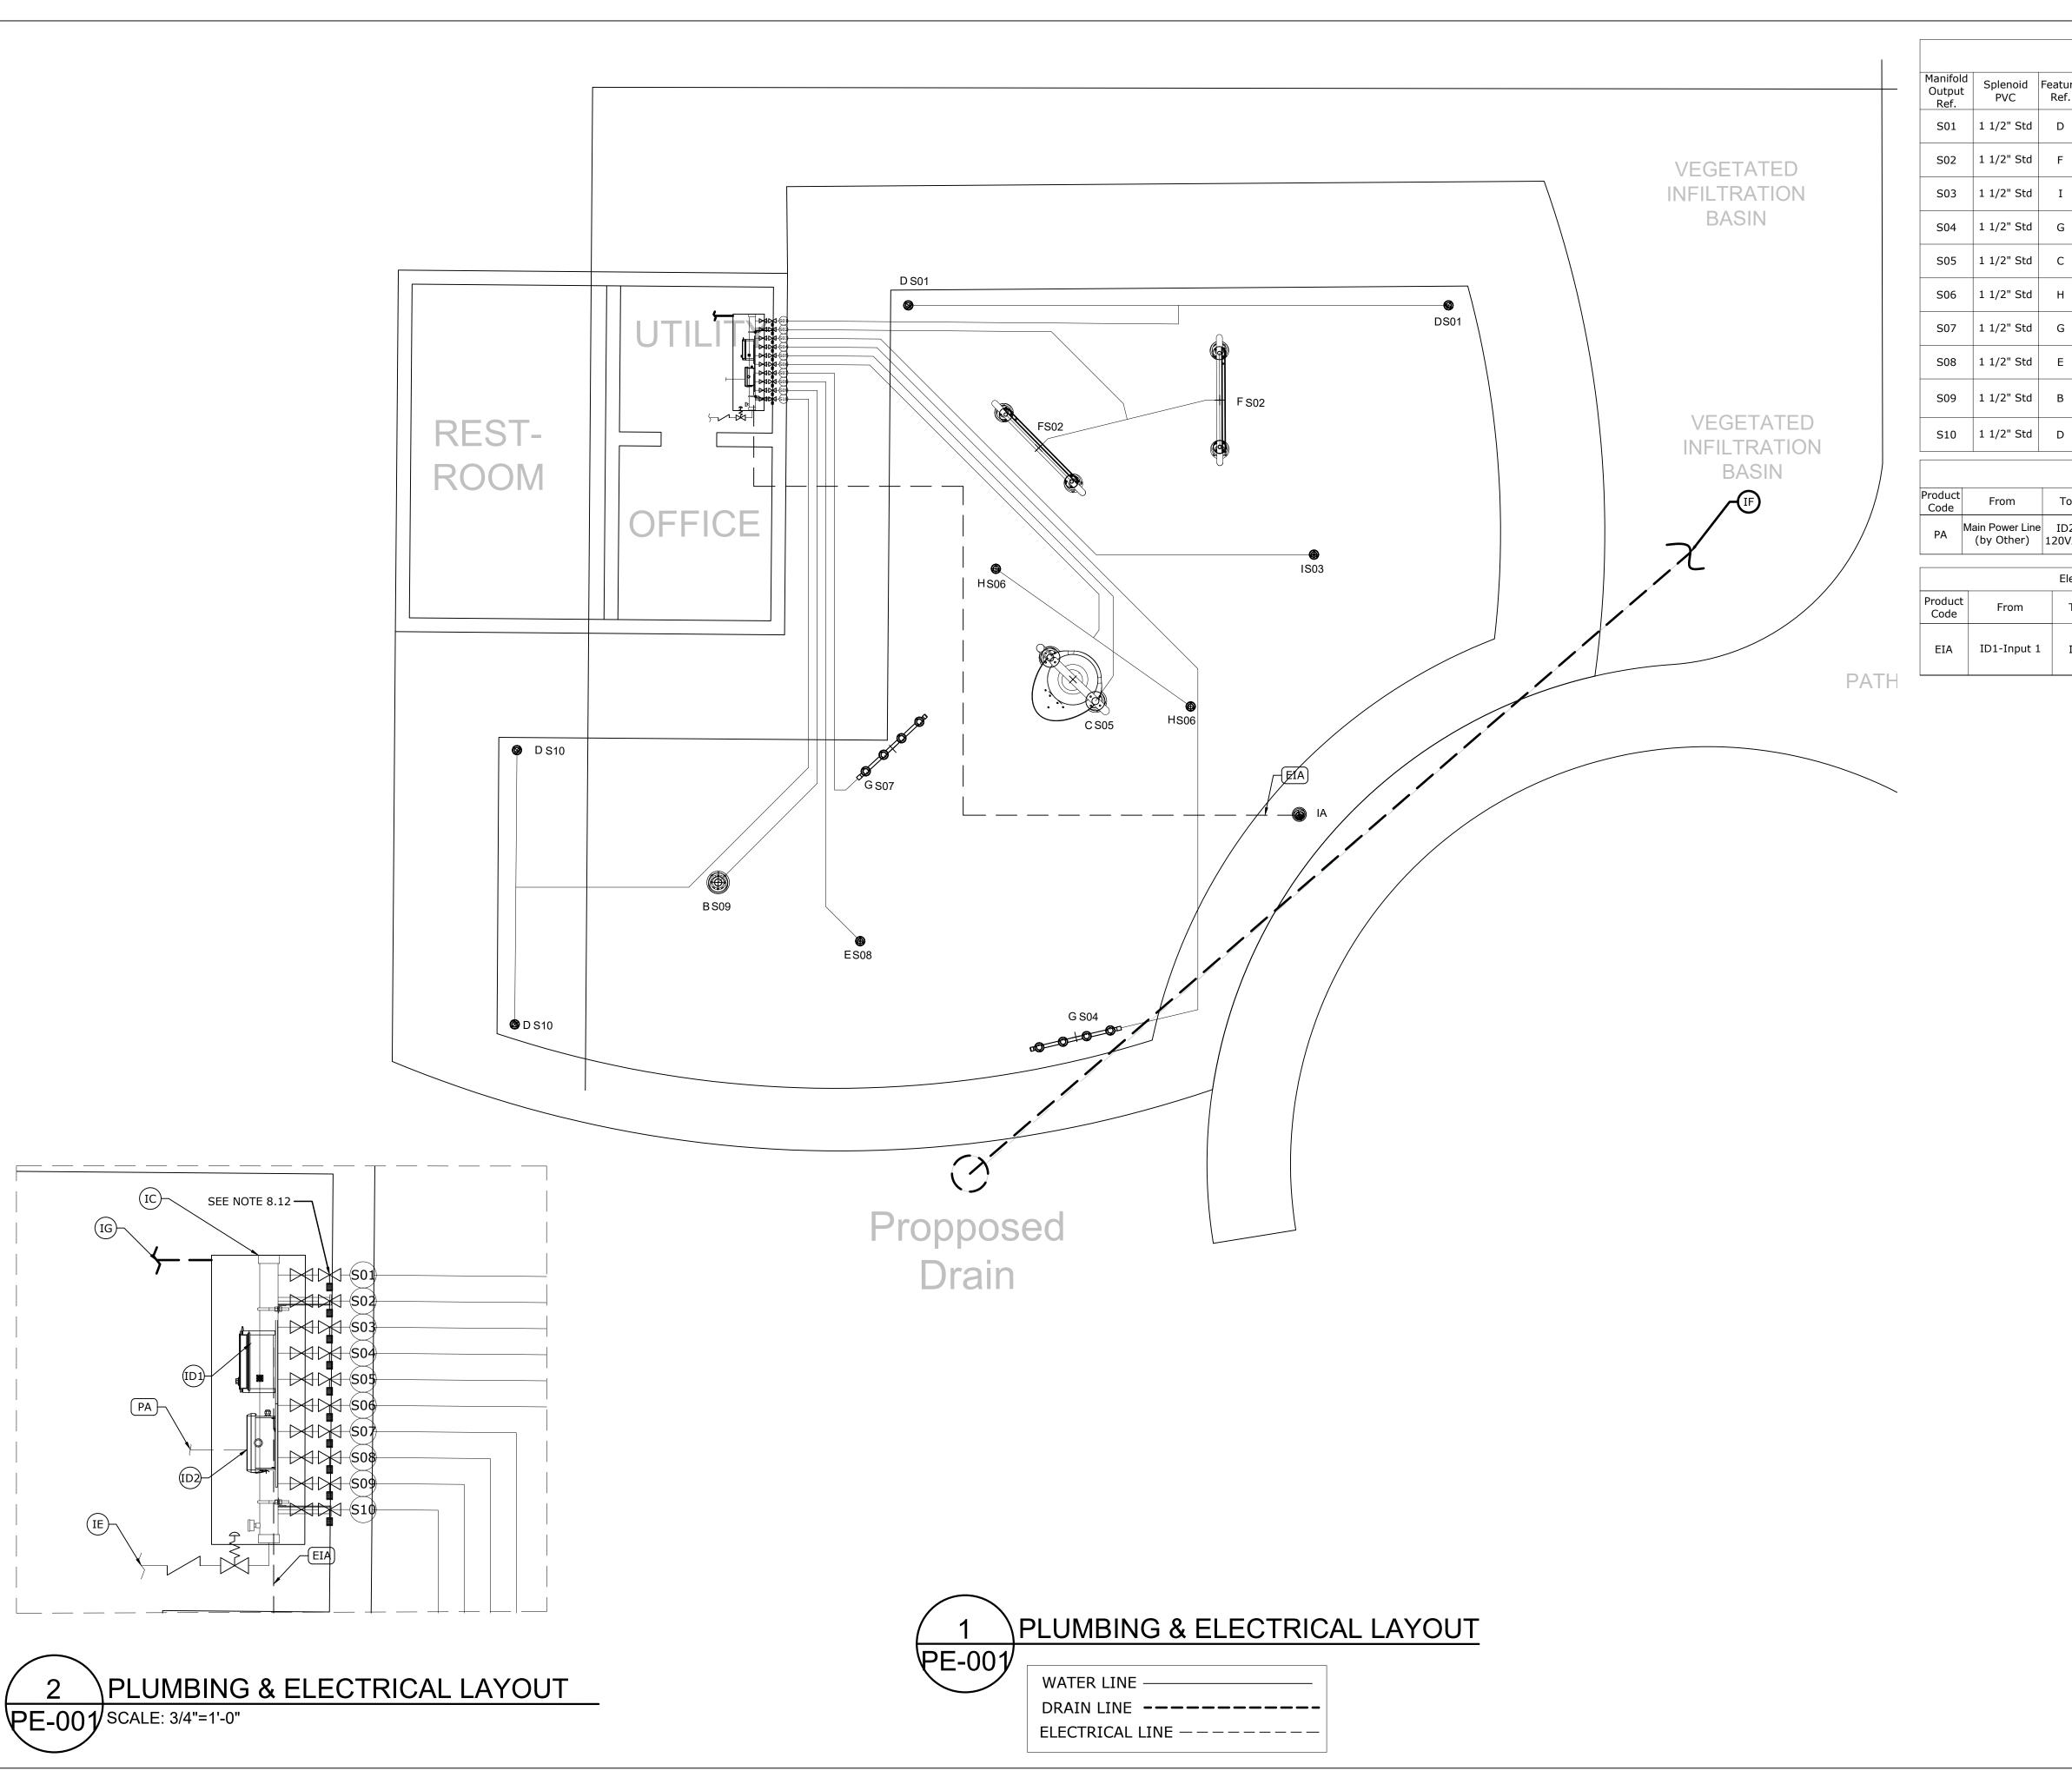

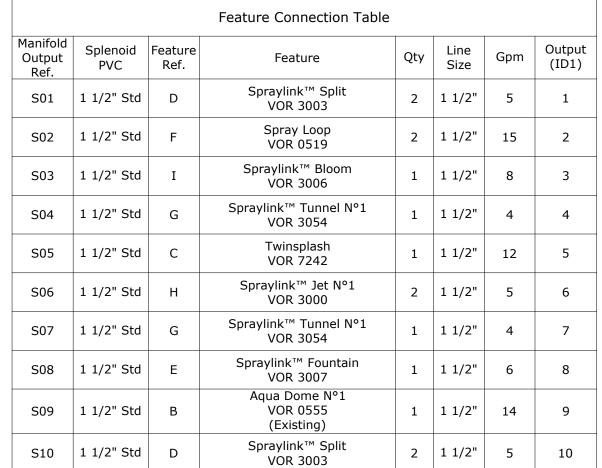

Electrical Line Connections Power					
Product Code	From	То	# Conductors	Gauge/Type	Note
PA	Main Power Line (by Other)	ID2 120VAC	3	TBD (by Other)	120V, 1 Phase, 60Hz, 10Amps Breaker Recommended ± 5% Voltage Drop is Acceptable

Electrical Line Connections Controller Inputs					
Product From To # Conductors		Gauge/ Type	Note		
EIA	ID1-Input 1	IA	2	22	Activator No 4 24 VDC, Max 350 mA, Max 300' (100m) Long (by Other)

	Product Legend	
Product Ref.	Product	Qty
IA	Activator N°4 VOR 0622	1
IB	Drain (By Other)	1
IC	Water Distribution System 1.0 Wall Mounted Manifold Command Center	1
ID1	MaestroPRO Controller 24 out/ 12 in VOR-33907.3200	1
ID2	MaestroPRO Power Box VOR-33907.3200	1
IE	2" City Water Line (by Other)	1
IF	Drain Line to Municipal Drain (by Other)	1
IG	4" TYP Drain Line With Strainer Connected to Drainage System. Ensure P-Trap is Below Frost Line to Prevent Freezing. (by Other)	1
__\	2" Pressure Regulator (by Vortex)	1
	2" Backflow Preventer (by Other)	1
X- X	1 1/2" Solenoid Valve with Ball Valve (by Vortex)	10



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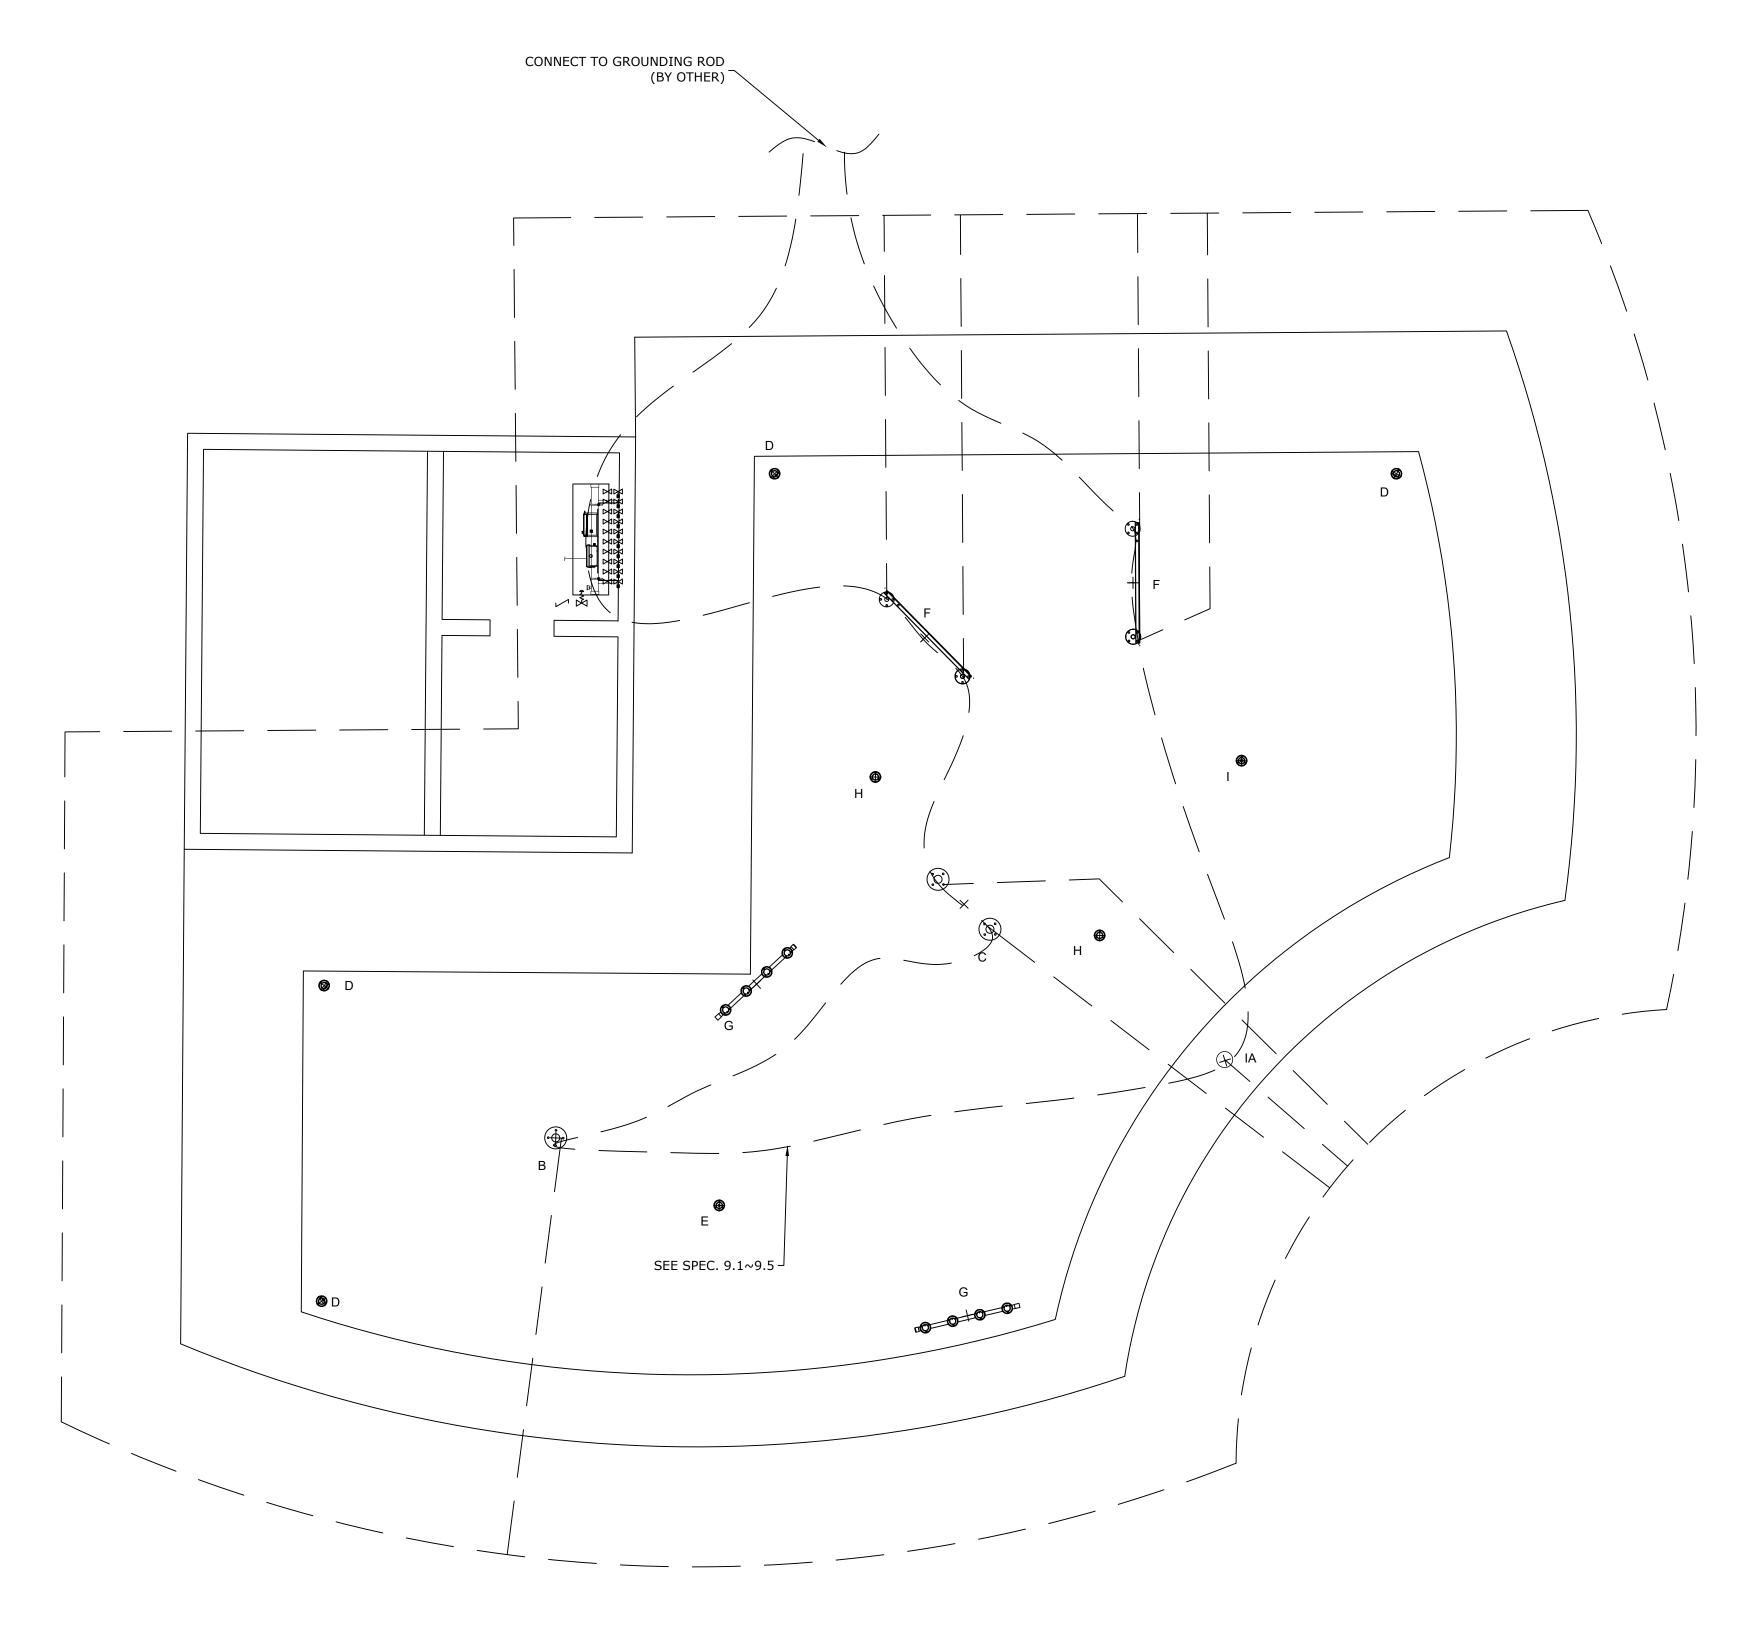
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Page # PE-001

REF	PRODUCT	QTY
IA	Activator N°4 VOR 0622	1
В	Aqua Dome N°1 VOR 0555 (Existing)	1
С	Twinsplash VOR 7242	1
D	Spraylink™ Split VOR 3003	4
E	Spraylink™ Fountain VOR 3007	1
F	Spray Loop VOR 0519	2
G	Spraylink™ Tunnel N°1 VOR 3054	2
Н	Spraylink™ Jet N°1 VOR 3000	2
I	Spraylink™ Bloom VOR 3006	1





BONDING WIRE ----



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Page # E-003

SECTION 32 33 00

SITE FURNISHINGS

PART 1 GENERAL

1.1 RELATED DOCUMENTS

A. Drawings and general provisions of the Contract, including General and Supplementary Conditions and Division 01 Specification Sections, apply to this Section.

1.2 SUMMARY

- A. Section Includes:
 - 1. Seating.
 - 2. Tables.
 - 3. Trash receptacles.

1.3 ACTION SUBMITTALS

A. Manufacturer's Literature: Submit copies of each of manufacturer's material descriptions, dimensions, details, and installation instructions for the following. Submit manufacturer's material descriptions for primer coat and finish coat.

1.4 INFORMATIONAL SUBMITTALS

- A. Complete Shop Drawings for the installation of 6' bench with back.
- B. Complete Shop Drawings for the installation of 6' backless bench.
- C. Complete Shop Drawings for the installation of 8' ADA picnic table with benches.
- D. Complete Shop Drawings for the installation of 6' picnic table with benches.
- E. Complete Shop Drawings for the installation of trash receptacle with metal hood.

1.5 CLOSEOUT SUBMITTALS

- A. Maintenance Data: For site furnishings to include in maintenance manuals.
- B. The Contractor shall furnish and deliver standard written manufacturer's guarantee in Owner's name covering all materials and workmanship under this Section 323300, Site

Furnishings, in addition to, and not in lieu of, guarantee requirements set forth under Section 010000, GENERAL REQUIREMENTS, and other liabilities which the Contractor may have by law or other provisions of the Contract Documents.

- C. Supplier shall pay for repairs of any damage to any part of the project caused by defects in his work and for any repair to the materials or equipment caused by replacement. All repairs are to be done to the satisfaction of the Owner's Representative.
- D. Any part of the work installed under this contract requiring excessive maintenance shall be considered as being defective, and shall be replaced by the Supplier during the one year guarantee period at no cost to the Owner.

PART 2 PRODUCTS

2.1 SEATING

- A. 72" long Bench with Backrest, Thermally Modified Red Oak wood slats with black supports, (model #34-60TMR) as manufactured by Dumor, Inc P.O. Box 142 Mifflintown, PA 17059 or approved equal.
 - 1. Surface mount (S-2)
 - 2. Inground mount (S-1)
- B. 72" long Backless Bench, Thermally Modified Red Oak wood slats with black supports, (model #6B-115) as manufactured by Dumor, Inc P.O. Box 142 Mifflintown, PA 17059 or approved equal.
 - 1. Surface mount (S-2)
 - 2. Inground mount (S-1)
- C. 72" long TenderTuff Player's Backless Bench, (model # 141683D) as manufactured by Landscape Structures, 601 7th Street South, Delano, MN 55328, https://www.playlsi.com/en/commercial-playground-equipment/playground-components/ tendertuff-bench/ or approved equal.

2.2 TABLES

- A. 8' long ADA Picnic Table, surface mount, Thermally Modified Red Oak wood slats with Black supports, (model #67-079-68-1) as manufactured by DuMor, Inc., P.O. Box 142, Mifflintown, PA 17059 800.598.4018, or approved equal.
- B. 6' long Picnic Table, surface mount, Thermally Modified Red Oak wood slats with Black supports (model 67-079-6) as manufactured by DuMor, Inc. P.O. Box 142, Mifflintown, PA 17059 800.598.018 or approved equal.

2.3 SHADE

2.4 TRASH RECEPTACLES

A. 26-1/2"OD x 36"H, Perforated, black thermo-plastic coated round steel Trash Receptacle (Model #CN-R/R-55) with Dome Lid (CN), heavy duty rigid Plastic Liner (CN/B) and Cable Kit (CK-5), surface mount on concrete pad, as manufactured by Pilot Rock, or approved equal.

2.5 FABRICATION

A. Factory Assembly: Factory assemble components to greatest extent possible to minimize field assembly. Clearly mark units for assembly in the field.

2.6 GENERAL FINISH REQUIREMENTS

A. Appearance of Finished Work: Noticeable variations in same piece are unacceptable.

Variations in appearance of adjoining components are acceptable if they are within the range of approved Samples and are assembled or installed to minimize contrast.

PART 3 EXECUTION

3.1 EXAMINATION

- A. Examine areas and conditions, with Installer present, for compliance with requirements for correct and level finished grade, mounting surfaces, installation tolerances, and other conditions affecting performance of the Work.
- B. Proceed with installation only after unsatisfactory conditions have been corrected.

3.2 INSTALLATION

- A. Comply with manufacturer's written installation instructions unless more stringent requirements are indicated. Complete field assembly of site furnishings where required.
- B. All metal inserts, anchor slots, anchors, anchor bolts, fastenings, and other fastening devices, for attachment of site improvement items to pavements, except as otherwise specified under other Sections of this Specification, shall be in specified, provided, delivered installed and paid for under the work of this Section 02800, Site Furnishings.
- C. Unless otherwise indicated, install site furnishings after landscaping and paving have been completed.
- D. Free-standing site improvement items shall be set plumb and horizontal regardless of the pitch of the finished surrounding grade unless otherwise shown on the Contract Documents.
- E. The Contractor shall be responsible for timing the delivery of site improvement items so as to minimize the on-site storage time prior to installation. All stored materials are the

responsibility of the Contractor and shall be protected from weather, careless handling and vandalism.

- F. Contractor shall be responsible for the correct location of site improvement items. Take particular care to maintain shapes, plumb and level during the pouring of concrete.
- G. All Work shall be accurately set to established lines and elevations and rigidly set in place to supporting construction.
- H. Install site furnishings level, plumb, true, and positionedat locations after final aproval in the field by Owner's Representative.
- I. Post Setting: Set cast-in support posts in concrete footing with smooth top, shaped to shed water. Protect portion of posts above footing from concrete splatter. Verify that posts are set plumb or at correct angle and are aligned and at correct height and spacing. Hold posts in position during placement and finishing operations until concrete is sufficiently cured.

END OF SECTION

32 33 00 - 4

SECTION 11 68 40 SPLASHPAD PLAY EQUIPMENT

PART 1 GENERAL

1.1 RELATED DOCUMENTS

A. Drawings and general provisions of the Contract, including General and Supplementary Conditions and Division 01 Specification Sections, apply to this Section.

1.2 SUMMARY

- A. Section Includes:
 - 1. Splash pad features.
 - 2. Manifold.
- B. Related Sections:
 - 1. Section 260000 Electrical.
 - 2. Section 321313 Concrete Paving.

1.3 ACTION SUBMITTALS

A. Manufacturer's Literature: Submit copies of each of manufacturer's material descriptions, dimensions, details, and installation instructions for all products.

1.4 INFORMATIONAL SUBMITTALS

A. Manufacturer's P&E Plan (if any adjustments are made to Splash Pad layout or design after the bidding process).

1.5 CLOSEOUT SUBMITTALS

- A. Maintenance Data: For splash pad fixtures to include in maintenance manuals.
- B. The Contractor shall furnish and deliver standard written manufacturer's guarantee in Owner's name covering all materials and workmanship under this Section 116840, Splashpad Play Equipment, in addition to, and not in lieu of, guarantee requirements set forth under Section 010000, GENERAL REQUIREMENTS, and other liabilities which the Contractor may have by law or other provisions of the Contract Documents.
- C. Supplier shall pay for repairs of any damage to any part of the project caused by defects in his work and for any repair to the materials or equipment caused by replacement. All repairs are to be done to the satisfaction of the Owner's Representative.

D. Any part of the work installed under this contract requiring excessive maintenance shall be considered as being defective, and shall be replaced by the Supplier during the one year guarantee period at no cost to the Owner.

PART 2 PRODUCTS

2.1 SPLASH PAD FEATURES

- A. Activator N°4, VOR 0622
- B. Aqua Dome N°1, VOR 0555 (Deliver & Install)
- C. Spraylink™ Split, VOR 3003
- D. Spraylink™ Fountain, VOR 3007
- E. Spray Loop, VOR 0519
- F. Spraylink™ Tunnel N°1, VOR 3054
- G. Spraylink™ Jet N°1, VOR 3000
- H. Spraylink™ Bloom, VOR 3006
- I. Twinsplash, VOR 7242

2.2 SPLASH PAD MANIFOLD & ACCESSORIES

- A. Water Distribution System WCC 2.0 Wall-Mounted Command Center
- B. MaestroPRO Controller 24 out/ 12 in, Model # VOR-33907.3200
- C. MaestroPRO Power Box, Model # VOR-33907.3200
- D. 2" Pressure Regulator
- E. 1" Solenoid Valve with Ball Valve & Union

2.3 PRODUCT CONSTRUCTION

- A. The aquatic play products shall be suitable for installation in municipal and commercial aquatic facilities and public play areas.
- B. Products shall be specifically designed for use by children and adults and follow the ASTM F2461-09 norm. In addition, products shall be manufactured by a company that has at least five (5) years of experience in the design and engineering of children's aquatic play areas.

- C. Any aquatic play product belonging to a new product line or series should demonstrate meeting the effective norm or show the conformity and resistance of the prescribed materials if it is proposed equivalency. The contractor or manufacturer must demonstrate meeting specifications by providing technical documents and drawings to be included in their bid proposal.
- D. Play Products: All aquatic play products installed above and below grade shall be manufactured from 304/304L stainless steel. The anchoring system and associated fastening hardware shall be manufactured from 304/304L stainless steel. Rigid centricast fiber reinforced (FRP) and/or molded fiberglass, PVC, filament wound tubing, Galvanized Steel, or Aluminum shall not be utilized for any above or below grade play product structures.
- E. Mounting and Assembly Hardware: All hardware and anchoring systems shall be 304/304L stainless steel. All Play Products and Ground Spay systems shall include an integrated anchoring and leveling system facilitating installation and a flush surface finish. Exposed and accessible hardware shall be tamper resistant, requiring a special tool for removal to deter
- F. Spray nozzles, caps and heads: Shall be manufactured from C360 brass and shall use tamper resistant tools for installation and removal. PVC, Nylon, and Delrin ™, shall not be utilized. All grade level play products are to be furnished with appropriate winterization caps.
- G. Polished Finish: All stainless steel above ground features shall have a high-luster polished finish.
- H. Material for Paneling, Signage, Water Deflection, and Toe Guards: All Polyethylene, Polyurethane, Elastomers, and Seeflow Polymers used for paneling, signage or water deflection shall be resistant to chlorinated water and be ultraviolet stabilized to inhibit sunlight fading.
- I. Safety & Craftsmanship: All accessible edges shall be machined to a rounded finish. All welds shall be watertight, buffed smooth, or polished to a non-visible finish and factory pressure tested. Accessible nozzles and spray heads shall be recessed to ensure a completely safe play environment with no pinch points, head entrapments or protrusion hazards. All products shall be designed in accordance with ASTM F1487, ASTM F-2461 and CSA Z614-98 regulations for public playgrounds.
- J. Lexan Polymer: The Lexan Polymer shall be specially selected for aquatic play products and shall have the following characteristics: translucent, highly resistant to shock and impact, vandalism and must be non-flammable. The polymer shall present dimensional stability a high resistance towards chemical products, ultra violets rays and be transparent presenting crystal clear surface throughout.
- K. H. Seeflow Polymer: The Seeflow Polymer shall be specially selected for aquatic play products and shall have the following characteristics: translucent, highly resistant to shock and impact, vandalism and must be non-flammable. The polymer shall present dimensional stability a high resistance towards chemical products, ultra violets rays and be transparent presenting crystal clear surface throughout.

PART 3 EXECUTION

3.1 EXECUTION

- A. Should the bidder wish to substitute products other than the products specified herein, the bidder shall list products and submit a written Substitution Form of Proposal at least 10 calendar days prior to the date of receipt of bids. The bidder shall submit specifications, cut sheets, and performance data, along with an itemization listing each and every deviation from the specifications herein.
- B. The manufacturer shall furnish the purchaser with at least two sets of complete installation and operating manuals. The installation manual will illustrate the installation of the entire system. It shall describe the start-up procedure and day- to- day operation of the system.

3.2 PLAY PRODUCT INSTALLATION

- A. When applicable, templates shall be supplied to facilitate the installation of embedded anchoring equipment.
- B. All play products shall have electrical grounding studs incorporated into their associated anchoring equipment. All play products shall be grounded by the installer per local codes.
- C. All installation conduit wiring including electrical supply panel, PVC connections, piping, elbows, tees, play product assembly if required and other items relating to the installation shall be supplied by the general contractor.
- D. Drawings and Instructions: Product drawings and installation manuals shall be supplied by the manufacturer for ease of installation.

3.3 PRODUCT DELIVERY, STORAGE AND HANDLING

- A. All aquatic play products and associated equipment must be properly wrapped and secured in place while in transport to the project site. Care shall be observed during offloading and handling to prevent excessive stress and abrasions.
- B. At the site, the play products and associated equipment are to be stored in safe areas, out of the way of traffic and other construction activities, until the actual time of installation. If required, safety barricades or other like precautions must be taken for the protection of public and adjacent property.
- C. Protective wrapping on the aquatic play features must be left in place until construction work for the Splashpad is complete.

3.4 COMMISSIONING OF THE SPLASHPAD

A. Upon completion of construction, the general contractor shall provide the owner/operator

adequate training on facility operations and maintenance. The contractor may request that the equipment manufacturer and/or manufacturer's representative provide on-site start-up and training for the owner/operator.

3.5 SPLASHPAD QUALITY ASSURANCE

- A. Provide evidence of commitment of quality craftsmanship as demonstrated by the following manufacturer qualifications:
- B. The products shall be designed and produced at a facility owned and directly supervised by the supplier.
- C. All products shall be shipped from a single source.
- D. A full time licensed engineer must be on-staff.
- A full time quality control manager must be on-staff.

3.6 EQUIVALENCIES CLAUSES

- A. To enable all bids to be judged equitably, they shall be based on the specified products in this document and shown on the drawings.
- B. A. The proposal for any substitute products must be attached to the bid separately, identifying the substitute product by its trade name along with any savings it may represent for the client.
- C. B. Following the opening of the bid, only those substitutes proposed by the lowest bidder of the specified products, will be considered.
- D. C. All substitute approval requests shall be accompanied by manufacturing drawings, including spray zones, sequencing, plumbing and electrical schematics and complete salt spray resisting testing data produced by an independent laboratory for coatings and a written warranty from the manufacturer.
- E. No substitution or equivalency submitted will be considered if products to be considered are not part of manufacturer standard existing product line or a written proof that product has manufactured previously by the substitute manufacturer. Please refer to General Clauses 1.1.
- F. D. Each substitute sample must be presented to the owner/consultant within seven days following the opening of bids. The sample must be completely operational. After this time period, the bidder will be required to supply the original specified product.
- G. E. The owner/consultant reserves the right to grant or deny approval for proposed substitutions without prejudice to his rights and his decision shall be final. The above conditions apply to this section independently of any other clauses on the subject found in this document.

H. F. If applicable the products must be interchangeable and of equivalent quality to the materials already installed.

3.7 SPLASHPAD EQUIPMENT WARRANTIES

- A. Minimum Warranty periods.
- B. Splashpad Play Events/Products & Skid Mounted Water Quality Management System Equipment.
- C. A 25 Year Warranty on stainless steel Play Events/Products, stainless steel anchoring systems and aluminum spheres.
- D. A 10 Year Warranty on the reinforced fiberglass skid, sand filter fiberglass tank and cartridge filter fiberglass tank.
- E. A 5 Year Warranty on brass components including; spray nozzles, spray caps and spray heads. High-density polyethylene components, polyurethane components, and ultra high molecular weight polyethylene components. The Subterranean vault (enclosure and access hatches), stainless steel automated water distribution manifold, drain boxes, strainers, electrical enclosures, and chemical controllers.
- F. A 2 Year Warranty on color coatings, stainless steel hardware & moving parts, fiberglass products, Seeflow Polymers, Soft Touch Elastomers (Toe Guards), subterranean water containments system, circulation pumps, chemical injection pumps, chlorinator systems, acid feed systems, polyvinyl chloride (PVC); piping, fittings, ball valves, check valves, cartridge elements, pressure gauges, chemical sensing probes, motor starters, electrical relays, terminal blocks, actuated valves, programmable logic controller (PLC controller), time switches, manual switches, transformers, breakers, electrical wiring and connections.
- G. All warranties are to be managed by the equipment supplier.

END OF SECTION