DDRC CONCEPTUAL AND FINAL APPROVAL ISSUED FOR DDRC REVIEW 10/8/25 SCHEDULE OF DRAWINGS

	ARCHIT	ECTURAL	ISSUED FOR DDRC REVIEW
1	A-000.00	COVER SHEET AND DRAWING SCHEDULE	10/8/25
2	Z-100.00	SITE PLAN AND ZONING INFORMATION	10/8/25
3	Z-101.00	ZONING COMPLIANT DIAGRAMS	10/8/25
4	Z-102.00	ZONING COMPLIANT DIAGRAMS	10/8/25
5	Z-103 00	ZONING COMPLIANT DIAGRAMS	10/8/25
6	Z-104.00	ZONING COMPLIANT DIAGRAMS	10/8/25
7	Z-105 00	ZONING COMPLIANT DIAGRAMS	10/8/25
8	Z-106.00	ZONING COMPLIANT DIAGRAMS	10/8/25
9	A-100 00	CELLAR FLOOR PLAN	10/8/25
10	A-101.00	1ST FLOOR PLAN	10/8/25
11	A-102.00	2ND FLOOR PLAN	10/8/25
12	A-103.00	3RD FLOOR PLAN	10/8/25
13	A-104.00	4TH-6TH FLOOR PLAN	10/8/25
14	A-105.00	7TH FLOOR PLAN	10/8/25
15	A-106.00	8TH-12TH FLOOR PLAN	10/8/25
16	A-107.00	ROOF FLOOR PLAN	10/8/25
17	A-300.00	SOUTH ELEVATION	10/8/25
18	A-301.00	NORTH ELEVATION	10/8/25
19	A-302.00	WEST ELEVATION	10/8/25
20	A-303.00	EAST ELEVATION	10/8/25
21	A-400.00	BUILDING SECTION	10/8/25
22	A-600.00	STOREFRONT AND SIGNAGE DETAILS	10/8/25
23	A-800.00	PROPOSED COLORWAY AND MATERIALS	10/8/25
24	A-900.00	RENDERINGS	10/8/25
25	A-901.00	RENDERINGS	10/8/25
26	A-902.00	SITE PHOTOS	10/8/25

3D MASSING CONTEXT MODEL



TAX MAP - PLAT #24

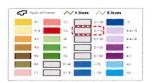


Property	Lot Number	Lot Area (S.F.)	Lot Frontage (B Street)	
139 Friendship St*	518	4,033 S.F.		50 Ft.
143 Friendship St	519	3.009 S.F.		31.50 Ft.
149 Friendship St	520	5,350 S.F.		56 Ft.
151 Friendship St	521	3.153 S.F.		33 Ft.
194 Pine St.	509	4,281 S.F		45 Ft.
Combined Lot Area:		19.826 S.F		170.5 Ft. (Friendship) & 45 Ft. (Pine)

*10' right of way - Deed Book 71, Page 236

ZONING MAP - BASE MAP





BASE ZONING:

D-1 Downtown District

Sub-District : D-1-120 = Max Building Height of 120 feet*
"Without Bonus Eligability

ZONING MAP - OVERLAY





OVERLAY ZONING:

I-3E: Educational Institutional Overlay

137-151 FRIENDSHIP ST. AND 194 PINE ST. PROVIDENCE

CLIENT

Friendship Partners, LLC 155 Chestnut Street Providence, RI 02903

ARCHITECT

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MEP ENGINEER


Wozny Barbar & Associates 1076 Washington Street Hanover, MA 02339 New York, NY 10001 Phone: 781-826-4144

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Sheet No: 01 of 26



(A) 12 WIDE PURISH STREET) (A) 13 WIDE PURISH STREET (A) 13 WIDE PURISH STREET (A) 13 WIDE PURISH STREET (A) 1

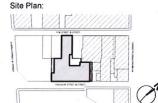170'-5"

GRADE PLANE CALCULATION

20.20' + 13.43' + 18.0' + 16.98' = 68.61' / 4 = 17.15' DATUM

FLOOR AREA AND UNIT MIX SCHEDULE

Floor	Use	Floor to Floor Height	Cumulative Height (ft) Above Grade Plane	Gross Buildable Area (including Balconies) Per Floor (sf)
Cellar	Mechanical, BOH Areas, Storages, and Amenities	12-0	-	8,647
-	Coffee Shop	130"		1,075
	Residential Lobby, Amenities, and BOH Areas		10'-9"	13,245
1	Residential			1,384
	Retail at Pine Street (1st-2nd floor)	20'-5"		978
	Loading Dock at Pine Street (1st-2nd floor)	22.9		800
2	Residential	9.9	20'-6"	14,229
3	Residential	3.9	303.	16,168
4	Residential	3.9	40'-0"	16,204
5	Residential	3.9	49'-9"	16,208
6	Residential	10-6	603.	16,204
7	Residential	9-9*	70'-0"	14,190
8	Residential	3-9.	79'-9"	14,442
9	Residential	3.9	89-5"	14,362
10	Residential	9-9*	99'-3"	14,442
11	Residential	3-9*	109-0"	14,362
12	Residential	11'-0"	120'-0"	14,442
Roof	Buikheads, Green House, and Pool Roof Deck	-	-	5,317
IATOT	All Uses	•		196,699

	UNIT MIX SCHEDULE							
Floor	Studios	Jr 1 Bedroom	1 Bedrooms	2 Bedrooms	Total # of Dwelling Unit			
1	2	1	0	0	3			
2	5	1	12	2	20			
3	4	1	15	2	22			
4	5	1	14	2	22			
5	5	1	14	2	22			
6	5	1	14	2	22			
7	5	1	10	3	19			
8	5	1	10	3	19			
9	5	1	10	3	19			
10	5	1	10	3	19			
11	5	1	10	3	19			
12	5	1	10	3	19			
TOTAL					225			

LOT AREA CALCULATION

Lot Number	Lot Area (S.F.)	Lot Frontage (B Street)	
518	4,033 S.F.	50 Ft.	
519	3,009 S.F.	31.50 Ft	
520	5,350 S.F.	56 Ft.	
521	3,153 S.F.	33 Ft.	
509	4,281 S.F	45 Ft	
	19,826 S.F	. 170.5 Ft. (Friendship) & 4	5 Ft. (Pine)
	518 519 520 521	518 4.033 S.F. 519 3.009 S.F. 520 5.350 S.F. 521 3.153 S.F. 509 4.281 S.F.	518 4.033 S.F. 50 Ft. 519 3.009 S.F. 31 50 Ft. 520 5.350 S.F. 55 Ft. 521 3.153 S.F. 33 Ft. 509 4.281 S.F. 45 Ft.

ZONING ANALYSIS (CITY OF PROVIDENCE ZONING ORDINANCE)

Article 6. Downtown District

A. General Regulations Refer to Article 12 for a list of permitted and special principal uses and temporary uses for the D-1 Downtown District

1201 Proposed Us

Dwelling - Multi-Family Permi

B. Use Restrictions - Not applicable because Friendship Street and Pine Street are both B Streets.

602 Dimensional Standards (Table 6-1: Downtown District Dimensional Standards

Minimum Ground Floor Height: 12-0*

Minimum Building Height 3 Stories

Maximum Building Height: D-1-120 district = 120 feet

A Street: Build-to zone of 0'-0" to 8'-0", with minimum build-to percentage of 80%

Side Setback: 0'-0" build-to line

Rear Setback: V-0 but

Development Standards

Front Setback

A. Awnings None Proposed

B. Signs - Refer to Article 16 for requirements and the following additional standards listed in Section 604.8

Refer to Z-105.00 and Z-600.00

C. Fences and Walls - Permitted and subject to the following regulations listed in 604C.

Proposed fence is in compliant

D. Lighting - Light fixtures shall be decorative or concealed. They shall be shielded and directed toward a building or the ground. Electrical conduit and junction boxes shall be located so as to minimize or, if possible eliminate their visbility from the public right-of-way.

Proposed light fixtures are in compliant

E. Mechanical Equipment - Located on the ground or on the roof shall be screened. The screening shall complement the design of the building through the use of similar materials, colors, finishes, and architectural details.

Proposed mechanical equipments are screened on the roof

F. Security Grates None Proposed

Street Parking None Process

If a use that is exempt from vehicle parking voluntarily provides parking, bicycle parking, as required by Article 14, is required.

Exemptions from Parking Requirements - The D-1 District is exempt from all off-street vehicle and bicycle parking requirements.

604 H. Loading - Off-street loading docks and areas shall be provided in accordance with Article 14 of this Ordinance and the following provisions

1. Access to loading docks and areas from A Streets is permitted only when the lot has no frontage on a B Street. Complies

Exterior loading docks are prohibited. Complies

3. Interior loading shall be screened from view by solid, non-transparent doors which shall remain closed when the loading dock is not in use. The doors used to screen the docks shall be designed to be consistent with similar building elements such as windows and doors, to reduce the industrial appearance of the bosting area and be constructed of materials found elemente on the building. Compiles

4. The maximum wdith of the driveway acess to the loading dock area is 24 feet. Complies

1403 Table 14-2 Off- Street Loading Requirements

Multi-Family Dwelling Number of Spaces Required

40,000 or more GFA

Complies - 1 loading dock provided

Dimensions

All required off-street loading spaces shall be a minimum 12 feet in width, a minimum of 35 feet in length, exclusive of aisle and maneuvering space, and have a minimum vertical clearance of 15 feet. Complies

Design Standards for New Construction

A On both A and B Sreet facades, buildings over 6 stories shall have a recess line of at least 10 feet, above the third story and below the seventh story.

Complies - 10'-0' recess line provided on Friendship Street and Pine Street.

B. Building Materials

Facade Design is in compliant with the building material requirements. Complies

C. Entrance Design - shall be designed to have multiple entrances, with no more than 35 feet between entrances.

Multiple entrances provided and with no more than 35 feet between entrances. Complies

D. Facade Design

1. Building facades shall be built within a build-to zone of between zero and 8 feet from the street line. Such facades shall occupy this build-to zone for at least 80% of each lot fronage of the property. Complies

2. A building facade shall have a transition line. Transition lines shall be designed in proportion to the overall height and mass of the proposed building to create a distinction between the upper and lower stories. Compiles

E. Fenestration Design

All building facade shall provide areas of transparency equal to at least 70% of the wall area, between the height of 1 and 12 feet from the ground of each building facade. Complies

2. Blank walls shall be separated by areas of transparency of at least 3 feet in width. Complies

3. Upper story facade shall provide areas of transparency equal to at least 35% of the wall area of the story. Complies

4. Windows shall only be composed of clear or lightly tinted glass. Highly reflective window coatings are prohibited. Complies

Trees and Landscaping - see Article 15 for landscape requirements

On-Site Landscaping and Required Trees

 All portions of a lot not covered by structures or paved surfaces shall be landscaped with trees, shrubbery, grass, five groundcover, and other plantings.

2. All existing plantings that are maintained on a site may be courted toward any required on-site landscaping.

3. Required Tree Canopy Percentage - sufficient trees shall be retained and/or planted on a lot so that the square footage of vegetative canopy of such trees, when mature, equals a certain percentage of the square footage of the lot. This required percentage is established by district as follows:

0-1 District: 15% of the lot area not occupied by a structure

t area not covered by structure: 2,272 S.F. x 15% = 341 S.F.

Calculation of Tree Canopy Coverage - the total canopy coverage for a lot is the sum of the canopy, at maturity, of the individual trees located on the lot. The square footage of canopy cover varies according to the tree species. Trees are classified as small (300 sf.), medium (700 sf.), or large (1,000 sf.)

Existing or planned street trees located in the public right-of-way directly adjacent to the lot line may be counted toward the canopy coverage for the lot.

There are 3 existing trees along Friendship Street, which may be counted toward the canopy coverage requirement for the lot.

137-151 FRIENDSHIP ST. AND 194 PINE ST. PROVIDENCE

CLIENT

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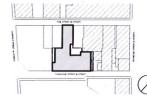
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Site Plan:



Revisions:

ISSUED FOR DORC REVIEW 10082
D: ISSUE Date

GKV Project: 1905-01

Scale: As Noted

Drawing Title:

SITE PLAN AND ZONING ANALYSIS

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Sheet No: 02 of 26

COMPLIANT WITH SECTION 606.D. FACADE DESIGN

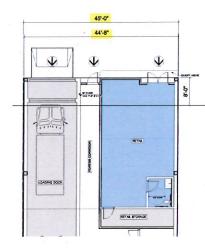
Building facades shall be built within a build-to zone of between 0 and 8 feet from the street line. Such facades shall occupy this build-to zone for at least 80% of each lot frontage of the property.



PINE STREET FACADE CALCULATION

45'-0" x 80% = 36'-0" minimum required frontage

Proposed Frontage: 44'-8" > 36'-0" Complies



FRIENDSHIP STREET FACADE CALCULATION

170'-6" x 80% = 136'-4 3/4" minimum required frontage

Proposed Frontage: 160'-5" > 136'-4 3/4" Complies

COMPLIANT WITH SECTION 1303 PERMITTED ENCROACHMENTS INTO THE PUBLIC RIGHT-OF-WAY AND SECTION 1607.C CANOPY SIGNS

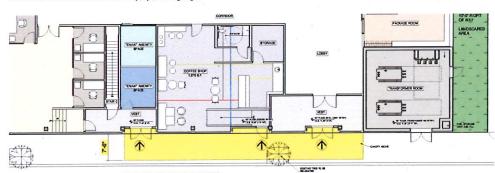
Enroachment Not for Habitation is any construction that projects from a building over, onto, or under a public right-of-way that is not designed for and cannot accommodate human or habitation including, but not limited to, awnings, canopies, marquees, signs, architecturals embellishments, foundations, wheelchair ramps, stairs, and the like, whether supported by the ground or not.

An encroachment not for habitation that encroaches over, onto, or under a public right-of-way is limited as follows:


1. Awnings, canopies, marquees, and signs with less than 15 feet vertical clearance above the sidewalk may extend into or occupy up to two-thirds of the width of the sidewalk measured from the lot line. Awnings, canopies, marquees, and signs with 15 feet or more vertical clearance above the sidewalk may extend into or occupy up to 100% of the width of the sidewalk.

2. In D-1 District, canopies are permitted to be located at least 6" from the curb line

Proposed canopy is projecting 7'-6" into the public right-of-way at Friendship Street Complies Proposed canopy is projecting 2'-0" into the public right-of-way at Pine Street Refer to Z-105.00 and A-600.00 for proposed signages





FRIENDSHIP STREET

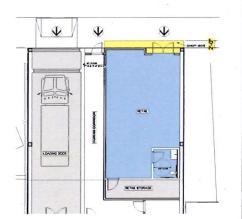

COMPLIANT WITH SECTION 604.H. AND SECTION 1406 LOADING

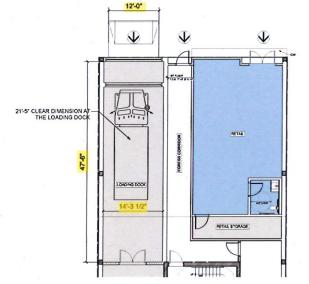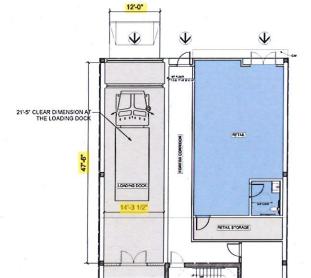The maximum width of the driveway acess to the loading dock area is 24 feet. All required off-street loading spaces shall be a minimum 12 feet in width, a minimum of 35 feet in length, exclusive of aisle and maneuvering space, and have a minimum vertical clearance of 15 feet. <u>Compiles</u>






COMPLIANT WITH SECTION 606.C. ENTRANCE DESIGN

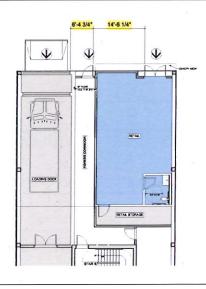Buildings shall be designed to have multiple entrances, with no more than 35 feet between entrances.







137-151 FRIENDSHIP ST. AND 194 PINE ST. **PROVIDENCE**

CLIENT

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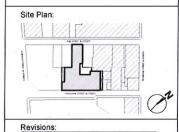
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1. ISSUED FOR DORC REVIEW 10/08/25 Date

GKV Project: 1905-01

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Drawing Title:

ZONING COMPLIANT **DIAGRAMS**


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Sheet No: 03 of 26

COMPLIANT WITH SECTION 606.A. BUILDING HEIGHT AND MASSING 1. Ground floors shall be a minimum of 12 feet from floor to ceiling to enhance the pedestrian streetscape, regardless of the overall building height. 1ST FLOOR 10 S 14 97 (2-37)

COMPLIANT WITH SECTION 606.A. BUILDING HEIGHT AND MASSING

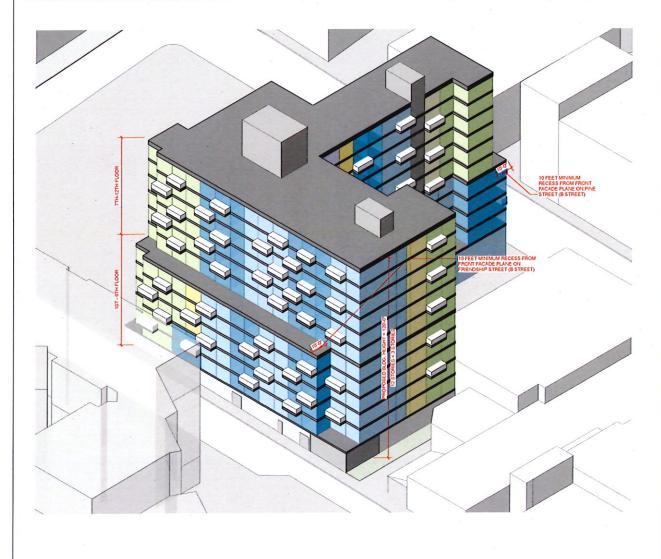- 1. Buildings shall be at least 3 stories in height. Complies
- 2. Building height and massing shall relate to adjacent structures. Complies
- 3. On both A and B Street facades, buildings over 6 stories shall have a recess line of at least 10 feet above the third story and below the seventh story.



COMPLIANT WITH SECTION 1303 PERMITTED ENCROACHMENTS AND PERMITTED ENCROACHMENTS INTO THE PUBLIC RIGHT-OF-WAY

Table 13-2: Permitted Encroachments into Required Setbacks Complies

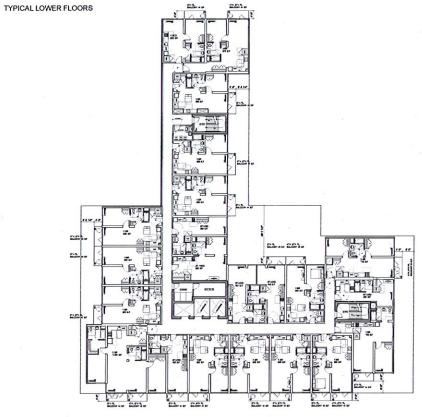
Balcony 6' into front, interior side, or corner side

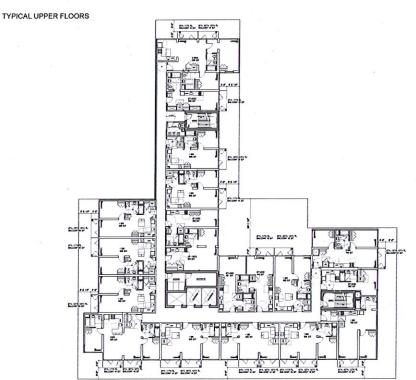
8' into rear 4' from all lot lines

An encroachment for habitation is any construction that projects from a building over, onto, or under a public right-of-way that is designed for and can accommodate human or other habitation including, but not limited to, balconies, overhangs, and the like, whether supported by the ground or not.

Where the vertical clearance above grade to projecting balconies is more than 8 feet, one inch of encroachment is permitted for each additional one inch of vertical above 8 feet, but the maximum encroachment is limited to a maximum of 4 feet.

Refer to below. Proposed balconies start on the 3rd floor and above and not projecting more than 4'-0". Compiles





137-151 FRIENDSHIP ST. AND 194 PINE ST. PROVIDENCE

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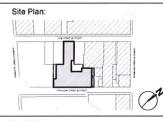
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ZONING COMPLIANT **DIAGRAMS**

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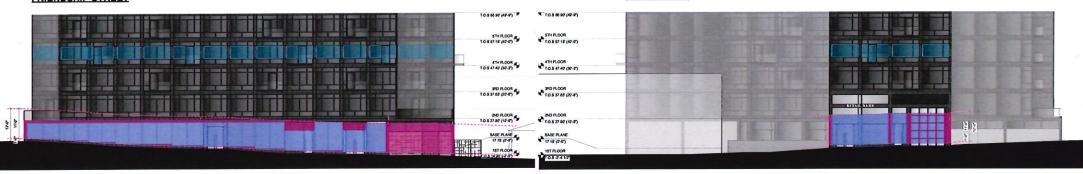
Sheet No: 04 of 26



COMPLIANT WITH SECTION 606.E. FACADE DESIGN - TRANSPARENCY DIAGRAMS

- 1. All building facades shall provides areas of transparency equal to at least 70% of the wall area, between height of 1 and 12 feet from the ground of each building facade.
- 2. Blank walls shall be separated by areas of transparency of at least 3 feet in width. Complies
- 3. Upper story facade shall provide areas of transparency equal to at least 35% of the wall area of the story. Complies

GROUND FLOOR AND ONE TYPICAL UPPER FLOOR TRANSPARENCY CALCULATION FRIENDSHIP STREET



GROUND FLOOR FACADE AREA = 1.588 S.F.

REQUIRED 70% TRANSPARENCY = 1,588 x .70 = 1.111.8 S.F.

TRANSPARENCY PROVIDED = 1.148 S.F. = 72% > 70%

TRANSFORMER VAULT FACADE AREA = 265 SF = 17%

TYPICAL UPPER FLOOR FACADE AREA = 1.536 SF PER FLOOR
REQUIRED 35% TRANSPARENCY = 1,536 x .35 = 538 SF
TRANSPARENCY PROVIDED = 619 SF = 40% > 35%

GROUND FLOOR FACADE AREA = 491 SF

REQUIRED 70% TRANSPARENCY = 491 x .70 = 344 SF

TRANSPARENCY PROVIDED = 390 SF = 79% > 70%

TYPICAL UPPER FLOOR FACADE AREA = <u>438 SF PER FLOOR</u> REQUIRED 35% TRANSPARENCY = 436 x .35 = <u>153 SF</u> TRANSPARENCY PROVIDED = <u>174 SF</u> = 40% > 35%

COMPLIANT WITH SECTION 604.C. FENCES AND WALLS

Fences and walls are permitted subject to the following regulations.

- 1. Fences shall be constructed of steel, aluminium, or wrought iron and may include stone or brick piers. Fence colors shall blend into the landscape. Compiles
- 2. Fences and walls shall not exceed 6 feet in height. Complies

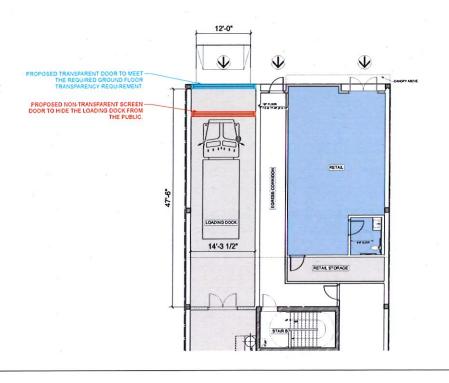


COMPLIANT WITH SECTION 604.H.

PINE STREET

Interior loading shall be screened from view by solid, non-transparent doors, which shall remain closed when the loading dock is not in use. The doors used to screen the docks shall be designed to be consistent with similar building elements, such as windows and doors, to reduce the industrial appearance of the loading area and be constructed of materials found elsewhere on the building.

GROUND FLOOR AND ONE TYPICAL UPPER FLOOR TRANSPARENCY CALCULATION



137-151 FRIENDSHIP ST. AND 194 PINE ST. PROVIDENCE

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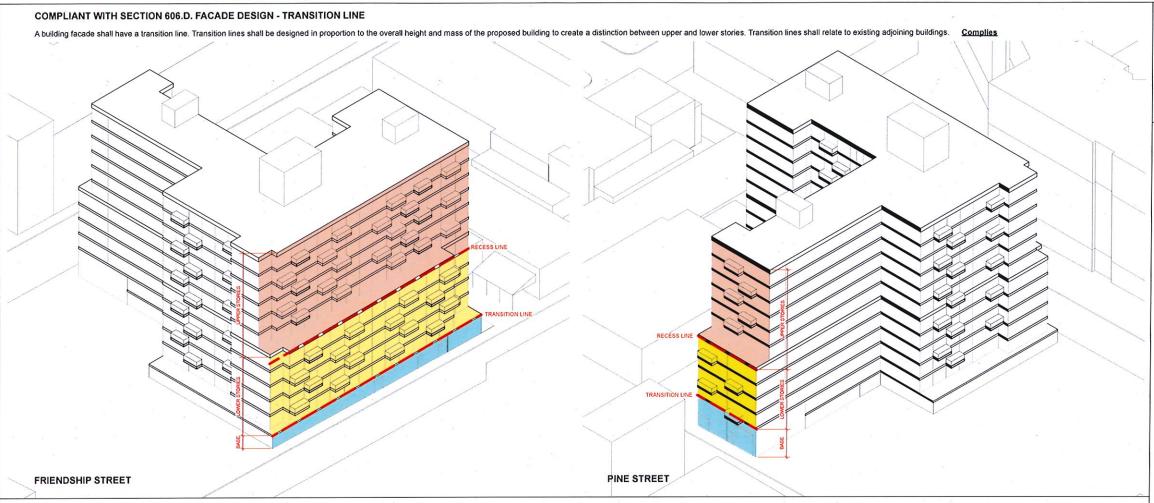
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Sheet No: 05 of 26

ZONING COMPLIANT DIAGRAMS

Z-103.00





COMPLIANT WITH SECTION 1302.0 ROOFTOP ACCESSORY STRUCTURE

- 1. Accessory structures and rooftop features, such as green roofs, rooftop decks, rooftop gardens, stormwater detention system, and similar accessory structures and uses are permitted on rooftops. Such structures are excluded from the calculation of height.
- 2. A rooftop greenhouse is excluded from building height calculations and does not count as a story. A rooftop greenhouse may exceed the building height maximum by no more than 25 feet so long as it is setback a minimum of 10 feet from the building facade. Complies



137-151 FRIENDSHIP ST. AND 194 PINE ST. **PROVIDENCE**

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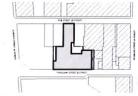
GEOTECH ENGINEER

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Sheet No: 06 of 26

COMPLIANT WITH SECTION 604.B SIGNS, AND 1607.C CANOPY SIGNS

The maximum total area of all permanent signs on a facade shall not exceed 3 S.F. per 1 linear foot of building frontage. Window signs are not included in the above calculation.

- 1. In the D-1 District, canopies are limited to a maximum sign area of 2 S.F. of sign area for every 1 foot of linear building frontage. Friendship Street Building Frontage: 157.50' x 2 S.F. = 315 S.F. maximum sign area

 Pine Street Building Frontage: 44.67' x 2 S.F. = 89.34 S.F. maximum sign area

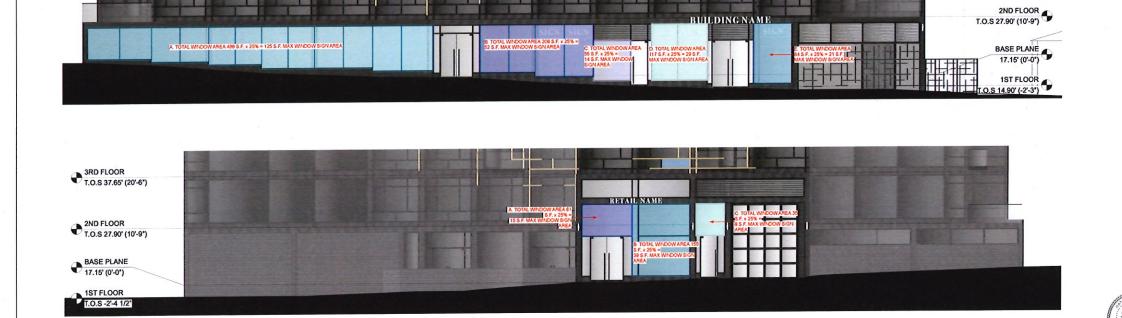
 Pine Street Building Frontage: 44.67' x 2 S.F. = 89.34 S.F. maximum sign area
- 2. Canopy signs shall maintain a minimum vertical clearance of 7 feet and 6 inches. Complies Refer to storefront diagrams below.
- 3. In D-1 District, canopies are permitted to be located at least 6" from the curb line. Compiles Proposed canopy is 7'-6" in depth at Friendship Street and 2'-0" in depth at Pine Street.
- 4. Support posts shall maintain a minimum separation of 5 feet between posts and between the posts and any building wall. No posts are proposed
- 5. Canopy signs shall be made of a durable, weather-resistant materials such as canvas, canvas-like material, fire-resistant acrylic, or metal.

 Complies
- 6. Printing on any canopy sign is limited to 25% of that surface area. Proposed Canopy sign is not printed
- 7. Canopy signs may be externally illuminated and shall be focused on the printed area.



COMPLIANT WITH SECTION SECTION 1607.L WINDOW SIGNS

- 1. All window signs, whether temporary or permanent, are limited to no more than 25% of the surface of each window area. Window area is counted as a continuous surface until divided by an architectural or structural element. Mullionns are not considered an element that divides window area. Compiles Refer to storefront diagram below
- 2. Window signs that are internally or externally illuminated require a permit. Neon and LED window signs are permitted only in the downtown districts.





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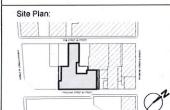
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Sheet No: 07 of 26


COMPLIANT WITH SECTION 202.B BUILDING HEIGHT

- 1. For a vacent parcel of land, building height shall be measured from the average, existing-grade elevation where the foundation of the structure is proposed. Refer to Grade Plane Catculation (Z-100,00) Compiles
- 2. The following structures or parts thereof are exempt from maximum height limitations.
- a. Building appurtenances such as chimneys, parapet walls, skylights, steeples, flag poles, smokestacks, cooling towers, elevator building appurtenances, monuments, water towers, stacks, stage towers, or scenery lofts, tanks, ornamental towers and spires, rooftop accessory structures, recreational facilities, necessary mechanical appurtenances, or penthouses to house mechanical appurtenances. However, building appurtenances shall be eligible for this exemption only if they meet the following standards:

 i. The footprint of all building appurtenances shall not exceed 50% of the total floor area of the roof.

 Compiles

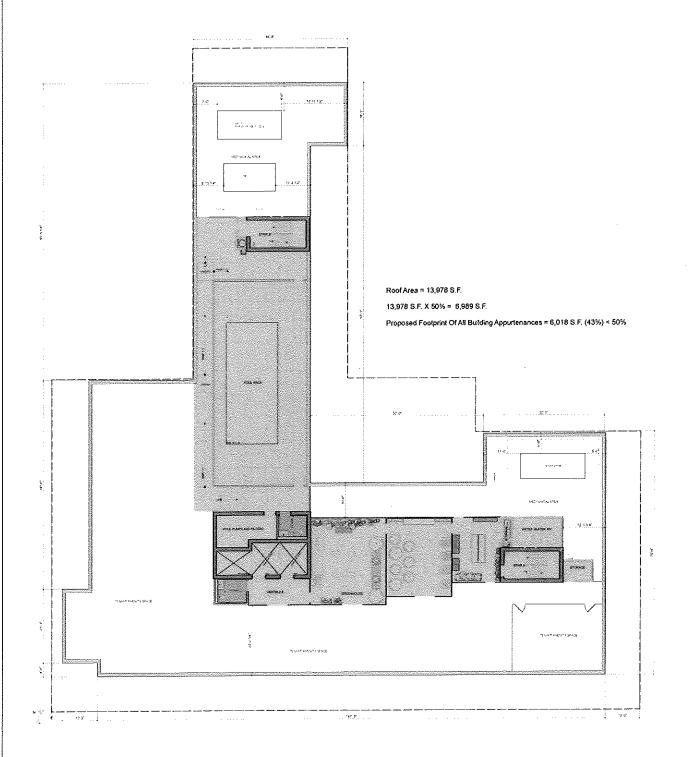 ii. All mechanical appurtenances or penthouses to house mechanical appurtenances roof equipment shall be set back from the edge of the roof a minimum distance of 1 foot for every 2 feet by which the equipment extends above the roof.



137-151 FRIENDSHIP ST. AND 194 PINE ST. PROVIDENCE

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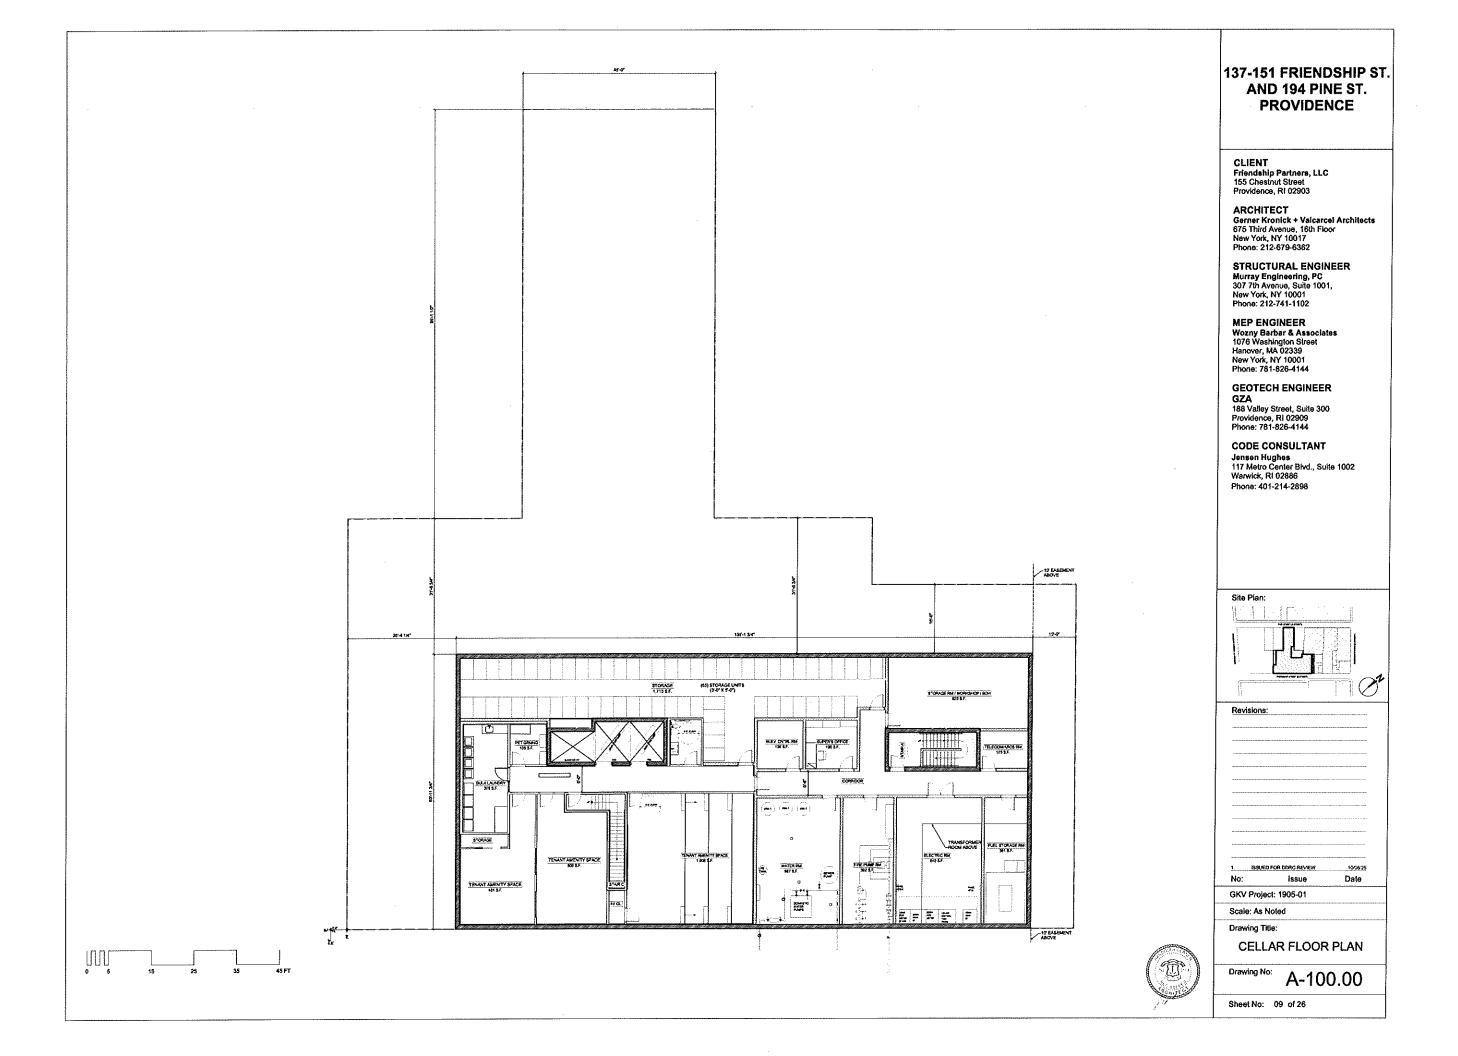
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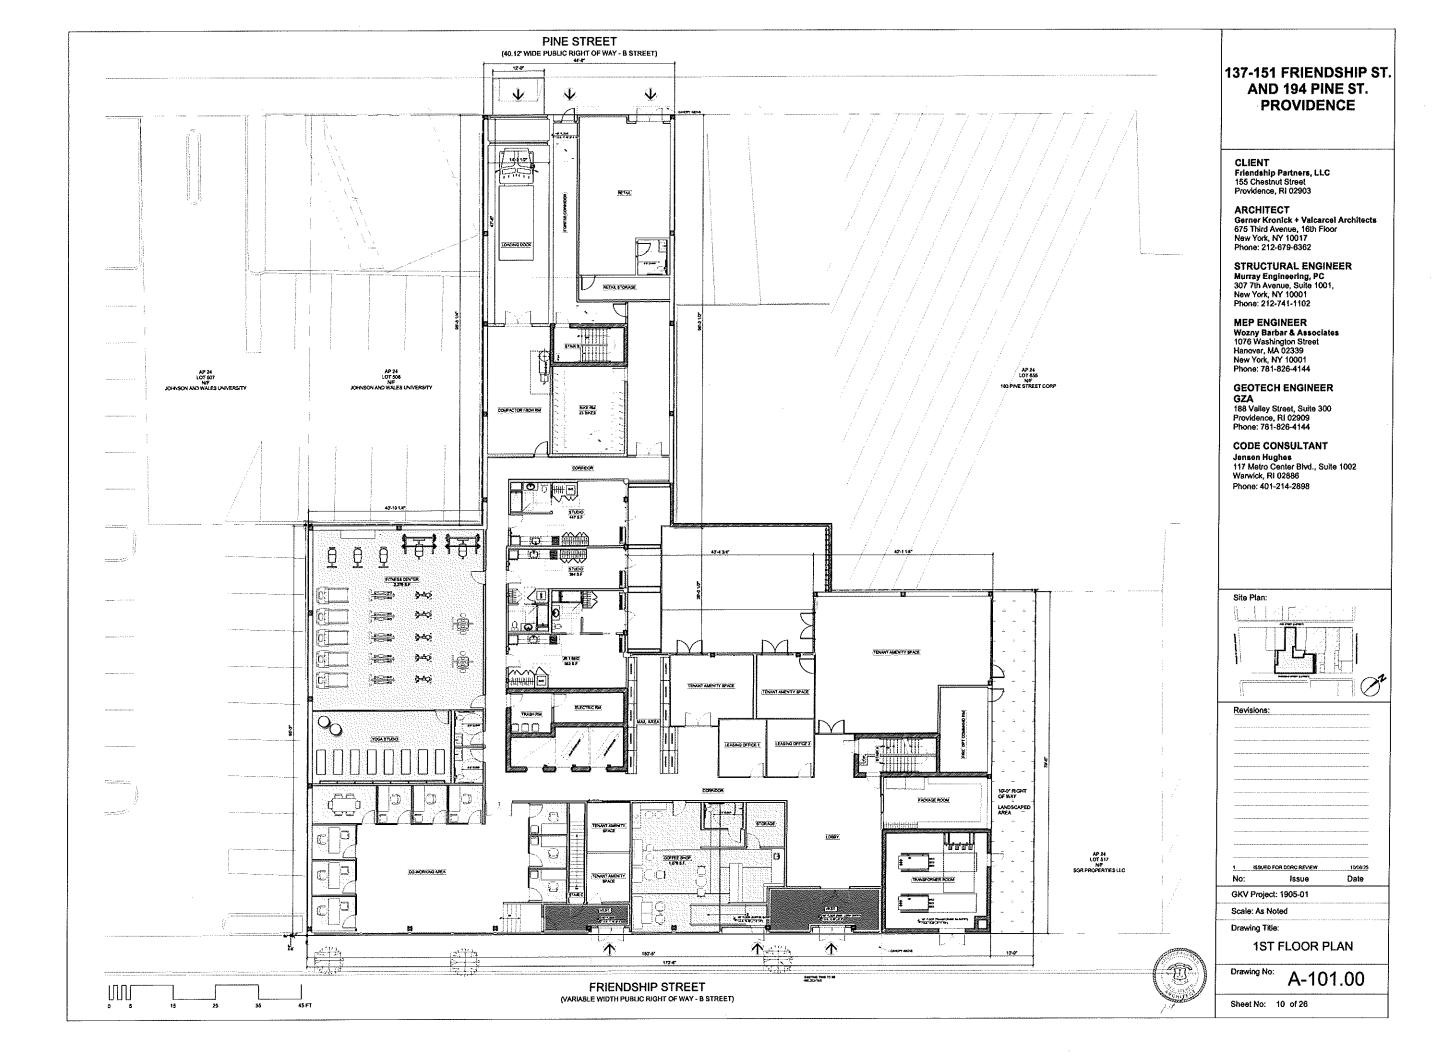
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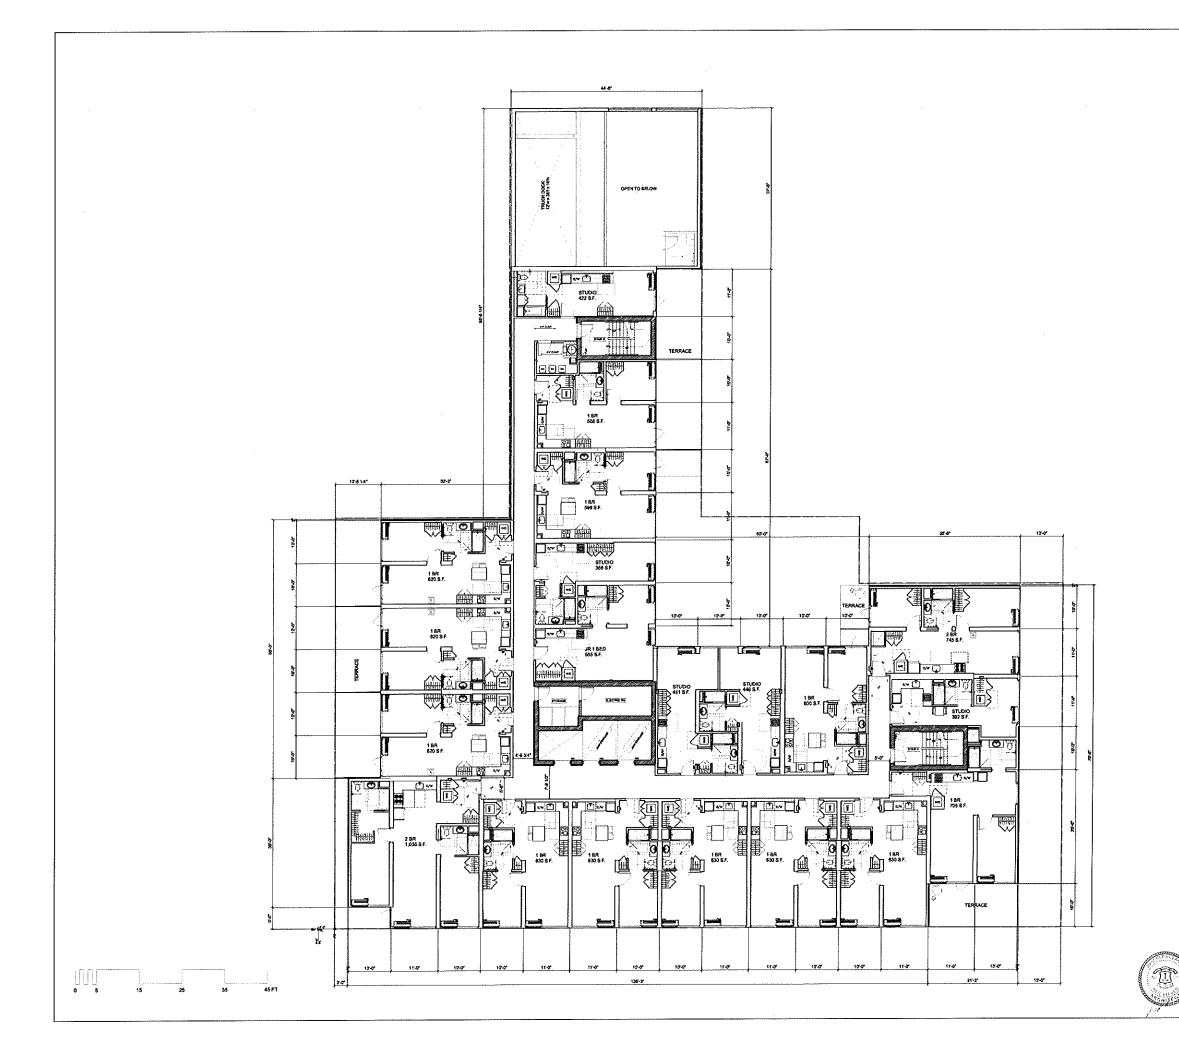
ZONING COMPLIANT DIAGRAMS

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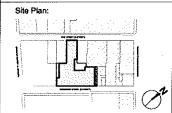
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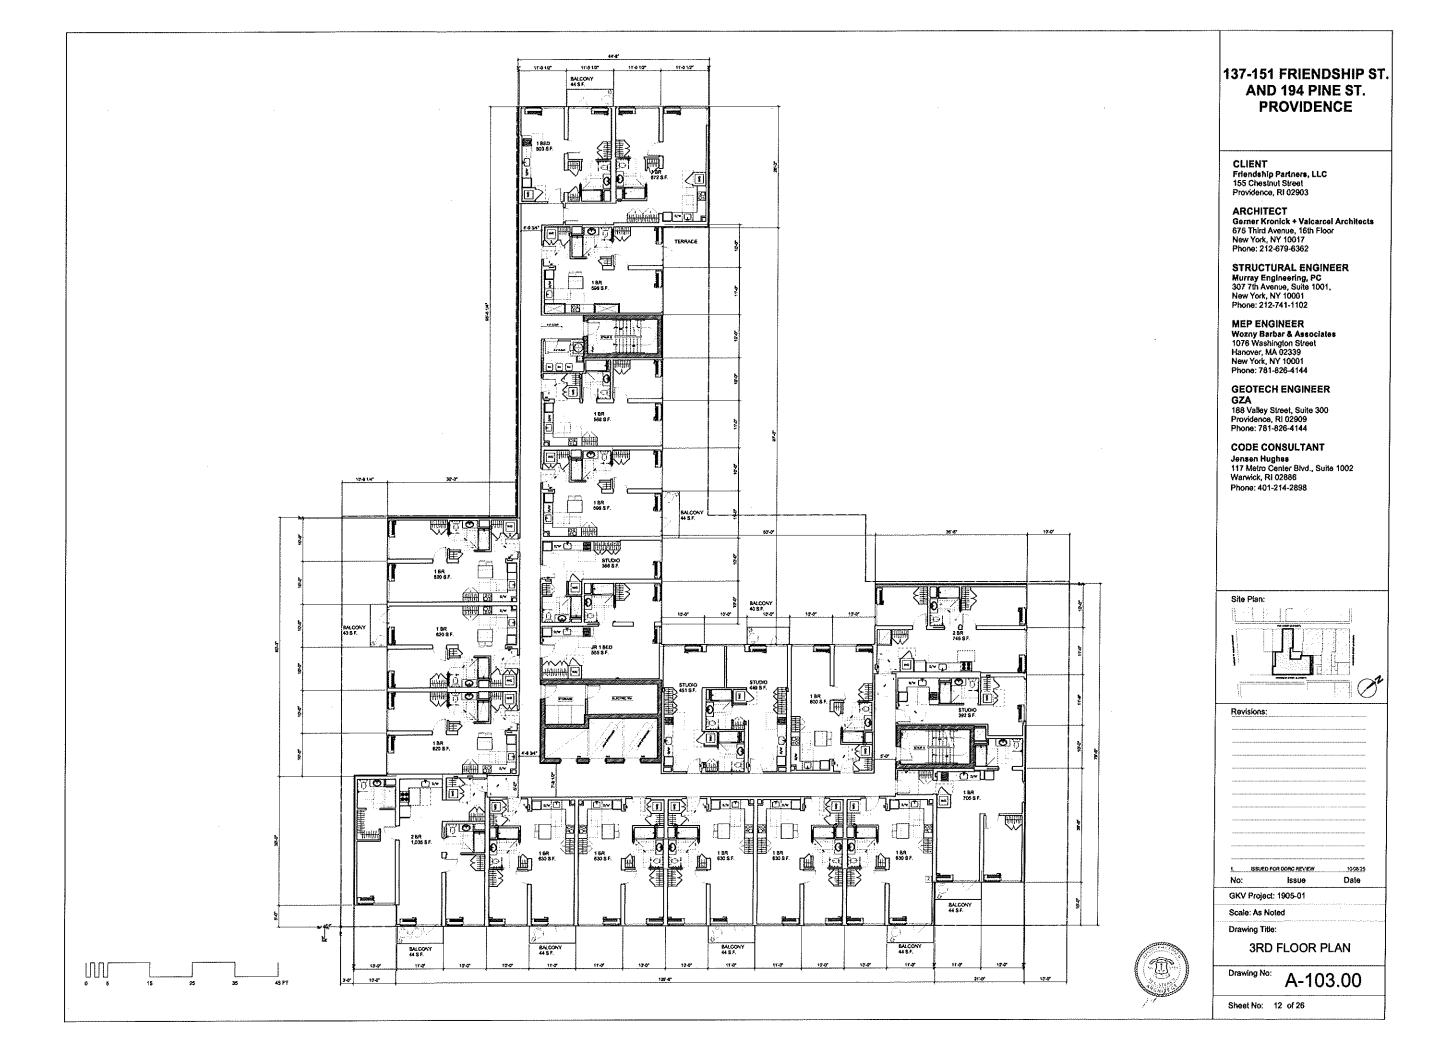
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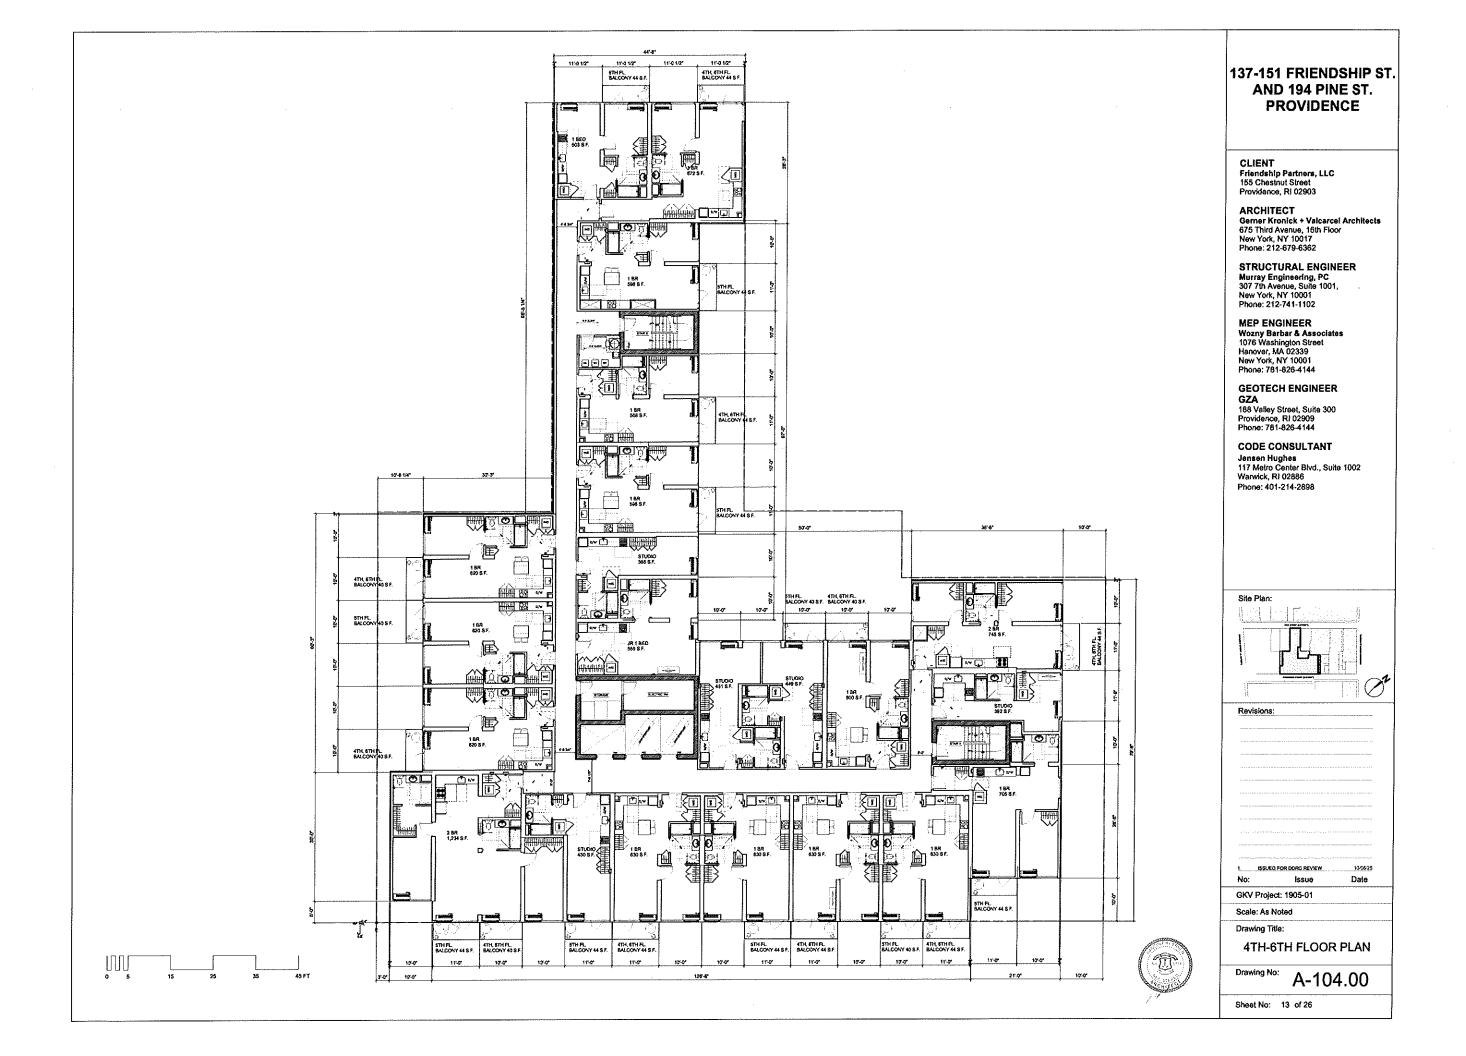
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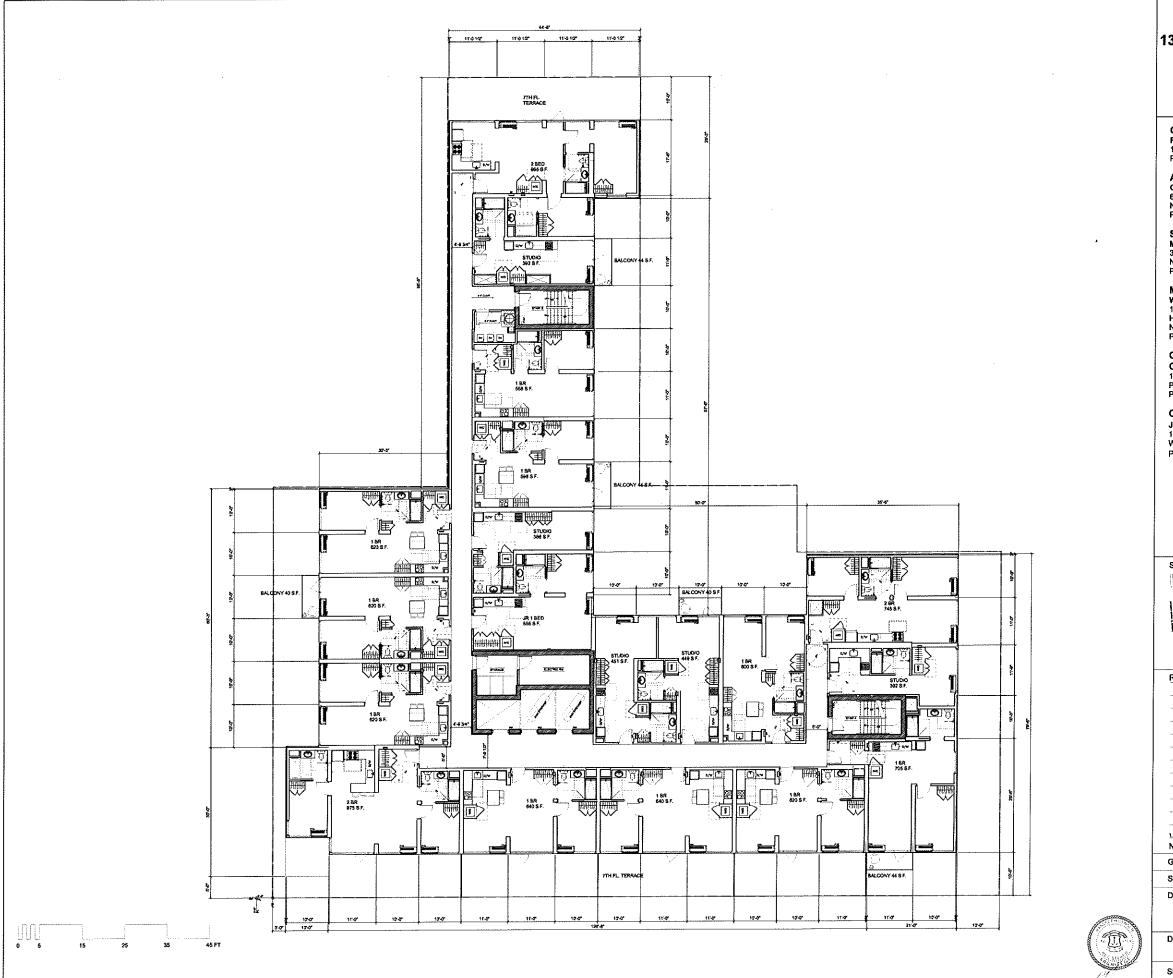
2ND FLOOR PLAN

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Sheet No: 11 of 26







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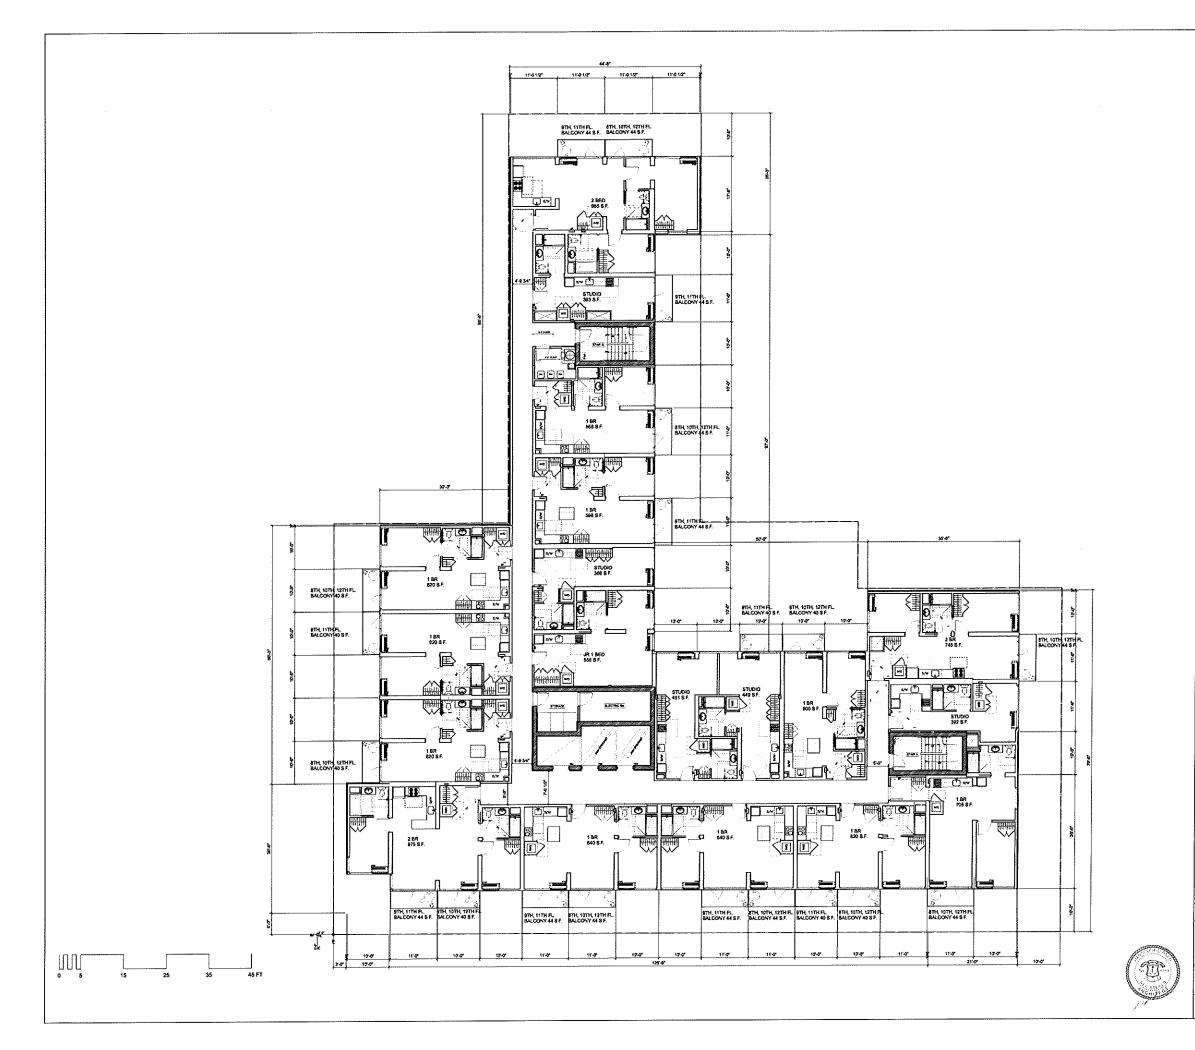
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7TH FLOOR PLAN

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Sheet No: 14 of 26



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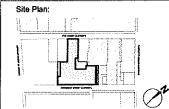
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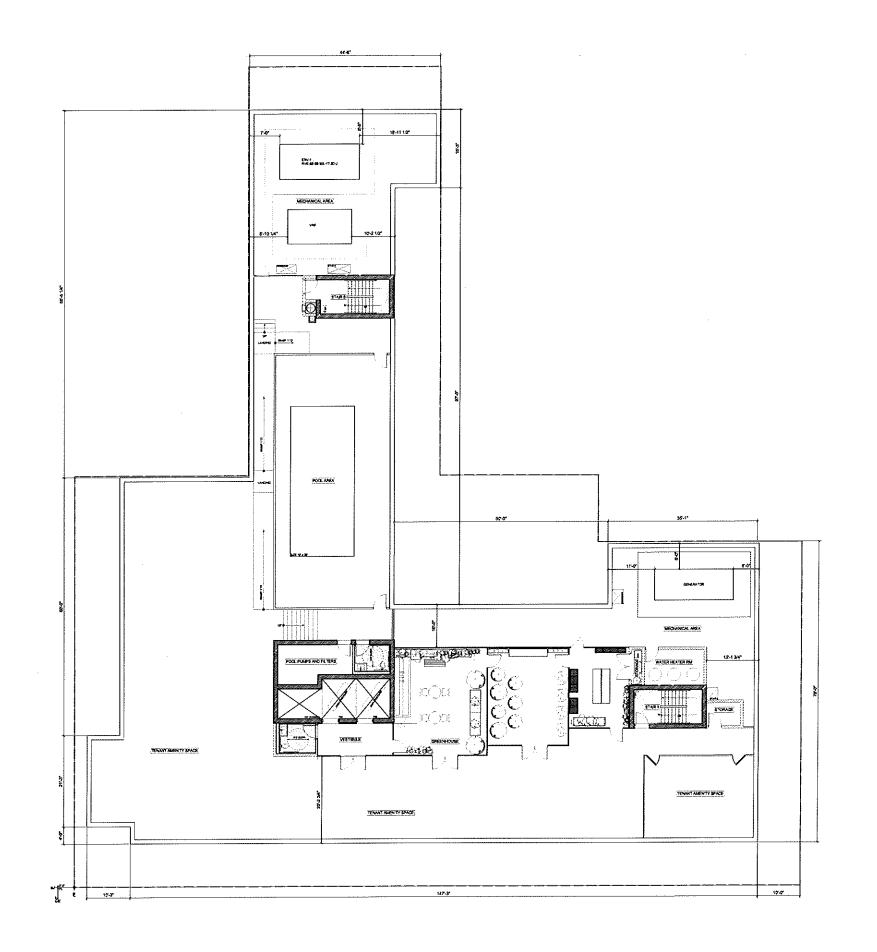
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8TH-12TH FLOOR PLAN

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Sheet No: 15 of 26



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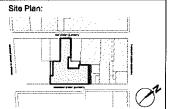
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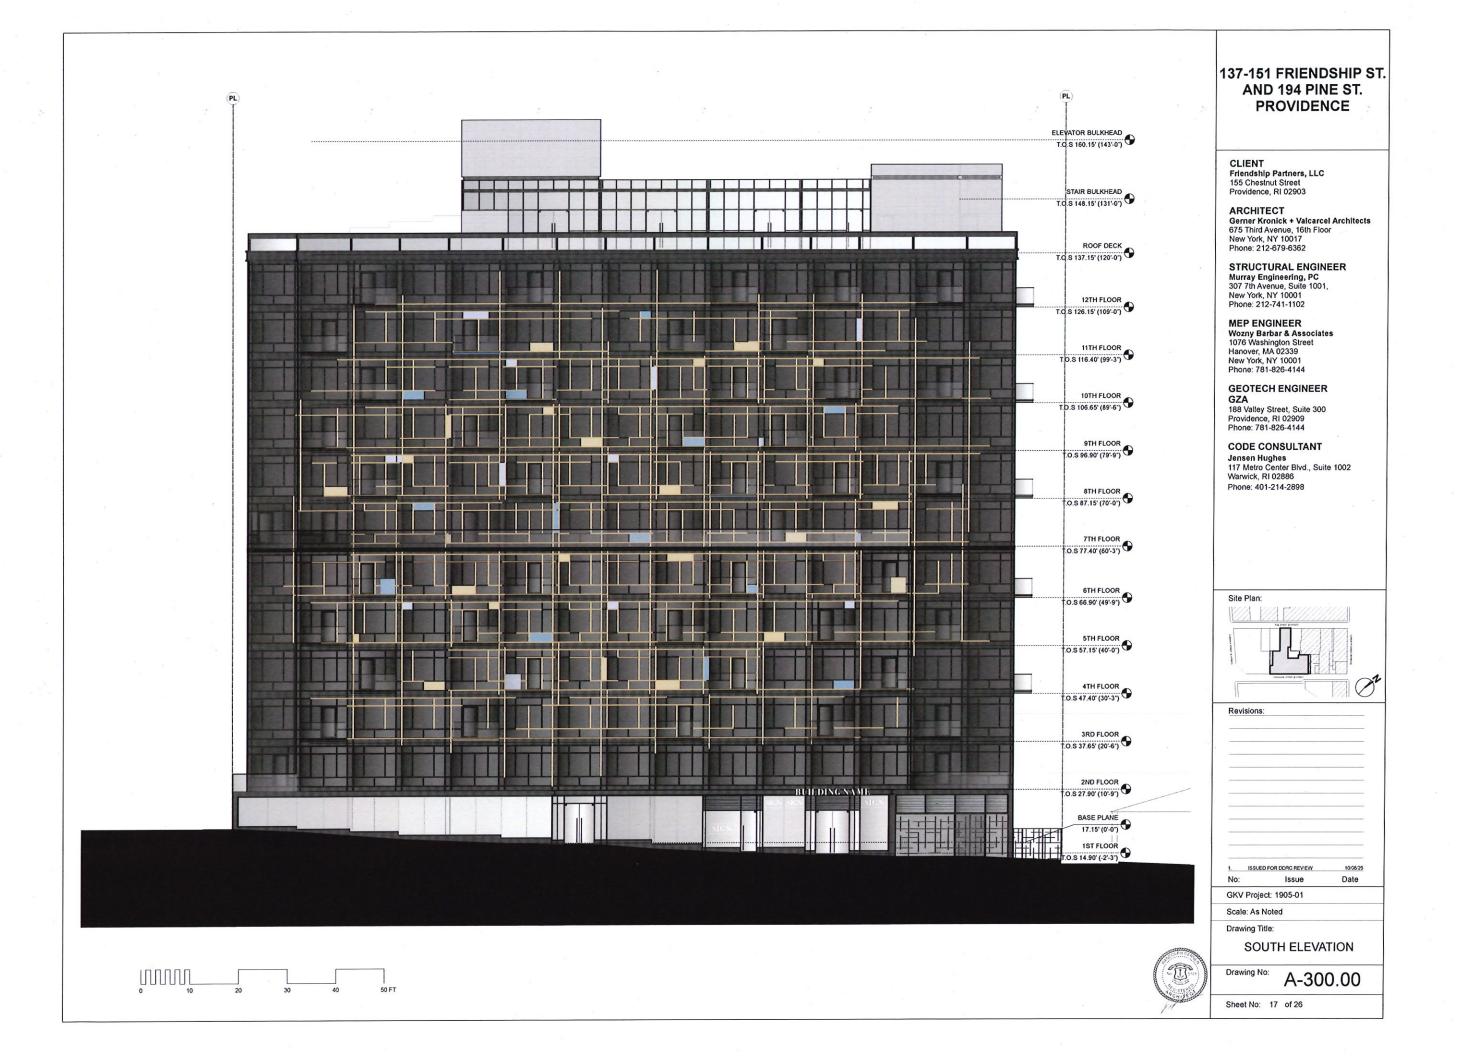
ROOF FLOOR PLAN

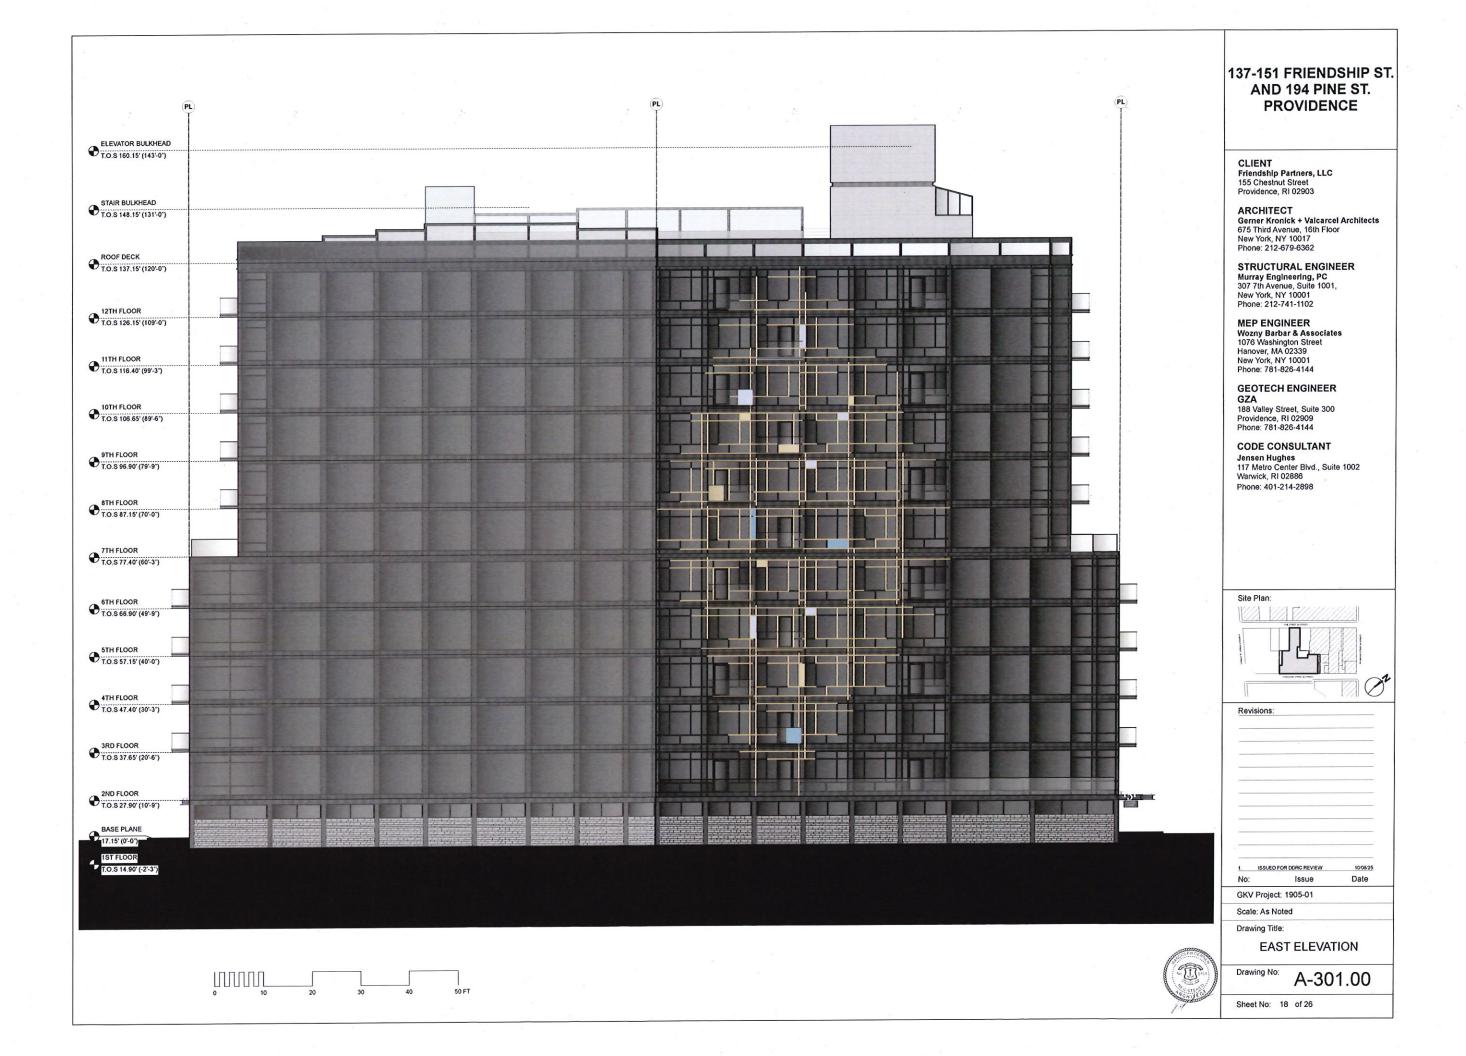
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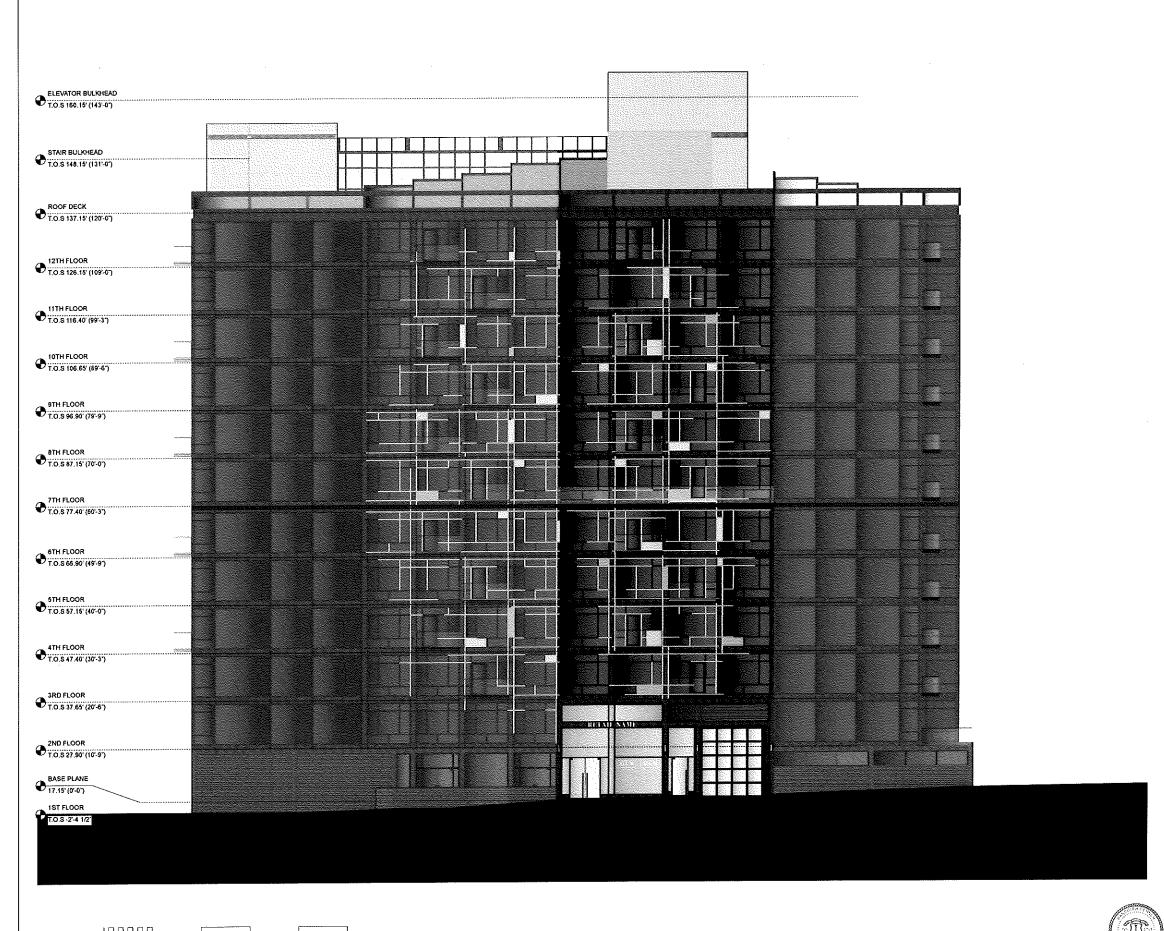
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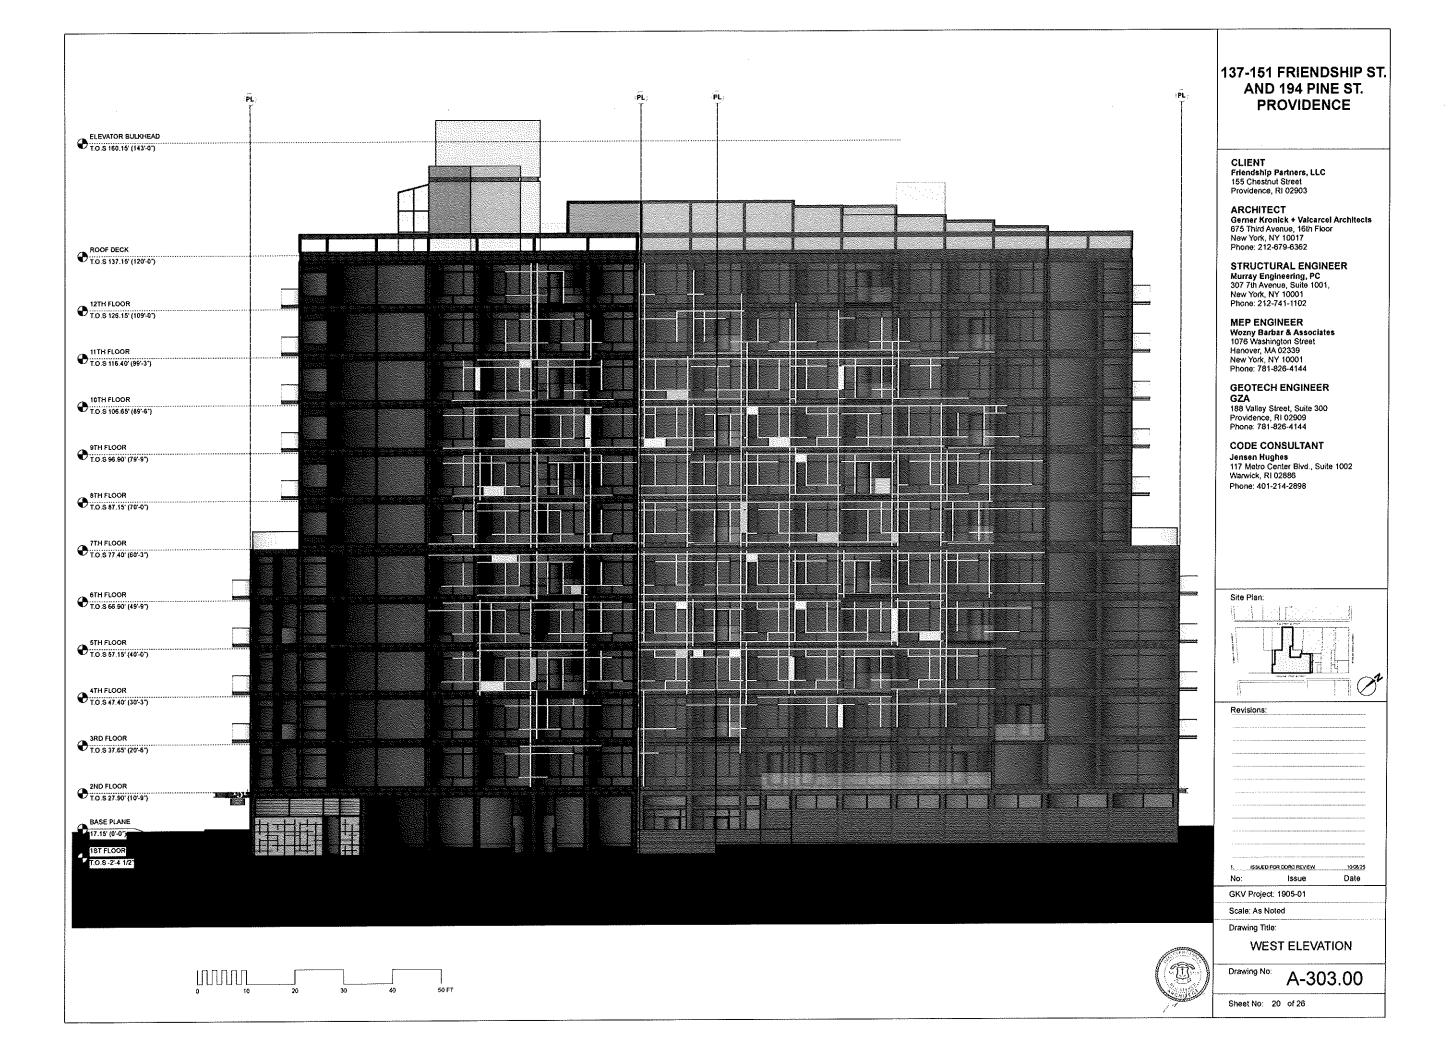
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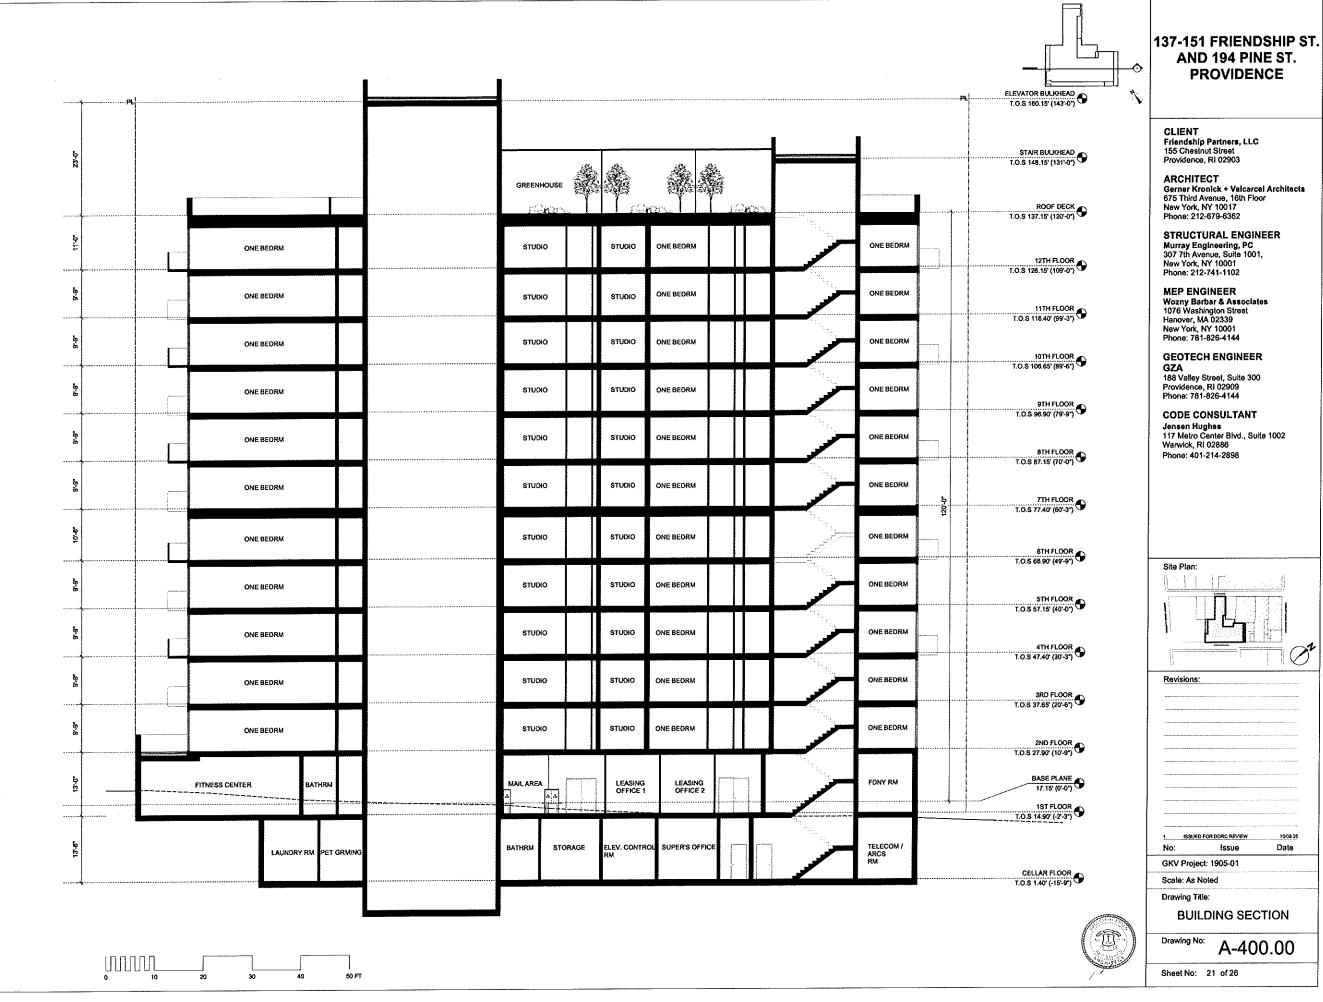
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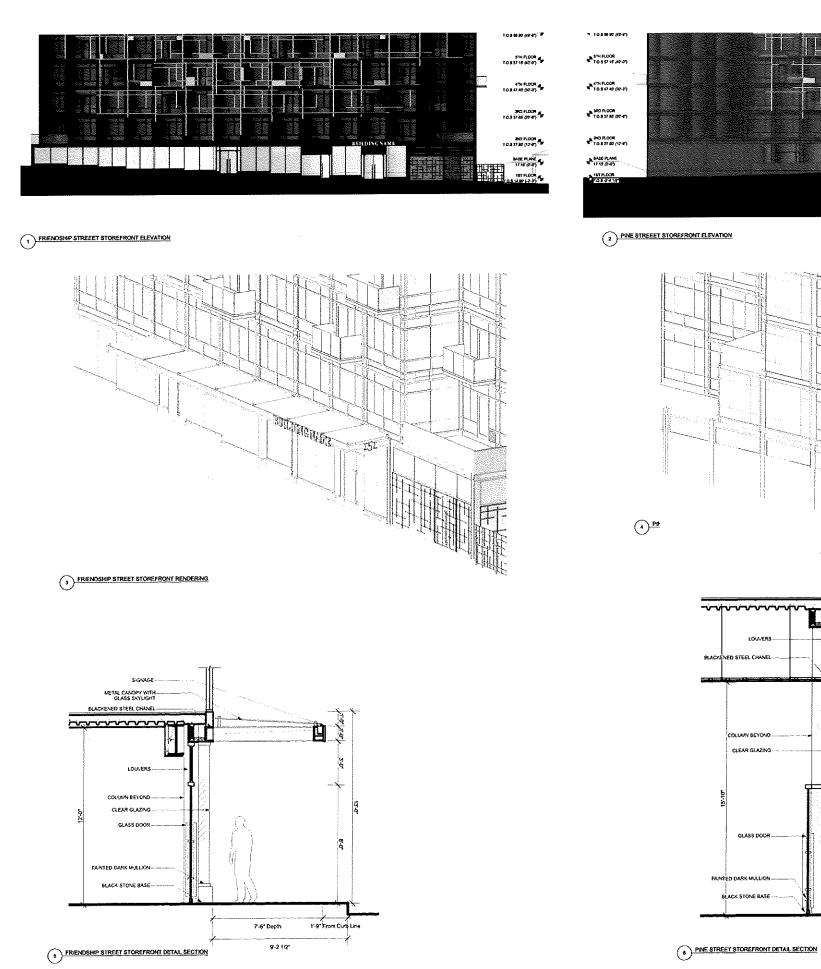
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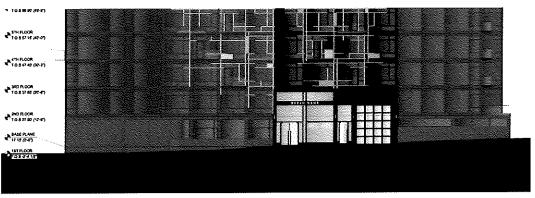
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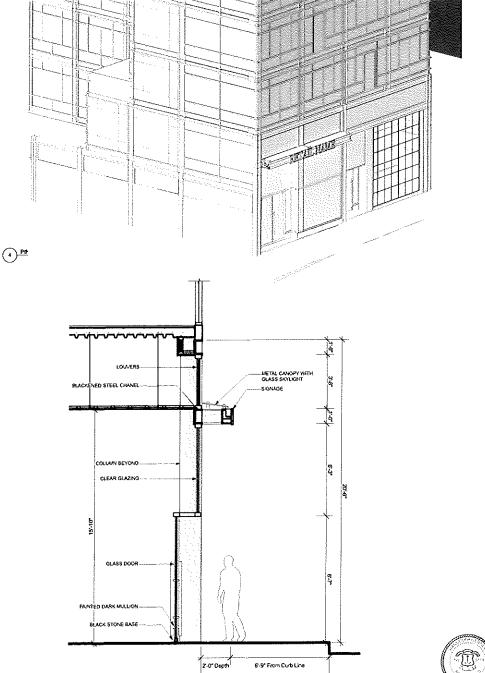








PINE STREET STOREFRONT ELEVATION



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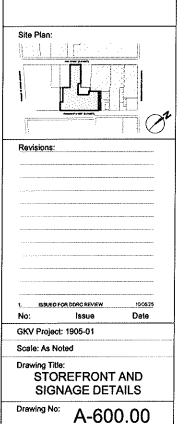
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Sheet No: 22 of 26

PROPOSED COLORWAY



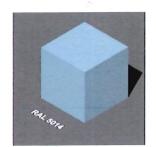
C01: WINDOW FRAME AND METAL PANEL




C02: DECORATIVE STRIPS



C03: METAL PANEL ACCENTS



C04: METAL PANEL ACCENTS

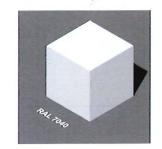

C05: METAL PANEL ACCENTS

PROPOSED GLASS MATERIALS



BUILDING GLASS



G02: SPANDREL GLASS



G03: TRANSPARENT AT BALCONIES AND TERRACES

PROPOSED BASE MATERIALS



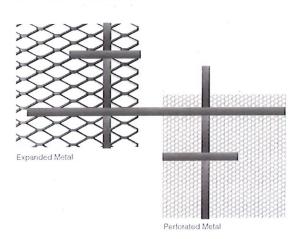
SPLASH COARSE AT STOREFRONT

PROPOSED STONE MATERIALS



S01: HANOVER CHAPEL STONE

PROPOSED FENCE MATERIALS



M01: EXPANDED METAL (INFILL)

M02: PERFORATED METAL (INFILL)

C01: RAILING

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PROPOSED COLORWAY AND MATERIALS

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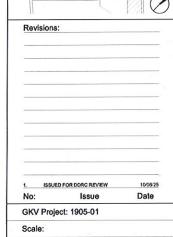
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RENDERINGS

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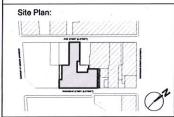
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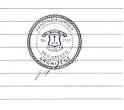
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RENDERINGS

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Sheet No: 25 of 26



LOOKING NORTHEAST LOOKING SOUTH





LOOKING EAST



LOOKING WEST



LOOKING NORTH



LOOKING SOUTHWEST

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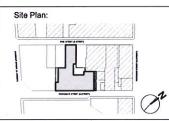
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